
735 ANDERSON HILL RD. PURCHASE NY 10577-1400

244 FIFTH AVENUE, SUITE B-265, NEW YORK, NY 10001

CONTRACTOR SHALL VERIFY ALL FIELD CONDITIONS & DIMENSIONS AND BE RESPONSIBLE FOR FIELD FIT AND QUANTITY OF WORK. NO ALLOWANCES SHALL BE MADE ON BEHALF OF THE CONTRACTOR

APPLICATION SPECIFICATION SHEET, ALL OTHER MATTERS SHOWN ARE NOT TO BE RELIED UPON, OR TO BE CONSIDERED AS EITHER

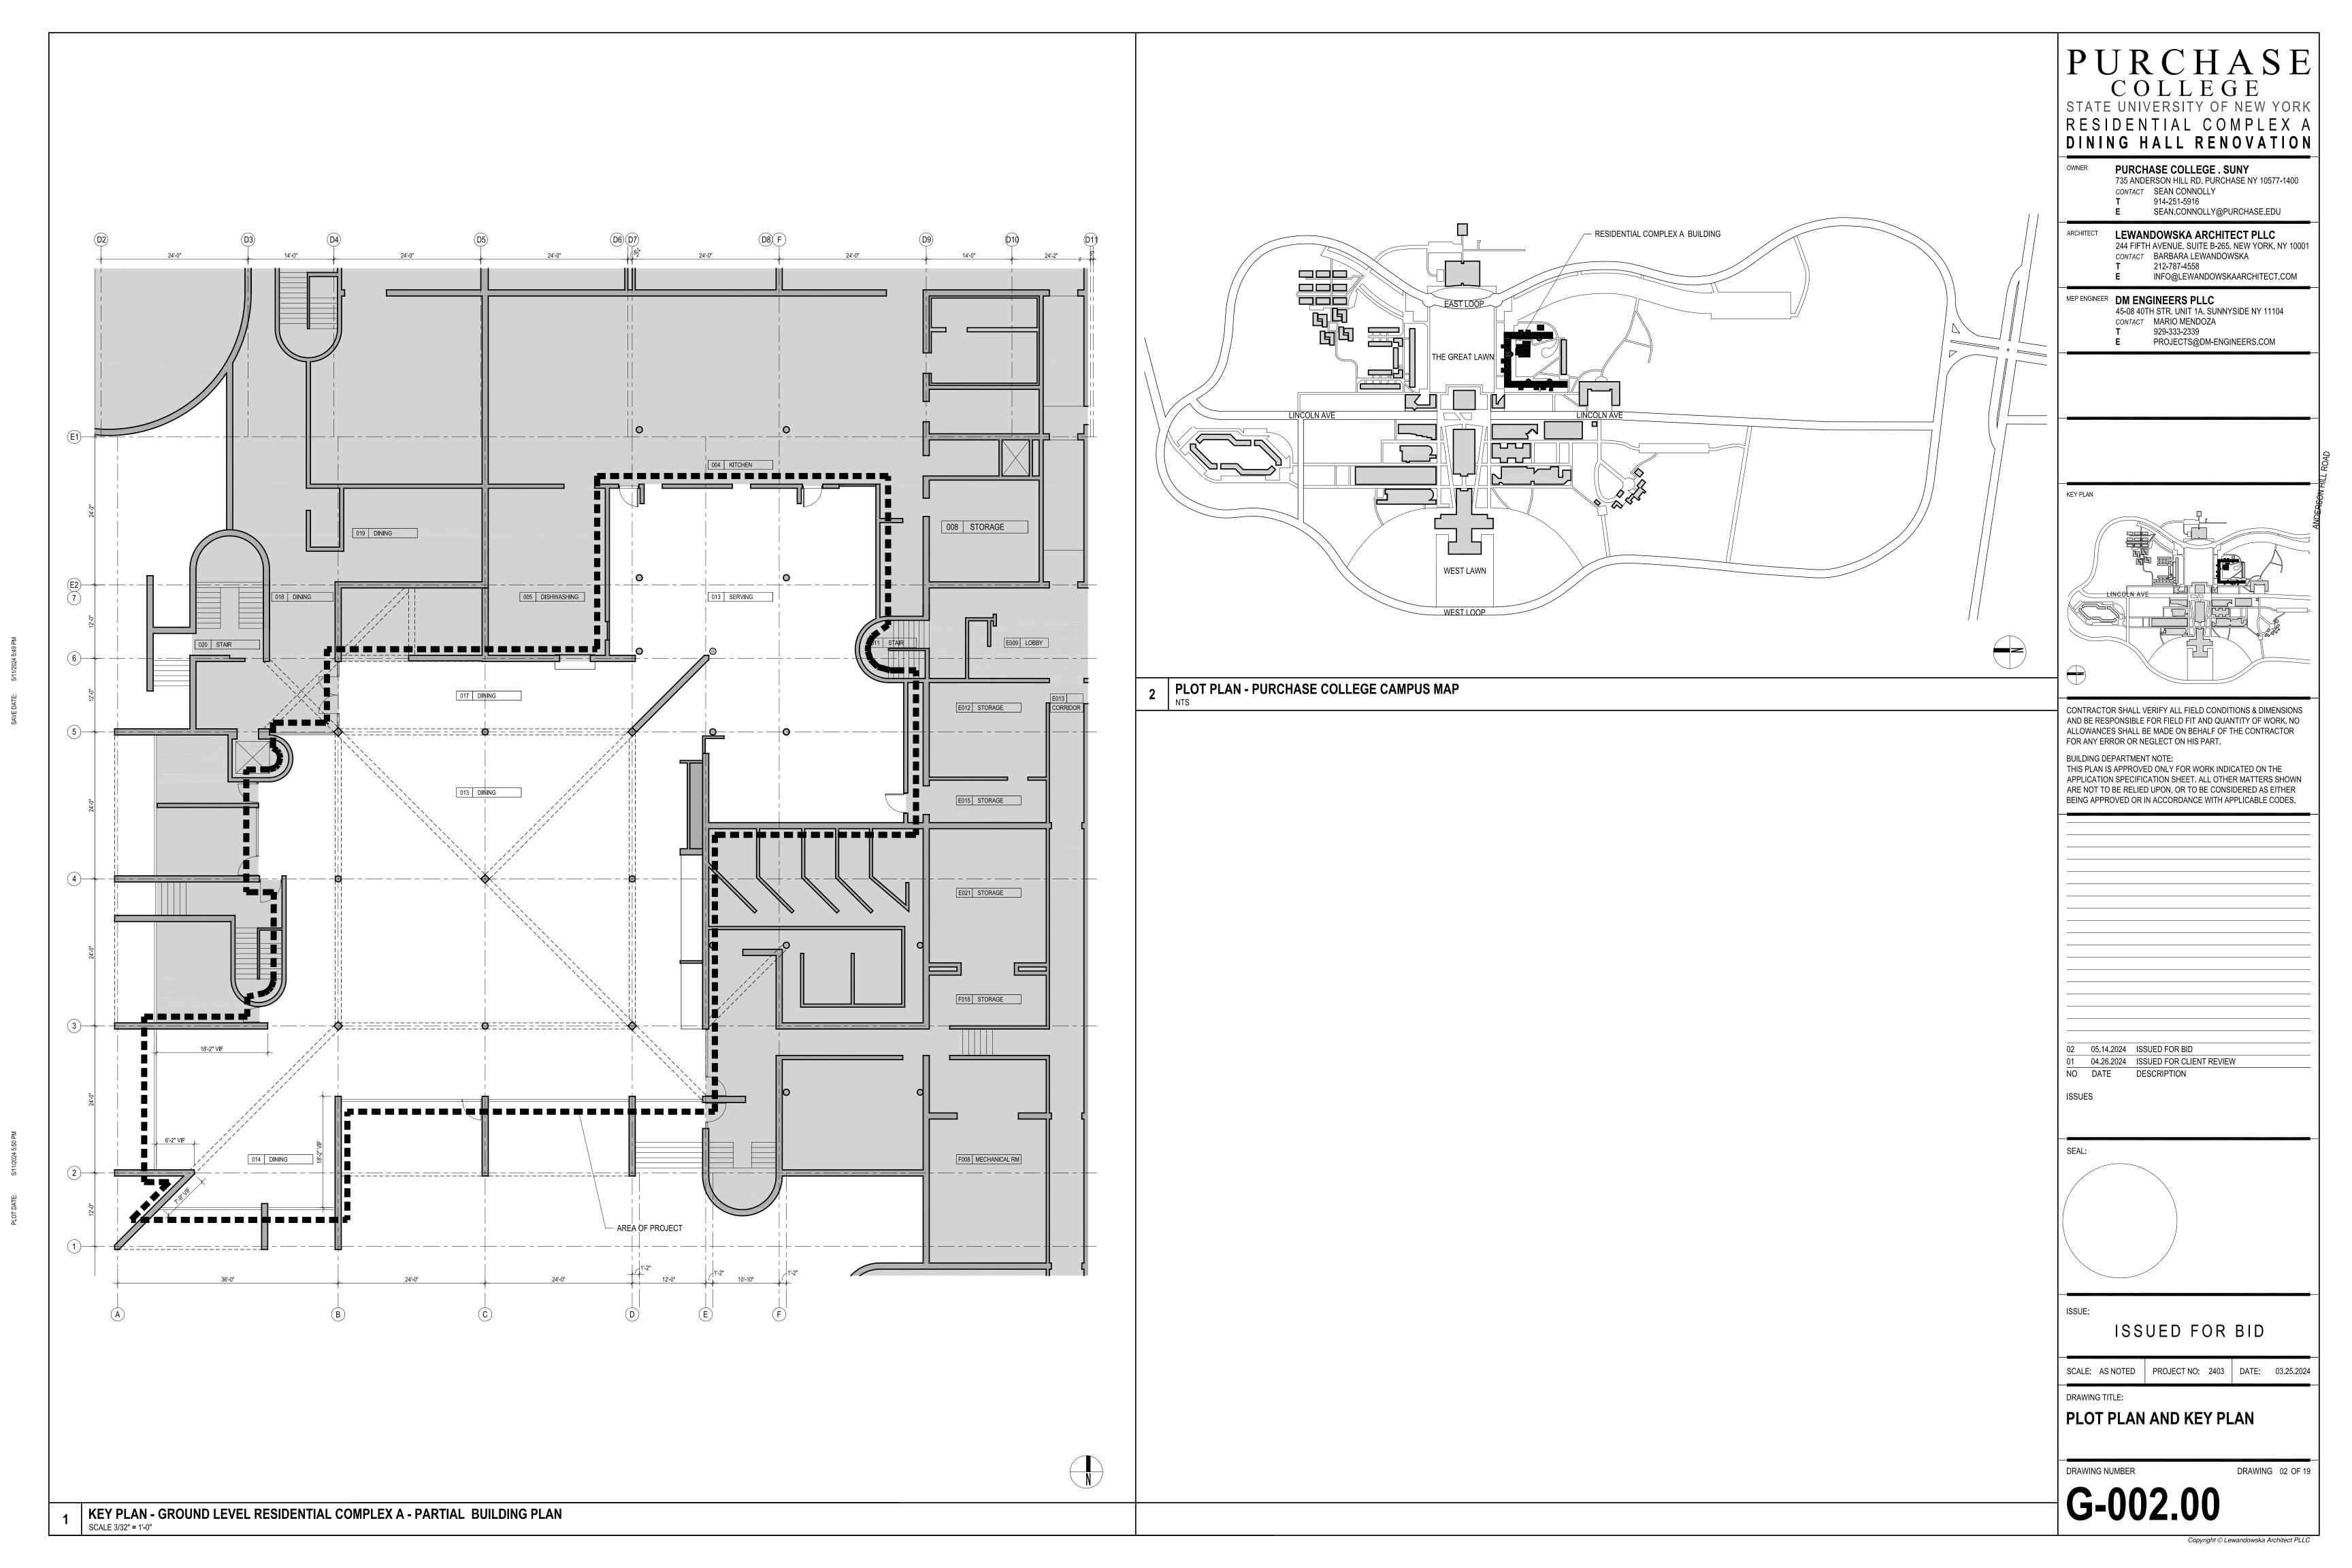

PURCHASE COLLEGE STATE UNIVERSITY OF NEW YORK RESIDENTIAL COMPLEX A DINING HALL RENOVATION


PURCHASE COLLEGE . SUNY 735 ANDERSON HILL RD. PURCHASE NY 10577-1400 CONTACT SEAN CONNOLLY 914-251-5916

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MEP ENGINEER DM ENGINEERS PLLC 45-08 40TH STR. UNIT 1A. SUNNYSIDE NY 11104 CONTACT MARIO MENDOZA 929-333-2339 PROJECTS@DM-ENGINEERS.COM

KEY PLAN



CONTRACTOR SHALL VERIFY ALL FIELD CONDITIONS & DIMENSIONS AND BE RESPONSIBLE FOR FIELD FIT AND QUANTITY OF WORK. NO ALLOWANCES SHALL BE MADE ON BEHALF OF THE CONTRACTOR FOR ANY ERROR OR NEGLECT ON HIS PART.

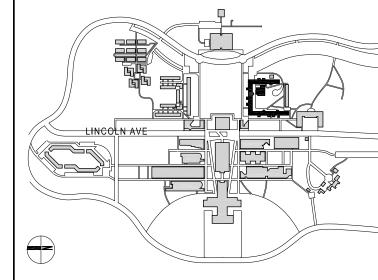BUILDING DEPARTMENT NOTE: THIS PLAN IS APPROVED ONLY FOR WORK INDICATED ON THE APPLICATION SPECIFICATION SHEET. ALL OTHER MATTERS SHOWN ARE NOT TO BE RELIED UPON, OR TO BE CONSIDERED AS EITHER

BEING APPROVED OR IN ACCORDANCE WITH APPLICABLE CODES.

02 05.14.2024 ISSUED FOR BID

1 04.26.2024 ISSUED FOR CLIENT REVIEW

NO DATE DESCRIPTION ISSUES

SEAL:

ISSUED FOR BID

SCALE: AS NOTED | PROJECT NO: 2403 | DATE: 03.25.2024

DRAWING TITLE:

GENERAL NOTES

DRAWING NUMBER DRAWING 05 OF 19

- 1.06 ALL APPROVALS SHALL BE FOR DESIGN APPEARANCE ONLY. CONTRACTOR(S) SHALL BE RESPONSIBLE FOR QUANTITIES, DIMENSIONS AND COMPLIANCE WITH CONTRACT DOCUMENTS, AND FOR INFORMATION PERTAINING TO FABRICATION PROCESS OR TECHNIQUES OF FIRST CLASS CONSTRUCTION AND FOR COORDINATION WITH OTHER
- 1.07 THE GENERAL CONTRACTOR SHALL MAINTAIN A CURRENT AND COMPLETE SET OF CONSTRUCTION DRAWINGS AT THE SITE DURING ALL PHASES OF CONSTRUCTION FOR USE BY ALL TRADES.
- 1.08 UPON ACCEPTANCE AND APPROVAL OF THE CONTRACT DOCUMENTS, THE GENERAL CONTRACTOR ASSUMES FULL RESPONSIBILITY FOR THE CONSTRUCTION, MATERIALS AND WORKMANSHIP OF THE WORK DESCRIBED HEREIN, AND HE SHALL BE EXPECTED TO COMPLY WITH THE SPIRIT AS WELL AS THE LETTER IN WHICH THEY WERE WRITTEN.
- 1.09 THE LANDLORD/BUILDING OWNER REQUIREMENTS FOR ALL ALTERATIONS SHALL APPLY TO ALL WORK. IT SHALL BE THE RESPONSIBILITY OF THE GENERAL CONTRACTOR TO FAMILIARIZE HIMSELF WITH THEM.
- 1.10 ALL CONTRACTORS SHALL CONTACT THE BUILDING MANAGEMENT TO DETERMINE THE RULES OF THE BUILDING OWNER FOR CONSTRUCTION, TO DETERMINE WHEN AND HOW DELIVERIES CAN BE MADE (SEE BELOW), WHAT PHASES OF CONSTRUCTION CAN BE DONE DURING REGULAR TIME OF OVERTIME, AND ANY SPECIAL BUILDING REQUIREMENTS WHICHWOULD AFFECT THEIR WORK. IF OVERTIME WORK IS REQUIRED BY ANY TRADE, APPROVAL MUST BE OBTAINED PRIOR TO THE EXECUTION OF ANY WORK, INCLUDING COST. THE GENERAL INTENT IS THAT MOST CONSTRUCTION WORK SHALL BE DONE DURING REGULAR HOURS.
- 1.11 EACH CONTRACTOR SHALL MAKE ALL REQUIRED ARRANGEMENTS FOR DELIVERY OF EQUIPMENT AND/OR MATERIALS. IT SHALL BE THE RESPONSIBILITY OF EACH CONTRACTOR TO CHECK THE RULES AND REGULATIONS GOVERNING WORK ON THE PREMISES, INCLUDING THE FOLLOWING:
- A. DATE AND TIME OF DELIVERY SHALL BE ESTABLISHED WITH CONJUNCTION WITH THE PERSON HAVING JURISDICTION OVER THE PREMISES (OVERTIME CHARGES AND/OR CONTRACTOR REQUIRING SERVICES.)
- B. BUILDING CONDITIONS INCLUDING SIZE & LOADING CAPACITY OF ELEVATORS, SIZE OF DOORWAYS, CORRIDORS, AND WINDOW OPENINGS ETC. SHALL BE CHECKED FOR ITEMS BEING DELIVERED BY THE CONTRACTOR REQUESTING DELIVERY.

- MEAN THAT SUCH SHALL BE FURNISHED, INSTALLED AND CONNECTED WHEN SO REQUIRED.
- 1.18 THE TERMS "EQUAL" OR "APPROVED EQUAL" IN CONNECTION WITH ANY ITEM SPECIFIED IS INTENDED TO MEAN THAT SUCH SHALL BE SUBMITTED TO THE ARCHITECT FOR APPROVAL.
- 1.19 THE GENERAL CONTRACTOR SHALL SUPPLY CUTS OF ALL FIXTURES AND EQUIPMENT CALLED FOR ON THE DRAWINGS, I.E., LIGHT FIXTURES, HARDWARE, ETC. FOR APPROVAL.
- 1.20 THE GENERAL CONTRACTOR SHALL SUBMIT FOR FABRICATION SHOP DRAWINGS AND FIXTURE CUTS TO THE ARCHITECT FOR REVIEW. ALL SHOP DRAWINGS AND CUTS SIGNED "NO EXCEPTIONS NOTED" SHALL SUPERSEDE ORIGINAL DRAWINGS IN DESIGN APPEARANCE ONLY. CONTRACTORS SHALL ASSUME RESPONSIBILITY FOR DISCREPANCIES IN THEIR DRAWINGS.
- 1.21 ALL WOODWORK ATTACHED TO PREMISES AND ALL WOOD DOORS SHALL BE DOUGLAS FIR UNLESS OTHERWISE NOTED, AND COMPLY WITH THE APPLICABLE ADMINISTRATIVE
- 1.22 THE GENERAL CONTRACTOR SHALL PROVIDE ALL NECESSARY PROTECTION FOR FLOORS, WALLS ETC., AND ANY EXISTING ITEMS TO REMAIN. THE GENERAL CONTRACTOR SHALL BE HELD RESPONSIBLE FOR ANY DAMAGE INCURRED TO THE SAME BY THE TRADES, AND SHALL BE OBLIGATED TO REPLACE OR RESTORE TO ITS ORIGINAL CONDITION, AS DETERMINED BY THE ARCHITECT.
- 1.23 THE GENERAL CONTRACTOR SHALL PROVIDE ALL NECESSARY PROTECTION AND SECURITY FOR HIS WORK UNTIL TURNED OVER TO THE OWNER.
- 1.24 IN HIS ESTIMATE. THE GENERAL CONTRACTOR SHALL INCLUDE ALL COSTS (INCLUDING OVERTIME WORK) FOR REMOVAL, NEW INSTALLATION, REINSTALLATION WORK FOR ANY PLUMBING, CEILING (REMOVAL AND REINSTALLATION), ELECTRICAL. TELEPHONE. COMMUNICATION EQUIPMENT. OR HVAC WORK ON FLOOR ABOVE AND BELOW THE TENANT SPACE TO COMPLETE WORK ON FLOOR BEING RENOVATED.
- 1.25 PRIOR TO BEGINNING OF ANY WORK, THE GENERAL CONTRACTOR SHALL FURNISH A CONSTRUCTION SCHEDULE SHOWING THE CHRONOLOGICAL PHASES OF HIS WORK, AND ALL RELATED WORK FOR THE COMPLETION OF THE PROJECT. THIS SCHEDULE SHALL INDICATE ALL ORDERING LEAD TIME, LENGTH OF TIME OF EACH PHASE, AND THE PROJECTED COMPLETION DATE.

- ALL ITS MATERIAL OR EQUIPMENT TO THE POINT OF USE, AND SHALL BE RESPONSIBLE FOR ALL UNLOADING, CHECKING AND STORING OF SAME IN CONNECTION WITH THIS CONTRACT.
- 1.32 THE GENERAL CONTRACTOR SHALL COORDINATE HIS WORK WITH THAT OF OTHER CONTRACTOR(S).
- 1.33 UNLESS OTHERWISE NOTED, ALL MATERIAL, EQUIPMENT, ETC. SHALL BE FURNISHED AND INSTALLED BY THE GENERAL CONTRACTOR.
- 1.34 THE GENERAL CONTRACTOR SHALL, AT THE TENANT'S DISCRETION, ENTER INTO AN AGREEMENT WITH THE TENANT UTILIZING THE APPROPRIATE A.I.A. FORM OF AGREEMENT BETWEEN OWNER AND CONTRACTOR.
- 1.35 THE GENERAL CONTRACTOR SHALL, AT THE TENANT'S DISCRETION, UTILIZE THE A.I.A. STANDARD FORM FOR REQUEST FOR PAYMENT AND FOLLOW ALL GUIDELINES ASSOCIATED THEREWITH.
- 1.36 THE GENERAL CONTRACTOR SHALL OBTAIN A BUILDING PERMIT FROM THE COLLEGE PRIOR TO COMMENCEMENT OF
- 1.37 THE GENERAL CONTRACTOR SHALL PROVIDE A PORTABLE TOILET FOR CONSTRUCTION PERSONNEL. ALL OTHER TOILETS SHALL BE LOCKED FOR THE PERIOD OF CONSTRUCTION.
- 1.38 DO NOT SCALE DRAWINGS, WRITTEN DIMENSIONS
- 1.39 THE ARCHITECT HAS NOT BEEN RETAINED TO PROVIDE SUPERVISION
- 1.40 ALL STRUCTURAL STEEL MEMBERS SHALL HAVE 2-HOUR RATED FIREPROOFING AT ALL LOCATIONS. SHOULD SUCH FIREPROOFING BE DAMAGED OR OTHERWISE MISSING FOR ANY REASON. IT SHOULD BE RESTORED IMMEDIATELY UPON SUCH DISCOVERY AS REQUIRED BY CODE.
- 1.41 THERE SHALL BE NO PENETRATION IN EXTERIOR BRICKWORK.

- 2.08 CORNER BEADS SHALL BE USED AT ALL EXPOSED GYPSUM BOARD CORNERS AND ENDS.
- 2.09 WHERE PARTITIONS ABUT THE PERIMETER ENCLOSURE, A SOUND BARRIER SHALL BE INSTALLED WITHIN THE ENCLOSURE TO ELIMINATE THE PASSAGE OF SOUND
- 2.10 WHERE NEW AND EXISTING BUILDING PARTITIONS ARE SHOWN TO ALIGN, THE JUNCTURE SHALL BE TAPED, SPACKLED, AND FINISHED SMOOTH.
- 2.11 ALL PARTITIONS ARE DIMENSIONED FINISH TO FINISH UNLESS OTHERWISE NOTED.

BETWEEN THE DIVIDED AREAS.

- 2.12 THE CONTRACTOR SHALL PROVIDE SUFFICIENT FRAMING FOR ALL OPENINGS FOR DUCTWORK AND RETURN AIR OPENINGS BELOW AND AT THE SUSPENDED CEILING. THESE SHALL BE COORDINATED WITH THE ENGINEER & MECHANICAL CONTRACTOR'S SHOP DRAWINGS. ALL OPENINGS SHALL BE PROPERLY SEALED FOR SOUNDPROOFING AND VIBRATION CONTROL.
- 2.13 WHERE A WALL IS SHOWN ALIGNED WITH MORE THAN ONE EXISTING COLUMN OR EXISTING WALLS, WHICH ARE NOT ALIGNED, THE CONTRACTOR SHALL ALIGN WITH THE FURTHEST PROJECTION, AND ALL OTHER SURFACES ALONG THIS ALIGNMENT SHALL BE FURRED OUT TO THIS LINE.
- 2.14 ALL "EXISTING TO REMAIN", "RELOCATED" OR "NEW" ITEMS INSTALLED BY THE GENERAL CONTRACTOR IN ADDITION TO BEING AMPLY PROTECTED THROUGHOUT THE PERIOD OF CONSTRUCTION. SHALL BE THOROUGHLY CLEANED TO THE SATISFACTION OF THE ARCHITECT PRIOR TO BEING TURNED OVER TO THE OWNER.
- 2.15 THE GENERAL CONTRACTOR SHALL THOROUGHLY CLEAN COVE AND STRAIGHT BASE. VISIBLE METAL WINDOW WORK: ALL DOORS AND CONVECTOR ENCLOSURES, ETC. AT THE COMPLETION OF CONSTRUCTION.
- 2.16 THE GENERAL CONTRACTOR SHALL THOROUGHLY CLEAN ALL DEBRIS AND VACUUM CLEAN CARPETING. LIGHT FIXTURES ARE TO BE CLEANED OF DUST AT COMPLETION OF CONSTRUCTION.
- 2.17 ALL GYPSUM BOARD USED IN DRYWALL PARTITIONS SHALL BE FIRE CODE "C".ALL WOOD AND PLYWOOD USED FOR BLOCKING SHALL BE FIRE-RATED AS PER CLASS I FIREPROOF BUILDING REQUIREMENTS.

#### 2. CONSTRUCTION NOTES CONT'D

- 2.18 THE SPACE AROUND PIPES, DUCTS ETC., PENETRATING FIRE RATED WALLS, SHALL NOT EXCEED 1/2" AND SHALL BE PACKED SOLID WITH MINERAL WOOL OR EQUAL, AND BE CLOSED OFF BY CLOSE FITTING ESCUTCHEONS AT BOTH SIDES OF THE CONSTRUCTION AS REQUIRED BY LOCAL BUILDING CODES.
- 2.19 PROVIDE AS MANY AS REQUIRED 4' X 8' X 3/4" THICK PLYWOOD A-C PANELS AROUND ALL TELEPHONE AND COMMUNICATION CLOSETS AS DIRECTED BY THE OWNER. MODIFY PANEL SIZES AS REQUIRED BY FIELD CONDITIONS.
- 2.20 HOLD NEW WALL CONSTRUCTION 1" BACK FROM REMOVABLE CONVECTOR/RADIATOR ENCLOSURES.
- 2.21 THE CONTRACTOR SHALL BE RESPONSIBLE FOR FIELD SUPERVISION OF ALL HVAC WORK DURING INSTALLATION AND SHALL INSPECT ALL SYSTEMS FOR PROPER OPERATION AT COMPLETION OF THE JOB.
- 2.22 SHOP DRAWINGS OF DUCT WORK AND REGISTERS INCLUDING ACCESS PANELS, IF REQUIRED, SHALL BE SUBMITTED TO THE ARCHITECT FOR APPROVAL PRIOR TO PROCEEDING WITH FABRICATION AND/OR INSTALLATION.
- 2.23 INSTALLATION OF MECHANICAL EQUIPMENT SHALL BE COORDINATED WITH ALL TRADES AS REQUIRED FOR PROPER
- 2.24 ANY BUILDING SHUT DOWNS FOR THIS WORK SHALL BE REQUIRED IN WRITING BY THE CONTRACTOR AT LEAST 72 HOURS IN ADVANCE OF THE SHUT DOWN. THE CONTRACTOR SHALL OBTAIN APPROVAL FROM ALL AUTHORITIES HAVING JURISDICTION PRIOR TO SHUT DOWN.
- 2.25 ALL PERIPHERAL SHUT-OFF VALVES SHALL BE ACCESSIBLE AT ALL TIMES.
- 2.26 NOT USED

#### CONSTRUCTION NOTES-DOORS

- 2.27 ALL DOORS AND FRAMES SHALL BE FABRICATED AS SPECIFIED ON THE DOOR SCHEDULE AND AS SHOWN ON THE DRAWINGS, OR CALLED FOR ON THE CONSTRUCTION DETAILS, EXCEPT AS NOTED.
- 2.28 ALL DOORS SHALL HAVE 1/2" UNDERCUT, UNLESS OTHERWISE NOTED.
- 2.29 ALL DOOR FRAMES SHALL HAVE CONCEALED REINFORCEMENT FOR DOOR JAMBS, AND SHALL BE PUNCHED FOR SILENCERS. DOORS AND DOOR FRAMES SHALL BE INSTALLED IN ACCORDANCE WITH THE MANUFACTURER'S INSTRUCTIONS, AND SHALL BE WELDED, UNLESS OTHERWISE
- 2.30 UNLESS OTHERWISE NOTED, ALL HARDWARE SHALL BE SUPPLIED BY THE GENERAL CONTRACTOR, AS SPECIFIED AND MATCHING THE EXISTING IN STYLE AND MAKE, IF REQUIRED.
- 2.31 ALL LOCK SETS SHALL BE CODED AND/OR KEYED IN ACCORDANCE WITH THE BUILDING REQUIREMENTS, CODES AND/OR KEYS ARE TO BE DELIVERED TO THE OWNER PROPERLY TESTED AND TAGGED. PROVIDE THREE MASTER KEYS AND THREE PASS KEYS FOR EACH LOCK.
- 2.32 DETAILED HOLLOW METAL AND HARDWARE SCHEDULES SHALL BE SUBMITTED TO THE ARCHITECT FOR REVIEW, AND FABRICATION OF MATERIAL SHALL NOT BE COMMENCED UNTIL SUCH REVIEW (NO EXCEPTION NOTED) HAS BEEN RECEIVED. THIS REVIEW SHALL NOT RELIEVE THE CONTRACTOR FROM RESPONSIBILITY TO SATISFY CONSTRUCTION DRAWINGS INTENT.
- 2.33 ALL WOOD DOORS AND FRAMES SHALL CONFORM TO STANDARDS BY GOVERNING AGENCIES HAVING JURISDICTION FOR RATED DOORS, IF REQUIRED.

3. NOT USED

4. NOT USED

### COLLEGE STATE UNIVERSITY OF NEW YORK

RESIDENTIAL COMPLEX A DINING HALL RENOVATION


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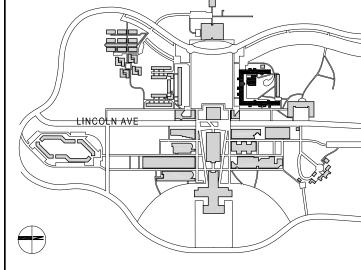
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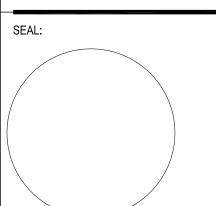
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- 02 05.14.2024 ISSUED FOR BID 01 04.26.2024 ISSUED FOR CLIENT REVIEW

NO DATE DESCRIPTION ISSUES



ISSUED FOR BID

SCALE: AS NOTED | PROJECT NO: 2403 | DATE: 03.25.2024

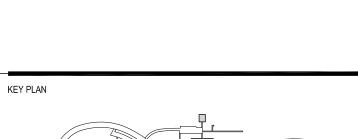DRAWING TITLE:

**GENERAL NOTES** 

DRAWING NUMBER

DRAWING 06 OF 19

t © Lewandowska Architect PLLC

© Lewandowska Architect PLLC

Surface mounted

Existing

Existing

Multiple existing uses

Existing to remain

Existing

Existing

Existing

Existing

Existing

Source:

Lamps:

Voltage:

Wattage:

Contractor to reuse existing track and lamps, which include accent lights, downlights, wall washers, heat lamps and other. Coordinate with

Lamps/Unit:

Manufacturer / Model Name

Mounting:

Function:

Remarks:

Reflected Ceiling Plan.

Finish:

Size:

Recessed

Direct recessed

4" linear aperture

4 ft and 8 ft lengths

ceiling adjacent to the fixture as required to match new width of the linear light fixtures.

Corelite

Continua™ SQ4

LED

Direct

**D**=None (Default Dimming)

Finish Mounting Run Length

PURCHASE

RESIDENTIAL COMPLEX A

Surface Mounted

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ISSUES

SEAL:

DRAWING TITLE:

DRAWING NUMBER

· 0-10V dimming to 1% standard WaveLinx sensor compatible for IoT capability Enlighted sensor compatible for IoT capability

nergency Options · Emergency circuit option operates entire downlight portion of a specified unit (4 ft, 6 ft, 8 ft, or 12 ft)

UL 924 emergency/generator transfer options available

DALI 2.0 and Lutron dimming available

Integrated Controls

roll lens up to 100 ft. Optional 6-watt 120-277V integral emergency battery BB(Black) and WB(White): Injection molded louvered baffles illuminates a 4 ft. down-light section with 1.5" openings for glare management and frosted glare 90-minute backup period for code compliance control diffuser to shield direct view of LEDs and lower UGR Test switch/indicator button located on the top side of the

< 3.5 lbs. per foot</li>

cULus listed for damp locations

Tested to IESNA LM-79 and LM-80

values and improve visual comfort. PC3, PP3, PW1, PR1, PH1: Proprietary Perceive™ optical system enables dynamic visual depth on a flat surface while watt of the desired fixture by the wattage of the emergency providing glare-reducing performance with comfortable, high-quality illumination. Perceive continuous flexible roll battery pack (100 lm/W x 6 = 600 lumens) ens creates seamless illumination along entire row length. Battery is self-testing

Precision engineered acrylic TIR optics on LED light engines for optimal light uniformity on continuous lens **LED and Light Engine** 

WB-B

White Baffle

PC3-W

WB-W

Black Fixture Finish White Fixture Finish White Fixture Finish Black Fixture Finish

White Baffle

Single piece roll lens up to 100 ft.

roll lens up to 100 ft.

• LEDs are available in 3000K, 3500K, 4000K CRI options of either ≥80CRI or ≥90CRI Surface mount fixture mounts directly to structure over a 2"x adjustment factor tables

· Lumen output will be affected - please refer to the lumen TM21 life at 60,000 hours up to L84 and calculated L70 exceeds 121,000 hrs. Drivers available in 120-277V and 347V

· F: Frosted continuous flexible roll lens creates seamless

illumination along entire row length. Single piece roll lens

seamless illumination along entire row length. Single piece

FA: Frosted Asymmetric continuous flexible roll lens creates

seamless illumination along entire row length. Single piece

FB: Frosted batwing continuous flexible roll lens creates

RoHS compliant Stated life per TM21 standards Can be used for State of California Title 24 high efficacy

PW1-W

White Fixture Finish White Fixture Finish White Fixture Finish White Fixture Finish

Perceive PARAmid Lens Perceive Prism Lens Perceive Waves Lens Perceive Ripple Lens Perceive Honeycomb Lens

PP3-W

PR1-W PH1-W

Cooper Lighting / Corelite Continua SQ4 Manufacturer / Model Name LED Mounting: Surface mounted Source: 3000K Function: Direct light Lamps: linear, frosted continuous lens Finish: White powder coated Lamps/Unit: 120V 4" wide, 2, 4, 6, 8 and 12 feet sections Size: Voltage: -W modular design (connect sections) Wattage:

Remarks:

Top Product Features

Up to 124 lumens per watt

· Compact square design with integral electrical

Options to meet Buy American Act requirements

• Seamless illumination with single-piece luminous roll lens • 5 differentiated Perceive lenses in a seamless roll lens • Black and white glare reducing louvered baffle options

• BioUp melanopic lighting options for 30% circadian boost a

24" [610mm]

Note: End caps add .75" at each end. Sensor end caps add 1.5

WB=White Baffle Frosted Diffuser

PC3=Perceive
PARAmid
PP3=Perceive Prism
PW1=Perceive Waves
PR1=Perceive Ripple

Notes F, PC3, PP3, PW1, PR1,

LH=Lutron HiLume 1% EcoSystems (LDE1)
W2A=Tunable White, 2ch, 0-10V Intensity
and CCT Control
WS (formerly WAA)=WaveLinx PRO Wireless
Sensor, Occupancy w/ photocell, Networked (A)
LWIPD1=Enlighted Wireless Integrated Sensor

ration. See Driver Availability tables for more details. sensor must be used with "SR" driver. Integrated Sensor

channels - color and intensity. May be combined with WaveLinx.

W2D for use with BioUp options only. Tunable White CCT between 2700K and 5000K. Must be used with DALI controls; one address to control two channels - intensity and CCT.

| UNV=Univeral (120V-277V) | STD=Standard 0-10V (1%-100%) | SR=Sensor Ready (1%-100%)

**Product Specifications** 

· Single-piece extruded aluminum housing

Die-formed 22 gauge cold rolled steel top housing cover

Die cast aluminum end caps allow for expansion of roll lens

Standard end cap adds 0.75" at each end. Integrated sensor

Modular design eliminates the need for starter, intermediate,

See table on page 4 for standard continuous row length

· Electrostatically applied polyester powder coat paint

· All sections are continuously wired with push-in connectors

Refer to installation instructions for various ceiling interface

White, silver, and black finishes are standard.

**Shielding & Finish Options** 

RAL custom colors are available

4" standard electrical box

Attach mechanically to the end of the fixture without

Available in 2-ft, 4-ft, 6-ft, 8-ft and 12-ft sections

3.75" x 3.75" square profile

to eliminate light leak

exposed fasteners

breakdowns

Driver accessible from above

end cap adds 1.5" at each end

Construction

and CCT Control
W2D=Tunable White, DALI Type 8 (1%-

F=Frosted Continuous
Roll Lens
FB= Batwing Frosted
Continuous Roll Lens
FA= Asymmetric
Frosted Continuous
Roll Lens
BB=Black Baffle,
Frosted Diffuser

**830**=3000K, 80CRI **835**=3500K, 80CRI

840=4000K, 80CRI 930=3000K, 90CRI 935=3500K, 90CRI 940=4000K, 90CRI

WLS (formerly WAB)=WaveLinx LITE Wireless BSL6=Bodine 6-watt, 120V-277V

93050-White Tuning 3000K-5000K 92765-White Tuning 2700K-6500K B35-BioUp Static 3500K B40-BioUp Static 4000K B50-BioUp Static 5000K

B2750=BioUp Tunable White 2700K-5000K

components and circuiting options

Contractor shall replace existing sections with one continuous run.

**Corelite** 

Manufacturer / Model Name

Function:

Remarks:

Finish:

Size:

CL4

LED Recessed Direct

• Commerical Office Spaces • Schools • Hospitals • Retail Merchandising Areas

4.0" [101mm]

Corelite

**Order Information** 

**Drywall Ceiling Dimensions** Flanged (FG) \_\_ 4.25" CUTOUT

SAMPLE ORDER NUMBER: CL4DR-F-80D840-1B1-UNV-STD-SWPD1-CP-W-T1-20

Drywall ceiling note: actual length of 'fg' fixures will be 1" shorter in length than total requested run length for all recessed fixtures Overall run length = 'fixture order length' - 1" e.g. - overall run length of 47" will ship when ordering a '4ft' fixture

P Interactive Menu • Order Information page 2 • Photometric Data page 3 • Run Configurations page 3 • Integrated Sensor Details page 4

#### **Top Product Features**

Product Warranty

Cooper Lighting / Corelite CL4DR-F-930-1-UNV-STD-W-FG-8

Linear, frosted lens

LED

3000K

120V

Source:

Lamps:

Voltage:

Wattage:

High performance efficacy fixture. Contractor to coordinate location with Reflected Ceiling Plan. Contractor shall extend/patch gypsum

Lamps/Unit:

• 2" and 4" linear aperture sizes

• 4 ft. and 8 ft. lengths for individual or continuous runs High performance efficacy up to 122 lumens per watt • Fits a variety of different architectural ceiling types

· Integrated wireless sensor control available

CL4 - Recessed

Icon Key: Grey bar denotes available with 10-Day Ouick Spec

cULus listed for damp locations

Tested to IESNA LM-79 and LM-80

Stated life per TM21 standards

IC Rated for insulation contact (except where noted)

Can be used for State of California Title 24 high

• Five year warranty standard. Optional ten year

DesignLights Consortium® Qualified and classified

for DLC Standard, refer to <a href="https://www.designlights.org">www.designlights.org</a> for

Meets NYC requirements

efficacy luminaire

warranty available

Warrantv

Light Distribution	Shielding Down	Lumen Package Down	CCT & Min CRI	Circuiting	Emergency	Voltage
Light Distribution	Shielding Down	Lumen Package Down	CCT & Min CRI	Circuiting	Emergency	Voltage
CL4DR=Corelite CL Series 4" Aperture Direct Recessed QS-CL4DR=Corelite CL Series 4" Aperture Direct Recessed Quick Spec	F=Frosted Flush Diffuser A=Asymmetric Flush Optic	40D=400 lumens/ft 60D=600 lumens/ft 80D=800 lumens/ft 100D=1000 lumens/ft 120D=1200 lumens/ft	830=3000K, 80+ CRI 835=3500K, 80+ CRI 840=4000K, 80+ CRI 930=3000K, 90+ CRI 935=3500K, 90+ CRI 940=4000K, 90+ CRI	1=Single Circuit S=Secondary Circuit	[Blank]=No Emergency E=Emergency Circuit B1=7-watt 120V-277V Integral EM Battery B2=14-watt 120V-277V Integral EM Battery EPC=EPC UL924 Device	<b>UNV</b> =Universal (120-277V) <b>347</b> =347V
Notes	Notes All lensing options are snap-in lenses	Notes  Nominal lumen output. Refer to performance table on Page 3 for more detail.	Notes Additional lead-time may apply for 930, 935 and 940 configurations.	Notes Secondary circuit similar to A/B switching. Secondary circuit not available with sensor options.	Notes Fixture Non-IC-Rated for internal battery and lumen output ±1000 Lms/ft. External battery standard with chicago plenum.	Notes 347V only available with STD driver.

Integral LED Driver	Integrated Sensor	Options	Finish	Ceiling Type	Length
Integral LED Driver	Integrated Sensor	Options	Finish	Ceiling Type	Length
STD=Standard 0-10V (1%-100%) 5LT=Fifth Light DALI (1%-100%) LH=Lutron HiLume 1% EcoSystems (LDE1)	[Blank]=No Sensor WAA=WaveLinx Wireless Integrated Sensor <sup>(A)</sup> WAB=WaveLinx Lite Wireless Integrated Sensor <sup>(B)</sup> SVPD1=0-10V Stand-alone Integrated Sensor <sup>(D)</sup>	CP=Chicago Plenum	<b>W</b> =White	T1=15/16" T-Grid, 9/16" T-Grid T2=9/16" Slot T-Grid, 9/16" Tegular T-Grid FG=Flanged (Gypsum Board)	4-4' Individual 8-8' Individual XX-4' Incremental Run (e.g. 40-40')
Notes	Notes	Notes	Notes	Notes	Notes
Additional lead-time may apply for 5LT and LH configurations.	Sensor options must be used with 'STD' driver. Please refer to page 4 for additional detail. Integrated options must be used in conjunction with the associated system and may not be compatible with other options or accessories. Please refer to the following: (A) Consult WaveLinx system pages for additional details and compatibility. (B) WaveLinx Lite devuces are not currently compatible with the WaveLinx Wireless Area Controller. Consult WaveLinx Lite system pages for additional details and compatibility. (B) Consult SyPD series system pages for additional details and compatibility. (D) Consult SyPD series system pages for additional details and compatibility.	Meets CCEC requirements		Please refer to ceiling interface diagrams for additional detail and dimensions.	Standard row configurations over 8' consist of 4' and 8' luminaires.

**Product Specifications** 

· Formed housing with precision cut housing trim extruded from 6063 aluminum. Laser-cut formed cold rolled steel endcaps Die-formed 22 gauge cold rolled steel pre-paint white reflector Driver accessible from below

 4 ft and 8 ft fully illuminated sections for individual See table on page 3 for continuous row length

 Electrostatically applied polyester powder coat paint Recessed lay-in for T-grid installation or direct into gypsum with ½" flange · All sections are continuously wired with plug-in connectors for fast installation Fixtures can be joined for straight continuous runs using rigid alignment features

 Frosted (F) – Flush, high diffusion pixilation-free Asymmetric (A) - Flush, internal prismatic design for asymmetric distribution Patent-pending under-lens solution eliminates light  LED's are available in 3000K, 3500K, 4000K CRI options of either ≥80CRI or ≥90CRI Lumen output will be affected - please refer to the lumen adjustment factor tables TM21 life at 60,000 hours up to L94 and calculated L70 exceeds 400,000 hrs

Drivers available in 120-277V and 347V Integrated Controls 0-10V dimming to 1% standard WaveLinx wireless sensor compatible for standalone, controlled, connected, and IoT capability SVPD sensor compatible for standalone · Low-voltage sensor and driver compatible for DLVF

DALI 2.0, Lutron, and step-dimming available

**Emergency Options** Default emergency circuit section (E) is 4 ft. in length and located at the beginning of the fixture unless designated elsewhere Optional 120-277V emergency battery provided internal to fixture with pre-wired external test switch 90-minute backup period for code compliance Estimated lumen output = battery wattage x min

efficacy - see performance table (e.g. 100 lm/W x 14 = 1400 lumens) UL 924 emergency/generator transfer options

2.7 lbs. per foot

View IES files FILE NAME: FILE NAME: CL4DR-F-80D835-1-UNV-STD-W-4 CL4DR-A-80D835-1-UNV-STD-W-4 LUMENS: 3331 Lms LUMENS: 3203 Lms 1598 — **LPW:** 121.3 LPW **LPW:** 126.2 LPW 1065 ----CCT: 3500K CCT: 3500K **WATTS:** 26.2 W **WATTS: 26.4 W** 

Photometric Data 1252 —

626 — 313 -----TEST NUMBER: G3-1802-639-21 TEST NUMBER: G3-1802-639-5 FROSTED FLUSH LENS

DRAWING 09 OF 19

ISSUED FOR BID

SCALE: AS NOTED | PROJECT NO: 2403 | DATE: 03.25.2024

LIGHTING FIXTURES SCHEDULE

Surface mount

Fixed downlight

Matte white

1.37" high

12" dia round

INFO@LEWANDOWSKAARCHITECT.COM

PROJECTS@DM-ENGINEERS.COM

PURCHASE

RESIDENTIAL COMPLEX A

914-251-5916

BUILDING DEPARTMENT NOTE: THIS PLAN IS APPROVED ONLY FOR WORK INDICATED ON THE APPLICATION SPECIFICATION SHEET. ALL OTHER MATTERS SHOWN ARE NOT TO BE RELIED UPON, OR TO BE CONSIDERED AS EITHER BEING APPROVED OR IN ACCORDANCE WITH APPLICABLE CODES.

02 05.14.2024 ISSUED FOR BID 1 04.26.2024 ISSUED FOR CLIENT REVIEW NO DATE DESCRIPTION

Can be used for International Energy Conservation Code (IECC) and high efficiency luminaire SEAL:

Five-year limited warranty

• cULus Certified in US and Canada.

IES LM-80-08 and TM-21-11.

Wet and Damp Location listed, airtight per

EMI/RFI emissions per FCC 47CFR Part 15B

Photometric testing in accordance with IES

Can be used for State of California Title 24 high

California Energy Commission Title 20 Appliance

efficacy luminaire compliance, reference the

Efficiency Database for current listings.

Suitable for use in closets, compliant with NFPA®

Contains no mercury or lead and RoHS compliant.

Lumen maintenance projections in accordance with

70, NEC® Section 410.16 (A)(3) and 410.16 (C)(5)

CCT - Range of 2700K- 5000K

ISSUES

SCALE: AS NOTED | PROJECT NO: 2403 | DATE: 03.25.2024

LIGHTING FIXTURES SCHEDULE


DRAWING NUMBER

RECESSED DOWNLIGHT - BASE BUILDING **Existing to remain** 

Manufacturer / Model Name Retrofit LED Mounting: Recessed Source: Fixed Downlight 3000K Function: Lamps: Finish: Flangeless Lamps/Unit: 1 each Existing Existing Size: Voltage: Existing Wattage:

Remarks:

Existing downlights in existing plaster ceiling trughout the building are to remain. Contractor to protect the flange and the fixture when finishing/painting the ceiling. Ground floor dining area replace the bulb with compatible retrofit LED.

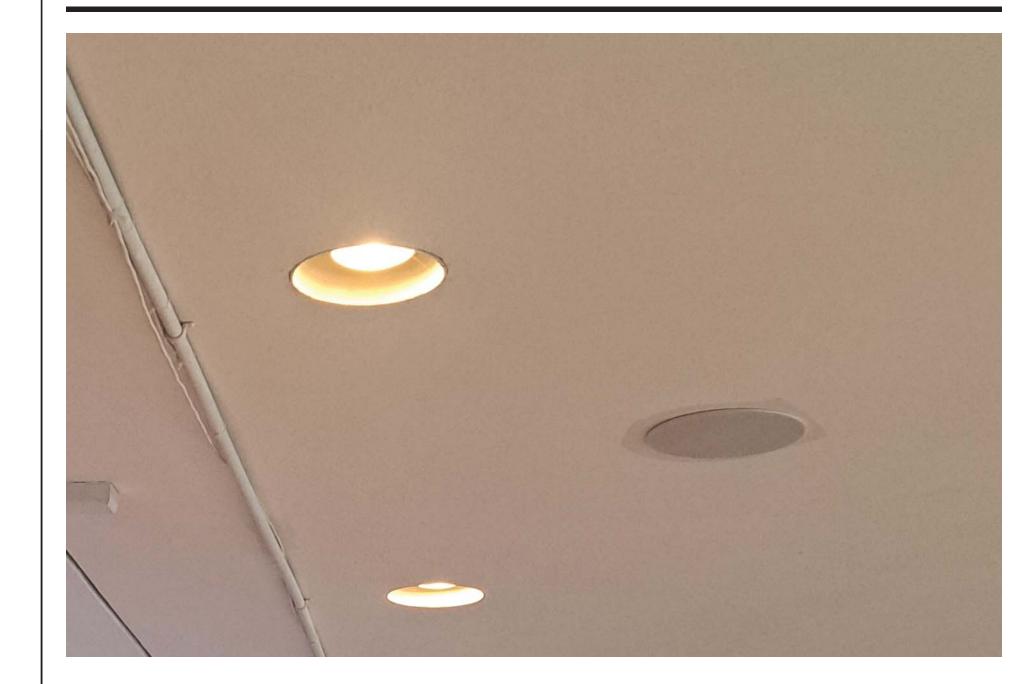

Remarks:

Replace the existing fixtures in an existing or new location. Contractor to coordinate location with Reflected Ceiling Plan. Installation instructions as per manufacturer recommendation.

#### BeveLED 2.2 Retrofit - B4RDRT 4.5" Round Downlight



usailighting.com/beveledRT

Introducing BeveLED 2.2, the newest generation of our iconic BeveLED 2.1 family. BeveLED is most complete recessed LED downlight product family available, and the best solution for any project. Now available with industry-leading performance and features that includes:

- Install-from-below in existing ceilings with retrofit housing
- · Dry/damp/wet location rated for bathrooms and showers
- 1% dimming standard + more dimming options · Clear overspray protector for installation convenience
- Full family platform

D	OWNLIGHT PERFORMANCE DATA

DOWNLIGHT PERFO	DRMANCE D	ATA		LE	D COLOR CHO	ICES			
DELIVERED*			Classic	c White	•		Warm G	low Dimming	
PERFORMANCE:	9W	12W	16W	24W	33W	36W	16W	32W	
Source Lumens:	1150	1300	1725	2400	3025	4150	1275	2150	
Lumens Per Watt:	93	86	86	80	71	99	69	61	
Delivered Lumens:	775	1025	1375	1925	2400	3450	1100	1800	

\*Based on 3000K, 80+ CRI. Performance varies for each specific beamspread and color temperature. See IES files for exact values at usailighting.com.

CORRELATED COLOR TEMPERATURE			0	Classic Wh	ite					Warm Glow [	imming	
MULTIPLIER	2700	K	3000	K	3500	K	4000	K	2700	K	3000К	
Color Rendering Index:	80+	90+	80+	90+	80+	90+	80+	90+	80+	90+	80+	90+
Multiplier for Lumen Output:	0.94	0.78	1.00	0.78	1.00	1.00	1.06	1.06	0.94	0.74	1.00	0.80

<b>B4RDRT</b>	16C3	30KH	50	S	WH-WH	RT	-	*
Fixture	Wattage	LED Color	Beam	Lens	Finish	Housing Choices	Driver Location	Voltage & Dimmine Driver
RT BeveLED 4.5" Retrofit	09C3	Classic White	25° beam 30	Solite (provided standard)	Single Color	RT Retrofit Install-From-Below Housing	- Integral Driver	Universal Voltage 120V-277V
netrone	9W LED	2700K, 80+ CRI	30° beam	SF	White	riousing	_	No Additional Charge
	<b>12C3</b> 12W LED	<b>27KH</b> 2700K, 90+ CRI	<b>50</b> 50° beam	Solite Frosted  BF	GR-GR Grey			UNV-D6E EldoLED 0-10V, 1%
	<b>16C3</b> 16W LED	<b>30KS</b> 3000K, 80+ CRI	<b>90</b> 90° beam	Borosilicate Frosted  AS61	<b>BL-BL</b> Black			UNV-D6F EldoLED 0-10V, 1%
	24C3 24W LED	<b>30KH</b> 3000K, 90+ CRI	1	Linear Spread CTS25	<b>BZ-BZ</b> Bronze			UNV-D4H Lutron H ECO, 1% Fade
	33C3 33W LED	<b>35KS</b> 3500K, 80+ CRI		Solite lens with warm filter coating, 1/4 CTO	PR-PR Primer Finish			UNV-D4C Lutron Ecosystem, 1%
	36E1 36W LED	35KH 3500K, 90+ CRI		reduces output by ~15% and shifts CCT down by	<b>QW-QW</b> Antimicrobial Paint, White			UNV-D6A EldoLED 0-10V, 0.1%
	30W LED	40KS 400K, 80+ CRI		~250K <b>HX</b>	RAL-RAL Custom Color Specify RAL#			UNV-D6B EldoLED 0-10V, 0.1%
		4000K, 80+ CRI 40KH 4000K, 90+ CRI		Hexcell louver trim lens	Dual Tone			UNV-D7A EldoLED DALI2, 0.1%
		Warm Glow			AC-WH AC bevel, WH flange			UNV-D7B EldoLED DALI2, 0.1%
	16WG2	2722KS			AC-BL AC bevel, BL flange			UNV-D7E EldoLED DALI2, 1%
	16W LED 32WG2	2700K-2200K, 80+ CRI			AC-SC AC bevel, SC flange			UNV-D7F EldoLED DALI2, 1%
	32W LED	<b>2722KH</b> 2700K-2200K, 90+ CRI			<b>AB-WH</b> AB bevel, WH flange			UNV-D28 EldoLED DMX, 0.1%
		3022KS			<b>AB-GR</b> AB bevel, GR flange			120V Only
		3000K-2200K, 80+ CRI			<b>AB-BL</b> AB bevel, BL flange			<b>120V-D19</b> Phase 2-wire, 1%
		<b>3022KH</b> 3000K-2200K, 90+ CRI						120V-D29 ERP PHB Phase 2-wire, 1%

FIELD REPLACEABLE LED LIGHT ENGINE is serviceable through the aperture with a Phillips screwdriver.

USAI CLASSIC WHITE LED COLOR TECHNOLOGY: is tightly binned for fixture-to-fixture color consistency within a 2-Step MacAdam's Ellipse.

**TRIM:** Die cast aluminum beveled trim has a 4.5" aperture with a 1" regressed bevel and retains a glass lens.

MOUNTING: BeveLED 2.2 Retrofit fixtures install from below the ceiling. Fixture is held in place with (2) leaf springs attached to flanged die case aluminum mounting collar, which is powder-coated with trim finish specified.

**CEILING CUT OUT:** 5-1/2" Diameter circle

WARRANTY: Based on IESNA LM80-2008, USAI Lighting LED light fixtures have a 50,000 hour rated life at 70% lumen maintenance (L70). USAI Lighting Warranty covers replacement parts for 5 years from date of shipment. Ambient temperatures at fixture location should not exceed 40 degrees C.

LISTINGS: Dry/Damp/Wet listed under covered ceilings only. AC and AB trim finishes are dry/damp only. EM Integral tes  $switch is dry/damp/wet \ rated; EM \ remote \ test \ switch is \ dry/damp \ only. \ Select \ EMW \ option \ for \ wet \ location \ remote \ test \ switch \ is \ dry/damp \ only. \ Select \ EMW \ option \ for \ wet \ location \ remote \ test \ switch \ is \ dry/damp \ only. \ Select \ EMW \ option \ for \ wet \ location \ remote \ test \ switch \ is \ dry/damp \ only. \ Select \ EMW \ option \ for \ wet \ location \ remote \ test \ switch \ is \ dry/damp \ only. \ Select \ EMW \ option \ for \ wet \ location \ remote \ test \ switch \ is \ dry/damp \ only. \ Select \ EMW \ option \ for \ wet \ location \ remote \ test \ switch \ location \ remote \ test \ switch \ location \ remote \ test \ location \ remote \ test \ location \ remote \ test \ location \ remote \ re$ switch. UL2043 rated for use in air handling plenums. NRTL/CSA-US tested to UL standards. IBEW union made. All USAI Lighting products are Buy American Act (BAA) compliant.

NOTES: Ambient temperatures at fixture location should not exceed 40°C during normal operation. Not for use in corrosive environmen Declare. Use of pressure washer voids warranty. Not for use in acoustic ceiling tiles. Declare Red-List Approved.

PHOTOMETRICS: Consult factory or website for IES files. Tested in accordance with IESNA LM79.

Manufacturer / Mo	odel Name	USAI Lighting / Be	evelLED 2.2 Retorfit B4RDRT	
Mounting: Function:	Recessed Fixed Downlight	Source: Lamps:	LED 3000K	
Finish: Size:	White (bevel and flange) 4.5" dia	Lamps/Unit: Voltage: Wattage:	1 each 120V 16W	

#### Remarks:

Mounting:

Function:

Finish:

Ultra-low profile surface luminaire with wide distribution, used for general area illumination. Ceiling mounted in compatible junction box. Contractor to coordinate location with Reflected Ceiling Plan. Contractor shall patch adjacent ceiling, if required.

Source:

Lamps:

Voltage:


Wattage:

Lamps/Unit:

## **Dimensional Details**

Manufacturer / Model Name



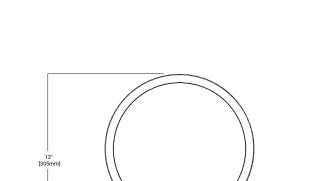

### Interactive Menu

- Order Information page 2 Product Specifications page 2 • Energy Data page 3
- Photometric Data page 4 Product Warranty

#### Dimming Guide **Top Product Features**

- Ultra-low profile surface luminaire with wide distribution Ceiling or wall mounting in compatible junction boxes
- 2000 lumen; Field Selecctable 2700K, 3000K, 3500K, 4000K, or 5000K CCT; 90CRI

Cooper Lighting / Halo SMD 12 Series

LED

3000K

1 each

120V

26.5 W

**HALO** 

SMD12 Series

12" Round & Square

SMD12R & SMD12S

**Product Certification** 

**Product Features** 

T24
Can be used to comy
with 2005 Table 24 Fe
LED Enclosed
Source Requirements

**Typical Applications** 

Surface Mount Downlight

- Universal Voltage 120V 277V options
- Dimmable with 0-10V DC low voltage dimmers only

#### Ordering Information


SAMPLE NUMBER: **SMD12R209SWHE** = 12" Round Surface Mount Downlight, 90CRI, 3000K Junction Box Installation: Order junction box separately, as supplied by others, to complete installation.


,				
SMD12R	20	3000k	WH	E
Models	Lumens	CRI/CCT	Finish	Voltage
Models	Lumens	CRI/CCT	Finish	Voltage
SMD12R = 12" Round Surface Mount Downlight SMD12S = 12" Square Surface Mount Downlight	<b>20</b> = 2000 lumen series	<b>9S</b> = 90 CRI, field selectable 2700K, 3000K, 3500K, 4000K or 5000K CCT	WH = Matte White	E = UNV Universal 120-277V
SMD12RTRMWH				
Accessories				
		OMBAGDEDMANN OM	DAODTDIAGN GMD40	DTD14TD7 014D40DTD1414

OIVID IZICI ICIVI VV II	
Accessories	
Accessories	SMD12RTRMW round, white (paint
SMD12RTRMSN = 12" Round SMD Satin Nickel SMD12RTRMTBZ = 12" Round SMD Tuscan Bronze SMD12RTRMWH = 12" Round SMD White (paintable) SMD12RTRMWB = 12" Round SMD Matte Black SMD12STRMSN = 12" Square SMD Satin Nickel SMD12STRMTBZ = 12" Square SMD Tuscan Bronze SMD12STRMWH = 12" Square SMD White (paintable) SMD12STRMWH = 12" Square SMD White (paintable) SMD12STRMWB = 12" Square SMD Matte Black	SMD12STRMW square, white (paint





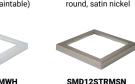

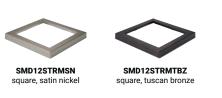

ASTM-E283

#### **Product Specifications**

- · Non-electrically conductive polycarbonate frame. High impact diffuse polystyrene lens provides shielding to the light guide with no pixilation Stamped aluminum housing provides thermal
- cooling achieving L70 at 50,000 hours in IC and non-IC applications Closed cell gasket achieves restrictive airflow and wet location requirements without additional
- Precision acrylic light guide organizes source flux into wide distribution with 1.2 – 1.4 spacing criteria useful for general area illumination
- Available in 90 CRI minimum, R9 greater than 50 and color accuracy within 3 SDCM provide color accuracy and uniformity
- Integrated 120-277V 60Hz constant current driver provides noise free operation. SMD 12" is universal Voltage (120-277V) configurations are recommended for use with compatible 0-10V DC low voltage dimmers only.

#### Adjustable spider plate allows for quick installation into junction boxes.

- Flectrical Junction Box Mounting The SMD may be used in compatible electrical junction boxes in direct contact with insulation including spray foam insulation. Suitable for installation in many 3-1/2" and 4"
- square, octagon, and round electrical junction boxes. Note: SMD12 is only compatible with junction boxes that provide minimum depth of 2-1/8". Installer must ensure compatibility of fit, wiring and proper mounting in the electrical junction box. This includes all applicable national and local electrical and building coded
- Designer Skins (sold separately) Mid power LED array provide a uniform source with
  - Satin Nickel Tuscan Bronze
- SMD skins are accessory rings in both round and square. These skins attach to the SMD for a permanent finish. Refer to the SMD accessories specification sheet for details. Matte White (Paintable)

## ENERGY STAR® listed, reference database for

978

1743

2236

43.6


77.7

99.8



## **Photometric Data**

high efficiency and long life.

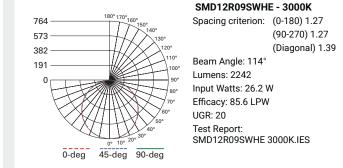

	0° 10° 20°	SM	ID12R09SWHE 3	8000K.IES	
0-de	eg 45-deg	90-deg			
9SWHI	E*				
al Is	ССТ	Watts	lumens	LPW	
	2700K	26.5	2179	82.2	

IZRUSSWII					
Nominal Lumens	ССТ	Watts	lumens	LPW	CRI
	2700K	26.5	2179	82.2	92
	3000K	26.5	2232	84.2	94
2000LM	3500K	26.5	2286	86.3	95
	4000K	26.6	2329	87.6	95
	5000K	26.6	2395	90.0	93

0-30

0-40

0-60

ISSUED FOR BID

DRAWING TITLE:

DRAWING 10 OF 19

LA-51

Big Ass Fans / Haiku MK-HK-04 Manufacturer / Model Name Mounting: Low profile, flat ceiling LED downlight Source: Fixed downlight plus fan Dimmable 3000K Function: Lamps: Finish: Hardware White A529 Lamps/Unit: 1 each Airfoil White F259 120-240 V AC Voltage: 52" dia 2.4 / 15.1 W Size: Wattage:


Remarks:


Contractor to coordinate fixture location with Reflected Ceiling Plan drawing A-210. Fans to replace existing fans. Provide flat cover plate at the ceiling opening as required.

#### **KEY FEATURES**

- Three precision-balanced airfoils in Moso bamboo or aircraft-grade aluminum
- whisper-quiet, energy-efficient airflow
- Built-in SenseME<sup>™</sup> technology efficiency
- Superior airflow control with for automated convenience and bluetooth remote, seven speed settings, mobile app, and more
- LED downlight and Chromatic Uplight with optional UV-C available together or separately
- Indoor and covered outdoor models available



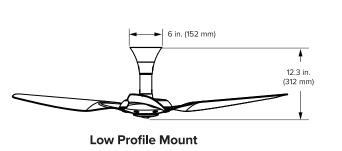

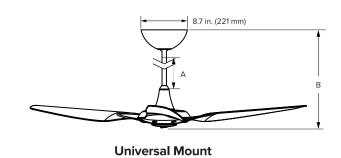



Universal Mount D	ownrod Lengths					
Downrod (A) <sup>1</sup>	Included Do	wnrod (Select at Tin	ne of Order)	Optional D	ownrods (Ordered S	ieparately)
Downloa (A)	12 in. (305 mm)	20 in. (508 mm)	32 in. (813 mm)	7 in. (178 mm)	48 in. (1219 mm)	60 in. (1524 mm)
Fan Height (B) <sup>2</sup>	21 in. (533 mm)	29 in. (737 mm)	41 in. (1041 mm)	16 in. (406 mm)	57 in. (1448 mm)	69 in. (1753 mm)
Ceiling Height	9-10.5 ft (2.7-3.2 m)	10.5-11 ft (3.2-3.4 m)	11-13 ft (3.4-4 m)	9-11 ft (2.7-2.9 m)	13-14 ft (4-4.3 m)	>14 ft (>4.3 m)
Ceiling Height	9–10.5 ft (2.7–3.2 m)	10.5-11 ft (3.2-3.4 m)	11–13 ft (3.4–4 m)	9–11 ft (2.7–2.9 m)	13-14 ft (4-4.3 m)	>14 ft (>4.3 m


Fan Specifications — Aluminum Airfoils										
I	Diameter	Mount	Weight <sup>3</sup>	Max Speed	Airflow Min/Max	Watts Min/Max	Operating Voltage	Ambient Operational Temperature	Sound Level <sup>4</sup>	
_	52 in.	Low Profile	16.5 lb (7.5 kg)	177 RPM	427 / 5,172 cfm	2.4/15.1 W	- 100–240 VAC, 1 Ф, 50–60 Hz		<35 dba at max speed	
	(132 cm)	Universal	15.5 lb (7 kg)	199 RPM	342 / 6,145 cfm	2.5/20.1 W				
	60 in.	Low Profile	18.5 lb (8.4 kg)	174 RPM	403 / 6,062 cfm	2.4/15.9 W		32° to 104° F		
	(152 cm)	Universal	17.5 lb (8 kg)	199 RPM	509 / 7,281 cfm	2.5 / 22.4 W		(0° to 40° C)		
	84 in									

Fan Specifications — Bamboo Airfoils <sup>5</sup>									
Diameter	Mount	Weight <sup>3</sup>	Max Speed	Airflow Min/Max	Watts Min/Max	Operating Voltage	Ambient Operational Temperature	Sound Level⁴	
52 in.	Low Profile	14 lb (6.4 kg)	177 RPM	331/5,731 cfm	2.4/19.5 W	100–240 VAC, 1 Ф, 50–60 Hz	32° to 104° F (0° to 40° C)	<35 dba at max	
(132 cm)	Universal	13 lb (5.9 kg)	200 RPM	371/6,973 cfm	3.5 / 28.92 W				
60 in.	Low Profile	16 lb (7.3 kg)	175 RPM	479 / 6,319 cfm	2.3/16.2 W				
(152 cm)	Universal	15 lb (6.8 kg)	199 RPM	596 / 7,632 cfm	2.6 / 25.1 W			speed	
84 in. (213 cm)	Universal	21 lb (9.5 kg)	128 RPM	2,260 / 15,081 cfm	3.6/32.9 W				

#### **Airfoil Finishes**

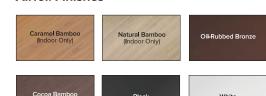

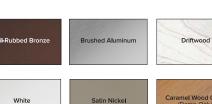

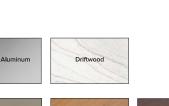



Satin	Oil-Rubbed
Nickel	Bronze
Black	White


**Hardware Finishes** 

Construction Features									
Airfoils	Motor <sup>1</sup>	Controls <sup>2</sup>	Onboard Sensors <sup>3</sup>	Mounting	Environment⁴	Accessories			
Bamboo (indoor only) or aircraft-grade aluminum	High-efficiency, brushless DC/EC motor Fan Eco Mode	Bluetooth remote Big Ass Fans mobile app Voice control 0–10 V (optional)	Temperature, humidity, and motion sensors enable SenseME Technology	Flat or sloped ceilings 8 ft (2.4 m) or taller Maximum slope: 33°	Indoor or covered damp locations	Haiku Light Kit Chromatic Uplight (indoor only) UV-C Uplight (indoor only) 0–10 V Module Extended downrod lengths Stabilizer Kit			

Ordering Information									
Diameter	Environment and Mounting <sup>5,6</sup>	Airfoil Material	Hardware Finish	Airfoil Finish <sup>7</sup>	Motor	Downrod	Region	Downlight	Uplight <sup>6</sup>
52 inch: MK-HK4-04 60 inch: MK-HK4-05 84 inch: MK-HK4-07		Balliboo. Of	Black: A258 White: A259 Satin Nickel: A470 Oil-Rubbed Bronze: A471	Natural Bamboo: F860	US, CA, MX: G10 International: G11	12 inch: I12 20 inch: I20 32 inch: I32 Low Profile: Blank	US, CA, MX: Blank APAC: R03 GCC: R04	Downlight: S2 None: Blank	Uplight: S80 None: Blank





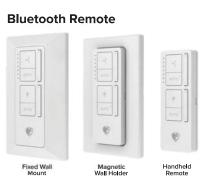

# PURCHASE COLLEGE STATE UNIVERSITY OF NEW YORK

RESIDENTIAL COMPLEX A DINING HALL RENOVATION


> PURCHASE COLLEGE . SUNY 735 ANDERSON HILL RD. PURCHASE NY 10577-1400 CONTACT SEAN CONNOLLY 914-251-5916

SEAN.CONNOLLY@PURCHASE.EDU ARCHITECT LEWANDOWSKA ARCHITECT PLLC
244 FIFTH AVENUE. SUITE B-265. NEW YORK. NY 10001

CONTACT BARBARA LEWANDOWSKA
T 212-787-4558 INFO@LEWANDOWSKAARCHITECT.COM

MEP ENGINEER DM ENGINEERS PLLC

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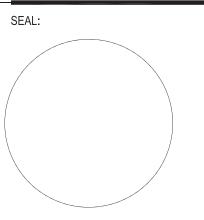
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BUILDING DEPARTMENT NOTE: THIS PLAN IS APPROVED ONLY FOR WORK INDICATED ON THE APPLICATION SPECIFICATION SHEET. ALL OTHER MATTERS SHOWN ARE NOT TO BE RELIED UPON, OR TO BE CONSIDERED AS EITHER BEING APPROVED OR IN ACCORDANCE WITH APPLICABLE CODES.

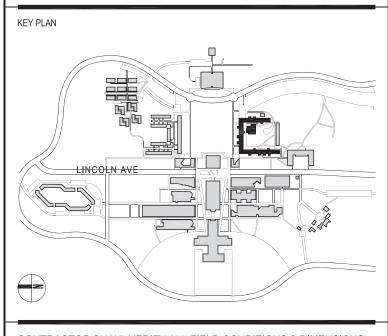02 05.14.2024 ISSUED FOR BID

01 04.26.2024 ISSUED FOR CLIENT REVIEW

NO DATE DESCRIPTION



ISSUED FOR BID

DRAWING TITLE:

SCALE: AS NOTED PROJECT NO: 2403 DATE: 03.25.2024

LIGHTING FIXTURES SCHEDULE

DRAWING NUMBER

DRAWING 11 OF 19

**PB-01** 

Manufacturer / Mo	odel Name	Eagle Group				
Model:	HSA-10-FAW	Mounting:	Wall mounted			
-unction:	Hand sink	Comments:	Mount at ADA-compliant ht. AFF			
inish:	304 stainless steel		Provide drain pipe cover			
Size:	18-7/8" wide, 14-3/4" deep		• •			
	6-3/4" bowl ht 6" backspl ht					

Remarks:

Constructed of type 304 stainless stell, all welded with deep-drawn positive drain sink bowl, inverted v edge to prevent spillage and basket drain, plus p-trap, tail piece and splash-mounted goosneck faucet with wrist handles.

**Traditional Hand Sinks** 

**Design & Construction Features** 

code requirements.

• Water inlet: ½" (13mm) NPS. • Drain outlet: 1½" (38mm) NPS. • Six models to choose from.

Unique deep-drawn positive-drain bowl assures

Item No.: . Project No.:

S.I.S. No.:

☐ HSA-10-F

Eagle Hand Sink, model HSA-10-FL. Constructed of type 304 • Heavy gauge type 304 stainless steel all-welded



#### **Specification Sheet**

**Short Form Specifications** Eagle Hand Sink, model HSA-10. Constructed of type 304 stainless steel, all-welded with deep-drawn positive drain sink **MODELS**: bowl, inverted "V" edge to prevent spillage and basket drain. 

#SA-10 Unit less faucet.

Eagle Hand Sink, model HSA-10-F. Features the same as sink \(\sum \mathbb{HSA-10-FAW}\) ☐ HSA-10-FA #HSA-10, plus splash mounted gooseneck faucet. Eagle Hand Sink, model HSA-10-FA. Features the same as sink #HSA-10, plus p-trap, tailpiece, and splash mounted gooseneck faucet.

Eagle Hand Sink, model HSA-10-FAW. Features the same as sink #HSA-10, plus p-trap, tailpiece, and splash mounted gooseneck faucet with wrist handles.

stainless steel, all-welded with deep-drawn positive drain sink construction. bowl, inverted "V" edge to prevent spillage, polymer lever drain, • Inverted "V" edge rim retards spillage. and splash mounted gooseneck faucet.

Eagle Hand Sink, model HSA-10-FO. Features the same as sink complete drainage to meet the most stringent health #HSA-10-FL, plus polymer lever drain includes overflow.



#HSA-10-F


Tail piece Front skirt

P-trap

**Options / Accessories** 

Side mount wall bracket ■ MICROGARD®\* antimicrobial protection

\* For hand sinks #HSA-10, HSA-10-F, HSA-10-FA, and HSA-10-FAW

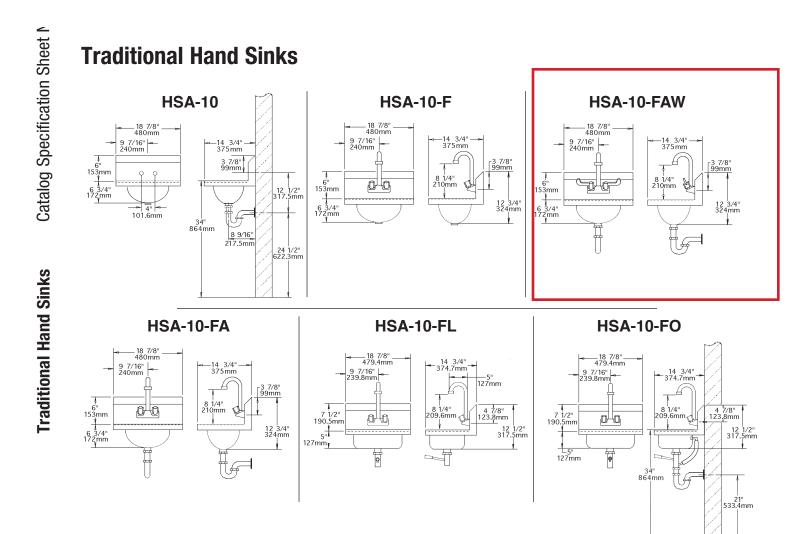

		bowl s width x leng		overall size width x length x height			weight	
model # includes		in.	mm	in.	mm	lbs.	kg	
HSA-10 *	4" (102mm) centerline faucet holes, basket drain	9¾″ x 13½″ x 6¾″	248 x 343 x 173	14¾" x 18¾" x 12¾"	376 x 480 x 324	10	4.5	
HSA-10-F	faucet, basket drain	9¾" x 13½" x 6¾"	248 x 343 x 173	14¾" x 18¾" x 12¾"	376 x 480 x 324	12	5.2	
HSA-10-FA	faucet, p-trap, tail piece, basket drain	9¾" x 13½" x 6¾"	248 x 343 x 173	14¾" x 18¾" x 12¾"	376 x 480 x 324	14	6.4	
HSA-10-FAW	faucet w/wrist handles, p-trap, tail piece, basket drain	9¾″ x 13½″ x 6¾″	248 x 343 x 173	14¾" x 18¾" x 12¾"	376 x 480 x 324	14	6.4	
HSA-10-FL	faucet, polymer lever drain	10" x 14" x 5"	254 x 256 x 127	14¾" x 18¾" x 12½"	376 x 480 x 318	15	6.6	

**HSA-10-FO** | faucet, polymer lever drain w/overflow | 10" x 14" x 5" | 254 x 256 x 127 | 14¾" x 18½" x 12½" | 376 x 480 x 318 | 13 | 5.9 \* To order hand sink with no faucet holes, add suffix "-NH" to model number (example: HSA-10-NH).

100 Industrial Boulevard, Clayton, DE 19938-8903 USA Phone: 302-653-3000 or 800-441-8440 • Fax: 302-653-2065 www.eaglegrp.com • www.eaglemhc.com



PURCHASE COLLEGE

STATE UNIVERSITY OF NEW YORK RESIDENTIAL COMPLEX A DINING HALL RENOVATION

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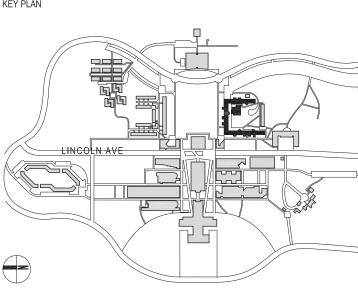
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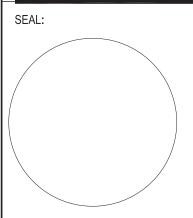
KEY PLAN



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DRAWING 12 OF 19

