# INTERIOR RENOVATIONS OF ALUMNI VILLAGE APARTMENTS 10.1 (ADA COMPLIANT) & 10.3

PROJECT # SU-040623

# SUNY PURCHASE COLLEGE

735 ANDERSON HILL ROAD PURCHASE NY 10577



19 West 21st Street New York, NY 10010 Tel: (212) 243-0725

Fax: (212) 243-0725


510 Broadhollow Road Melville, NY 11747 Tel: (631) 465-0786 Fax: (631) 465-0788



LONG ISLAND | NEW YORK CITY | CHARLOTTE | DANBURY

200 Old Country Road | Suite 670 Mineola | NY 11501 516 484 1020 Lizardos.com

Lizardos Engineering Associates D.P.C.

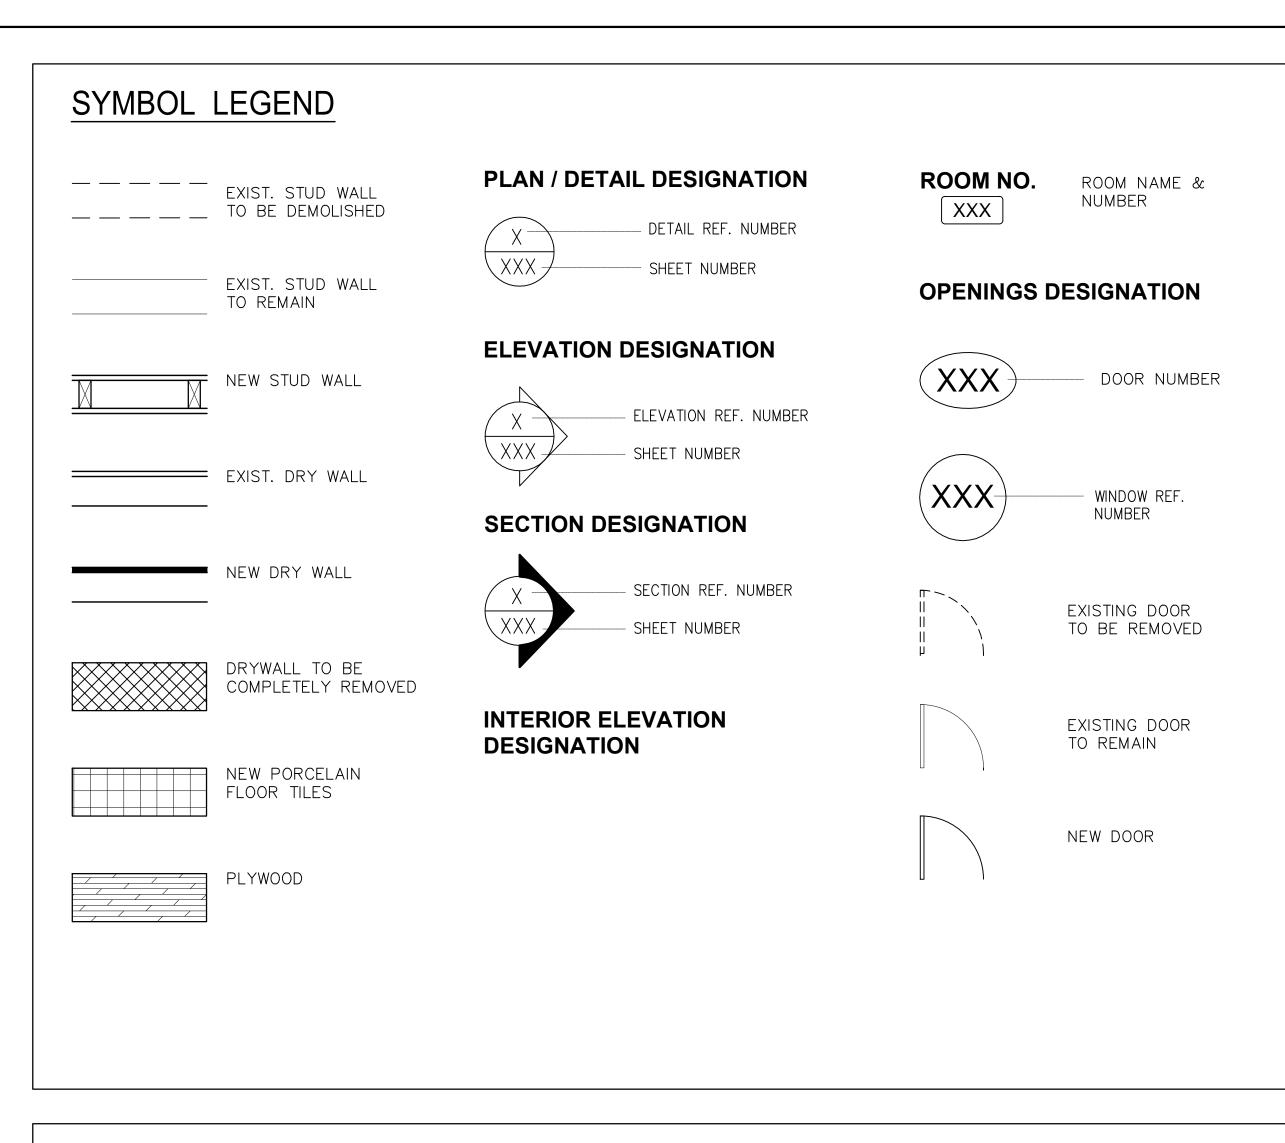

### **ABBREVIATIONS** ABOVE EXTERIOR WIRE EIC TBD ACCESS DOOR ENGINEER IN CHARGE MATERIAL TO BE DECIDED MAX. ADJACENT EXPANSION JOINT MAXIMUM THICKNESS ALUMINUM ELEVATION MECH. MECHANICAL T.O.S. - TOP OF SLAB ALUM.A. ARCHITECT OF RECORD EMG. EXPANDED METAL MANHOLE TYP. TYPICAL M.H. T.C. MIN. MINIMUM TERRA COTTA APP'D. APPROVED GUARD EXISTING LEADER M.I.S. METAL INSECT SCREEN AAPR.B. APPROXIMATELY ENT. ENTRANCE MT'D MOUNTED ARCH. ARCHITECT EOR ENGINEER OF RECORD ASPH. ASPHALT M.O. MASONRY OPENING EQ. VENT. VENTILATOR AUX. AUXILIARY EQUAL M.S. - MINERAL SURFACED VERT. EQUIPMENT VERTICAL AND VFRIFY IN FIFLD EXP. EXPANSION V.I.F. ANGLE EXIST. EXISTING VENT — AT EXT. EXTERIOR VERTICAL CRACK NOMINAL DIAMETER N.D. ELECTRICAL CONDUIT NEC. NECESSARY N.I.C. NOT IN BR BRICK CONTRACT B.0. BASE OF NO. NUMBER WITH FACE BRICK N.T.S. BRICK COURSE NOT TO SCALE W.F. WIDE FLANGE FD FLOOR DRAIN BUILDING LINE W.H. WEEP HOLE FIN. FINISH BLDG. BUILDING WROUGHT IRON BLOCK FLOOR WIRE MESH BLK W.M. FRESH AIR INTAKE BEAM ON CENTER WATERPROOFING F.P. FIREPROOFING B.S. 0.D. OUTSIDE DIAMETER WT. WEIGHT BLUE STONE FR. FRAME B.S.&A. BOARD OF STANDARDS OBSCURE GLAZING AND APPEAL BUILT—UP ROOF B.U.R GAUGE PAVEMENT PAV. GALVANIZED P&D PLUMBING AND GLASS BLOCK WINDOW CASEMENT DRAINAGE G.C. GENERAL CONTRACTOR PLASTER CAB'T CABINET G.I. GALVANIZED IRON CENTER LINE - GLASS CONTROL JOINT GRNT. GRANITE CL'G CEILING RADIUS COL. COLUMN RAILING CONT. CONTINUOUS RADIATOR CONC. CONCRETE HORIZONTAL CRACK R.D. ROOF DRAIN C.R. CLASSROOM HANDICAPPED REF. REFERENCE CU.YD. CUBIC YARD HGT. HEIGHT REINF. REINFORCEMENT H.M. HOLLOW METAL RET. RETAINING HORIZ. HORIZONTAL RM. - ROOM DEPARTMENT DET. DETAIL D.H. DOUBLE HUNG INT. INTERIOR STAINLESS STEEL DIA. DIAMETER INSTRUCTOR SPEC. SPECIFICATION DIM. DIMENSION INSUL. – INSULATION S.F. SQUARE FEET DN. DOWN STD. STANDARD DITTO DO. DOOR ST. PL. STEEL PLATE DR. STANDARD DETAIL DWG. DRAWING L.S. LIMESTONE SQUARE YARD S.Y. D.C. DIAGONAL CRACK LIGHT SFT STRUCTURAL FACING LINEAR FOOT TILE

### **GENERAL NOTES**

- 1. ALL WORK OF THIS CONTRACT SHALL BE DONE IN ACCORDANCE WITH THE LATEST EDITION OF NEW YORK STATE BUILDING CODE, AND REGULATIONS OF OTHER AGENCIES HAVING JURISDICTION ON THE WORK OF THIS CONTRACT.
- 2. WHERE DIMENSIONS ARE INDICATED, DIMENSIONS GOVERN OVER SCALE. ALL DIMENSIONS AND CONDITIONS SHOWN AND ASSUMED ON THE DRAWINGS MUST BE VERIFIED AT THE SITE BY THE CONTRACTOR PRIOR TO ORDERING ANY MATERIAL OR COMMENCING ANY WORK. ANY DISCREPANCIES IN THE DRAWINGS AND SPECIFICATIONS SHALL BE REPORTED TO THE EIC. NO CHANGE IN DRAWINGS OR SPECIFICATIONS IS ACCEPTED WITHOUT THE WRITTEN CONSENT OF THE ARCHITECT/ENGINEER. NO WORK SHALL PROCEED UNTIL SUCH DISCREPANCY HAS BEEN RECTIFIED.
- 3. ALL WORK ON THESE DRAWINGS SHALL BE CONSIDERED NEW WORK WHETHER STATED OR NOT EXCEPT WHERE SPECIFICALLY NOTED AS "EXISTING TO REMAIN".
- 4. COORDINATION OF ALL WORK UNDER THIS CONTRACT SHALL BE MAINTAINED TO ENSURE THE QUALITY AND TIMELY COMPLETION OF THE WORK/PROJECT.
- 5. THE CONTRACTOR SHALL DISCONNECT AND/OR REMOVE ANY EXISTING PLUMBING, ELECTRICAL FIXTURES, WIRE CONDUITS. OR OTHER WORK WHICH MIGHT INTERFERE WITH THE WORK OF THIS CONTRACT. AFTER NEW WORK IS COMPLETED, THE DISCONNECTED OR REMOVED ITEMS SHALL BE REINSTALLED BY THE CONTRACTOR AT THE SAME LOCATION OR AT NEW LOCATION AS DIRECTED. FURNISH ALL NECESSARY NEW MATERIALS/HARDWARE FOR COMPLETION OF WORK.
- 6. THE CONTRACTOR SHALL PATCH AND REPAIR ALL DAMAGED OR EXPOSED SURFACES DUE TO CONTRACT WORK. ALL NEWLY INSTALLED, PATCHED WORK AND ALL AFFECTED AREAS SHALL BE PAINTED. ALL PAINTING WORK SHALL BE PERFORMED TO COVER THE ENTIRE HORIZONTAL OR VERTICAL SURFACE TO THE CLOSEST CORNER IN ALL FOUR DIRECTIONS. COLOR TO MATCH EXISTING CONDITIONS.
- 7. THE CONTRACTOR SHALL FURNISH AND INSTALL NEW MATERIALS AT NO ADDITIONAL COST TO SUNY PURCHASE, ON THE FOLLOWING CONDITIONS:

a) ANY EXISTING WORK THAT HAS BEEN REMOVED OR DAMAGED IN ORDER TO PERFORM THE CONTRACT WORK.

b) TO FURNISH THE WORK OF THIS CONTRACT IN WORKMANLIKE MANNER.

8. THE CONTRACTOR SHALL BE RESPONSIBLE FOR ADEQUATELY BRACING AND PROTECTING ALL WORK DURING CONSTRUCTION AGAINST DAMAGE, BREAKAGE, COLLAPSE, DISTORTIONS AND OFF ALIGNMENTS ACCORDING

TO CODES AND STANDARDS OF GOOD PRACTICE.

- 9. THE CONTRACTOR SHALL INCLUDE ALL PREPARATORY AND ASSOCIATED SUPPLEMENTARY WORK TO PROVIDE A COMPLETE AND FINISHED INSTALLATION.
- 10. WHERE MANUFACTURER'S NAMES AND PRODUCT NUMBERS ARE INDICATED ON DRAWINGS, IT SHALL BE CONSTRUED TO MEAN THE ESTABLISHMENT OF QUALITY AND PERFORMANCE STANDARDS OF SUCH ITEMS. ALL OTHER PRODUCTS MUST BE SUBMITTED TO THE ARCHITECT FOR APPROVAL BEFORE THEY SHALL BE DEEMED EQUAL.
- 11. SIZE OF MASONRY UNITS AND WOOD MEMBERS ON PLANS, BUILDING ELEVATIONS AND SECTIONS ARE SHOWN AS NOMINAL SIZE.
- 13. PROVIDE GUARDS, RAILS, BARRICADES, FENCES, SIDEWALK SHEDS, CATCH PLATFORMS, DECKING, NIGHT LIGHTING, ETC., AS REQUIRED BY THE NEW YORK STATE BUILDING CODE, SECTION 3302 AND 3306 AS REQUIRED TO PROVIDE ADEQUATE PROTECTION.
- 14. THE CONTRACTOR SHALL KEEP WORK SITE FREE FROM DEBRIS AND ACCUMULATED REFUSE, AND SHALL HAVE SOLE RESPONSIBILITY FOR PROTECTING ALL DANGEROUS AREAS FROM ENTRY BY UNAUTHORIZED PARTIES. SITE SHALL BE LEFT BROOM CLEAN AT THE END OF EACH WORKING DAY.
- 15. THE CONTRACTOR SHALL MAINTAIN FREE AND UNOBSTRUCTED ACCESS FROM ALL ADJACENT SPACES INTO THE EXISTING FIRE STAIRS TO OUTSIDE OF THE BUILDING AT ALL TIMES.
- 16. THE CONTRACTOR SHALL, UNLESS OTHERWISE PROVIDED IN THE CONTRACT DOCUMENTS, SECURE AND PAY FOR REQUIRED INSPECTIONS, PERMIT(S), FEES, LICENSE AND INSPECTIONS NECESSARY FOR THE PROPER EXECUTION OF THE WORK.
- 18. THE CONTRACTOR SHALL EXAMINE AND VERIFY IN THE FIELD ALL EXISTING AND GIVEN CONDITIONS AND DIMENSIONS WITH THOSE SHOWN ON THE CONTRACT DOCUMENTS. IF THE FIELD CONDITIONS AND DIMENSIONS DIFFER FROM THOSE SHOWN ON THE CONTRACT DOCUMENTS, THE CONTRACTOR SHALL NOTIFY THE ENGINEER. ALL FIELD CONDITIONS AND DIMENSIONS SHALL BE SO NOTED ON THE DRAWINGS AND SUBMITTED FOR APPROVAL.

- 19. THE CONTRACTOR'S ATTENTION IS DIRECTED TO THE FACT THAT, DUE TO THE NATURE OF THIS PROJECT, THE EXACT EXTENT OF WORK CAN NOT ALWAYS BE ACCURATELY DETERMINED PRIOR TO THE COMMENCEMENT OF THE WORK. THE CONTRACT DOCUMENTS HAVE BEEN PREPARED BASED ON FIELD INSPECTION AND OTHER INFORMATION AVAILABLE AT THE TIME. ACTUAL FIELD CONDITIONS MAY REQUIRE MODIFICATIONS TO THE CONSTRUCTION DETAILS AND WORK QUANTITIES. THE CONTRACTOR SHALL PERFORM THE WORK IN ACCORDANCE WITH THE FIELD CONDITIONS AND AS ORDERED BY THE ENGINEER.
- 20. ALL BIDDERS SHALL INSPECT THE PROJECT SITE PRIOR TO SUBMITTING BIDS TO VERIFY THE FIELD CONDITIONS WHICH MAY BE ENCOUNTERED AND THE NATURE OF THE WORK TO BE DONE UNDER THIS CONTRACT. NO COMPENSATION WILL BE ALLOWED TO THE BIDDER FOR FAILURE TO INCLUDE ALL LABOR, MATERIALS AND EQUIPMENT COSTS NECESSARY TO COMPLETE THE WORK.
- 21. THE CONTRACTOR SHALL PERFORM ALL WORK WITH CARE SO THAT ANY MATERIALS THAT ARE TO REMAIN IN PLACE, OR THAT ARE TO BE REMOVED AND REMAIN THE PROPERTY OF THE COLLEGE, WILL NOT BE DAMAGED. IF THE CONTRACTOR DAMAGES ANY MATERIALS THAT ARE TO REMAIN IN PLACE, OR WHICH ARE TO REMAIN THE PROPERTY OF THE COLLEGE. THE DAMAGED MATERIALS SHALL BE REPAIRED OR REPLACED IN A MANNER SATISFACTORY TO THE PARK MANAGER AT THE EXPENSE OF THE CONTRACTOR.
- 22. THE CONTRACTOR SHALL BE REQUIRED TO PROTECT HIS/HER WORKERS AT ALL TIMES IN CONFORMANCE WITH APPLICABLE OSHA REGULATIONS.
- 23. THE USE OF POWER DEVICES SUCH AS ELECTRIC HAMMERS OR OTHER PNEUMATIC TOOLS WILL NOT BE ALLOWED UNLESS APPROVED BY THE CAMPUS PROJECT REPRESENTATIVE. NO POWER-ACTUATED DEVICES MAY BE USED TO ATTACH STUDS TO EXISTING FLOORS, CEILINGS OR WALLS UNLESS A LIST OF PROPOSED TOOLS IS SUBMITTED AND APPROVED BY THE CAMPUS PROJECT REPRESENTATIVE. POWER-ACTUATED DEVICES MAY NOT BE UTILIZED WITHOUT PRIOR CONSENT FROM THE BOARD, AS PER THE ALTERATION AGREEMENT.
- 24. CONTRACTOR TO PROVIDE FOR PAINT, DUST, DEBRIS AND NOISE CONTAINMENT AS DIRECTED BY THE CAMPUS PROJECT REPRESENTATIVE. ALL VENTS AND EXHAUSTS MUST BE FULLY SEALED TO PREVENT INFILTRATION OF DUST AND DIRT.
- 25. ANY CHANGES TO THE SCOPE OF WORK MUST BE SUBMITTED TO THE CLIENT AND THE ARCHITECT FOR REVIEW AND APPROVAL PRIOR TO THE COMMENCEMENT OF THAT WORK.
- 26. CONTRACTOR SHALL SCHEDULE AND SEQUENCE WORK SO AS NOT TO INTERFERE WITH OTHER ONGOING OR SCHEDULED WORK, OR WITH ACTIVITIES OF THE OWNER. COORDINATE WITH OWNER'S REPRESENTATIVE.
- 27. CONSTRUCTION WORK SHALL NOT IMPACT THE ADJOINING OCCUPIED APARTMENTS.
- 28. DO NOT SCALE DRAWINGS. DETAILS, NOTES, AND THE LIKE ARE TYPICAL AND APPLY IN GENERAL TO SIMILAR CONDITIONS.

### SUMMARY OF WORK

THE WORK SHALL BE AS SHOWN AND CALLED FOR IN THE CONTRACT DOCUMENTS AND SHALL INCLUDE, BUT NOT BE LIMITED TO, THE FOLLOWING GENERAL ITEMS OF WORK:

PARTIAL REMOVAL OF EXISTING STUD WALLS, DROPPED CEILING, FLOORING, PARTIAL MECHANICAL AND PLUMBING WORKS.

INSTALLATION OF NEW MECHANICAL AND ELECTRICAL WORK.

INSTALLATION OF NEW INTERIOR STUD WALLS, NEW BATHROOM FINISHES AND FIXTURES, NEW FLOORS, NEW DROPPED CEILING AND NEW GYPSUM CEILINGS, NEW DOORS. INSTALLATION AND CONNECTION OF NEW PLUMBING,

2 04/06/2023 100% SUBMISSION 1 09/24/2022 80% SUBMISSION

No. Date

Revision

# AFRIDI ASSOCIATES

**CONSULTING ENGINEERS** 510 Broadhollow Road 19 West 21st Street

Melville, NY 11747 New York, NY 10010 Tel: (212) 243-0725 Tel: (631) 465-0786 Fax: (212) 243-0725 Fax: (631) 465-0788 aafridi@afridiassociates.com

# **IZARDOS**

LONG ISLAND | NEW YORK CITY | CHARLOTTE | DANBURY

200 Old Country Road | Suite 670 Mineola | NY 11501 516 484 1020 Lizardos.com

Lizardos Engineering Associates D.P.C.

	Designer:	AKBER AFRIDI, P.E.
	Drawn by:	AZHER MALIK
	Checked by:	AKRER AFRIDI P F

### INTERIOR RENOVATIONS OF **ALUMNI VILLAGE APARTMENTS** 10.1 (ADA COMPLIANT) & 10.3

735 Anderson Hill Road Purchase NY 10577

Drawing Title: GENERAL NOTES, SUMMARY OF WORKS, & MISCELLANOUS INFO.

> Drawing No.: T002.00

Scale: AS NOTED

08/24/2020

SU-040623

Date:

DRAWIN	IG LIST
SHEET NO.	SHEET TITLE
COVER & GE	ENERAL NOTES
T001.00	COVER SHEET
T002.00	SYMBOL LEGEND, ABBREVIATIONS, GENERAL NOTES, SUMMARY OF WORK
T003.00	LIST OF DRAWINGS
T004.00	ADA CODE COMPLIANCE
FIRE PROTE	CTION DRAWINGS
SP-001.00	SPRINKLER LEGENDS, NOTES, ABBREVIATIONS, SCHEDULE AND DETAILS
SP-101.00	SPRINKLER FIRST FLOOR DEMO AND NEW WORK
SP-201.00	SPRINKLER SPECIFICATIONS
ARCHITECT	JRAL DRAWINGS
A101.00	LOCATION/KEY PLAN (FOR REFERENCE ONLY)
A102.00	ADA APARTMENT 10.1 PARTIAL REMOVALS & PROPOSED PLANS
A103.00	APARTMENT 10.3 PARTIAL REMOVALS & PROPOSED PLANS
A201.00	WALL SECTIONS
A202.00	ENLARGED BATHROOM PLANS, ADA APARTMENT 10.1
A203.00	BATHROOM WALL ELEVATIONS & FINISHES, ADA APARTMENT 10.1
A204.00	ENLARGED BATHROOM PLANS, APARTMENT 10.3
A205.00	BATHROOM WALL ELEVATIONS & FINISHES, APARTMENT 10.3
A206.00	ENLARGED KITCHEN DETTAILS, ADA APARTMENT 10.1
A207.00	MILLWORK DETAILS, ADA APARTMENT 10.1
A208.00	ENLARGED KITCHEN DETAILS, APARTMENT 10.3
A209.00	MILLWORK DETTAILS, APARTMENT 10.3
A210.00	BEDROOM CLOSET DETAILS (TYP.), APARTMENT 10.1 & 10.3
A301.00	FINISHES PLAN (FLOOR & WALL), ADA APARTMENT 10.1
A302.00	FINISHES PLAN (FLOOR & WALL), APARTMENT 10.3
A303.00	FINISHES (CEILING & SOFFIT), ADA APARTMENT 10.1
A304.00	FINISHES (CEILING & SOFFIT), APARTMENT 10.3
A305.00	DOOR DETAILS, (TYPICAL)
A401.00	ELECTRICAL LAYOUT PLAN, ADA APARTMENT 10.1
A402.00	ELECTRICAL LAYOUT PLAN, APARTMENT 10.3
MECHANICA	L DRAWINGS
M-001.00	MECHANICAL LEGENDS, ABBREVIATIONS, NOTES AND SCHEDULE
M-101.00	MECHANICAL FIRST AND SECOND FLOOR NEW WORK
M-301.00	MECHANICAL DETAILS
M-401.00	MECHANICAL SPECIFICATIONS, SHEET 1 OF 2
M-402.00	MECHANICAL SPECIFICATIONS, SHEET 2 OF 2

PLUMBING	DRAWINGS
P-001.00	PLUMBING LEGENDS, ABBREVIATIONS, NOTES, SCHEDULE AND DETAILS
P-101.00	PLUMBING FIRST FLOOR DEMOLITION AND RISER DIAGRAMS
P-102.00	PLUMBING SECOND FLOOR DEMOLITION AND RISER DIAGRAMS
P-201.00	PLUMBING FIRST FLOOR NEW WORK AND RISER DIAGRAMS
P-202.00	PLUMBING SECOND FLOOR NEW WORK AND RISER DIAGRAMS
P-301.00	PLUMBING DETAILS
P-401.00	PLUMBING SPECIFICATIONS
ELECTRICA	L DRAWINGS
E-001.00	ELECTRICAL LEGEND, ABBREVIATIONS AND NOTES
E-101.00	ELECTRICAL FIRST FLOOR POWER AND LIGHTING - DEMOLITION PLANS
E-102.00	ELECTRICAL SECOND FLOOR POWER, LIGHTING - DEMOLITION PLANS
E-201.00	ELECTRICAL FIRST FLOOR POWER, LIGHTING — NEW WORK PLANS
E-202.00	ELECTRICAL SECOND FLOOR POWER, LIGHTING — NEW WORK PLANS
E-401.00	ELEC. SPECIFICATIONS, SHEET 1 OF 2
E-402.00	ELEC. SPECIFICATIONS, SHEET 2 OF 2
FIRE ALARN	/ DRAWINGS
FA-101.00	FIRST FLOOR AND SECOND FLOOR FIRE DEMOLITION

2 04/06/2023 100% SUBMISSION

1 09/24/2022 80% SUBMISSION

No. Date Revision

# AFRIDI ASSOCIATES CONSULTING ENGINEERS

19 West 21st Street New York, NY 10010

510 Broadhollow Road Melville, NY 11747 Tel: (212) 243-0725 Tel: (631) 465-0786 Fax: (212) 243-0725 Fax: (631) 465-0788

aafridi@afridiassociates.com

# **LIZARDOS**

LONG ISLAND | NEW YORK CITY | CHARLOTTE | DANBURY

200 Old Country Road | Suite 670 Mineola | NY 11501 516 484 1020 Lizardos.com

Lizardos Engineering Associates D.P.C.

AKBER AFRIDI, P.E. Designer: Drawn by: AZHER MALIK AKBER AFRIDI, P.E. Checked by:

INTERIOR RENOVATIONS OF ALUMNI VILLAGE APARTMENTS 10.1 (ADA COMPLIANT) & 10.3


Address: 735 Anderson Hill Road Purchase NY 10577

Drawing Title: LIST OF DRAWINGS


> Drawing No.: T003.00

> > Scale: AS NOTED

SU-040623

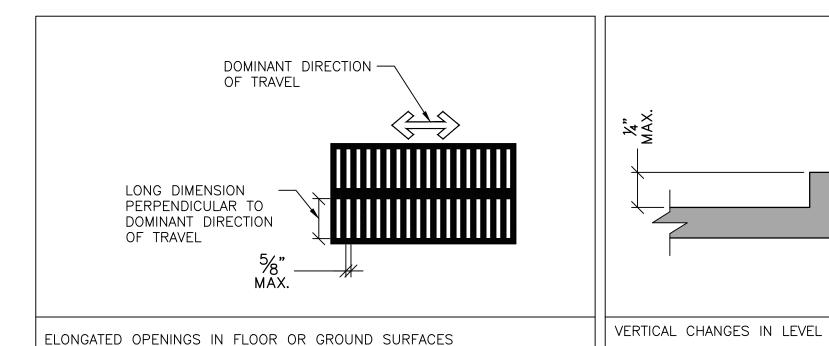

2010 ADAAG FIG. 302.3 2009 ICC A117.1 FIG. 302.3

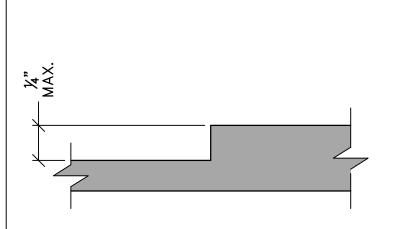

2010 ADAAG FIG.

2009 ICC A117.1 FIG.

",4M XA X	


VERTICAL CHANGES IN LEVEL

60"	60" MIN.
	12" ARM ARM ARM ARM ARM WIN. 12"
(A) CIRCULAR	MIN. MIN. MIN. (B) T-SHAPED

VERTICAL	CHANGES	IN	LEVEL

2009 ICC A117.1 FIG.


304.3.2 2010 ADAAG FIG. 2009 ICC A117.1 FIG. 304.3(A) & 304.3(B)

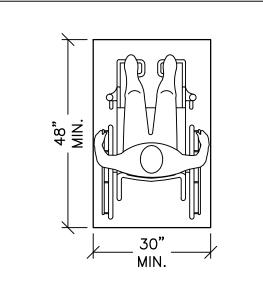

CLEAR FLOOR OR GROUND SPACE

305.3 2010 ADAAG FIG. 2009 ICC A117.1 FIG. 305.3

307.2

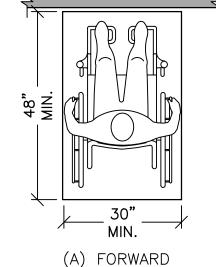


2009 ICC A117.1 FIG.

(B) PARALLEL

305.5

POSITION OF CLEAR FLOOR OR GROUND SPACE

2010 ADAAG FIG.

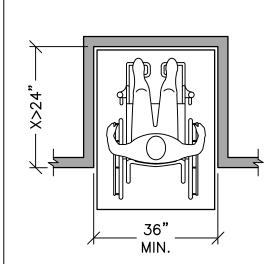

NOTE:WHEN THE DEPTH OF AN ALCOVE EXCEEDS 24"

APPROACH, THE WIDTH OF MANEUVERING CLEARANCE INCREASES TO 36" MIN. IN

MANEUVERING CLEARANCE IN ALCOVE, FORWARD APPROACH

2010 ADAAG FIG.	305.7.1
2009 ICC A117.1 FIG.	305.7(A)

303.2

303.2


2010 ADAAG FIG.

2009 ICC A117.1 FIG.

WIDTH OF MANEUVERING CLEARANCE INCREASES TO 60" MIN. IN WIDTH.

MANEUVERING CLEARANCE IN ALCOVE, PARALLEL APPROACH


2010 ADAAG FIG.	305.7.2
2009 ICC A117.1 FIG.	305.7(B) 20"

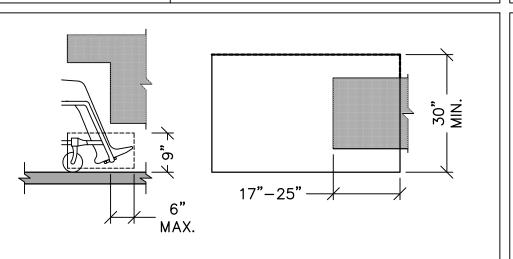

303.2(A) & 303.2(B)


(A) ELEVATION	(B) PLAN

TOE CLEARANCE	
2010 ADAAG FIG.	306.2
2009 ICC A117.1 FIG.	306.2

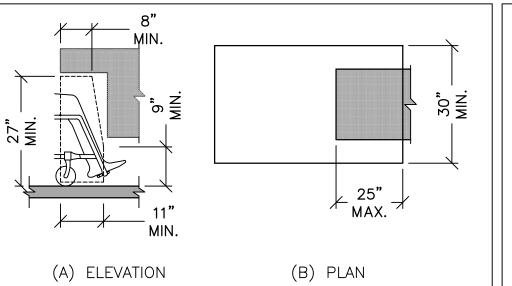



(//)/	
KNEE CLEARANCE	
2010 ADAAG FIG.	306.3


306.3

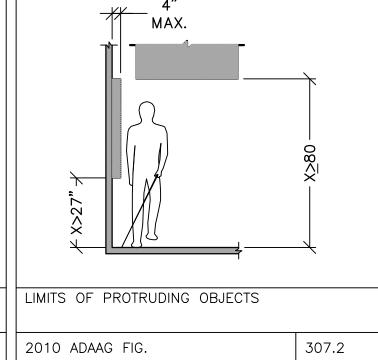



2009 ICC A117.1 FIG.

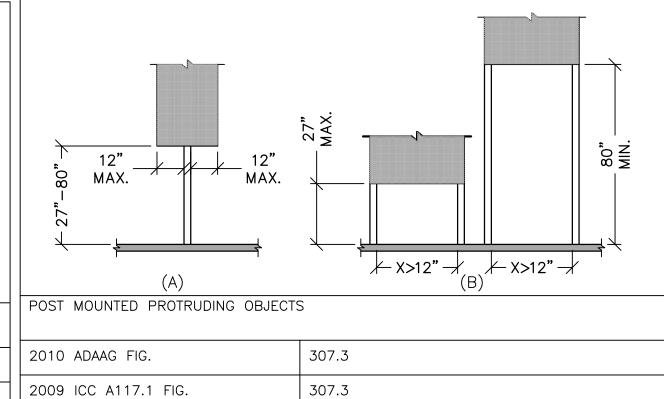


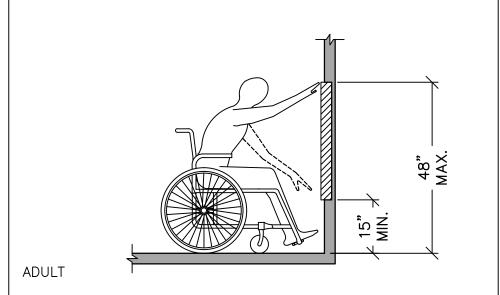


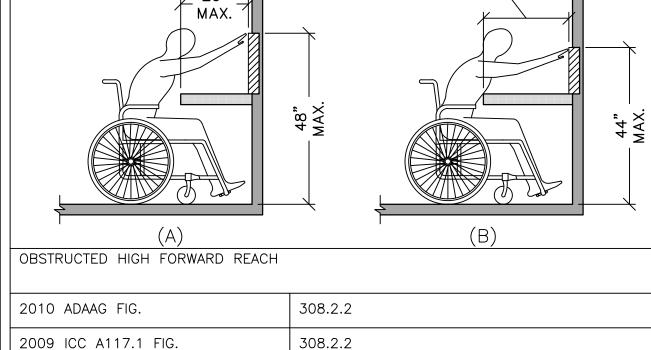


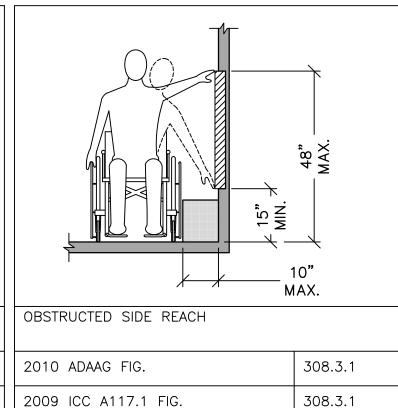

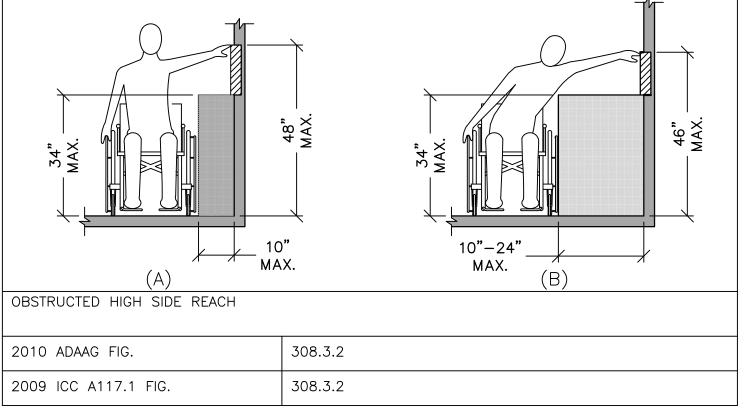

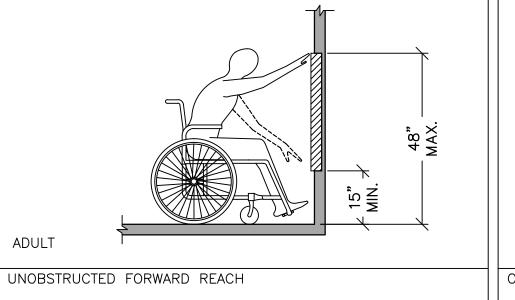

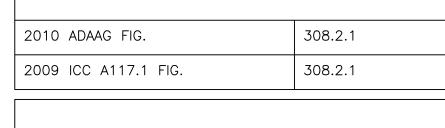


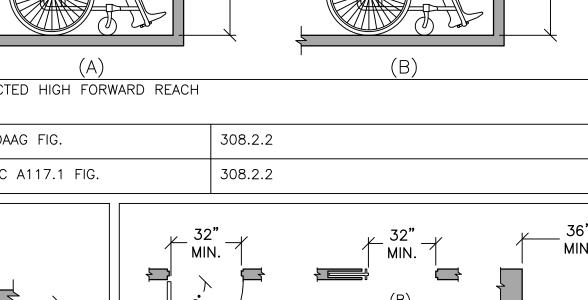


\_ 42" -MAX. -


MIN.

20"-25" MAX.

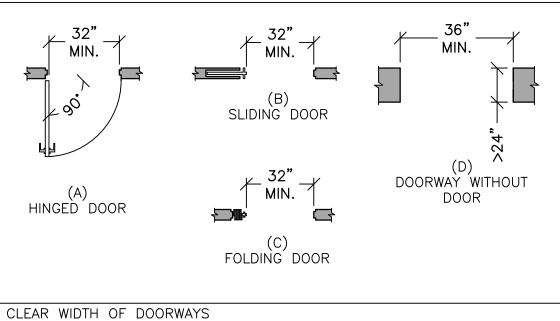

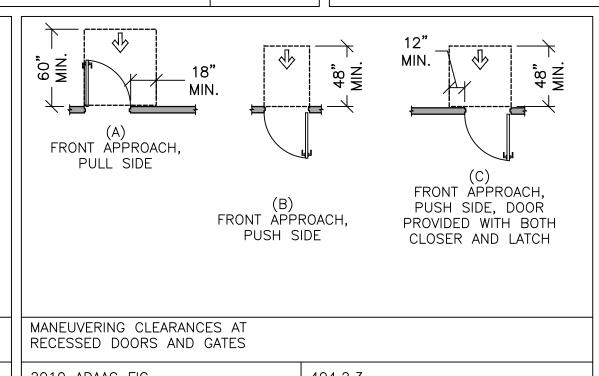

TAPPROACH, PULL SIDE  (B) FRONT APP PUSH S	ROACH,	(C) FRONT APPROACH, PUSH SIDE, DOOR PROVIDED WITH BOTH CLOSER AND LATCH
MANEUVERING CLEARANCES AT RECESSED DOORS AND GATES		
2010 ADAAG FIG.	404.2.3	
2009 ICC A117.1 FIG.	404.2.2	

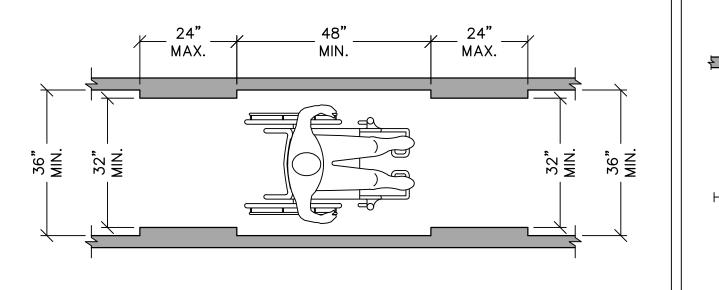

CLEAR WIDTH OF AN ACCESSIBLE ROUTE				
2010 ADAAG FIG.				

	ACCESSIBLE NOOTE		
	2010 ADAAG FIG.	403.5.1	
	2009 ICC A117.1 FIG.	403.5	
Ì			

2010 ADAAG FIG.	404.2.3
2009 ICC A117.1 FIG.	404.2.2


RECESSED DOORS AND
2010 ADAAG FIG.
2009 ICC A117.1 FIG.

MAX.


7"-9" MIN.


MIN.

MIN.

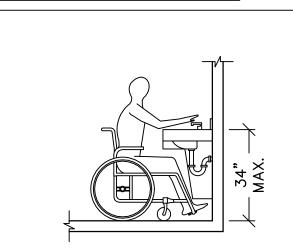

NOTE: PROVIDE A CLEAR FLOOR SPACE POSITIONED FORWARD APPROACH AS PER SECTION 305.
   PROVIDE TOE AND KNEE CLEARANCE AS PER SECTIO

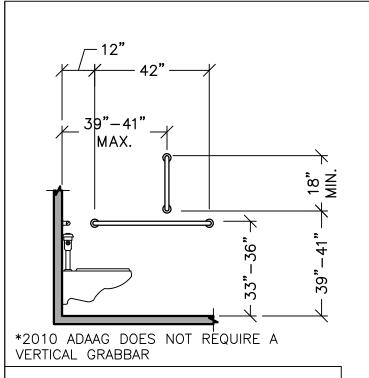

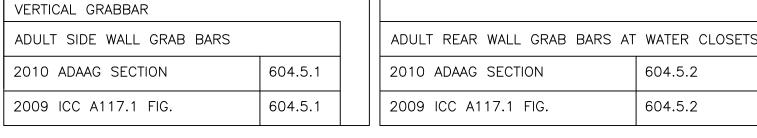


**/**── 36" ── /

í TRANSFER

SIDE

— 24" <del>- /</del> 12"|

(A) PROTRUDING DISPENSER (B) BELOW GRAB BAR	PROTRUDIN ABOVE GI	NG DISPENSER (C) RECESSED DISPENSER RAB BAR
ADULT DISPENSER OUTLET LOCATION	NC	*2010 ADAG ALLOWS A LOWER MINIMUM HEIGHT OF 15" MIN. HOWEVER 18" MIN. REQUIREMENT OF 2009 ICC
2010 ADAAG SECTION	604.7	A117.1 WILL PROVIDE COMPLIANCE WITH BOTH STANDARDS.
2009 ICC A117.1 FIG.	604.7	**THIS IS ONLY A REQUIREMENT FOUND IN 2010 ADAAG

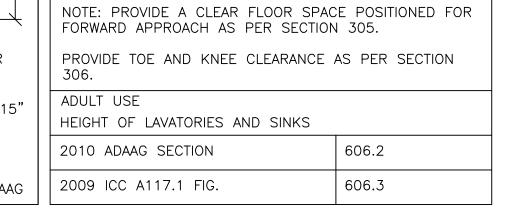

2	04/06/2023	100% SUBMISSION
1	09/24/2022	80% SUBMISSION
No.	Date	Revision

# AFRIDI ASSOCIATES

510 Broadhollow Road 19 West 21st Street Melville, NY 11747 New York, NY 10010 Tel: (631) 465-0786 Tel: (212) 243-0725 Fax: (212) 243-0725 Fax: (631) 465-0788

aafridi@afridiassociates.com

LONG ISLAND | NEW YORK CITY | CHARLOTTE | DANBURY

200 Old Country Road | Suite 670 Mineola | NY 11501 516 484 1020 Lizardos.com

Lizardos Engineering Associates D.P.C.

Designer:	AKBER AFRIDI, P.E.
Drawn by:	AZHER MALIK
Checked by:	AKBER AFRIDI, P.E.

	-
Project:	_
INTERIOR RENOVATIONS OF	
ALUMNI VILLAGE APARTMENTS	

10.1 (ADA COMPLIANT) & 10.3 735 Anderson Hill Road

Purchase NY 10577


ADA CODE COMPLAINCE


Drawing TOC	No.: <b>)4.00</b>	
Scale:	AS NOTED	


Date:

SU-040623

08/24/2020

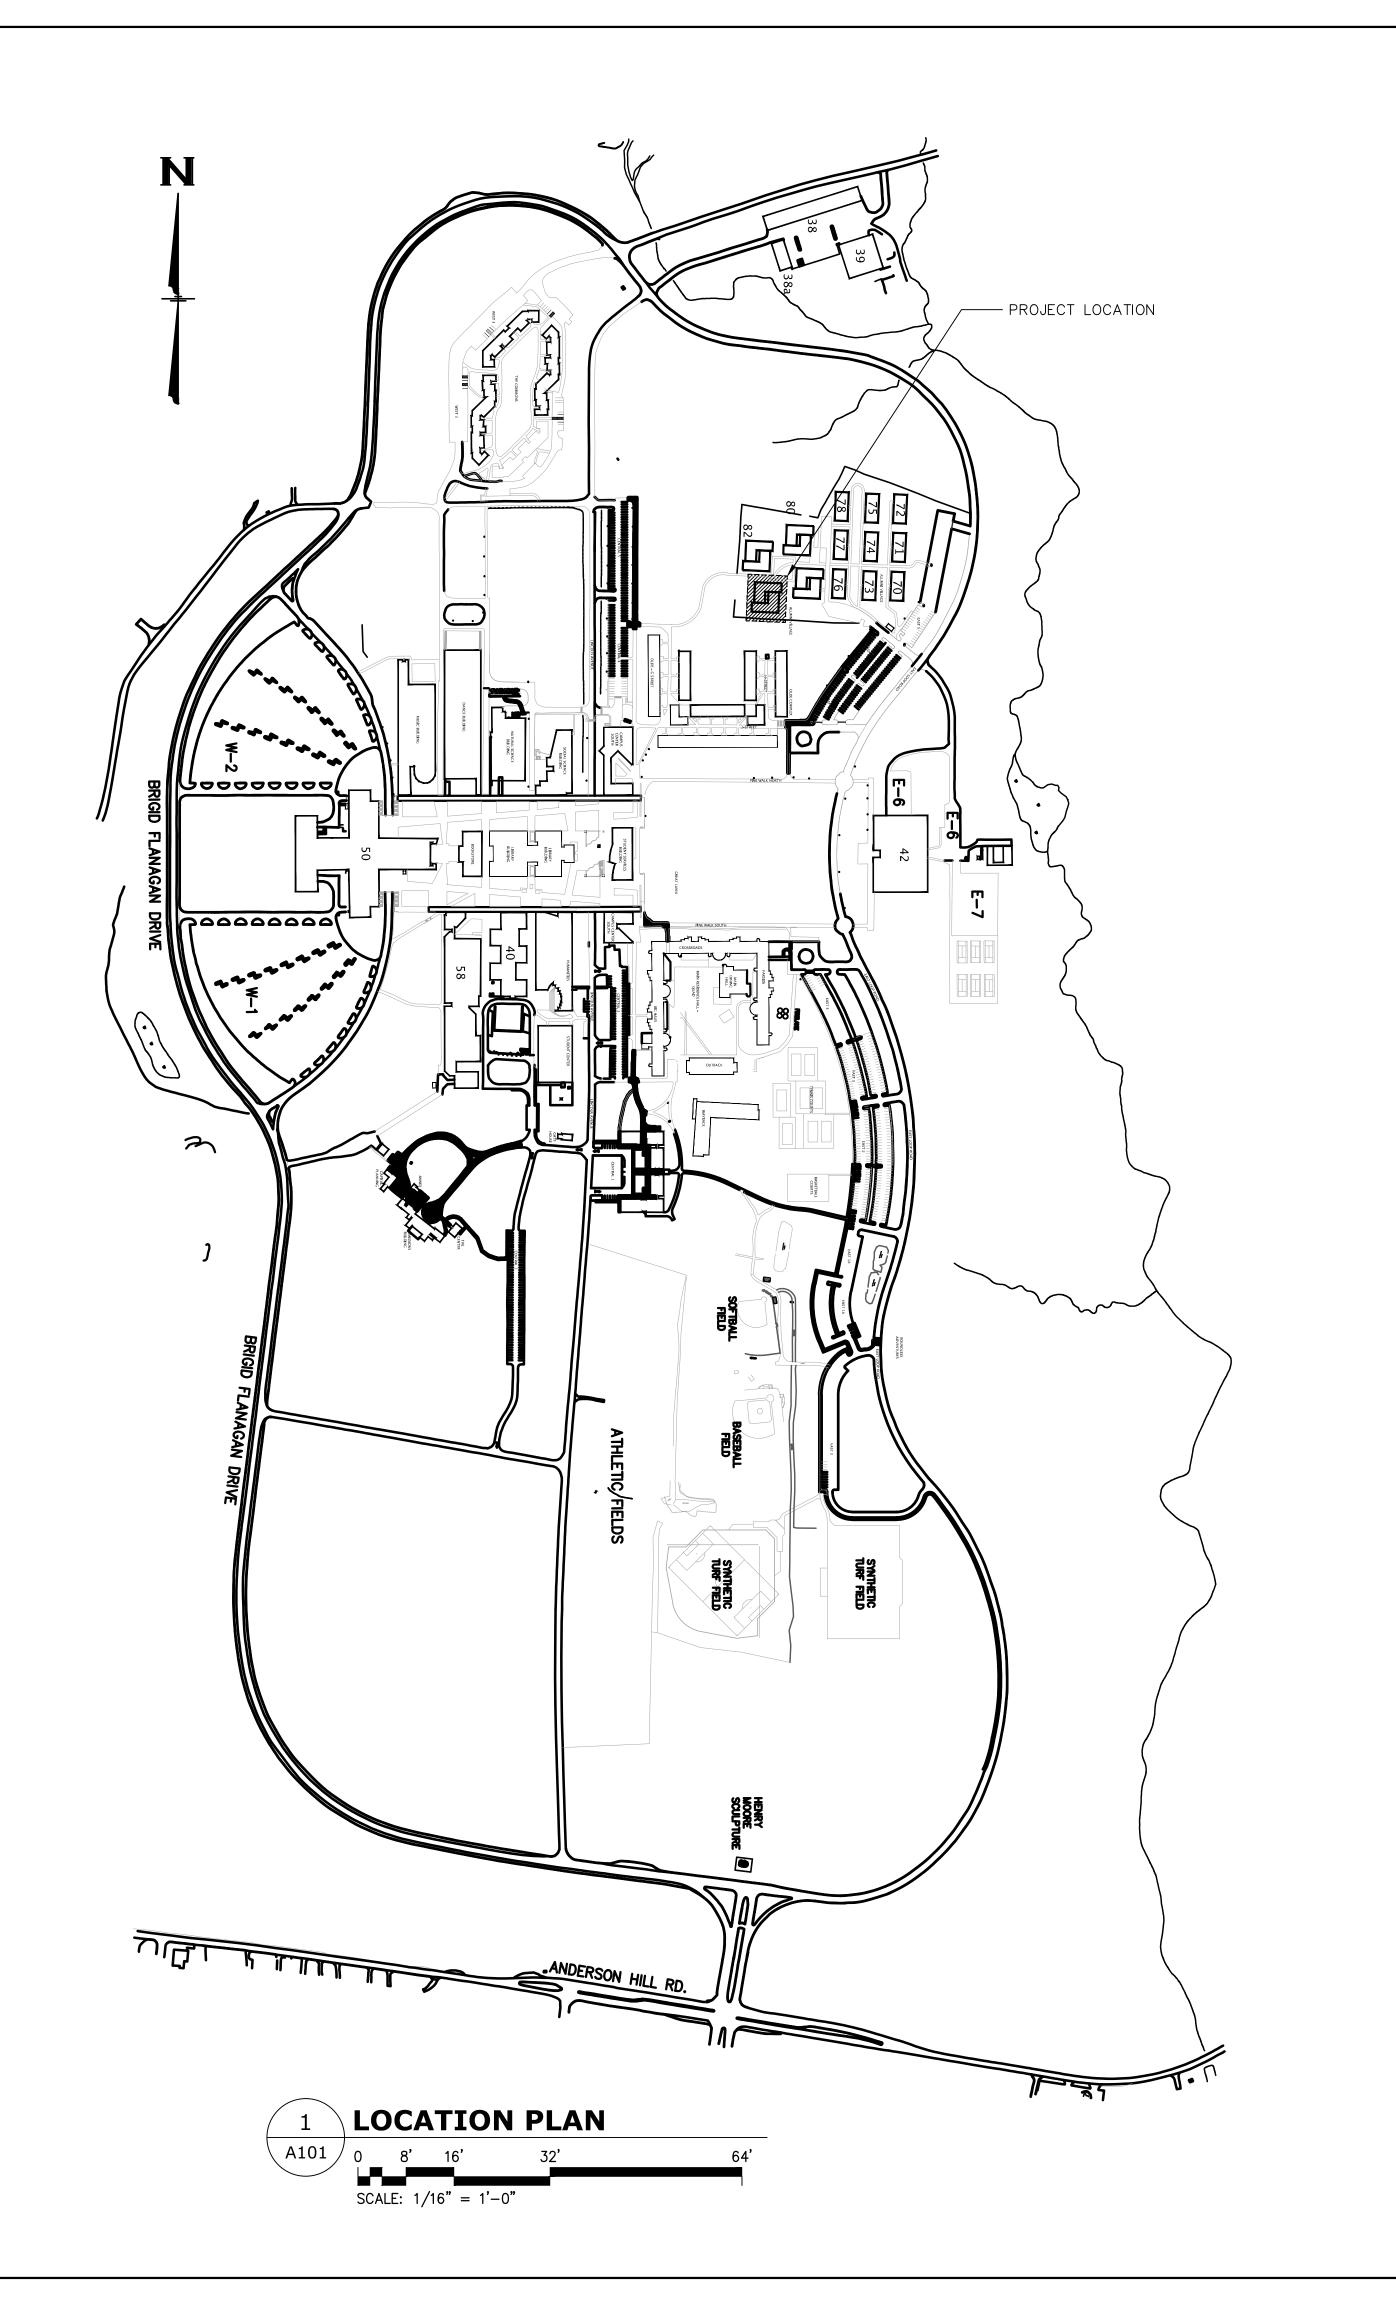

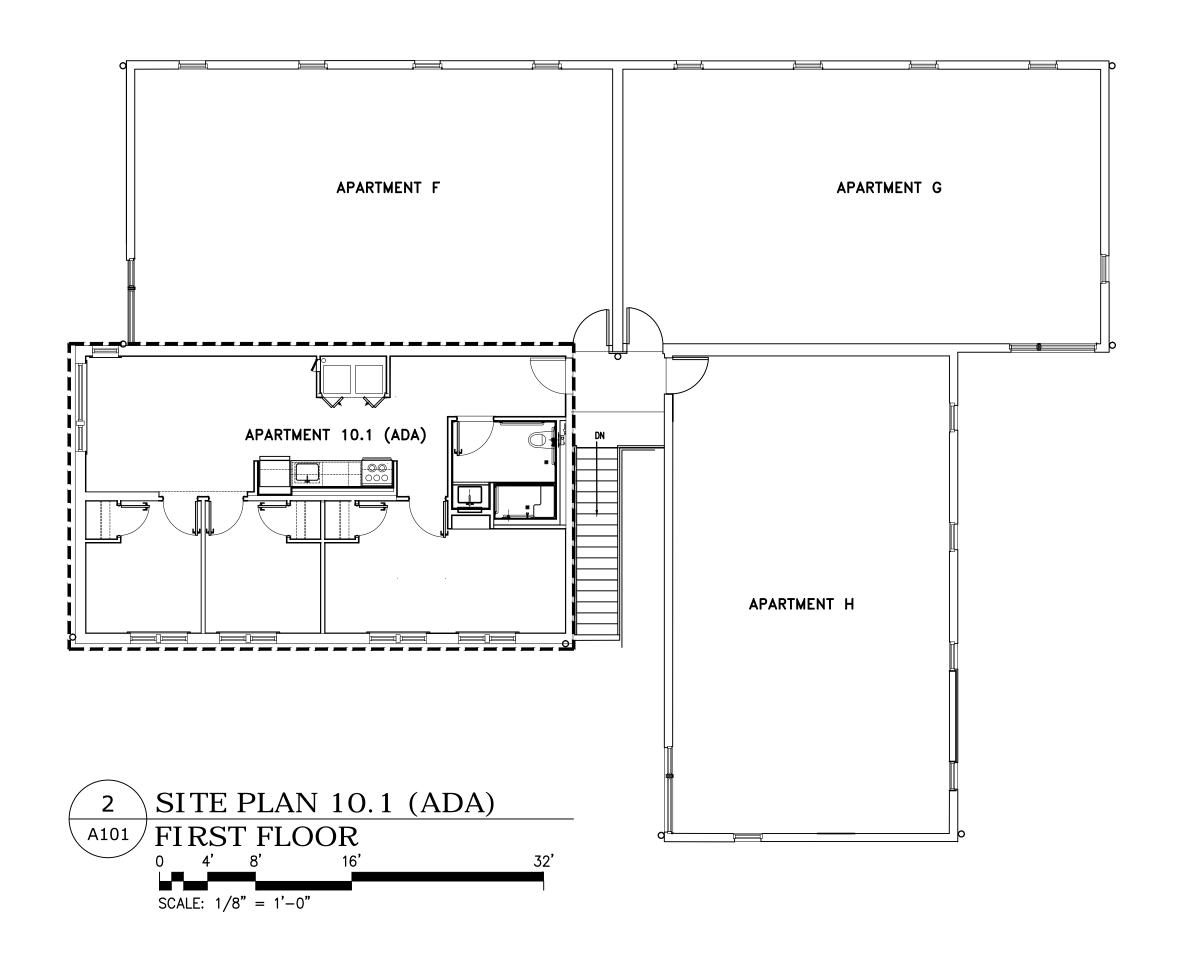

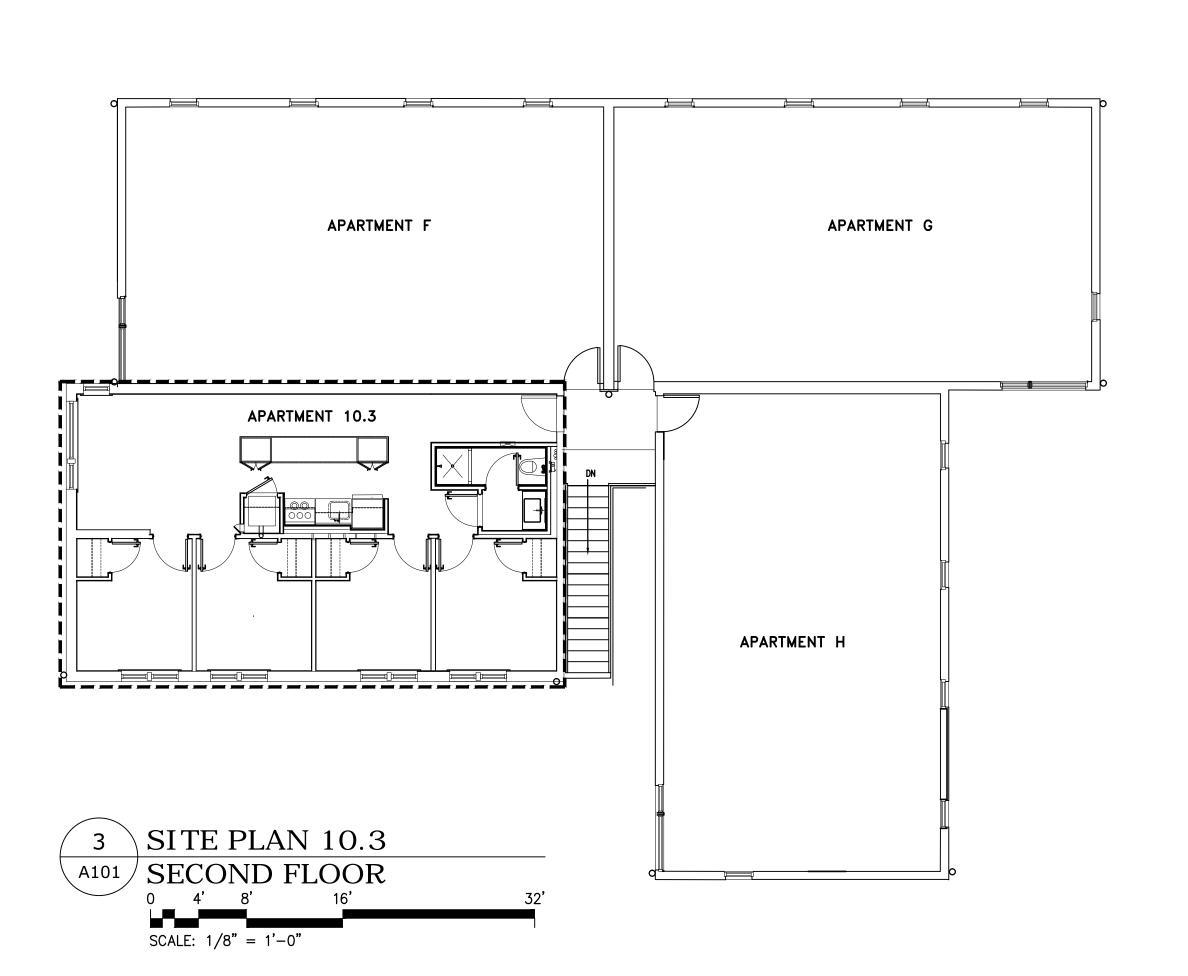

2 04/06/2023 100% SUBMISSION 1 09/24/2022 80% SUBMISSION

No. Date Revision

## AFRIDI ASSOCIATES

CONSULTING ENGINEE

19 West 21st Street 510 Broadhollow Road New York, NY 10010 Melville, NY 11747 Tel: (212) 243-0725 Tel: (631) 465-0786 Fax: (212) 243-0725 Fax: (631) 465-0788

aafridi@afridiassociates.com

# **LIZARDOS**

LONG ISLAND | NEW YORK CITY | CHARLOTTE | DANBURY

200 Old Country Road | Suite 670 Mineola | NY 11501 516 484 1020 Lizardos.com

Lizardos Engineering Associates D.P.C.

Designer: AKBER AFRIDI, P.E.

Drawn by: AZHER MALIK

Checked by: AKBER AFRIDI, P.E.

# Project: INTERIOR RENOVATIONS OF ALUMNI VILLAGE APARTMENTS 10.1 (ADA COMPLIANT) & 10.3

Address:
735 Anderson Hill Road

Purchase NY 10577


LOCATION/KEY PLAN
(FOR REFERENCE ONLY)

Drawing No.:
A101.00

Scale: AS NOTED

Date: 08/24/2020

SU-040623

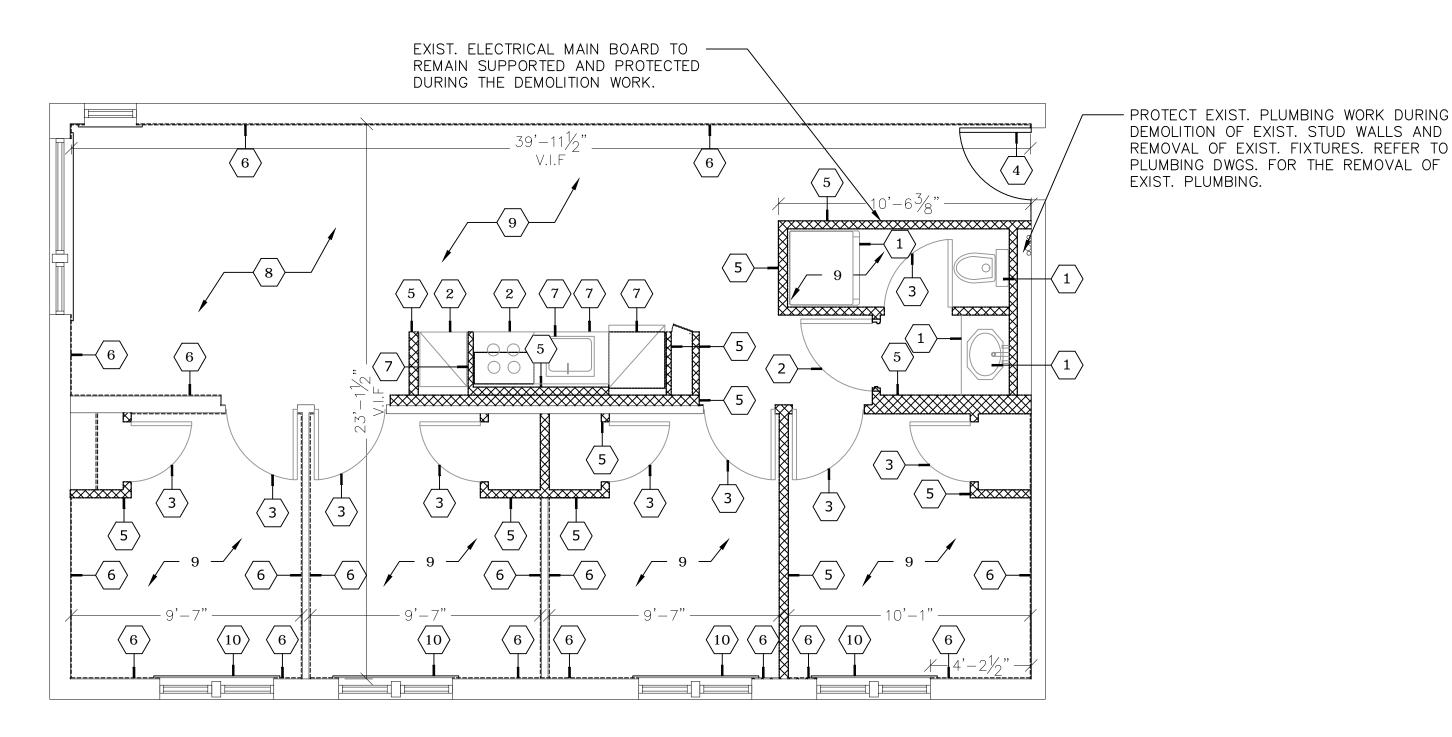

### **DEMOLITION KEY**

- REMOVE TOILET FIXTURES AND ASSOCIATED HARDWARE AND ASSOCIATED PLUMBING AND CARRIERS: PREPARE FOR NEW FIXTURES IN RELOCATED AREAS: PATCH AREAS AS NECESSARY TO MATCH ADJACENT FINISHES.
- DISCONNECT AND REMOVE KITCHEN APPLIANCES.
- REMOVE EXISTING DOOR AND DOOR HARDWARE.
- EXIST. DOOR TO REMAIN.
- REMOVE INTERIOR NON LOAD-BEARING WALL AND ASSOCIATED FRAMING AND BLOCKING AND SUPPORT AS INDICATED.
- REMOVE DAMAGED EXIST. DRYWALL, AND PREPARE EXIST. FRAMING FOR NEW DRYWALL. EXIST. DRYWALL IN GOOD CONDITION TO REMAIN.
- REMOVE CASEWORK AND BUILT-IN THROUGHOUT WORK AREA.
- REMOVE FINISH FLOOR AND REPAIR FOR NEW FLOOR FINISH.
- (9) REMOVE EXIST. DRYWALL CEILING CAREFULLY.
- UNINSTALL EXIST. WINDOW APRON AND CASING.

### **GENERAL NOTES**


- 1. SHUT DOWN ALL EXIST UTILITY CONNECTION PRIOR TO DISCONNECTING FIXTURES AND FAUCETS.
- 2. DISCONNECT AND SAFELY REMOVE ALL EXIST. EQUIPMENT.
- 3. CAP ALL EXIST. UTILITY CONNECTIONS PRIOR TO REINSTATING THE UTILITIES.
- 4. FOR REMOVAL OF ELECTRIC WIRING, SWITCHES, OUTLETS REFER TO ELECTRICAL DWGS.
- 5. FOR SMOKE DETECTORS AND OTHER EQUIPMENT REFER TO MEP DWGS.
- 6. NEW ROUGH DOOR OPENING SIZE MAY VARY ON METAL DOOR FRAME SIZE.
- 7. USE R-21, 5  $\frac{1}{2}$ " INSULATION BATTS FOR 2"x6" STUD WALL.
- 8. USE R-15, 3  $\frac{1}{2}$ " INSULATION BATTS FOR 2"X4" STUD WALL.

### <u>LEGEND</u>

----- EXIST. WALL, TO ----- REMAIN




----- NEW PARTIAL DRYWALL

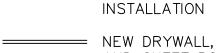

----- NEW DRYWALL, FRAMING ----- AND SHEET ROCK

DEMOLITION PLAN (A102/ADA APARTMENT 10.1 SCALE: 1/4" = 1'-0"

ALL DAMAGE TO ADJOINING WORK DUE TO FAILURE TO PROVIDE ADEQUATE PROTECTION SHALL BE CORRECTED BY THE CONTRACTOR AT THE CONTRACTOR'S EXPENSE.

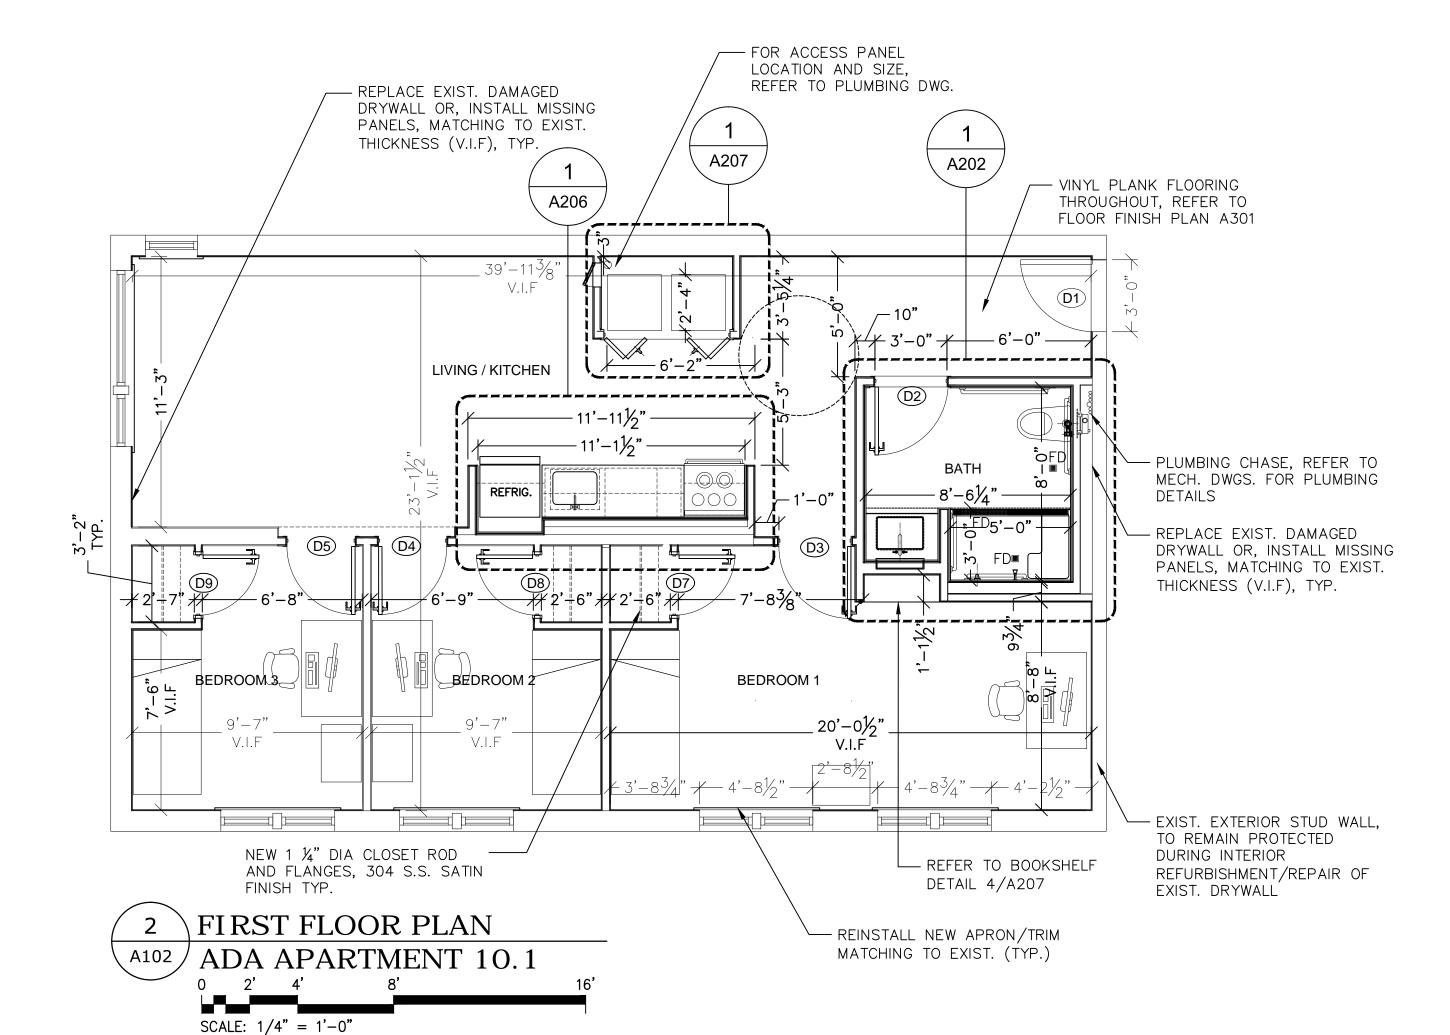

		CAPACITY POWER SUPPLY			R SUPPLY			
No.	APPLIANCE	WIDTH	DEPTH	HEIGHT	CAPACITY	COLOR	AMPS	WATTS
01	SPEED QUEEN (COMMERCIAL FRONT LOAD) WASHER	27"	27 3/4"	44 1/2"	4.5 CF	WHITE	15 A	
02	SPEED QUEEN (COMMERCIAL FRONT LOAD) DRYER	27"	30 3/8"		7.4 CF	WHITE	30 A	
03	FRIGIDAIRE REFRIGERATOR	30"	30 3/8"	66.38"	18.3 CF	S. STEEL	15 A	
04	FRIGIDAIRE COOKING RANGE (4 BURNERS)	30"	32"	34"	6.3 CF	S. STEEL	40 A	1500-4800
05	FRIGIDAIRE MICROWAVE (OVER THE RANGE)	30"	15 3/4"	16 3/8"	1.9 CF	S. STEEL	15 A	1000

2 04/06/2023 100% SUBMISSION

1 09/24/2022 80% SUBMISSION

No. Date Revision

### AFRIDI ASSOCIATES **CONSULTING ENGINEERS**

19 West 21st Street New York, NY 10010 Tel: (212) 243-0725

Tel: (631) 465-0786 Fax: (212) 243-0725 Fax: (631) 465-0788 aafridi@afridiassociates.com

510 Broadhollow Road

Melville, NY 11747

LONG ISLAND | NEW YORK CITY | CHARLOTTE | DANBURY

200 Old Country Road | Suite 670 Mineola | NY 11501 516 484 1020 Lizardos.com

Lizardos Engineering Associates D.P.C.

Designer:	AKBER AFRIDI, P.E.
Drawn by:	AZHER MALIK
Checked by:	AKBER AFRIDI, P.E.

### INTERIOR RENOVATIONS OF ALUMNI VILLAGE APARTMENTS 10.1 (ADA COMPLIANT) & 10.3

Address:


735 Anderson Hill Road Purchase NY 10577


Drawing Title: ADA APARTMENT 10.1, PARTIAL REMOVALS & PROPOSED PLANS


> Drawing No.: A102.00 Scale: AS NOTED

> > Date:

08/24/2020

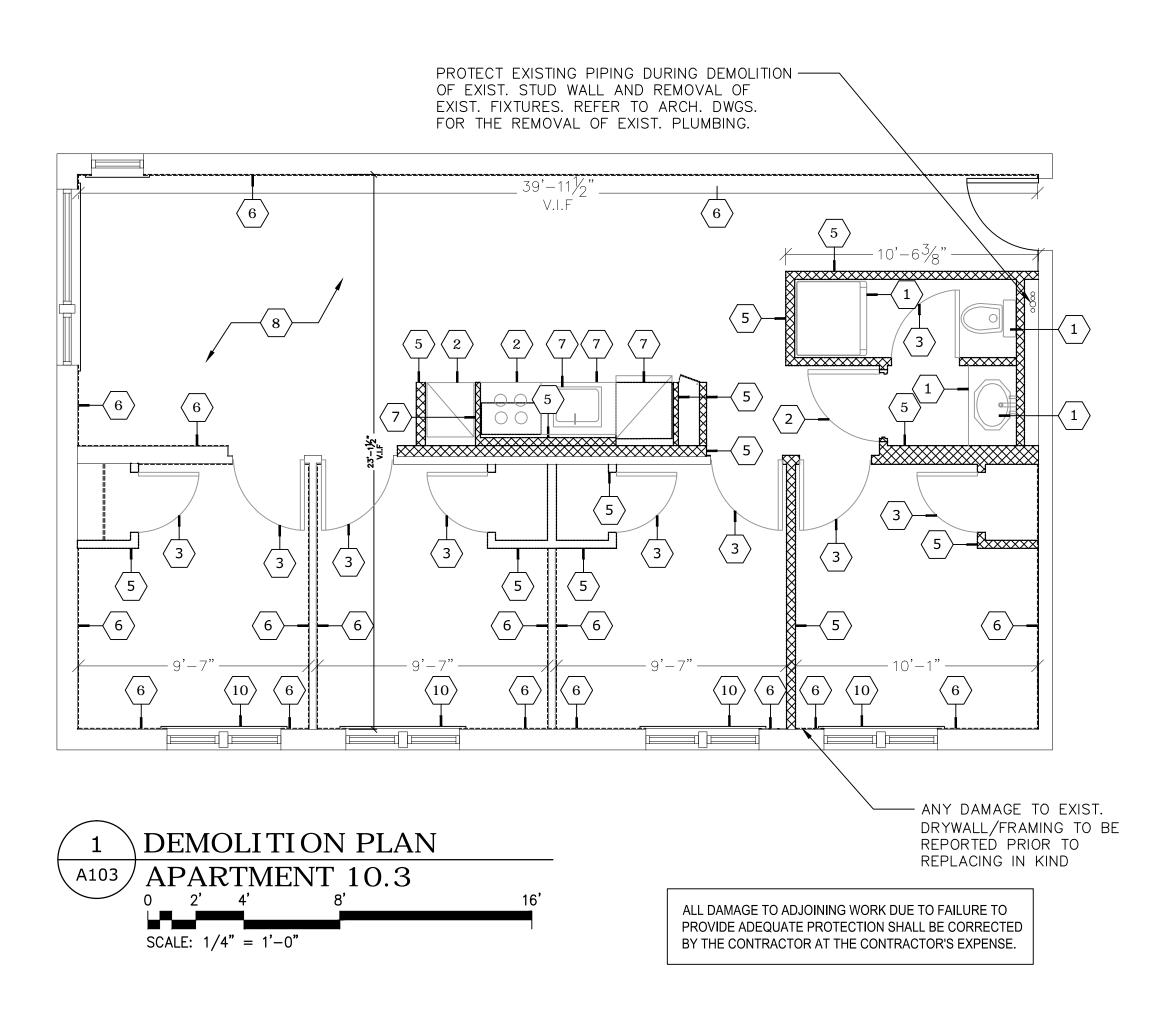

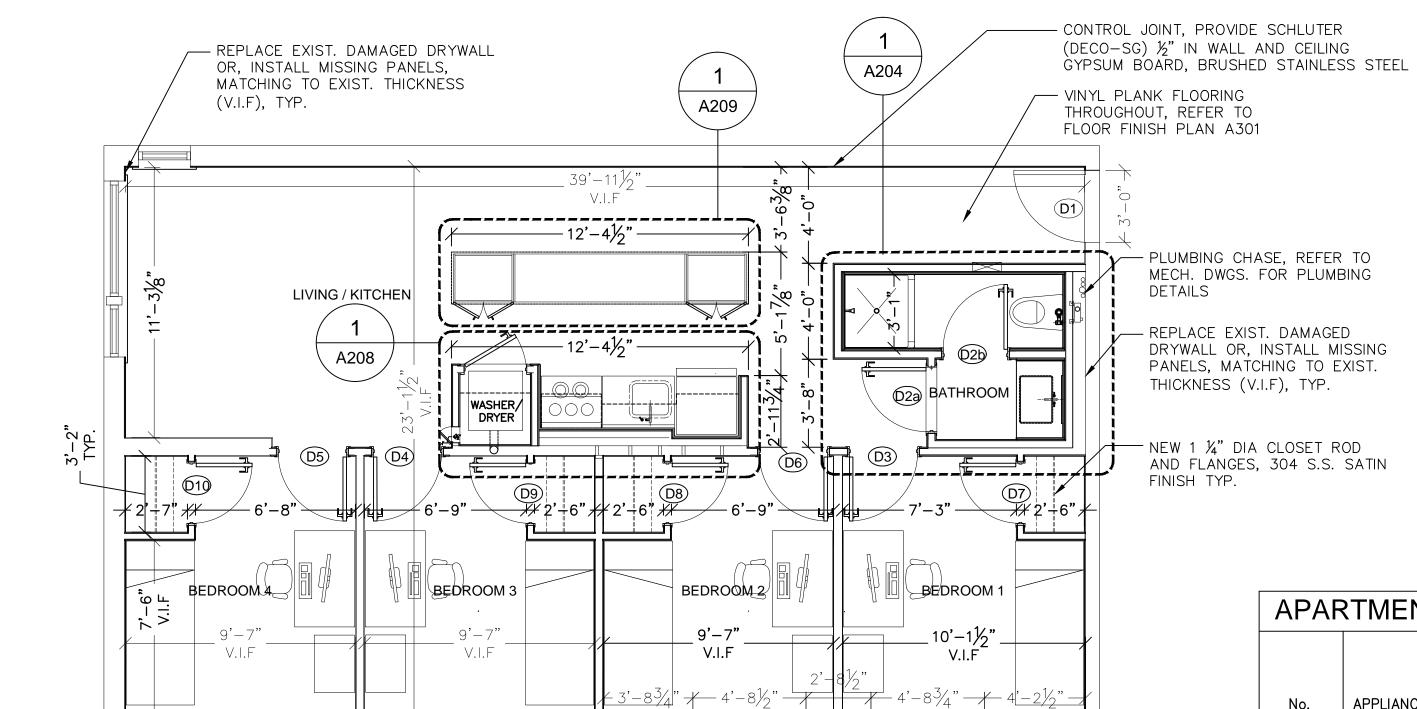

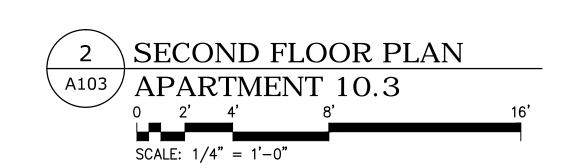

### DEMOLITION KEY

- REMOVE TOILET FIXTURES AND ASSOCIATED HARDWARE AND ASSOCIATED PLUMBING AND CARRIERS: PREPARE FOR NEW FIXTURES IN RELOCATED AREAS: PATCH AREAS AS NECESSARY TO MATCH ADJACENT FINISHES.
- DISCONNECT AND REMOVE KITCHEN APPLIANCES.
- REMOVE EXISTING DOOR AND DOOR HARDWARE.
- EXISTING DOOR TO REMAIN.
- REMOVE INTERIOR NON LOAD-BEARING WALL AND ASSOCIATED FRAMING AND BLOCKING AND SUPPORT AS INDICATED.
- EXISTING DRYWALL TO REMAIN. REMOVE ANY BROKEN PIECES WALL AND PREPARE STUD WALL FOR NEW
- 7 REMOVE CASEWORK AND BUILT-IN THROUGHOUT WORK
- 8 REMOVE FINISH FLOOR AND PREPARE FOR NEW FLOOR

UNINSTALL EXIST. WINDOW APRON AND CASING.

CAPACITY

DEPTH | HEIGHT | CAPACITY

34" 6.3 CF

27" | 27 3/4" | 78 1/4" | 21.5 LB

30" | 30 3/8" | 66.38" | 18.3 CF

30" | 15 3/4" | 16 3/8" | 1.9 CF

REMOVE EXIST. DRYWALL CEILING CAREFULLY.

APARTMENT 10.3, APPLIANCES (BY OTHERS)

| SPEED QUEEN (COMMERCIAL FRONT LOAD)

FRIGIDAIRE COOKING RANGE (4 BURNERS)

FRIGIDAIRE MICROWAVE (OVER THE RANGE)

STACKED WASHER/DRYER

FRIGIDAIRE REFRIGERATOR

APPLIANCE

### **GENERAL NOTES**

POWER SUPPLY

40 A 1500-4800

WATTS

AMPS

30 A

30 A

15 A

15 A

COLOR

S. STEEL

S. STEEL

S. STEEL

- 1. SHUT DOWN ALL EXIST UTILITY CONNECTION PRIOR TO DISCONNECTING FIXTURES AND FAUCETS.
- 2. DISCONNECT AND SAFELY REMOVE ALL EXIST. EQUIPMENT.
- 3. CAP ALL EXIST. UTILITY CONNECTIONS PRIOR TO REINSTATING THE UTILITIES.
- 4. FOR REMOVAL OF ELECTRIC WIRING, SWITCHES, OUTLETS REFER TO ELECTRICAL DWGS.
- 5. FOR SMOKE DETECTORS AND OTHER EQUIPMENT REFER TO MEP DWGS.
- 6. NEW ROUGH DOOR OPENING SIZE MAY VARY ON METAL DOOR FRAME SIZE.
- 7. USE R-21, 5  $\frac{1}{2}$ " INSULATION BATTS FOR 2"X6" STUD WALL.
- 8. USE R-15, 3 ½" INSULATION BATTS FOR 2"X4" STUD WALL.

### LEGEND

----- EXIST. WALL, TO REMAIN



----- NEW PARTIAL DRYWALL INSTALLATION

----- NEW DRYWALL, FRAMING AND SHEET ROCK

2 04/06/2023 100% SUBMISSION

1 09/24/2022 80% SUBMISSION

No. Date Revision

### AFRIDI ASSOCIATES **CONSULTING ENGINEERS**

19 West 21st Street New York, NY 10010 Tel: (212) 243-0725

Tel: (631) 465-0786 Fax: (212) 243-0725 Fax: (631) 465-0788

510 Broadhollow Road

Melville, NY 11747

aafridi@afridiassociates.com

# LIZARDOS

LONG ISLAND | NEW YORK CITY | CHARLOTTE | DANBURY

200 Old Country Road | Suite 670 Mineola | NY 11501 516 484 1020 Lizardos.com

Lizardos Engineering Associates D.P.C.

Designer:	AKBER AFRIDI, P.E.
Drawn by:	AZHER MALIK
Checked by:	AKBER AFRIDI, P.E.

### INTERIOR RENOVATIONS OF ALUMNI VILLAGE APARTMENTS 10.1 (ADA COMPLIANT) & 10.3

Address:

735 Anderson Hill Road Purchase NY 10577

Drawing Title: **APARTMENT 10.3, PARTIAL** REMOVAL & PROPOSED PLANS


> Drawing No.: A103.00


> > Scale: AS NOTED


Date:

08/24/2020

SU-040623

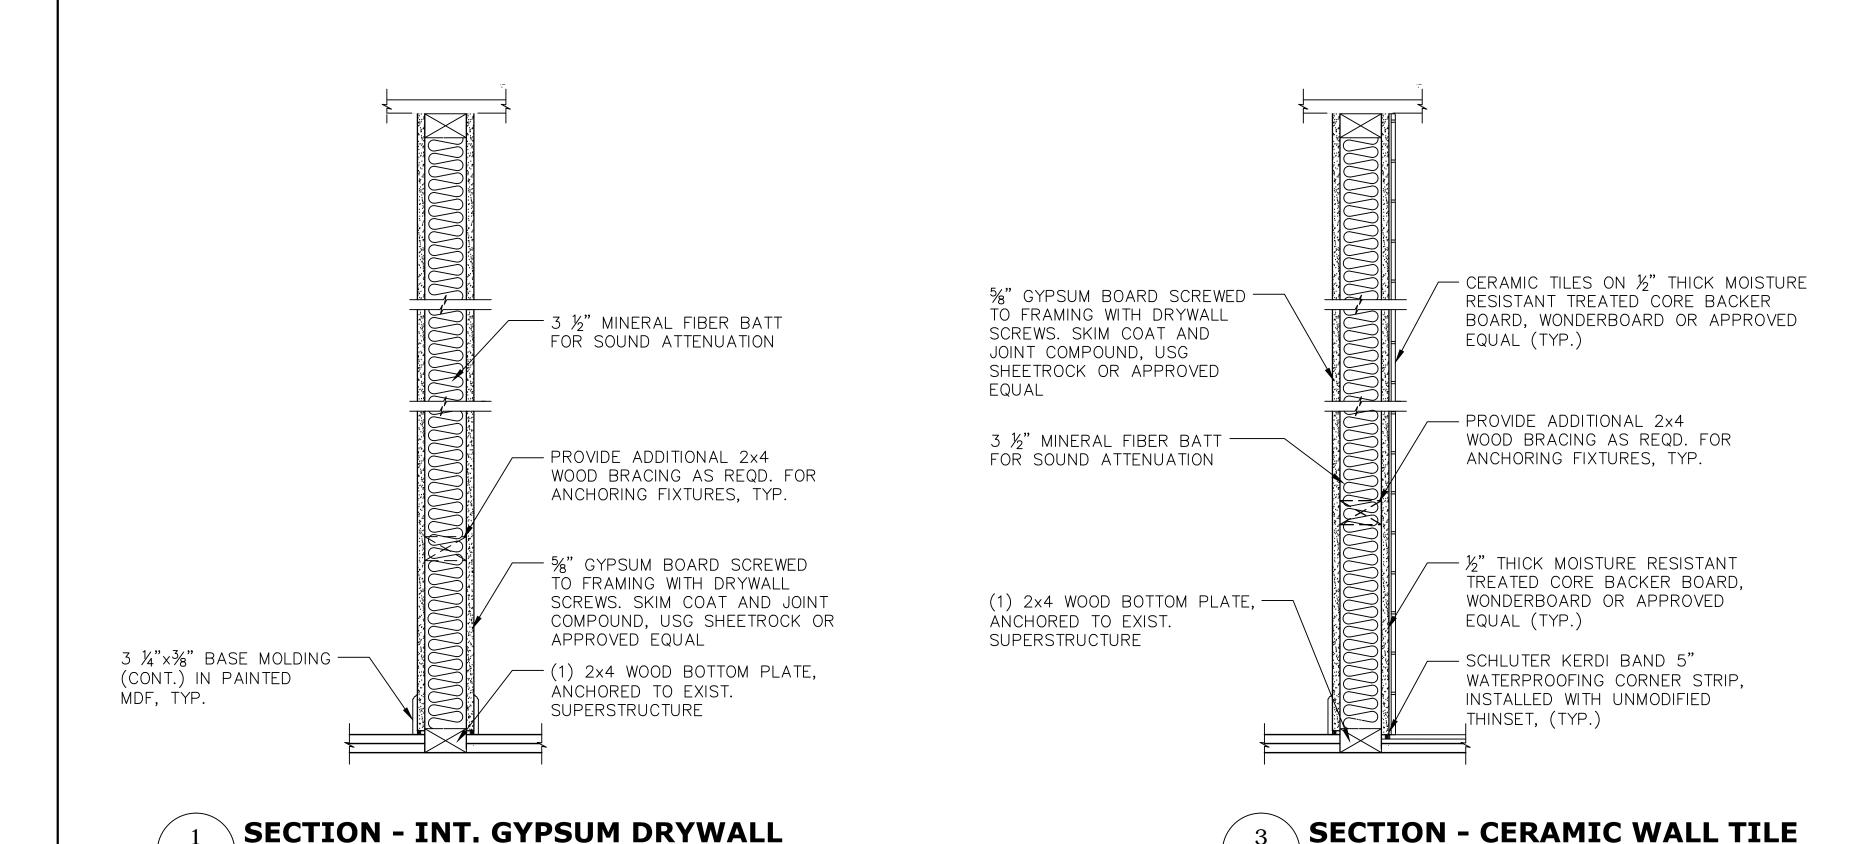

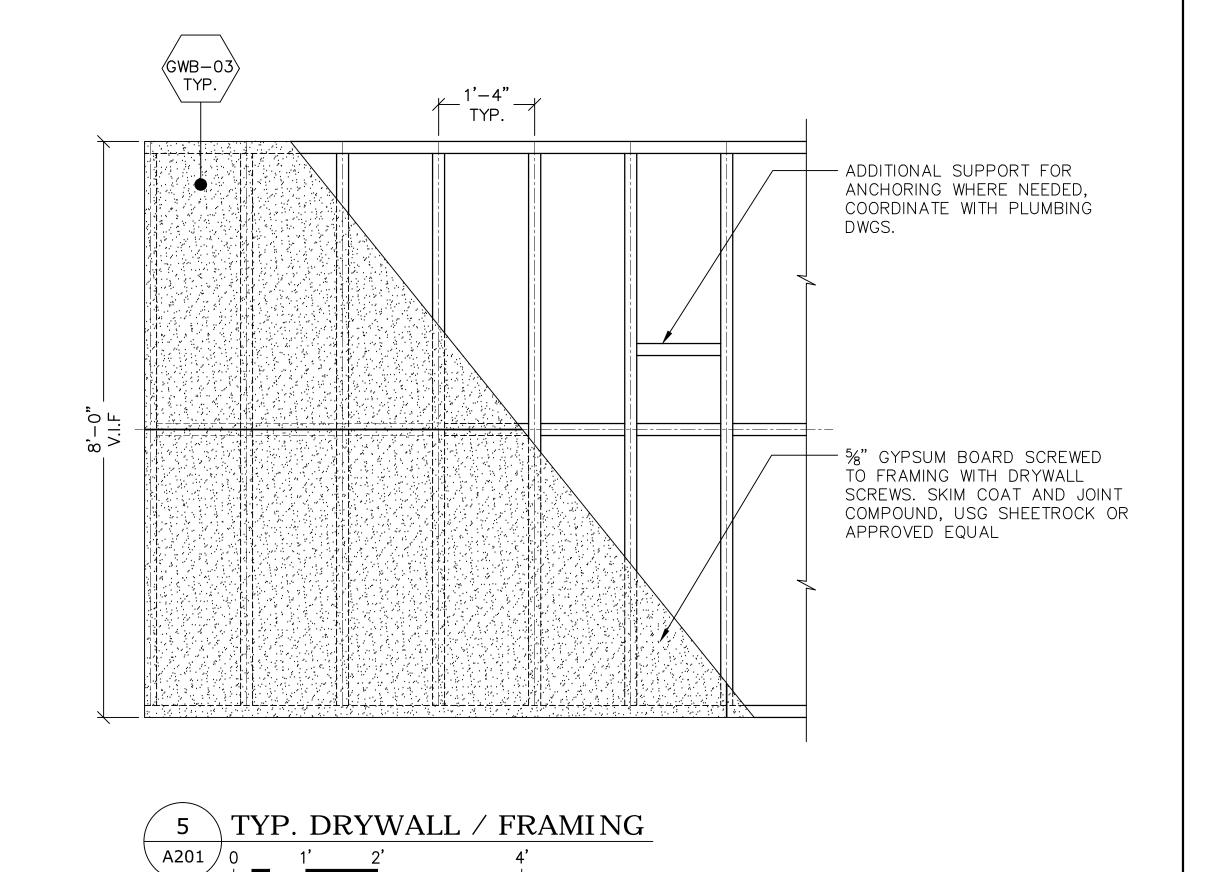

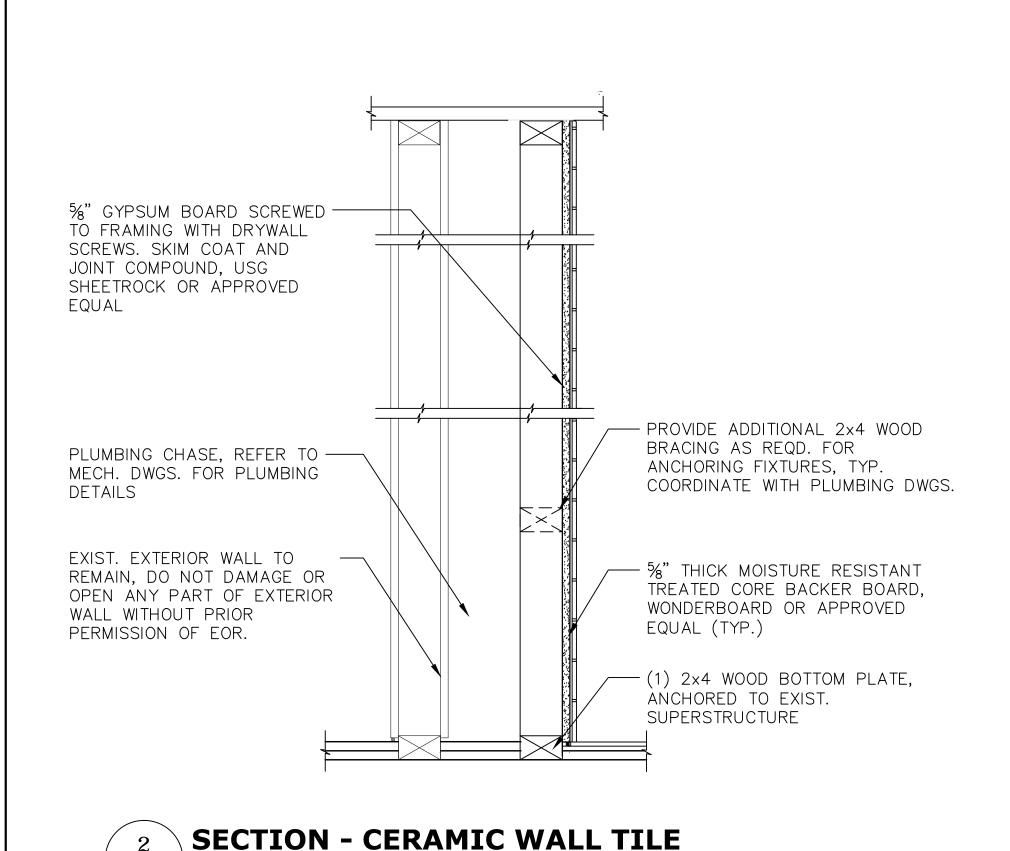


A201 / 0 6" 1'

 $\frac{1}{1} = \frac{1}{1} = \frac{1}$ 

A201 / ON BACKER BOARD

SCALE:  $1 \frac{1}{2} = 1 - 0$ 

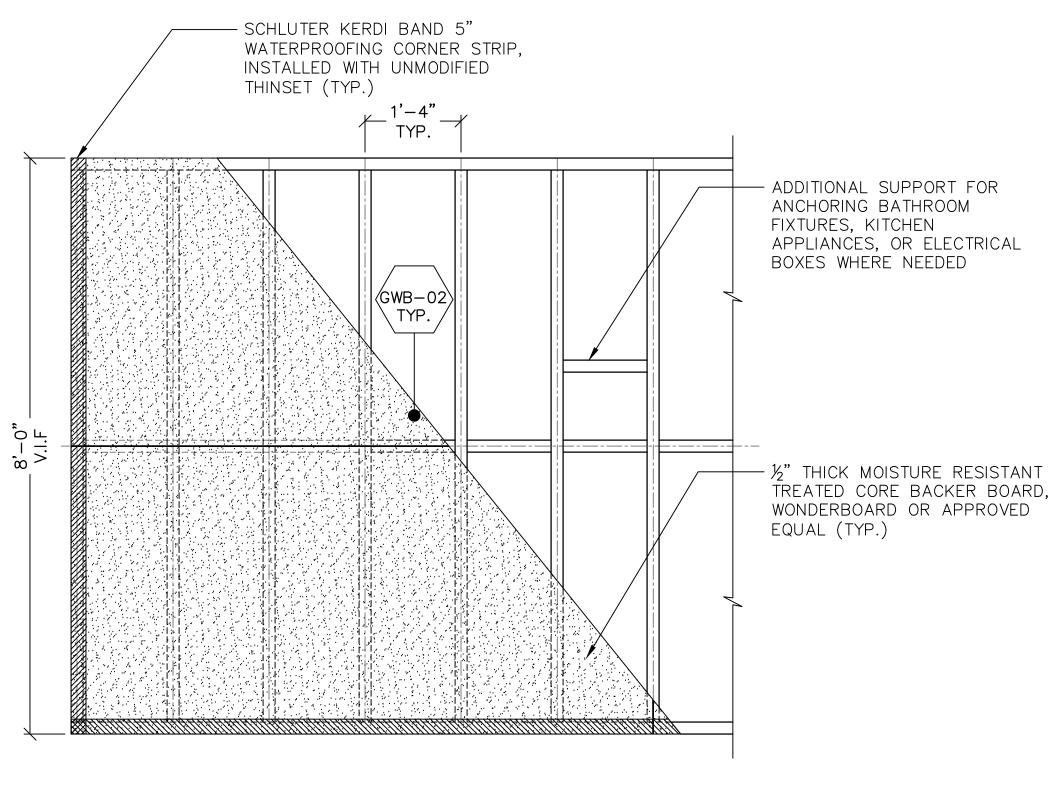


ON BACKER BOARD

DRYWALL / FRAMING


 $\frac{1}{5}$  SCALE:  $\frac{3}{4}$ " =  $\frac{1}{-0}$ "

(KITCHEN & BATHROOM)

 $\frac{1}{1} = \frac{1}{1} = \frac{1}$ 

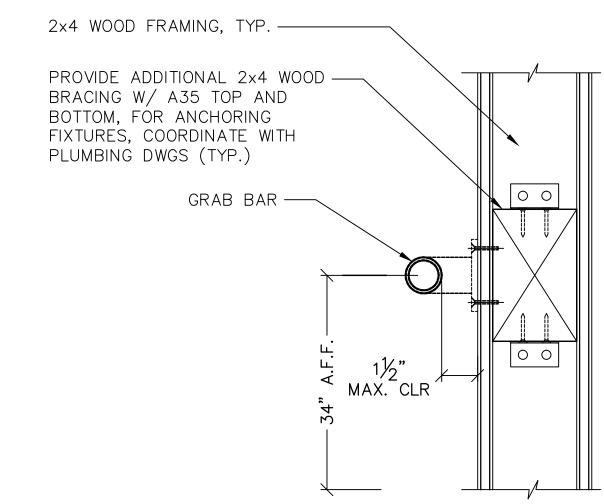

SCALE: 3/4" = 1'-0"

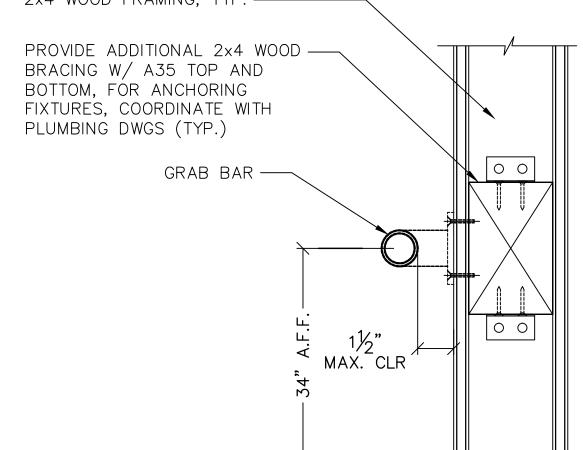



# SCALE: 3'' = 1'-0''

### NOTE:

- 1. GRAB BAR MOUNTING TO WITHSTAND 250 LBS IN BENDING SHEAR AND TENSION W/ 1/8" MIN. RADIUS ON ALL EDGES. BAR SHALL NOT ROTATE IN FITTINGS.
- 2. A GRAB BAR AND ANY WALL SURFACE ADJACENT TO IT SHALL BE FREE OF ANY SHARP OR ABRASIVE ELEMENTS. EDGES SHALL HAVE A MINIMUM RADIUS OF 1/8".
- 3. ALL OTHER EQUIPMENT SHALL BE ADA COMPLIANT WITH ADDITIONAL HORIZONTAL BRACING.

2 04/06/2023 100% SUBMISSION 1 09/24/2022 80% SUBMISSION

Revision

No. Date

## AFRIDI ASSOCIATES

**CONSULTING ENGINEERS** 

19 West 21st Street 510 Broadhollow Road New York, NY 10010 Melville, NY 11747 Tel: (212) 243-0725 Tel: (631) 465-0786 Fax: (212) 243-0725 Fax: (631) 465-0788

aafridi@afridiassociates.com

# LIZARDOS

LONG ISLAND | NEW YORK CITY | CHARLOTTE | DANBURY

200 Old Country Road | Suite 670 Mineola NY 11501 516 484 1020 Lizardos.com

Lizardos Engineering Associates D.P.C.

Designer:	AKBER AFRIDI, P.E.
Drawn by:	AZHER MALIK
Checked by:	AKBER AFRIDI, P.E.

INTERIOR RENOVATIONS OF ALUMNI VILLAGE APARTMENTS


# 10.1 (ADA COMPLIANT) & 10.3 735 Anderson Hill Road


Drawing Title: WALL SECTIONS

Purchase NY 10577

Drawing N	) 1.00	
Scale:	AS NOTED	

SU-040623

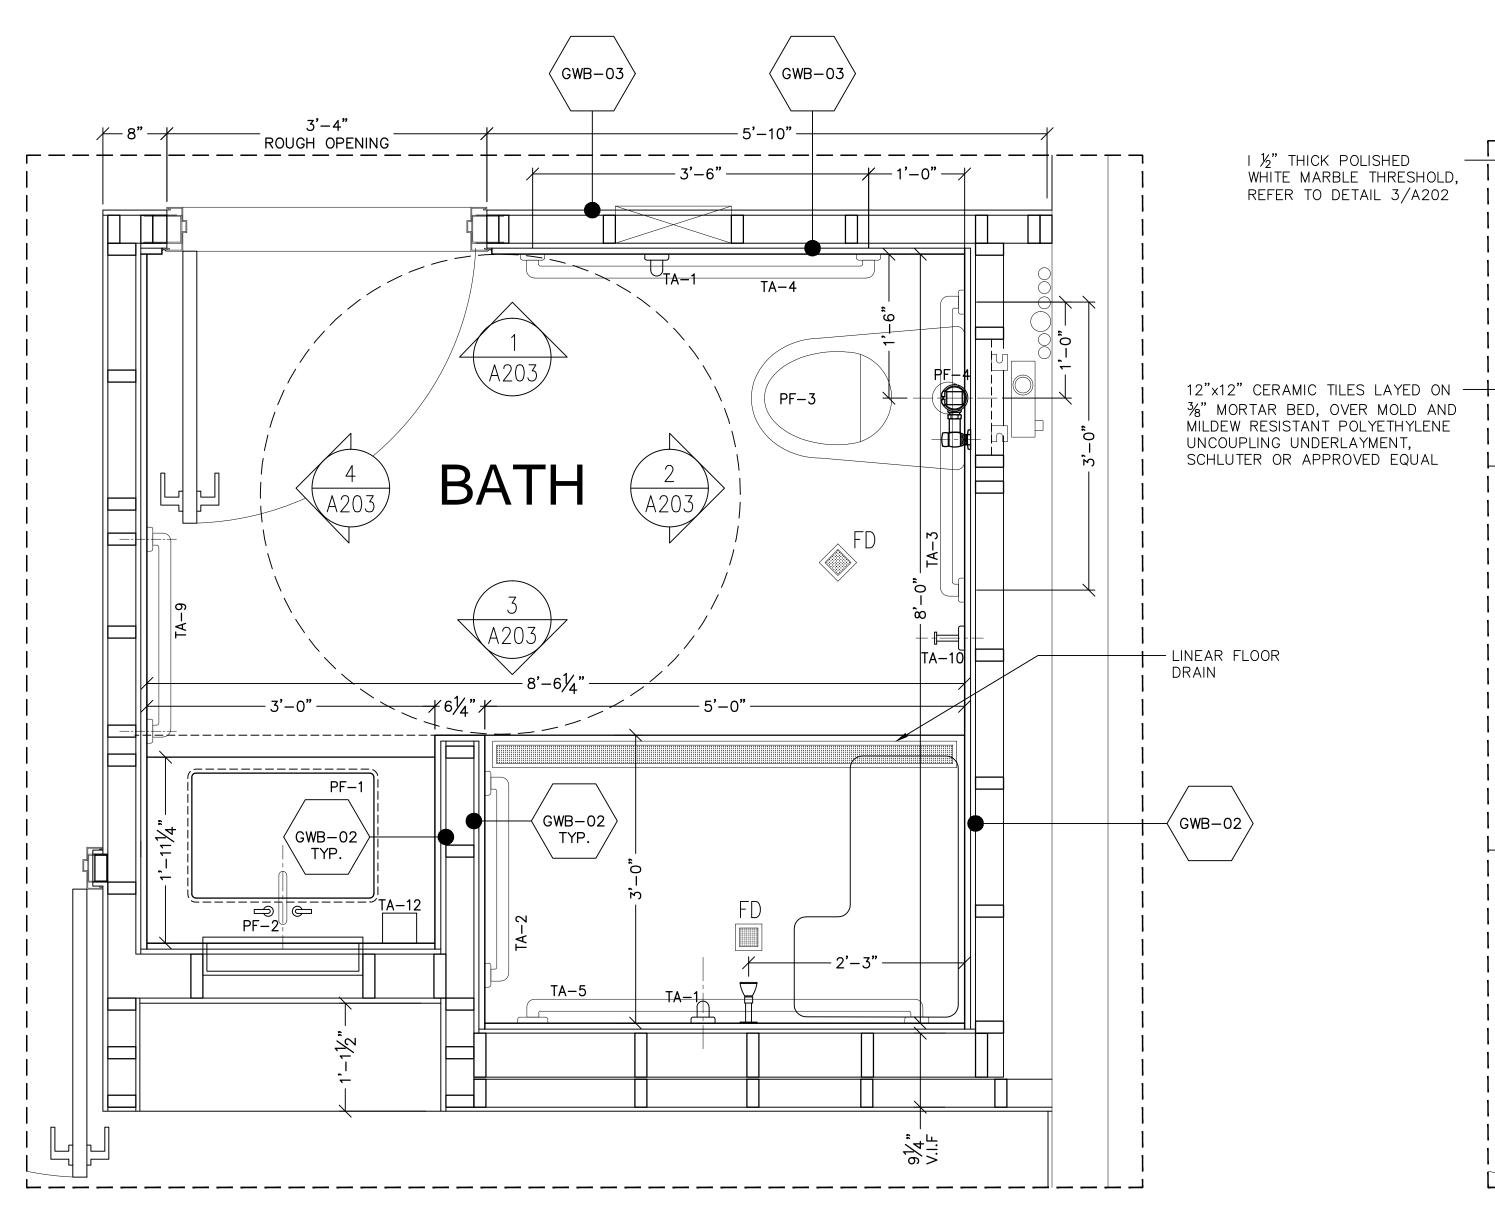


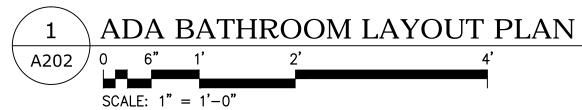

APA	RTM	ENT 10.1 PLUMBING FIXTURE SCHEDULE			
MARK	QTY	DESCRIPTION	MANUFACTURER	MODEL	REMARKS
PF-1	1	'STUDIO' UNDERCOUNTER SINK, VITREOUS CHINA	AMERICAN STANDARD	STUDIO - 0618.300	
PF-1K	1	'RUVATI' MODENA UNDERMOUNT 20 1/2"x17 3/4" BRUSHED SS SINK (16 GAUGE)	RUVATI	MODENA	
PF-2	1	'MONTERREY' TWO HANDLE 8" WIDESPREAD LAVATORY FAUCET	AMERICAN STANDARD	MONTERREY - 6500.170	
PF-2K	1	'HYDROLOCK' SINGLE HANDLE HIGH ARC PULL DOWN KITCHEN FAUCET	MOEN	CA87094 SERIES	
PF-3	1	'MODERA' FLOWISE 16 1/2" (FLUSHOMETER TOILET), 1.28 GPF	AMERICAN STANDARD		
PF-4	1	'SOLIS' SLOAN BATTERY/SOLAR POWERED DUAL FLUSH (8111-1.6/1.1)	SLOAN	8111-1.6/1.1	
			SLOAN		
PF-5	1	'M-DURA' COMMERCIAL THREE-FUNCTION SHOWER SYSTEM	MOEN	T9342	

NOTE: STANDARD CAMPUS WIDE FIXTURES, FINISHES AND OPERATION, G.C. TO COORDINATE.


	BATHROOM ACCESSORIES				
MARK	QTY	DESCRIPTION	MANUFACTURER	MODEL	REMARKS
TA-1	2	BOBRICK B-5806.99x18 STRAIGHT PEENED GRAB BAR	BOBRICK WASHROOM EQUIPMENT, INC.	B-5806.99x18	S.S. SATIN EXTRA HEAVY DUTY SURFACE MOUNTED
TA-2	1	BOBRICK B-5806.99x24 STRAIGHT PEENED GRAB BAR	BOBRICK WASHROOM EQUIPMENT, INC.	B-5806.99x24	S.S. SATIN EXTRA HEAVY DUTY SURFACE MOUNTED
TA-3	1	BOBRICK B-5806.99x36 STRAIGHT PEENED GRAB BAR	BOBRICK WASHROOM EQUIPMENT, INC.	B-5806.99x36	S.S. SATIN EXTRA HEAVY DUTY SURFACE MOUNTED
TA-4	1	BOBRICK B-5806.99x42 STRAIGHT PEENED GRAB BAR	BOBRICK WASHROOM EQUIPMENT, INC.	B-5806.99x42	S.S. SATIN EXTRA HEAVY DUTY SURFACE MOUNTED
TA-5	1	BOBRICK B-5806.99x48 STRAIGHT PEENED GRAB BAR	BOBRICK WASHROOM EQUIPMENT, INC.	B-5806.99x48	S.S. SATIN EXTRA HEAVY DUTY SURFACE MOUNTED
TA-6	1	BOBRICK COMMERCIAL TOILET PAPER DISPENSER	BOBRICK WASHROOM EQUIPMENT, INC.	B-6677	S.S. SATIN FIN.
TA-7	1	KOHLER, MEDICINE CABINET, RECESSED-MOUNTED	KOHLER	CATALAN	ANODIZED ALUMINUM (20 1/8"x36 1/8")
TA-8	1	BOBRICK B-542, SATIN FINISH STAINLESS STEEL COAT HOOK	BOBRICK WASHROOM EQUIPMENT, INC.	B-9542	S.S. SATIN FIN.
TA-9	1	BOBRICK B-530x18, TOWEL BAR	BOBRICK WASHROOM EQUIPMENT, INC.	B-530x18	S.S. SATIN EXTRA HEAVY DUTY SURFACE MOUNTED
TA-10	1	BOBRICK B-6777, SATIN FINISH STAINLESS STEEL TOWEL PIN	BOBRICK WASHROOM EQUIPMENT, INC.	B-6777	S.S. SATIN FIN.
TA-11	1	BOBRICK B-207x60, SHOWER CURTAIN ROD/CONCEALED MOUNT	BOBRICK WASHROOM EQUIPMENT, INC.	B-207x60	S.S. SATIN FIN.
TA-12	1	BOBRICK B-40, SURFACE MOUNTED SOAP DISPENSER	BOBRICK WASHROOM EQUIPMENT, INC.	B-40 (ADA)	POLYETHYLENE FIN.(BLACK)

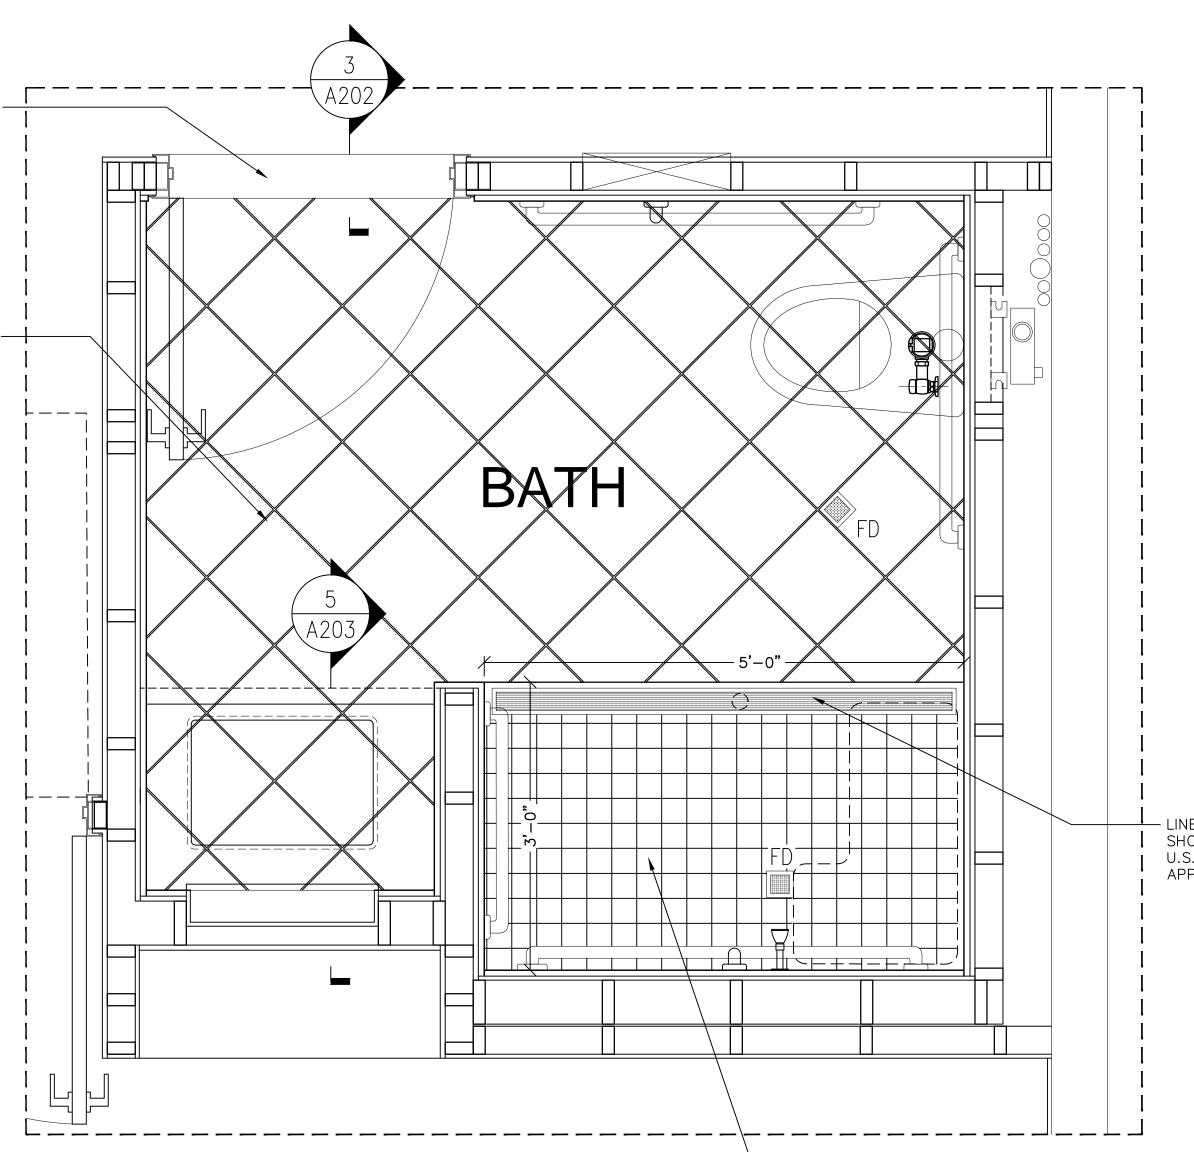

2 \ ADA BATHROOM PLAN - FLOOR TILES

A202 / 0 6" 1'

SCALE: 1" = 1'-0"

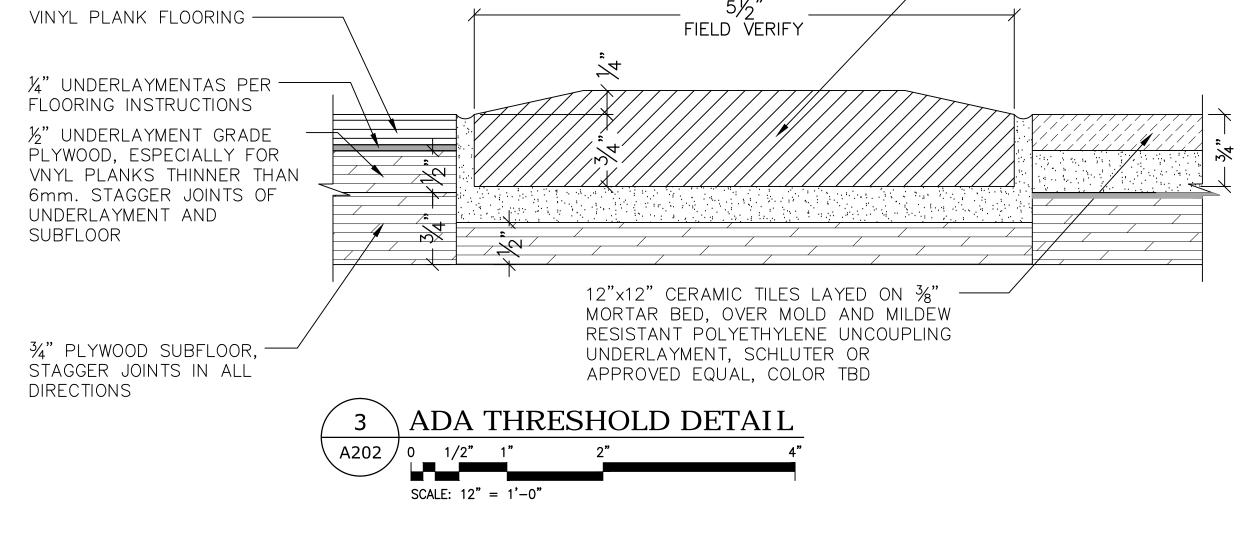


NOTES

- LEVEL SUBFLOOR AS REQUIRED PRIOR TO INSTALLING FINISH FLOOR.
- 2. STAGGER SUBFLOOR JOINTS IN BOTH DIRECTIONS.
- 3. PROVIDE COLOR SAMPLES AND FULL SIZE TILE SAMPLES FOR APPROVAL PRIOR TO INSTALLATION OF TILES/VINYL PLANKS.
- 4. FOR SHOWER AREA, BATHROOM AND KITCHEN WALLS, USE SCHLUTER KERDI MEMBRANE, CORNER STRIPS AND FIXTURE AND FAUCET SEALS.
- 5. FOR BATHROOM FLOOR UNCOUPLING MEMBRANE, USE SCHLUTER DITRA OR APPROVED EQUAL.
- 6. DOOR STOP IN BATHROOM, TO BE INSTALLED ON BASEBOARD/TILED WALL. DO NOT INSTALL ON FINISH FLOOR.
- 7. ELECTRICAL RECEPTACLES NEAR WET AREA TO BE GFCI OUTLETS.

### <u>LEGEND</u>



12"x12" CERAMIC FLOOR
TILES (BATHROOM)

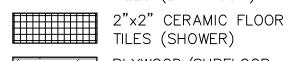

PLYWOOD/SUBFLOOR

LINEAR STAINLESS STEEL SHOWER DRAIN, KOHLER, U.S. TRENCH DRAIN OR APPROVED EQUAL

- 2"x2" MOSAIC/CERAMIC TILES LAYED ON

MEMBRANE UNDERLAYMENT, SCHLUTER OR APPROVED EQUAL

3/8" MORTAR BED, OVER WATERPROOFING

- BEVELLED WHITE MARBLE

2 04/06/2023 100% SUBMISSION

1 09/24/2022 80% SUBMISSION

No. Date Revision

# AFRIDI ASSOCIATES

CONSULTING ENGINEERS

19 West 21st Street 510 Broadhollow Road

New York, NY 10010 Melville, NY 11747
Tel: (212) 243-0725 Fax: (212) 243-0725 Fax: (631) 465-0788

aafridi@afridiassociates.com

# **LIZARDOS**

LONG ISLAND | NEW YORK CITY | CHARLOTTE | DANBURY

200 Old Country Road | Suite 670 Mineola | NY 11501 516 484 1020 Lizardos.com

Lizardos Engineering Associates D.P.C.

Designer:	AKBER AFRIDI, P.E.
Drawn by:	AZHER MALIK
Checked by:	AKBER AFRIDI, P.E.

### Project:

### INTERIOR RENOVATIONS OF ALUMNI VILLAGE APARTMENTS 10.1 (ADA COMPLIANT) & 10.3

Address: 735 Anderson Hill Road

Purchase NY 10577

Drawing Title:


ENLARGED BATHROOM PLANS
ADA APARTMENT 10.1


Drawing No.:
A202.00


Scale: AS NOTED

Date: 08/24/2020

SU-040623

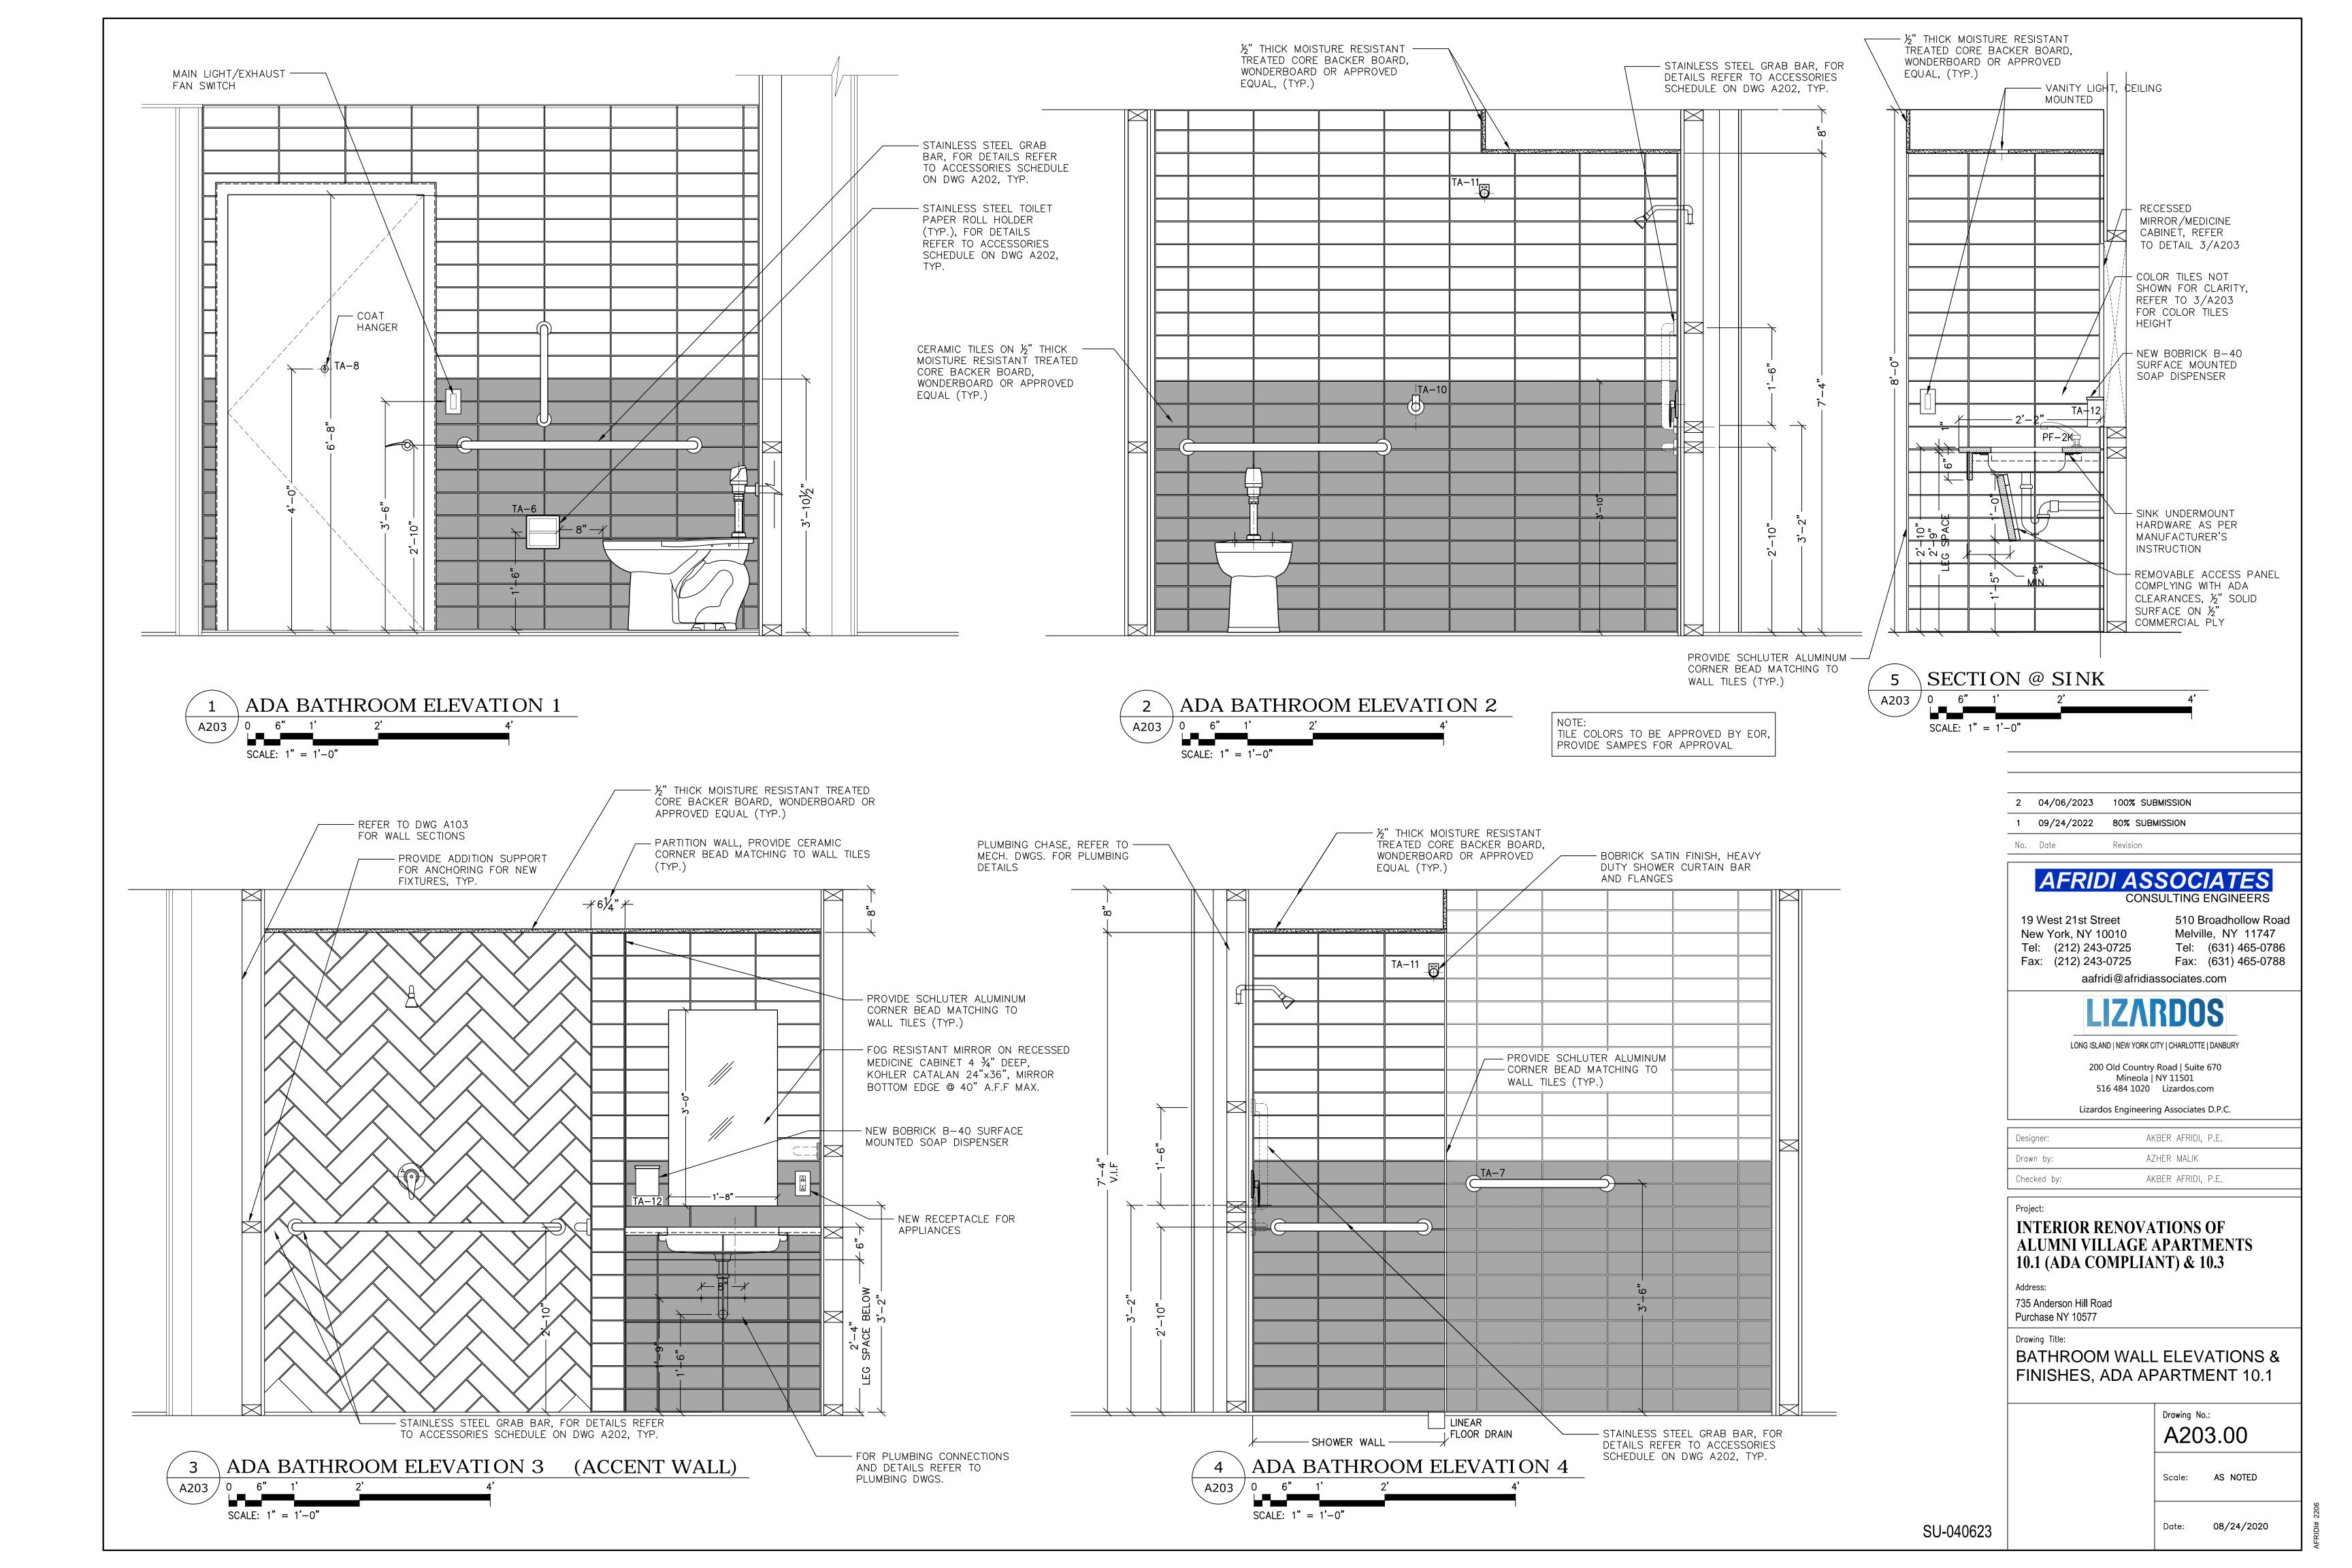

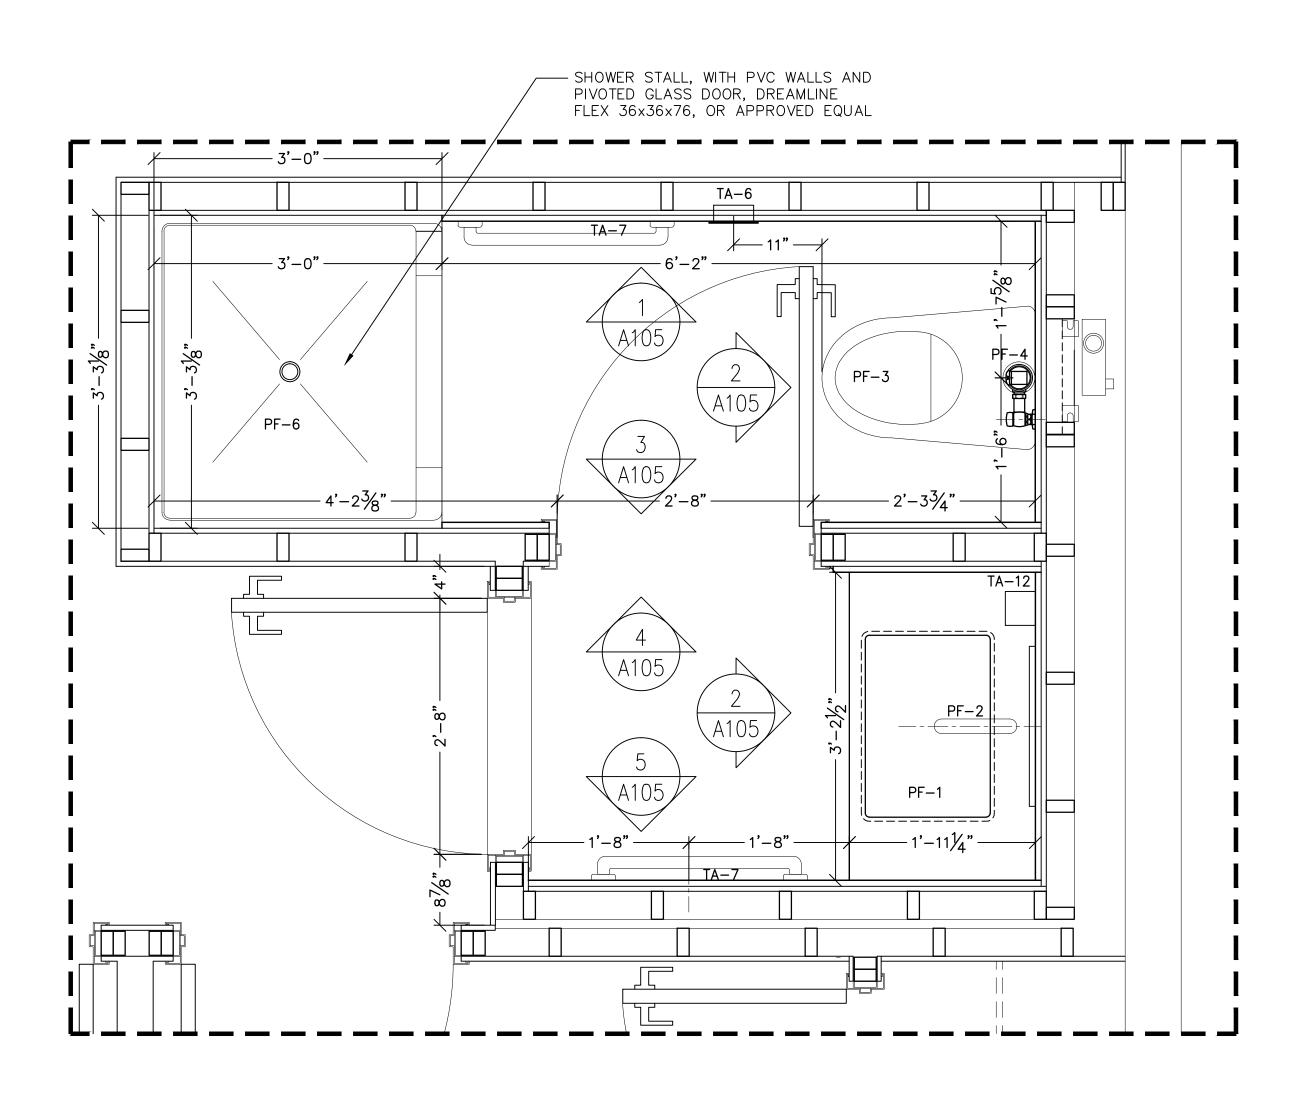


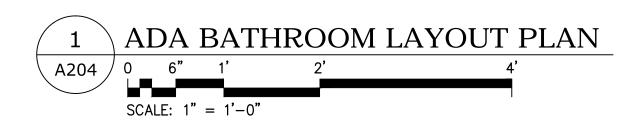

APA	APARTMENT 10.1 PLUMBING FIXTURE SCHEDULE				
MARK	QTY	DESCRIPTION	MANUFACTURER	MODEL	REMARKS
PF-1	1	'STUDIO' UNDERCOUNTER SINK, VITREOUS CHINA	AMERICAN STANDARD	STUDIO - 0618.300	GLAZED UNDERSIDE
PF-1K	1	'RUVATI' MODENA UNDERMOUNT 20 1/2"x17 3/4" BRUSHED SS SINK (16 GAUGE)	RUVATI	MODENA	
PF-2	1	'MONTERREY' TWO HANDLE 8" WIDESPREAD LAVATORY FAUCET	AMERICAN STANDARD	MONTERREY - 6500.170	
PF-2K	1	'HYDROLOCK' SINGLE HANDLE HIGH ARC PULL DOWN KITCHEN FAUCET	MOEN	CA87094 SERIES	
PF-3	1	'MODERA' FLOWISE 16 1/2" (FLUSHOMETER TOILET), 1.28 GPF	AMERICAN STANDARD		
PF-4	1	'SOLIS' SLOAN BATTERY/SOLAR POWERED DUAL FLUSH (8111-1.6/1.1)	SLOAN	8111-1.6/1.1	
PF-5	1	'M-DURA' COMMERCIAL THREE-FUNCTION SHOWER SYSTEM	MOEN	T9342	
PF-6	1	36Dx36Lx76 3/4 H SEMI FRAMLESS DOOR, BASE/BACKWALLS, SATIN CHROME	DREAMLINE	DL-6218C-04CL FLEX	

NOTE: STANDARD CAMPUS WIDE FIXTURES, FINISHES AND OPERATION, G.C. TO COORDINATE.

MARK	QTY	DESCRIPTION	MANUFACTURER	MODEL	REMARKS
TA-1		BOBRICK B-5806.99x18 STRAIGHT PEENED GRAB BAR	BOBRICK WASHROOM EQUIPMENT, INC.	B-5806.99x18	S.S. SATIN EXTRA HEAVY DUTY SURFACE MOUNTED
TA-2		BOBRICK B-5806.99x24 STRAIGHT PEENED GRAB BAR	BOBRICK WASHROOM EQUIPMENT, INC.	B-5806.99x24	S.S. SATIN EXTRA HEAVY DUTY SURFACE MOUNTED
TA-3		BOBRICK B-5806.99x36 STRAIGHT PEENED GRAB BAR	BOBRICK WASHROOM EQUIPMENT, INC.	B-5806.99x36	S.S. SATIN EXTRA HEAVY DUTY SURFACE MOUNTED
TA-4		BOBRICK B-5806.99x42 STRAIGHT PEENED GRAB BAR	BOBRICK WASHROOM EQUIPMENT, INC.	B-5806.99x42	S.S. SATIN EXTRA HEAVY DUTY SURFACE MOUNTED
TA-5		BOBRICK B-5806.99x48 STRAIGHT PEENED GRAB BAR	BOBRICK WASHROOM EQUIPMENT, INC.	B-5806.99x48	S.S. SATIN EXTRA HEAVY DUTY SURFACE MOUNTED
TA-6	1	BOBRICK COMMERCIAL TOILET PAPER DISPENSER	BOBRICK WASHROOM EQUIPMENT, INC.	B-6677	S.S. SATIN FIN.
TA-7	1	KOHLER, MEDICINE CABINET, RECESSED-MOUNTED	KOHLER	CATALAN	ANODIZED ALUMINUM (20 1/8"x36 1/8")
TA-8	1	BOBRICK B-542, SATIN FINISH STAINLESS STEEL COAT HOOK	BOBRICK WASHROOM EQUIPMENT, INC.	B-9542	S.S. SATIN FIN.
TA-9	2	BOBRICK B-530x18, TOWEL BAR	BOBRICK WASHROOM EQUIPMENT, INC.	B-530x18	S.S. SATIN EXTRA HEAVY DUTY SURFACE MOUNTED
TA-10		BOBRICK B-6777, SATIN FINISH STAINLESS STEEL TOWEL PIN	BOBRICK WASHROOM EQUIPMENT, INC.	B-6777	S.S. SATIN FIN.
TA-11		BOBRICK B-207x60, CLOSET ROD/CONCEALED MOUNT	BOBRICK WASHROOM EQUIPMENT, INC.	B-207x60	S.S. SATIN FIN.
TA-12	1	BOBRICK B-40, SURFACE MOUNTED SOAP DISPENSER	BOBRICK WASHROOM EQUIPMENT, INC.	B-40 (ADA)	POLYETHYLENE FIN.(BLACK)

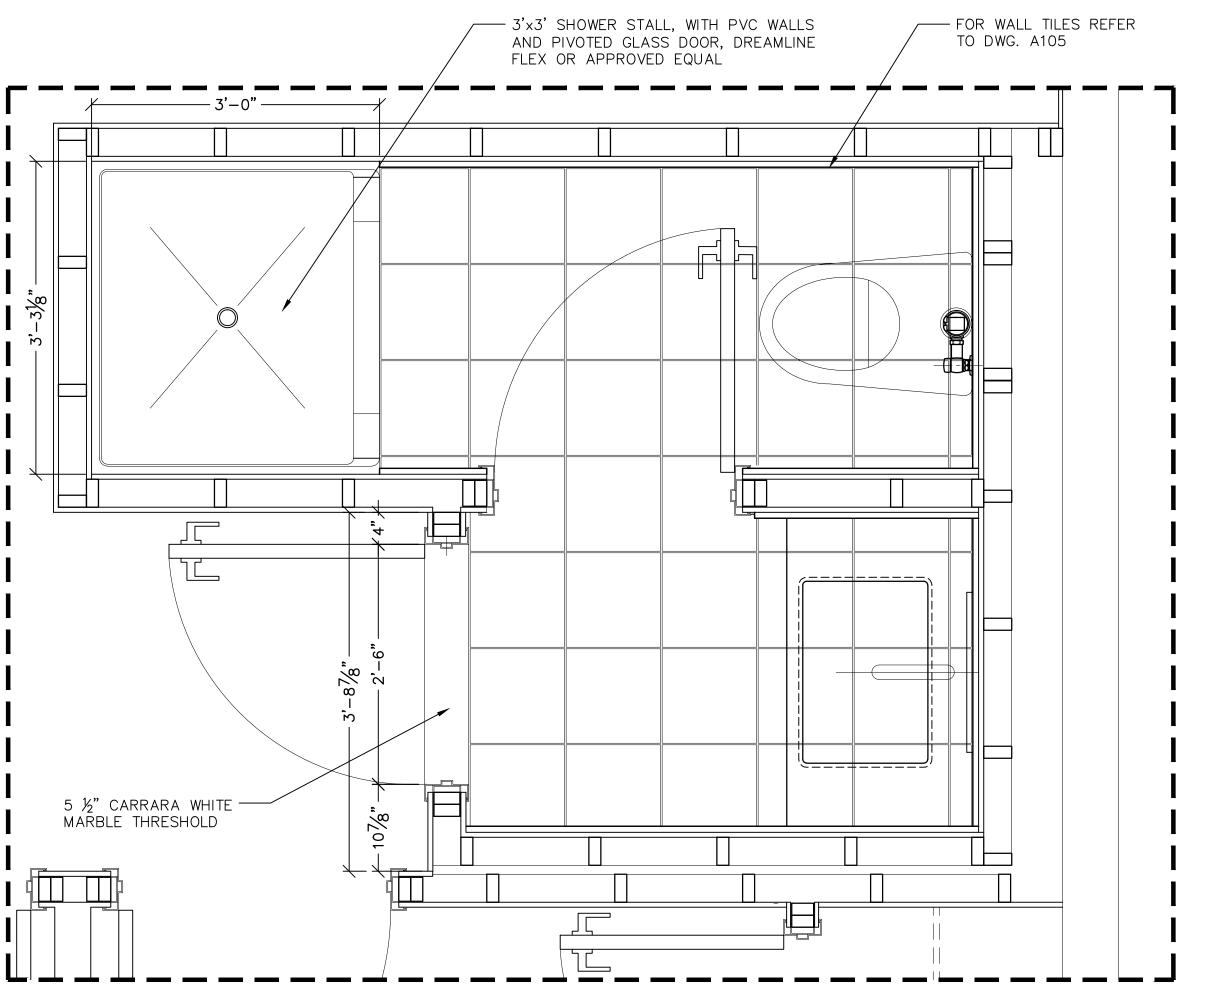



### NOTES

- 1. LEVEL SUBFLOOR AS REQUIRED PRIOR TO INSTALLING FINISH FLOOR.
- 2. STAGGER SUBFLOOR JOINTS IN BOTH DIRECTIONS.
  - 3. PROVIDE COLOR SAMPLES AND FULL SIZE TILE SAMPLES FOR APPROVAL PRIOR TO INSTALLATION OF TILES/VINYL PLANKS.
  - 4. FOR SHOWER AREA, BATHROOM AND KITCHEN WALLS, USE SCHLUTER KERDI MEMBRANE, CORNER STRIPS AND FIXTURE AND FAUCET SEALS.
  - 5. FOR BATHROOM FLOOR UNCOUPLING MEMBRANE, USE SCHLUTER DITRA OR APPROVED EQUAL.
  - 6. DOOR STOP IN BATHROOM, TO BE INSTALLED ON BASEBOARD/TILED WALL. DO NOT INSTALL ON FINISH FLOOR.
  - 7. ELECTRICAL RECEPTACLES NEAR WET AREA TO BE GFCI OUTLETS.



12"x12" CERAMIC FLOOR

12"x12" CERAMIC FL TILES (BATHROOM)

PLYWOOD/SUBFLOOR

2 04/06/2023 100% SUBMISSION

1 09/24/2022 80% SUBMISSION

No. Date Revision

# AFRIDI ASSOCIATES

CONSULTING ENGINEERS

19 West 21st Street 510 Broadhollow Road Melville, NY 11747 New York, NY 10010 Tel: (212) 243-0725 Tel: (631) 465-0786 Fax: (631) 465-0788 Fax: (212) 243-0725

aafridi@afridiassociates.com

LONG ISLAND | NEW YORK CITY | CHARLOTTE | DANBURY

200 Old Country Road | Suite 670 Mineola | NY 11501 516 484 1020 Lizardos.com

Lizardos Engineering Associates D.P.C.

Designer:	AKBER AFRIDI, P.E.
Drawn by:	AZHER MALIK
Checked by:	AKBER AFRIDI, P.E.

INTERIOR RENOVATIONS OF ALUMNI VILLAGE APARTMENTS 10.1 (ADA COMPLIANT) & 10.3


735 Anderson Hill Road Purchase NY 10577


**ENLARGED BATHROOM PLANS APARTMENT 10.3** 


> Drawing No.: A204.00

> > Scale: AS NOTED

SU-040623

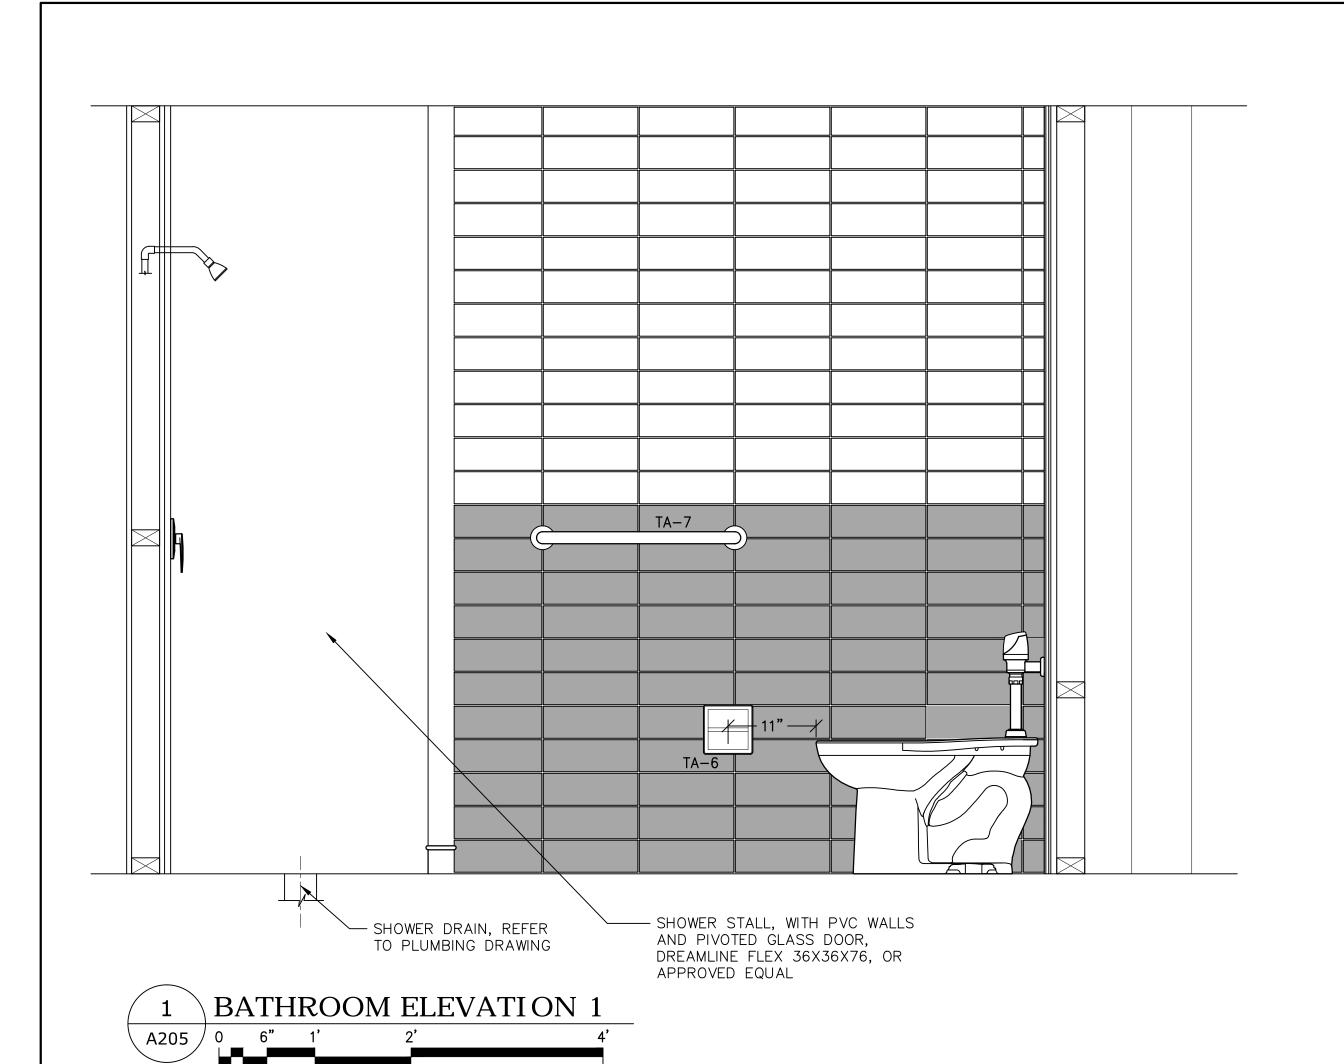


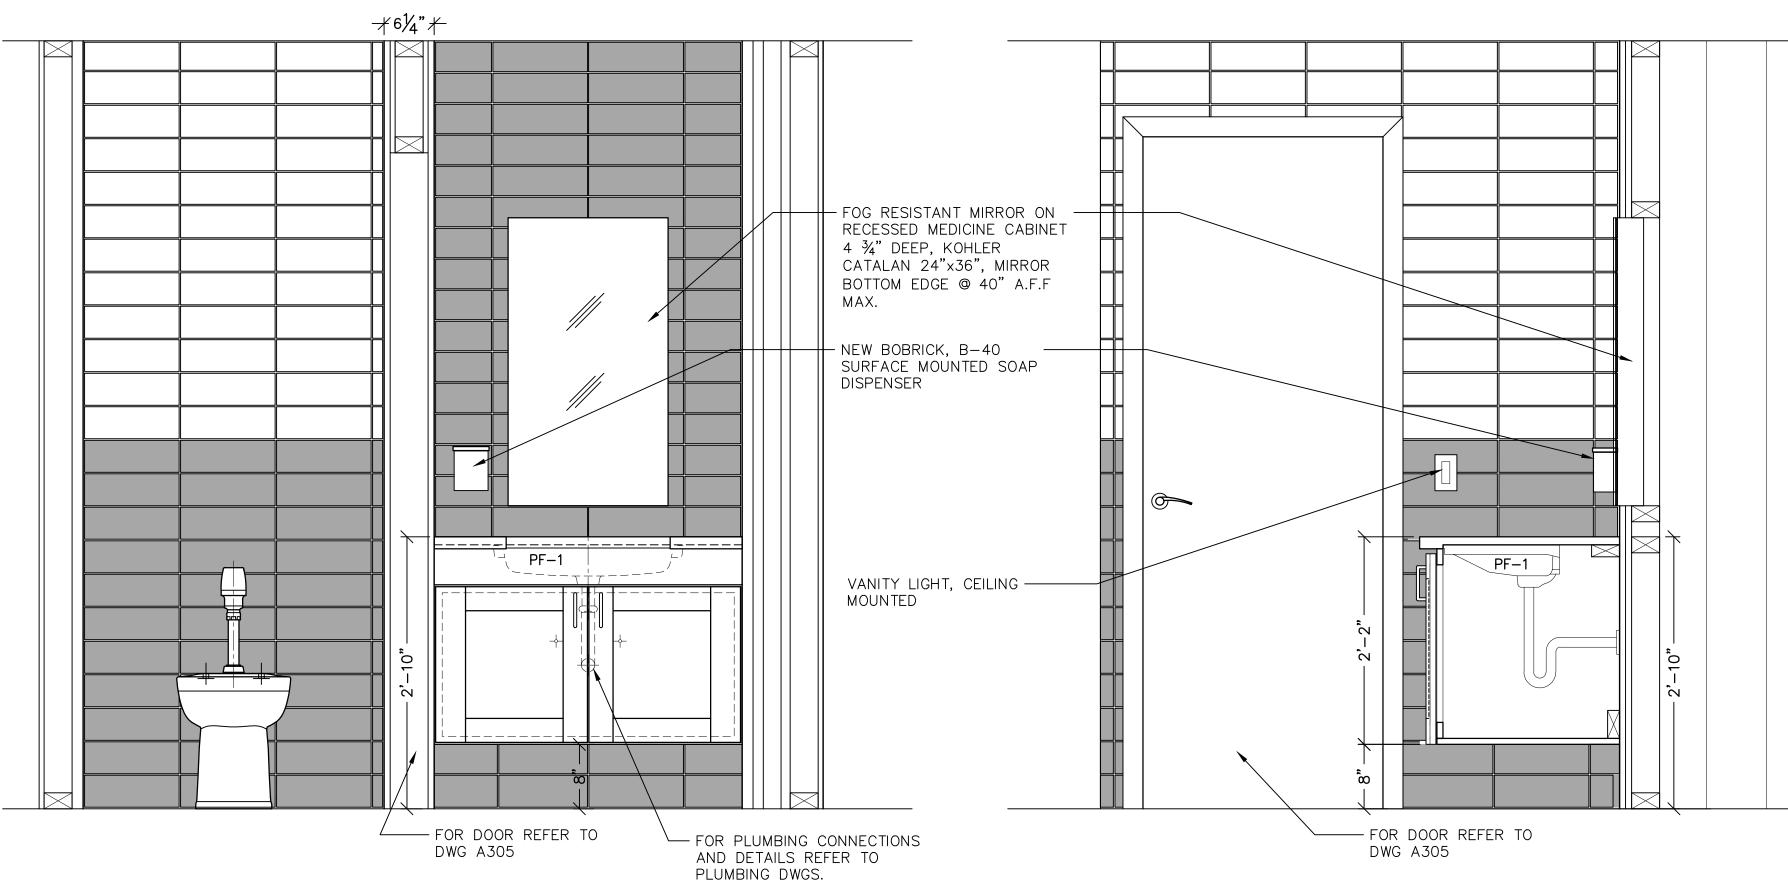


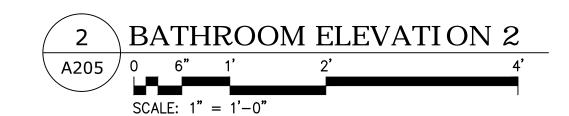

5 BATHROOM ELEVATION 6

SCALE:  $1" = \overline{1'-0"}$ 

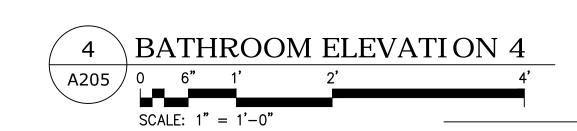


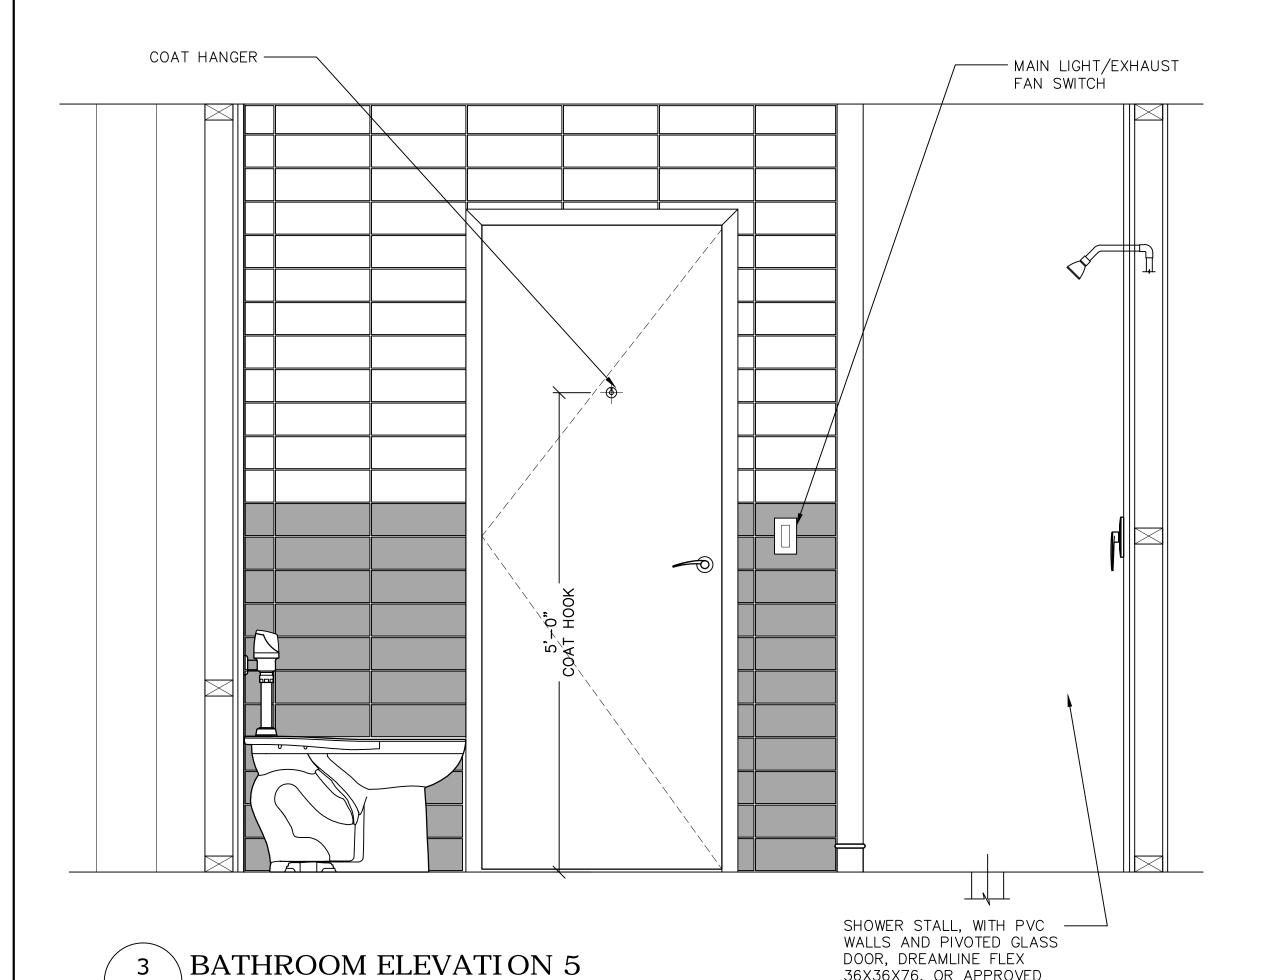


36X36X76, OR APPROVED EQUAL

SCALE: 1" = 1'-0"

SCALE: 1" = 1'-0"

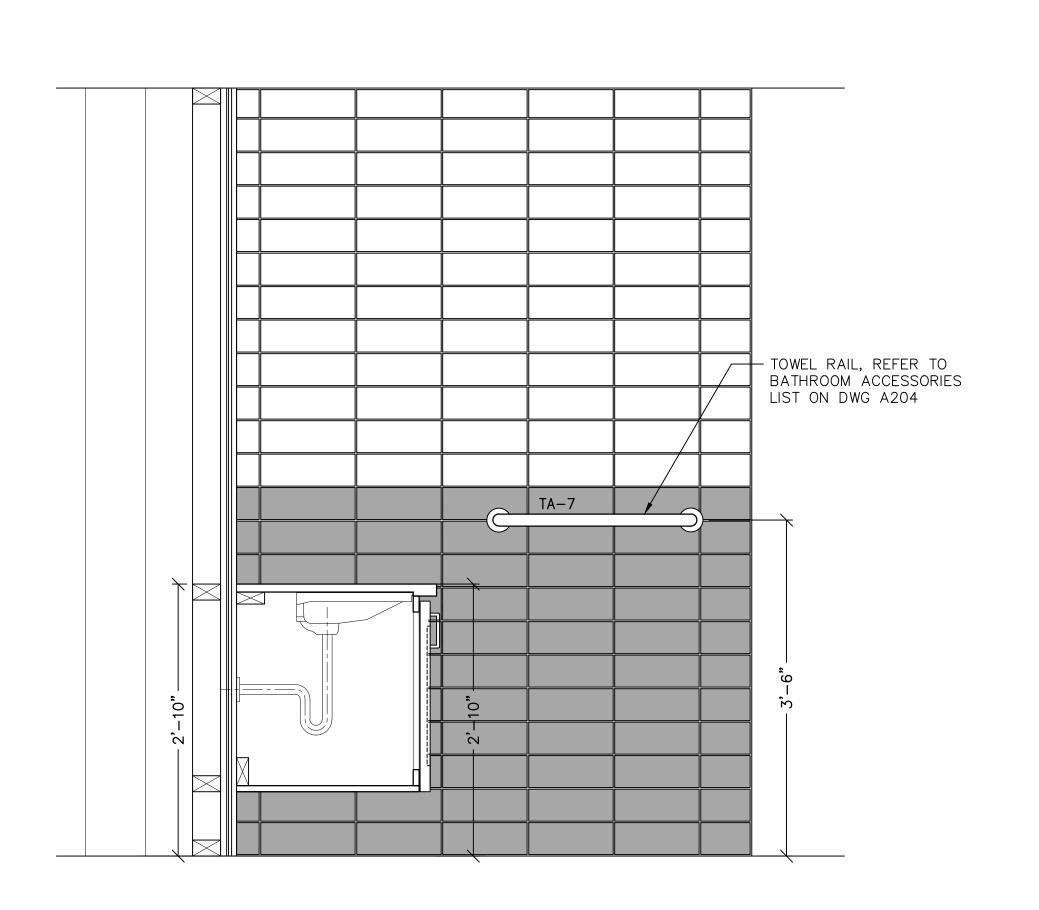

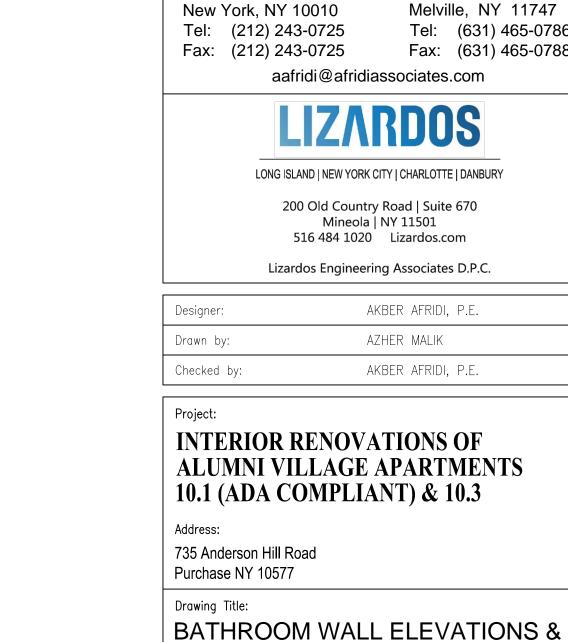

2 04/06/2023 100% SUBMISSION

1 09/24/2022 80% SUBMISSION

Revision

AFRIDI ASSOCIATES

CONSULTING ENGINEERS

510 Broadhollow Road

Melville, NY 11747

Tel: (631) 465-0786

Fax: (631) 465-0788


No. Date


19 West 21st Street


Drawing No.: A205.00 Scale: AS NOTED Date: 08/24/2020


FINISHES, APARTMENT 10.3

SU-040623

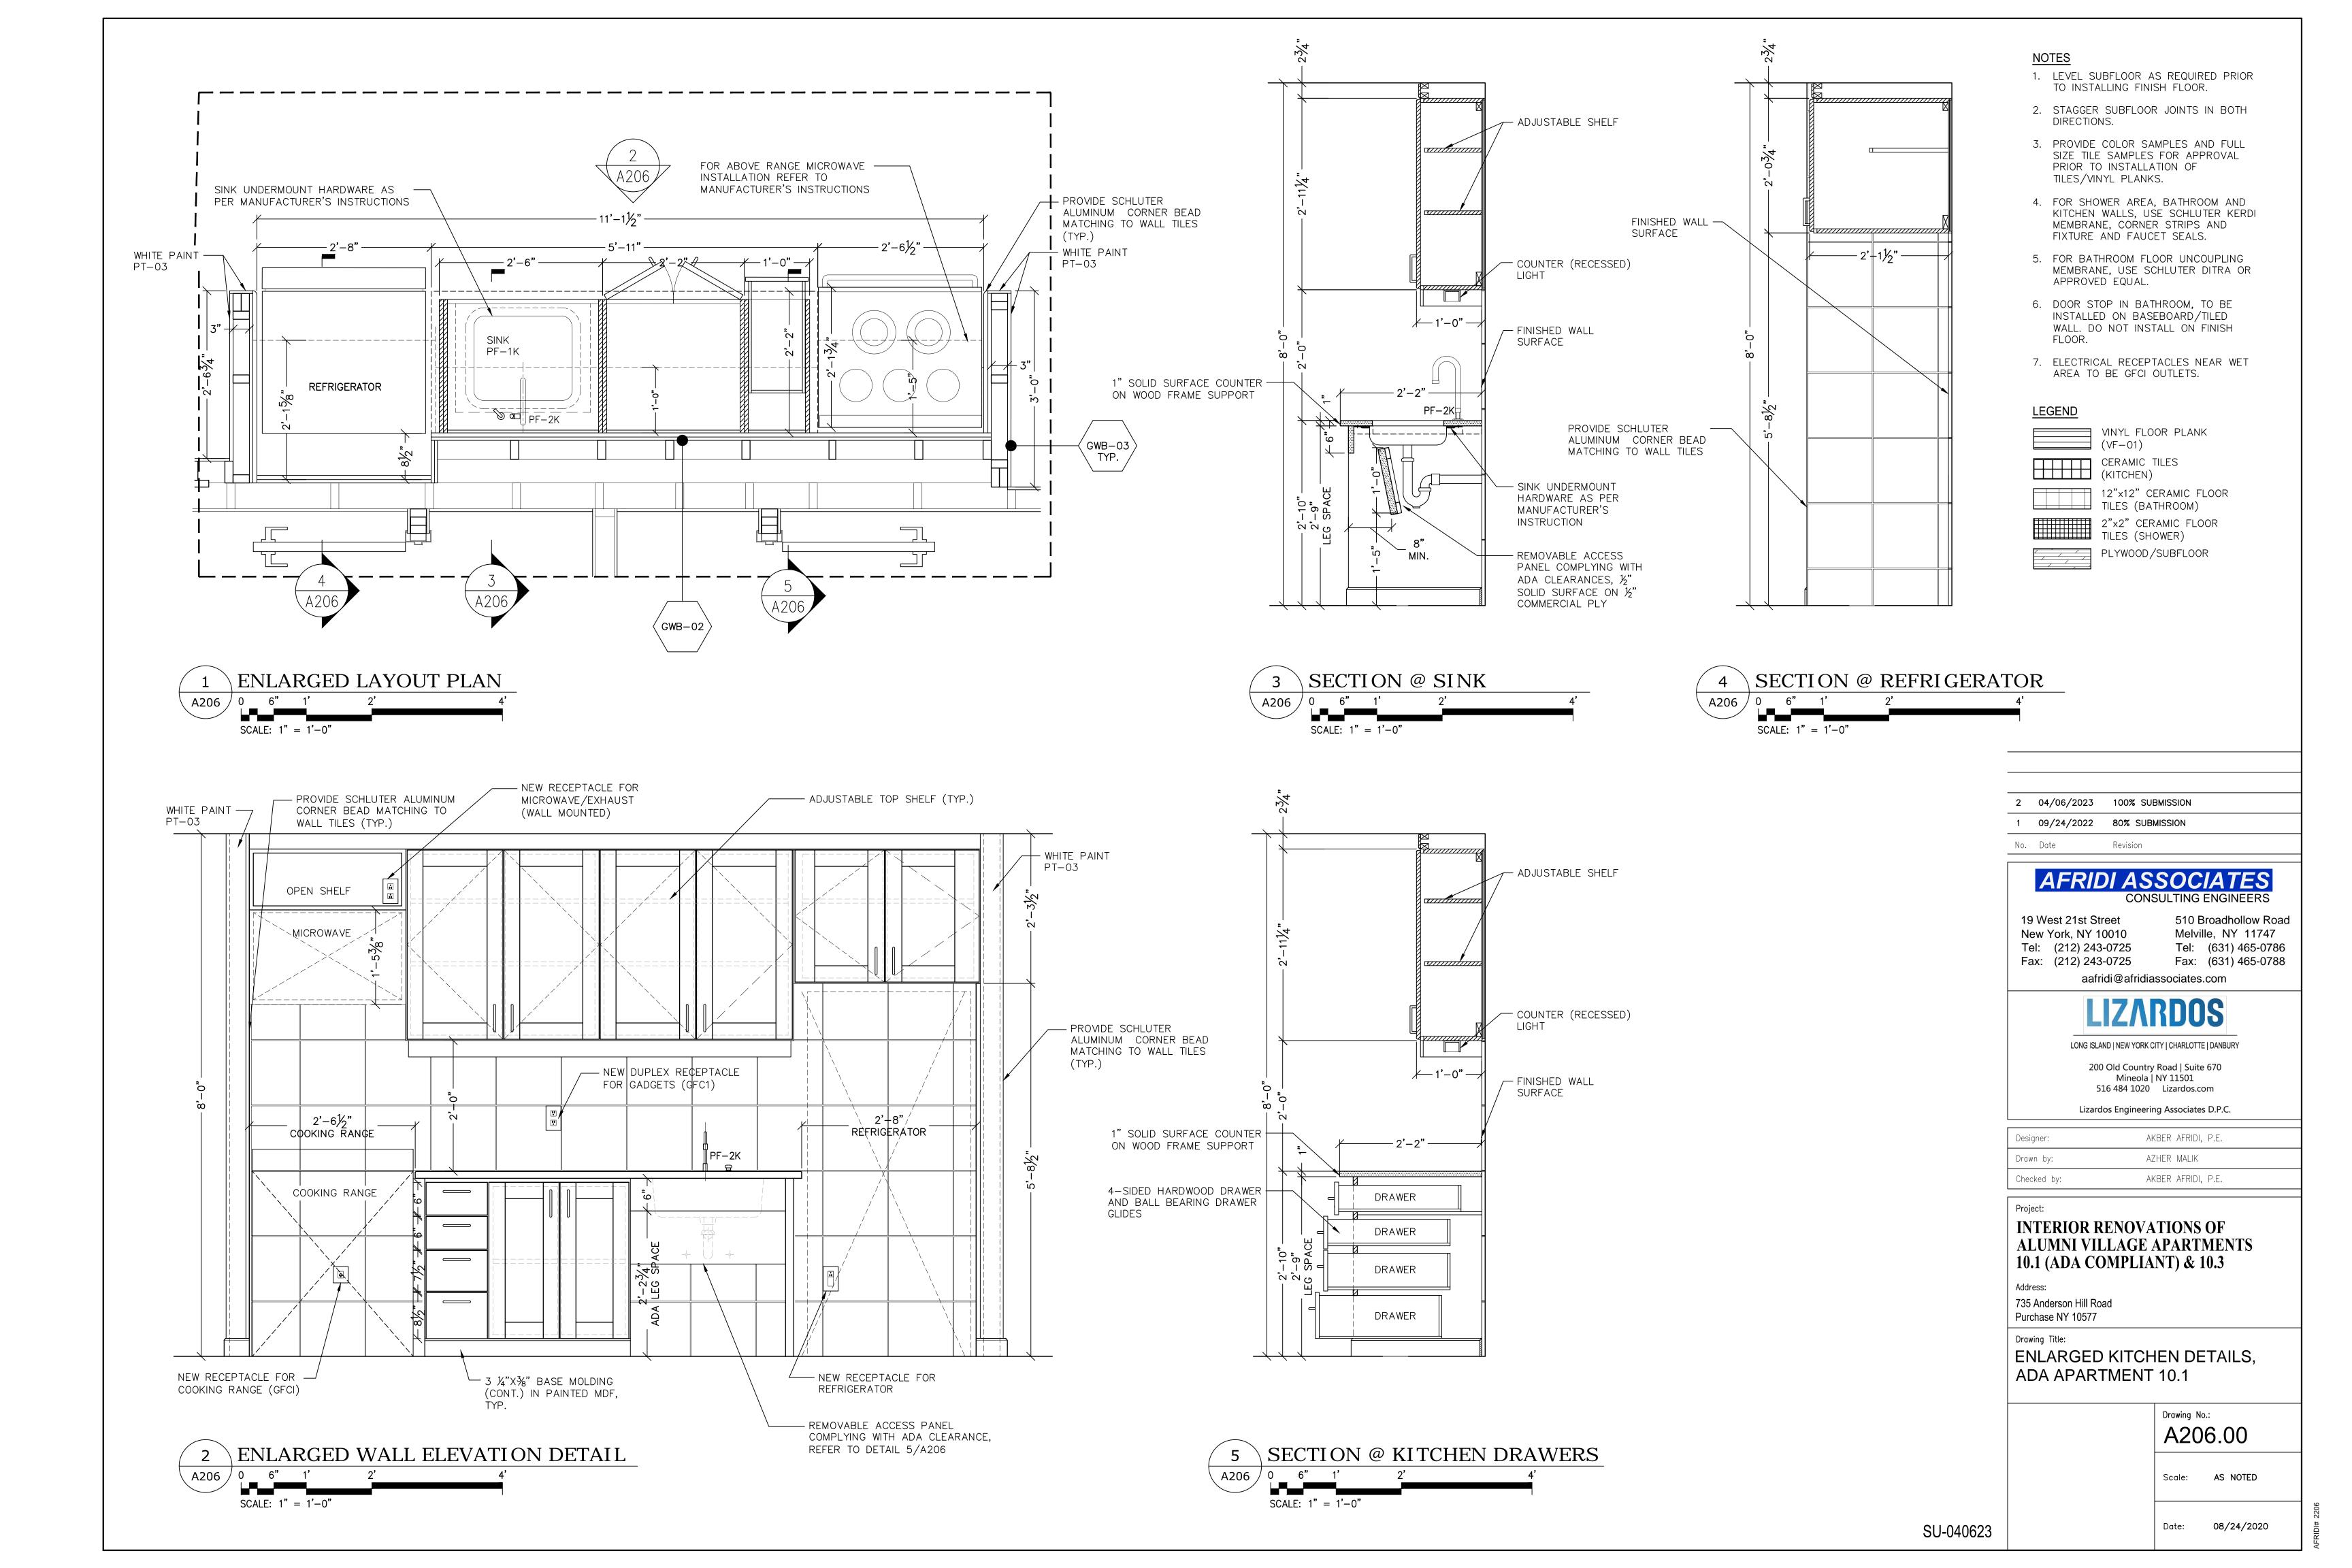


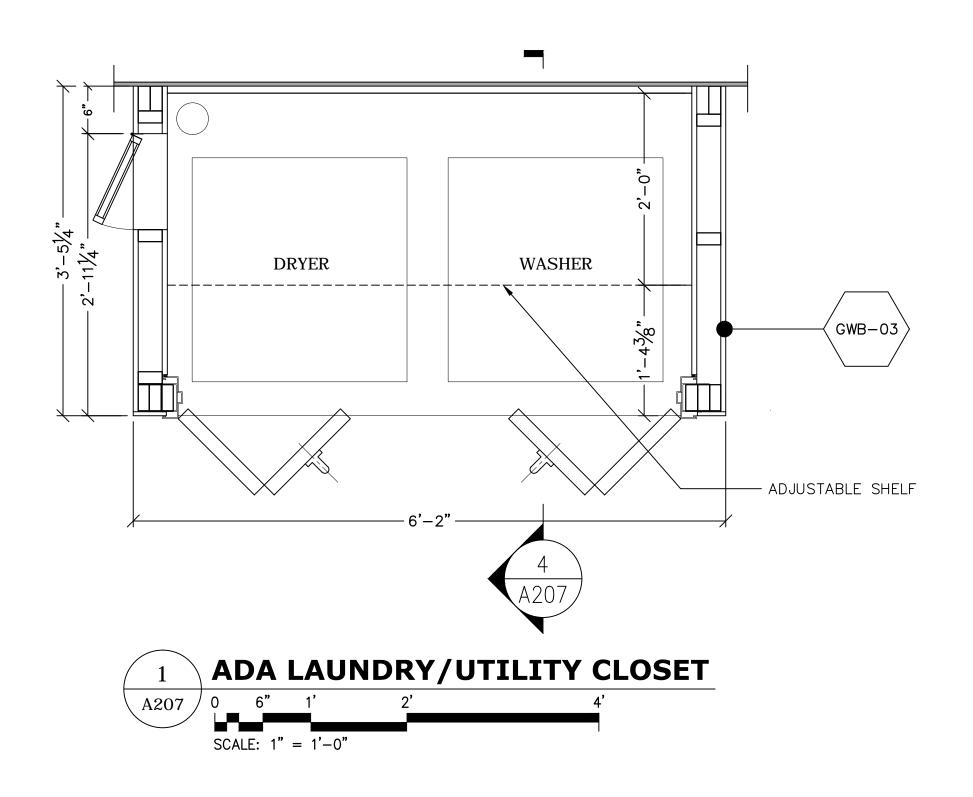

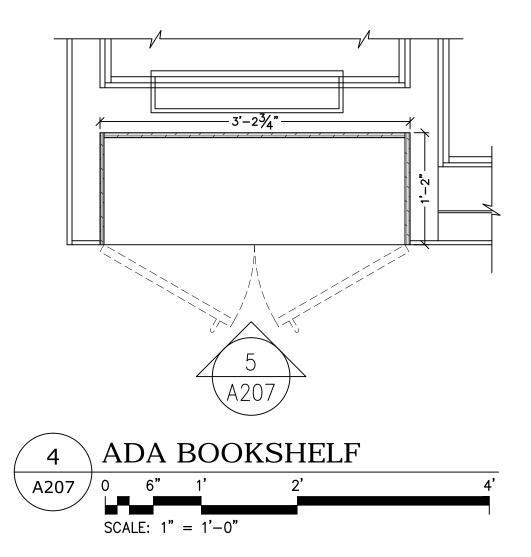


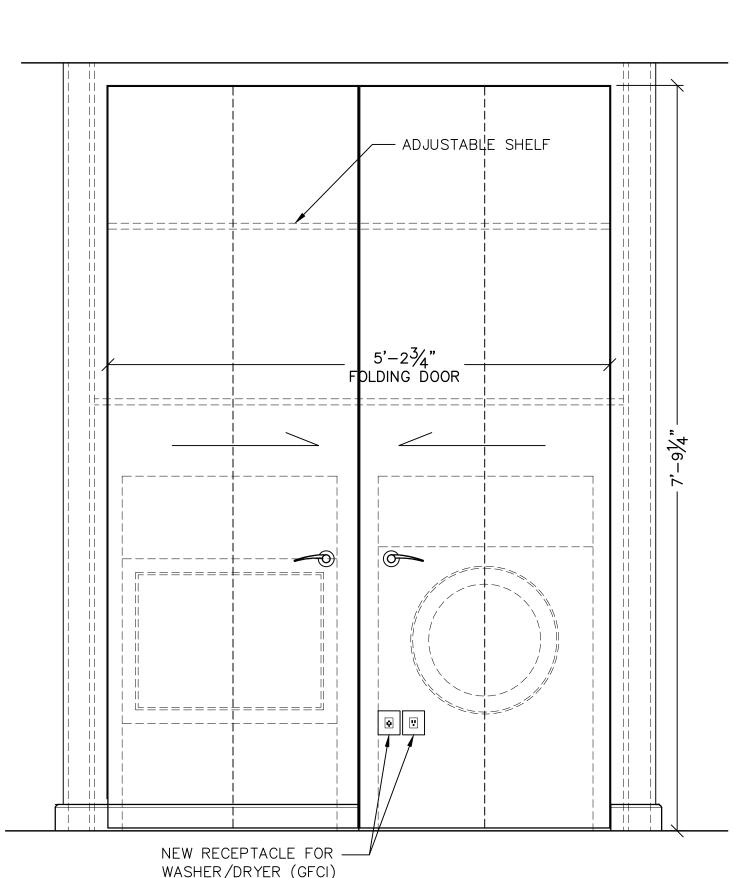



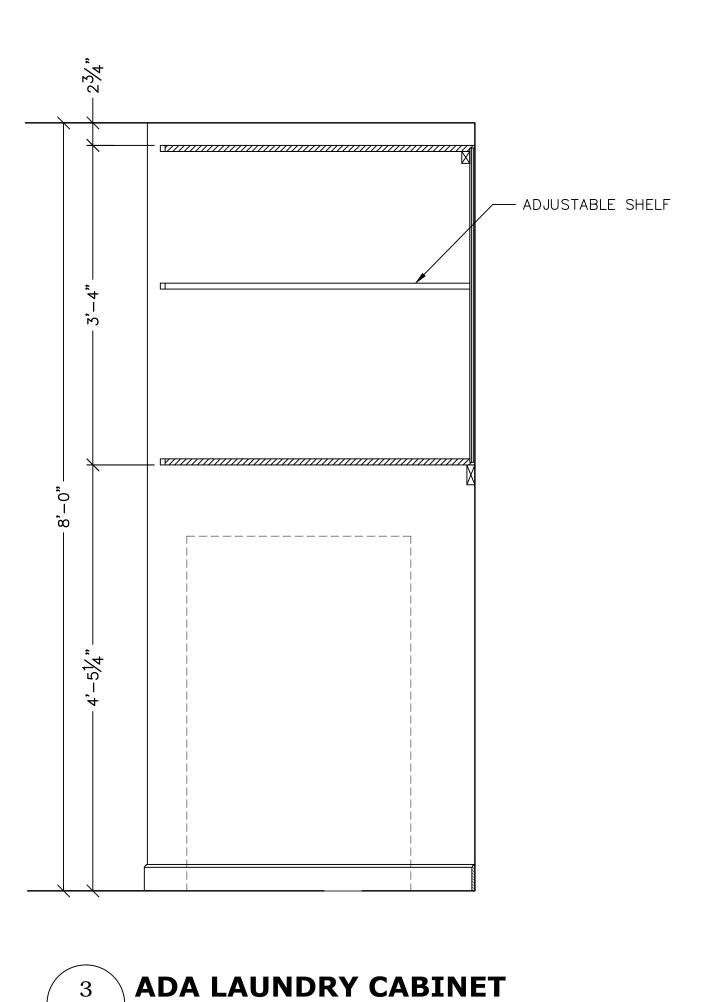

SCALE: 1" = 1'-0"

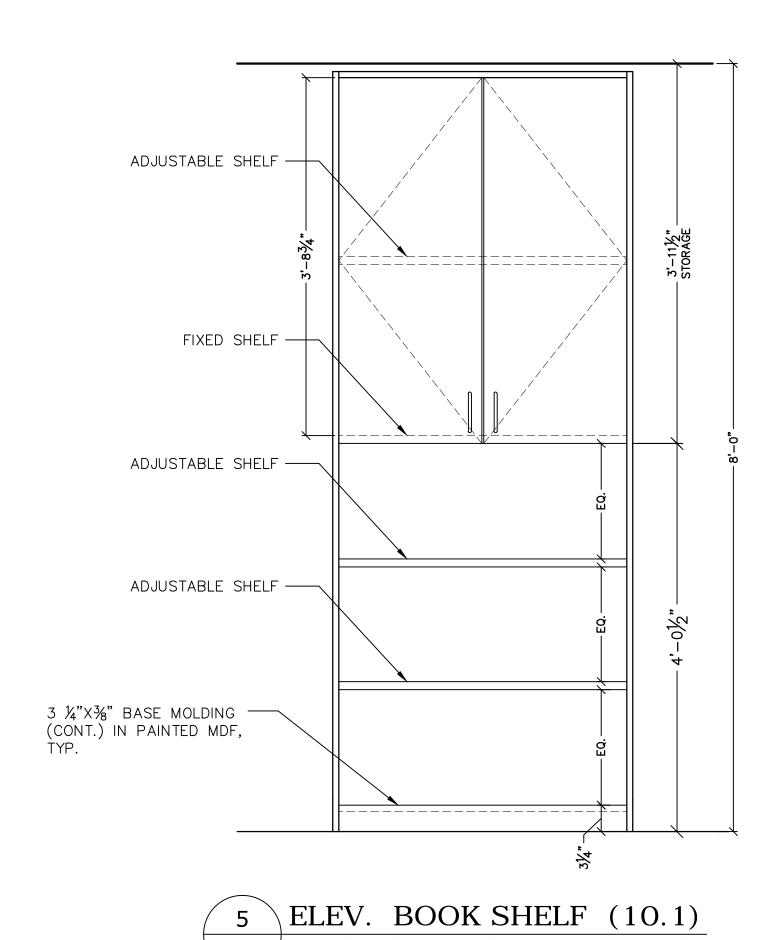

SCALE: 1" = 1'-0"

2 04/06/2023 100% SUBMISSION 1 09/24/2022 80% SUBMISSION

No. Date Revision

### AFRIDI ASSOCIATES

CONSULTING ENGINEERS

19 West 21st Street 510 Broadhollow Road New York, NY 10010 Melville, NY 11747 Tel: (212) 243-0725 Tel: (631) 465-0786

Tel: (212) 243-0725 Tel: (631) 465-0786 Fax: (212) 243-0725 Fax: (631) 465-0788

# aafridi@afridiassociates.com

LONG ISLAND | NEW YORK CITY | CHARLOTTE | DANBURY

200 Old Country Road | Suite 670 Mineola | NY 11501 516 484 1020 Lizardos.com

Lizardos Engineering Associates D.P.C.

Designer:	AKBER AFRIDI, P.E.
Drawn by:	AZHER MALIK
Checked by:	AKBER AFRIDI, P.E.

Project:
INTERIOR RENOVATIONS OF
ALUMNI VILLAGE APARTMENTS
10.1 (ADA COMPLIANT) & 10.3

Address: 735 Anderson Hill Road Purchase NY 10577

Drawing Title:


MILLWORK DETAILS

MILLWORK DETAILS ADA APARTMENT 10.1

Drawing No.:
A207.00

Scale: AS NOTED

SU-040623

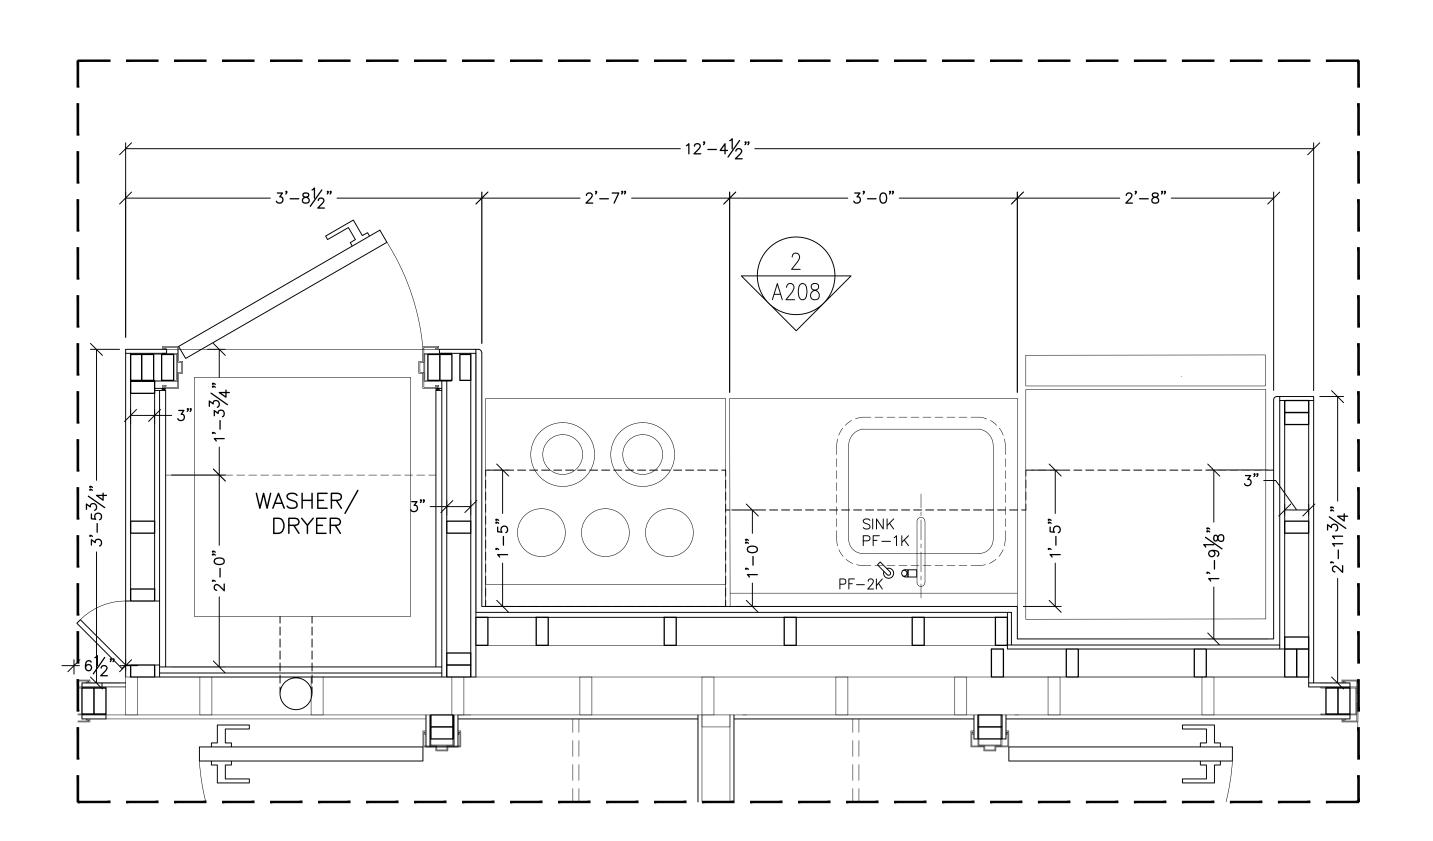


ENLARGED LAYOUT PLAN

ELEVATION - WALL/TILE DETAILS


 $A208 / 0 \underline{6}^{"} \underline{1}$ 

SCALE: 1" = 1'-0"


SCALE: 1" = 1'-0"

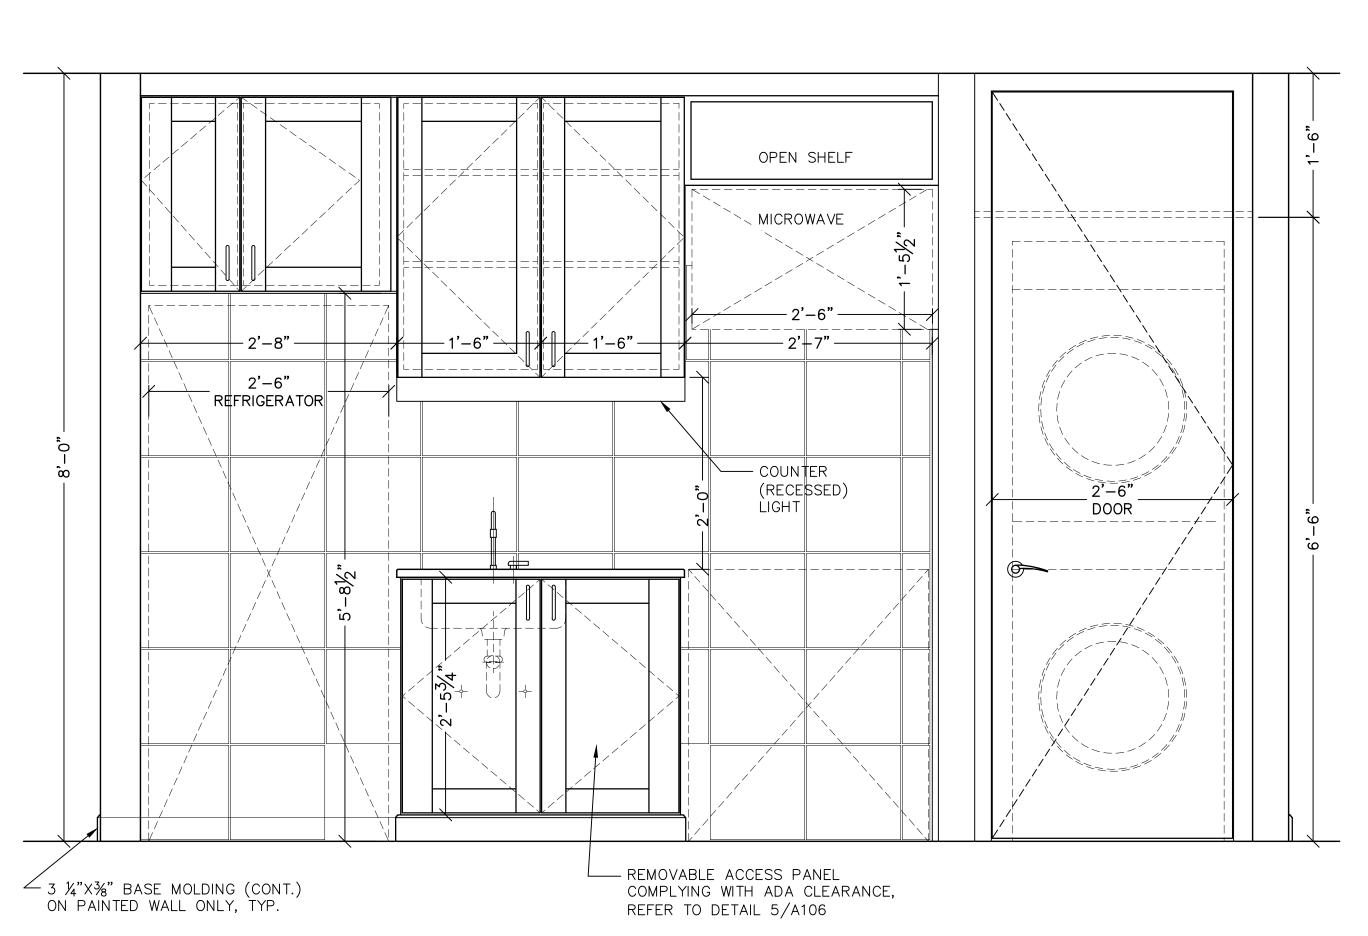



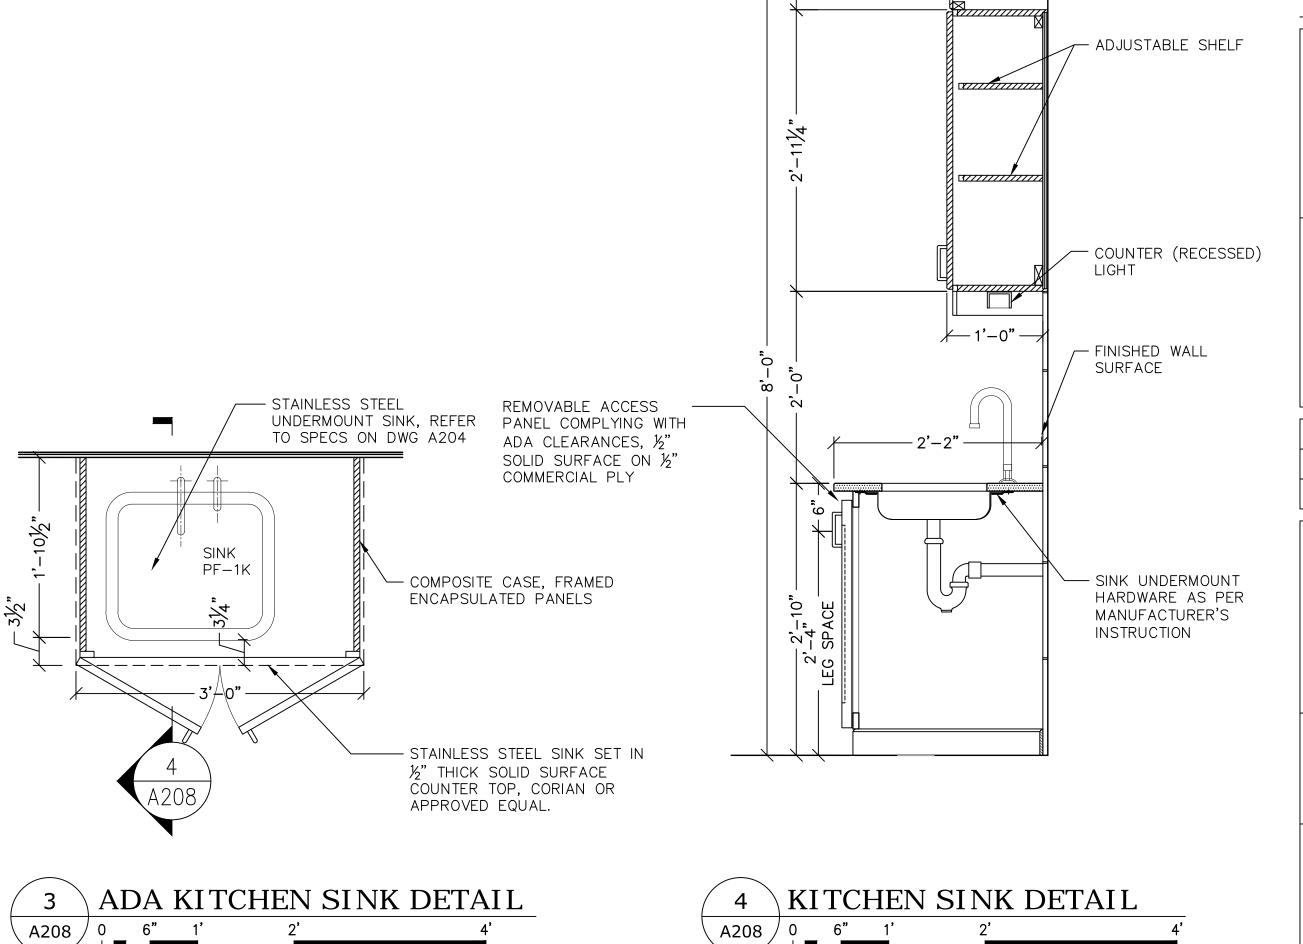

SCALE: 1" = 1'-0"

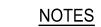

- 1. LEVEL SUBFLOOR AS REQUIRED PRIOR TO INSTALLING FINISH FLOOR.
- 2. STAGGER SUBFLOOR JOINTS IN BOTH DIRECTIONS.
- 3. PROVIDE COLOR SAMPLES AND FULL SIZE TILE SAMPLES FOR APPROVAL PRIOR TO INSTALLATION OF TILES/VINYL PLANKS.
- 4. FOR SHOWER AREA, BATHROOM AND KITCHEN WALLS, USE SCHLUTER KERDI MEMBRANE, CORNER STRIPS AND FIXTURE AND FAUCET SEALS.
- 5. FOR BATHROOM FLOOR UNCOUPLING MEMBRANE, USE SCHLUTER DITRA OR APPROVED EQUAL.
- 6. DOOR STOP IN BATHROOM, TO BE INSTALLED ON BASEBOARD/TILED WALL. DO NOT INSTALL ON FINISH FLOOR.
- 7. ELECTRICAL RECEPTACLES NEAR WET AREA TO BE GFCI OUTLETS.

### LEGEND



12"x12" CERAMIC FLOOR TILES (BATHROOM)

PLYWOOD/SUBFLOOR

2 04/06/2023 100% SUBMISSION

1 09/24/2022 80% SUBMISSION

No. Date Revision

# AFRIDI ASSOCIATES

**CONSULTING ENGINEERS** 19 West 21st Street 510 Broadhollow Road

New York, NY 10010 Melville, NY 11747 Tel: (212) 243-0725 Tel: (631) 465-0786 Fax: (212) 243-0725 Fax: (631) 465-0788

aafridi@afridiassociates.com

# **LIZARDOS**

LONG ISLAND | NEW YORK CITY | CHARLOTTE | DANBURY

200 Old Country Road | Suite 670 Mineola | NY 11501 516 484 1020 Lizardos.com

Lizardos Engineering Associates D.P.C.

	Designer:	AKBER AFRIDI, P.E.
	Drawn by:	AZHER MALIK
•	Checked by:	AKBER AFRIDI, P.E.

SU-040623

INTERIOR RENOVATIONS OF ALUMNI VILLAGE APARTMENTS 10.1 (ADA COMPLIANT) & 10.3

Address:

735 Anderson Hill Road Purchase NY 10577


Drawing Title: ENLARGED KITCHEN DETAILS, **APARTMENT 10.3** 

> Drawing No.: A208.00


> > Scale: AS NOTED

Date:


08/24/2020

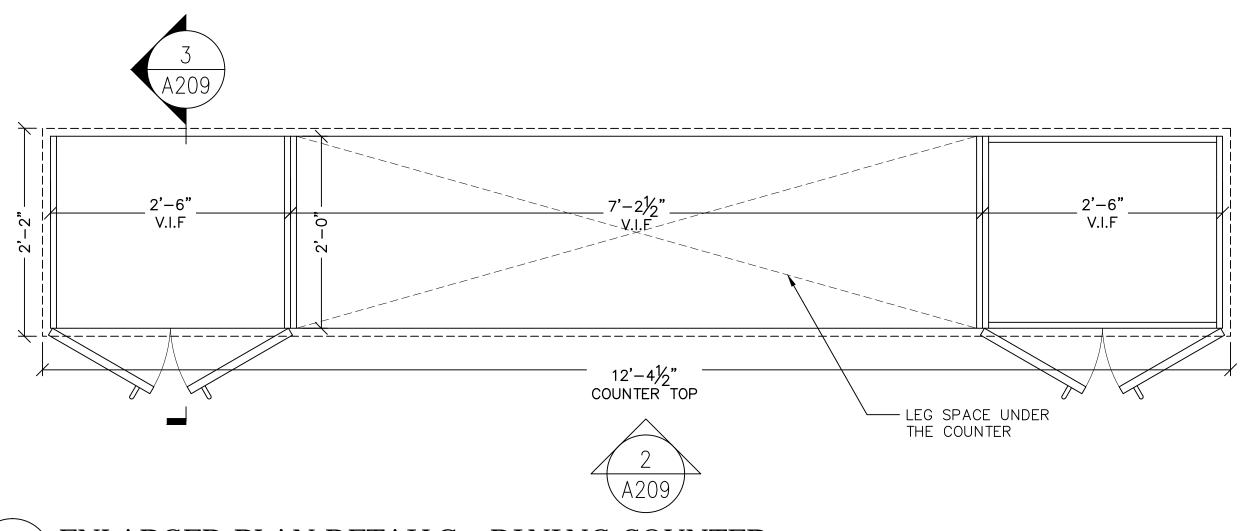


ENLARGED PLAN DETAILS - DINING COUNTER

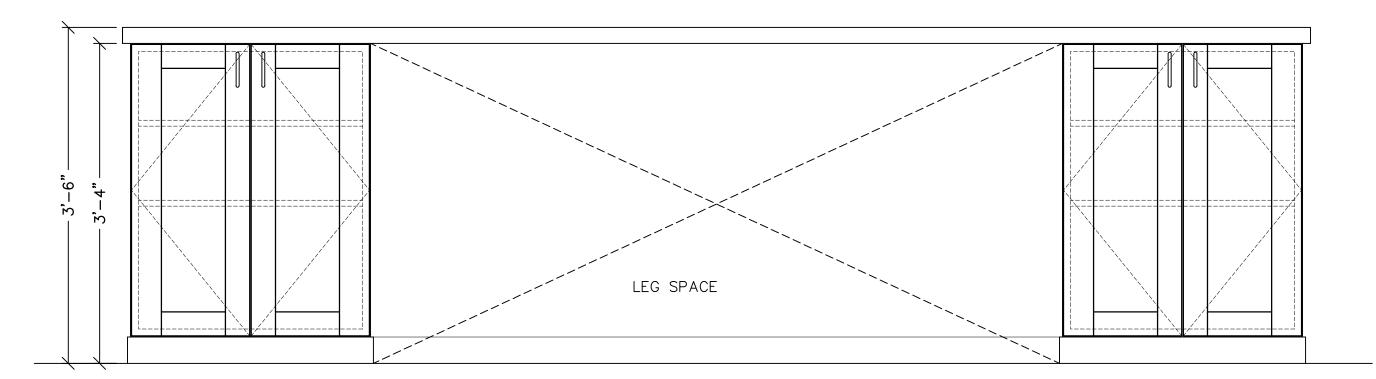

2 TYP. ELEVATION - DINING COUNTER / WALL CABINETS A209 0 6" 1'

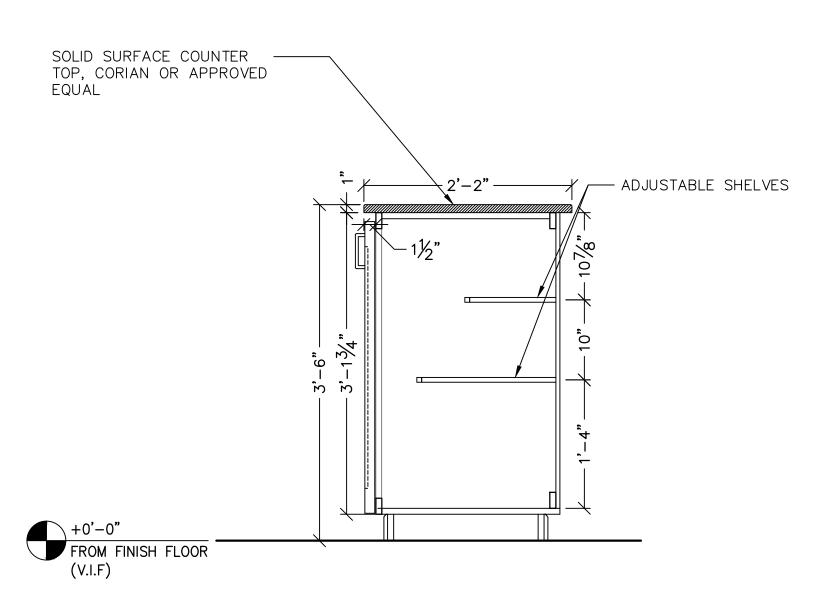

SCALE: 1" = 1'-0"

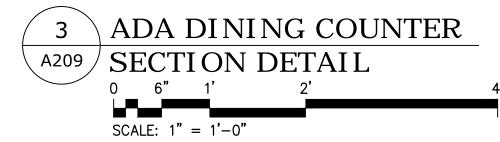

2 04/06/2023 100% SUBMISSION 1 09/24/2022 80% SUBMISSION

No. Date Revision

### AFRIDI ASSOCIATES CONSULTING ENGINEERS

510 Broadhollow Road 19 West 21st Street New York, NY 10010 Melville, NY 11747 Tel: (212) 243-0725 Tel: (631) 465-0786 Fax: (212) 243-0725

Fax: (631) 465-0788 aafridi@afridiassociates.com

# **LIZARDOS**

LONG ISLAND | NEW YORK CITY | CHARLOTTE | DANBURY

200 Old Country Road | Suite 670 Mineola | NY 11501 516 484 1020 Lizardos.com

Lizardos Engineering Associates D.P.C.

Designer:	AKBER AFRIDI, P.E.
Drawn by:	AZHER MALIK
Checked by:	AKBER AFRIDI, P.E.

INTERIOR RENOVATIONS OF ALUMNI VILLAGE APARTMENTS

10.1 (ADA COMPLIANT) & 10.3 Address: 735 Anderson Hill Road


Drawing Title: MILLWORK DETAILS **APARTMENT 10.3** 


Purchase NY 10577

Drawing No.: A209.00

Scale: AS NOTED

SU-040623

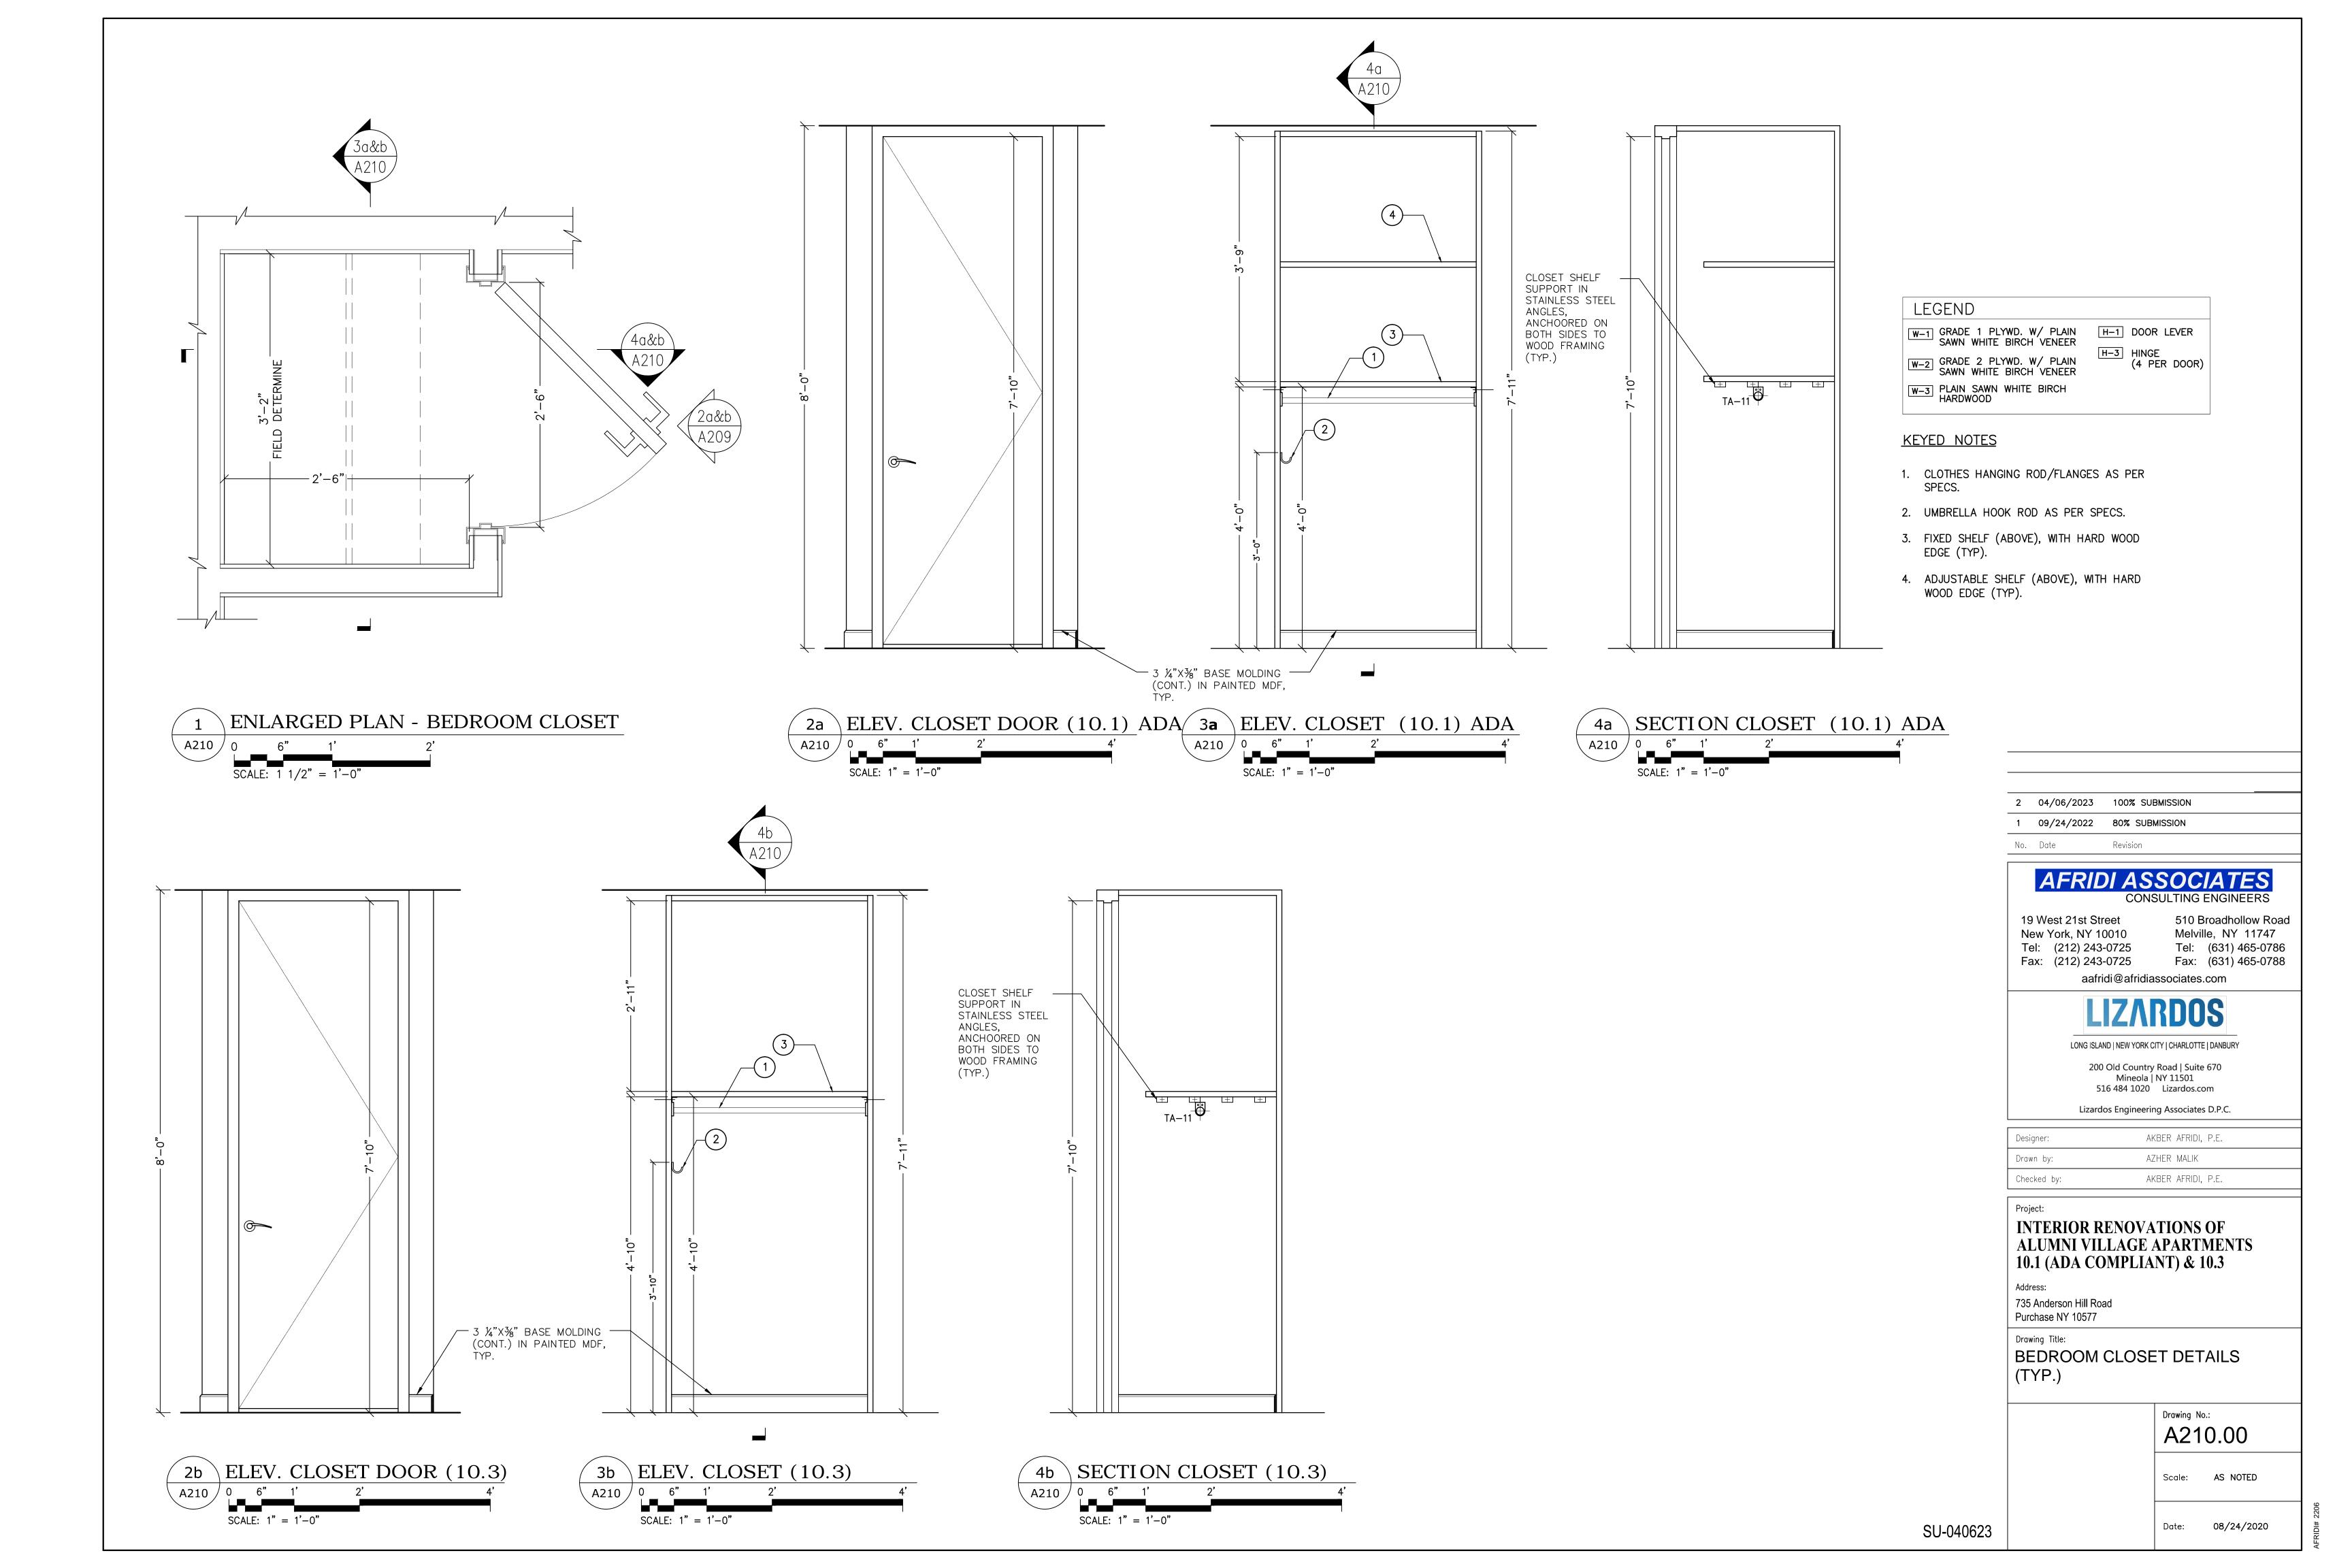

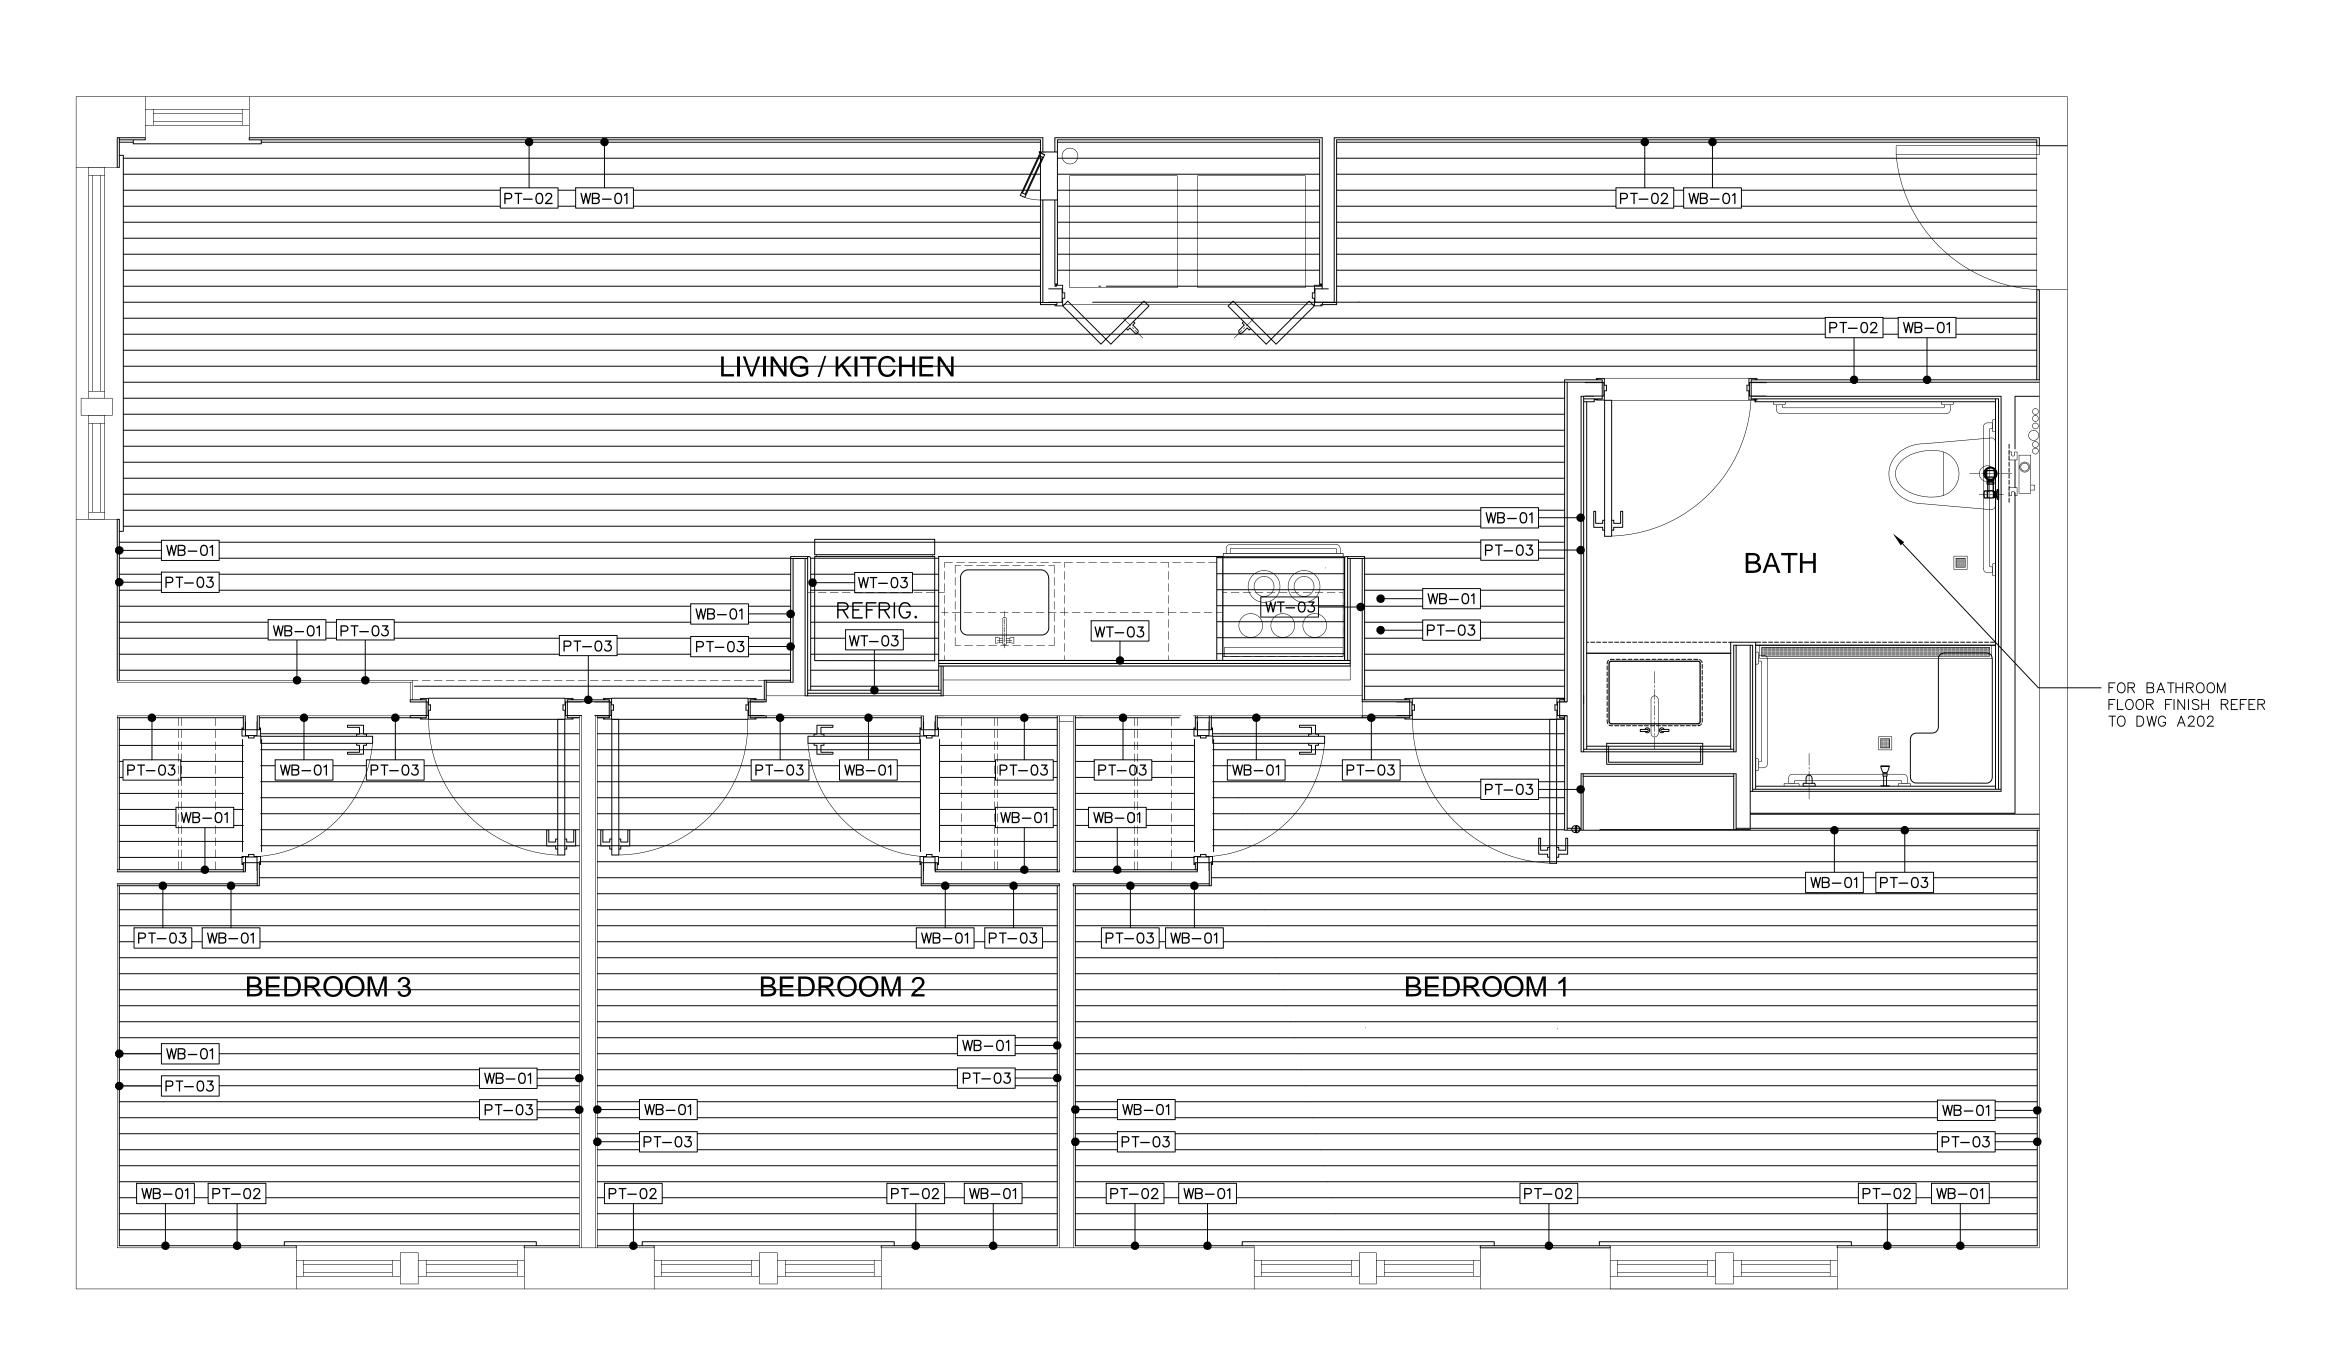



### <u>NOTES</u>

- LEVEL SUBFLOOR AS REQUIRED PRIOR TO INSTALLING FINISH FLOOR.
- 2. PROVIDE WATERPROOFING MEMBRANE UNDER NEW KITCHEN BASE CABINETS AND SINK AS PER VINYL PLANKING MANUFACTURER'S INSTRUCTIONS.
- 3. PROVIDE COLOR SAMPLES AND FULL SIZE TILE SAMPLES FOR APPROVAL PRIOR TO INSTALLATION.
- 4. USE VNYL FLOOR MANUFACTURER'S INSTRUCTION FOR INSTALLING UNDERLAYMENT.
- 5. ALL DOOR STOPS TO BE INSTALLED ON BASEBOARD/TILED WALL. DO NOT INSTALL ON FINISH FLOOR.
- 6. ELECTRICAL RECEPTACLES NEAR WET AREA TO BE GFCI OUTLETS.

2	04/06/2023	100% SUBMISSION
1	09/24/2022	80% SUBMISSION
No.	Date	Revision

## AFRIDI ASSOCIATES

CONSULTING ENGINEERS

19 West 21st Street 510 Broadhollow Road New York, NY 10010 Melville, NY 11747 Tel: (212) 243-0725 Fax: (212) 243-0725 Fax: (631) 465-0788

aafridi@afridiassociates.com

# LIZARDOS

LONG ISLAND | NEW YORK CITY | CHARLOTTE | DANBURY

200 Old Country Road | Suite 670 Mineola | NY 11501 516 484 1020 Lizardos.com

Lizardos Engineering Associates D.P.C.

Designer:	AKBER AFRIDI, P.E.
Drawn by:	AZHER MALIK
Checked by:	AKBER AFRIDI, P.E.

## Project:

INTERIOR RENOVATIONS OF ALUMNI VILLAGE APARTMENTS 10.1 (ADA COMPLIANT) & 10.3

Address: 735 Anderson Hill Road Purchase NY 10577

Drawing Title:
FINISHES PLAN (FLOOR & WALL)
ADA APARTMENT 10.1

Drawing No.:
A301.00

Scale: AS NOTED


23


Date: 08/24/2020

# 1 FINISH PLAN A301 0 1' 2' 4' 8' SCALE: 1/2" = 1'-0"

FINISH SCHEDULE						
FIN. TAG	FIN. DESCRIPTION	MANUFACTURER	FIN. SPECS	NOTES		
TILE FINIS	Н			•		
FT-01	CERAMIC FLOOR TILE	DALTILE	12"x12", COLOR TBD	BATHROOM FLOOR		
FT-02	CERAMIC FLOOR TILE (SHOWER AREA)	DALTILE	(2"x2" MOSAIC) CERMIC, MATT FINISH, COLOR CODE D617	SHOWER AREA		
WT-03	GLAZED CERAMIC WALL TILE	DALTILE	12"x12", WHITE	KITCHEN WALLS		
WT-03	GLAZED CERAMIC WALL TILE	DALTILE	4"x12", VITRUVIAN LIGHT GREY GLOSSY	BATHROOM WALLS		
WT-04	GLAZED CERAMIC WALL TILE	DALTILE	4"x12", MOD WALL GLOSSY ARCTIC WHITE 0190	BATHROOM WALLS		

VINYL FLOOR PLANKING							
VF-01	VF-01 VINYL LIFEPROOF		8.7" W BURNT OAK CLICK LOCK, LUXURY VINYL PLANK FLOORING	LIVING AREA/ FOYER BEDROOMS			
WALL BASE							
WB-01	WOOD (PRIMED)	WOODGRAIN MILLWORK	%6" x 4 ¼" x 96" LATEX PAINT, MATCHING TO PT-01	FOYER, LIVING AREA, BEDROOM, KITCHEN (SIDE WALLS), LAUNDRY			
PAINT							
PT-01	WHITE	BENJAMIN MOORE	COLOR: SUPER WHITE, OC-152 FINISH: EGGSHELL	TRIM, DOORS, CEILING REFER TO FLOOR PLAN			
PT-02	LIGHT GREY	BENJAMIN MOORE	COLOR: COVENTRY GRAY, HC-169 FINISH: SATIN	ACCENT WALL REFER TO FLOOR PLAN			
PT-03	WHITE	BENJAMIN MOORE	COLOR: DECORATOR'S WHITE, OC-149 FINISH: EGGSHELL	LIVING AREA, BEDROOM			

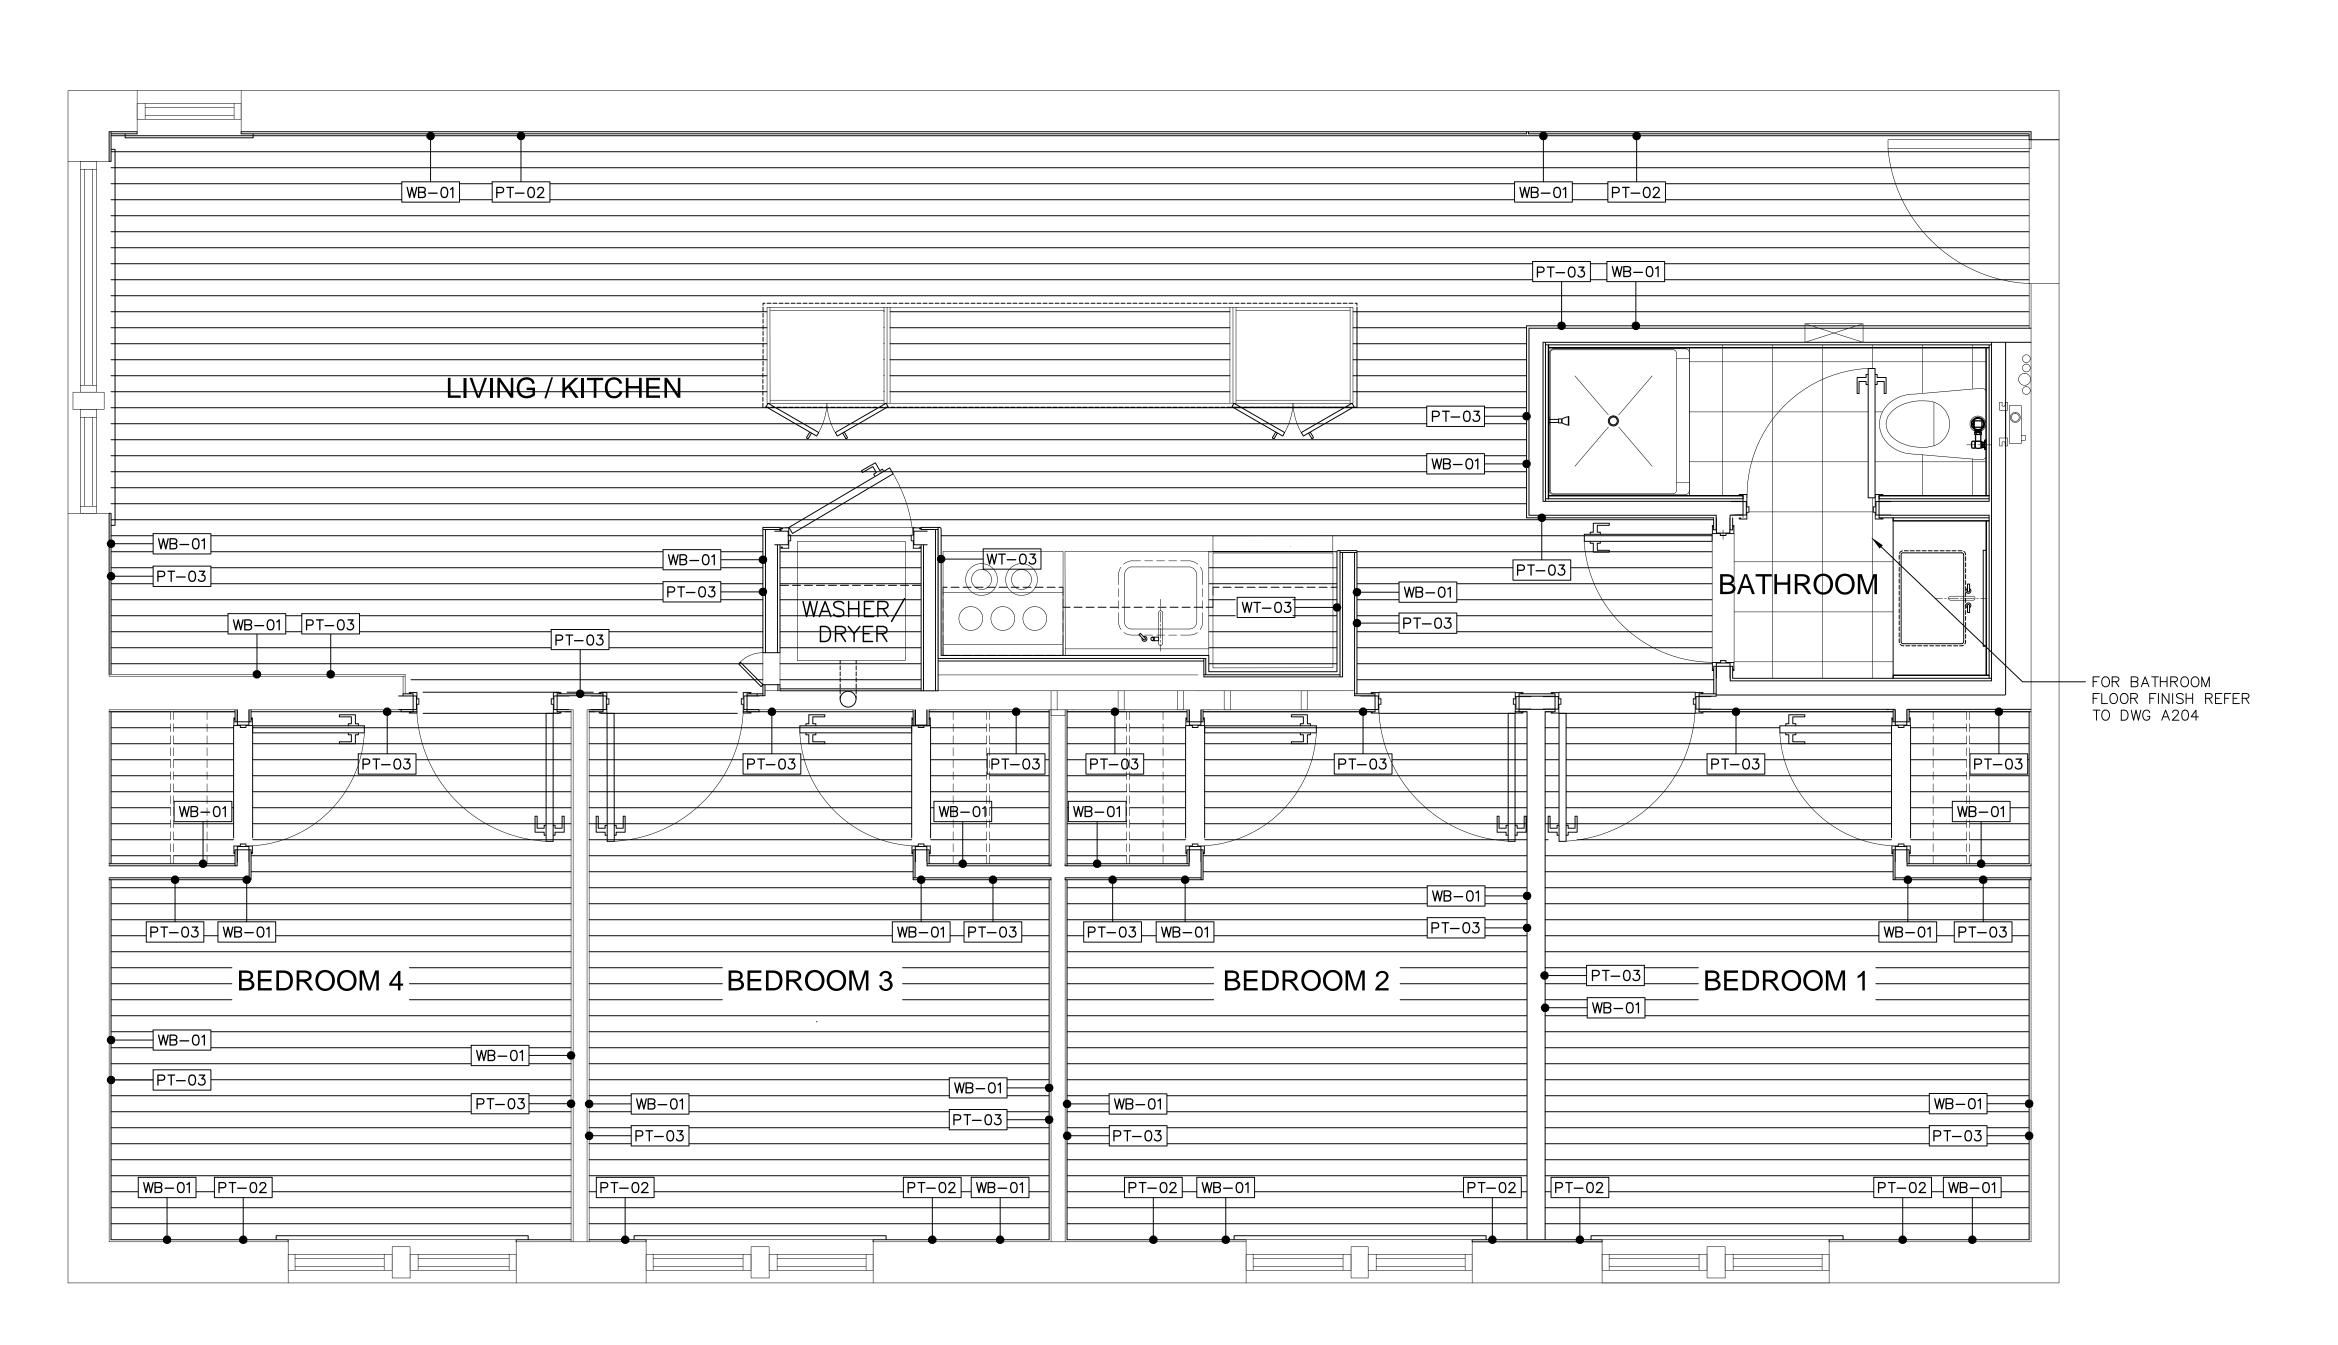

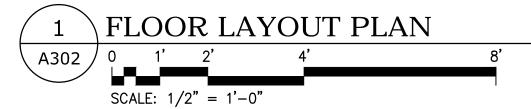

FINISH SC	FINISH SCHEDULE						
FIN. TAG	FIN. TAG FIN. DESCRIPTION MANUFACTURER		FIN. SPECS	NOTES			
TILE FINIS	Н						
FT-01	CERAMIC FLOOR TILE	DALTILE	12"x12", COLOR TO BE DECIDED	BATHROOM FLOOR			
FT-02	_	_	_	_			
WT-03	GLAZED CERAMIC WALL TILE	DALTILE	12"x12", WHITE	KITCHEN WALLS			
WT-03	GLAZED CERAMIC WALL TILE	DALTILE	4"x12", VITRUVIAN LIGHT GREY GLOSSY	BATHROOM WALLS			
WT-04	GLAZED CERAMIC WALL TILE	DALTILE	4"x12", MOD WALL GLOSSY ARCTIC WHITE 0190	BATHROOM WALLS			

VINYL FLOOR PLANKING						
VF-01	VINYL	LIFEPROOF	8.7" W BURNT OAK CLICK LOCK, LUXURY VINYL PLANK FLOORING	LIVING AREA/ FOYER BEDROOMS		
WALL BAS	SE					
WB-01	WOOD (PRIMED)	WOODGRAIN MILLWORK	%6" × 4 ¼" × 96" LATEX PAINT, MATCHING TO PT−01	FOYER, LIVING AREA, BEDROOM, KITCHEN (SIDE WALLS)		
PAINT						
PT-01	WHITE	BENJAMIN MOORE	COLOR: SUPER WHITE, OC-152 FINISH: EGGSHELL	TRIM, DOORS, CEILING REFER TO FLOOR PLAN		
PT-02	LIGHT GREY	BENJAMIN MOORE	COLOR: COVENTRY GRAY, HC-169 FINISH: SATIN	ACCENT WALL REFER TO FLOOR PLAN		
PT-03	WHITE	BENJAMIN MOORE	COLOR: DECORATOR'S WHITE, OC-149 FINISH: EGGSHELL	LIVING AREA, BEDROOM		

### <u>LEGEND</u>

VINYL FLOOR PLANK (VF-01)CERAMIC TILES (KITCHEN)

PLYWOOD/SUBFLOOR

12"x12" CERAMIC FLOOR TILES (BATHROOM) ☐ 2"x2" CERAMIC FLOOR TILES (SHOWER)

AND SINK AS PER VINYL PLANKING MANUFACTURER'S INSTRUCTIONS. 3. PROVIDE COLOR SAMPLES AND FULL SIZE TILE SAMPLES FOR APPROVAL PRIOR TO INSTALLATION.

<u>NOTES</u>

- 4. USE VNYL FLOOR MANUFACTURER'S INSTRUCTION FOR INSTALLING UNDERLAYMENT.
- 5. ALL DOOR STOPS TO BE INSTALLED ON BASEBOARD/TILED WALL. DO NOT INSTALL ON FINISH FLOOR.

1. LEVEL SUBFLOOR AS REQUIRED PRIOR

2. PROVIDE WATERPROOFING MEMBRANE UNDER NEW KITCHEN BASE CABINETS

TO INSTALLING FINISH FLOOR.

6. ELECTRICAL RECEPTACLES NEAR WET AREA TO BE GFCI OUTLETS.

2 04/06/2023 100% SUBMISSION 1 09/24/2022 80% SUBMISSION

No. Date Revision

# AFRIDI ASSOCIATES

CONSULTING ENGINEERS 19 West 21st Street 510 Broadhollow Road

New York, NY 10010 Melville, NY 11747 Tel: (212) 243-0725 Tel: (631) 465-0786 Fax: (212) 243-0725 Fax: (631) 465-0788

aafridi@afridiassociates.com

# **LIZARDOS**

LONG ISLAND | NEW YORK CITY | CHARLOTTE | DANBURY

200 Old Country Road | Suite 670 Mineola | NY 11501 516 484 1020 Lizardos.com

Lizardos Engineering Associates D.P.C.

Designer:	AKBER AFRIDI, P.E.
Drawn by:	AZHER MALIK
Checked by:	AKBER AFRIDI, P.E.

### INTERIOR RENOVATIONS OF ALUMNI VILLAGE APARTMENTS 10.1 (ADA COMPLIANT) & 10.3


Address: 735 Anderson Hill Road Purchase NY 10577

Drawing Title: FINISHES PLAN (FLOOR & WALL) **APARTMENT 10.3** 

> Drawing No.: A302.00

> > Scale: AS NOTED

SU-040623

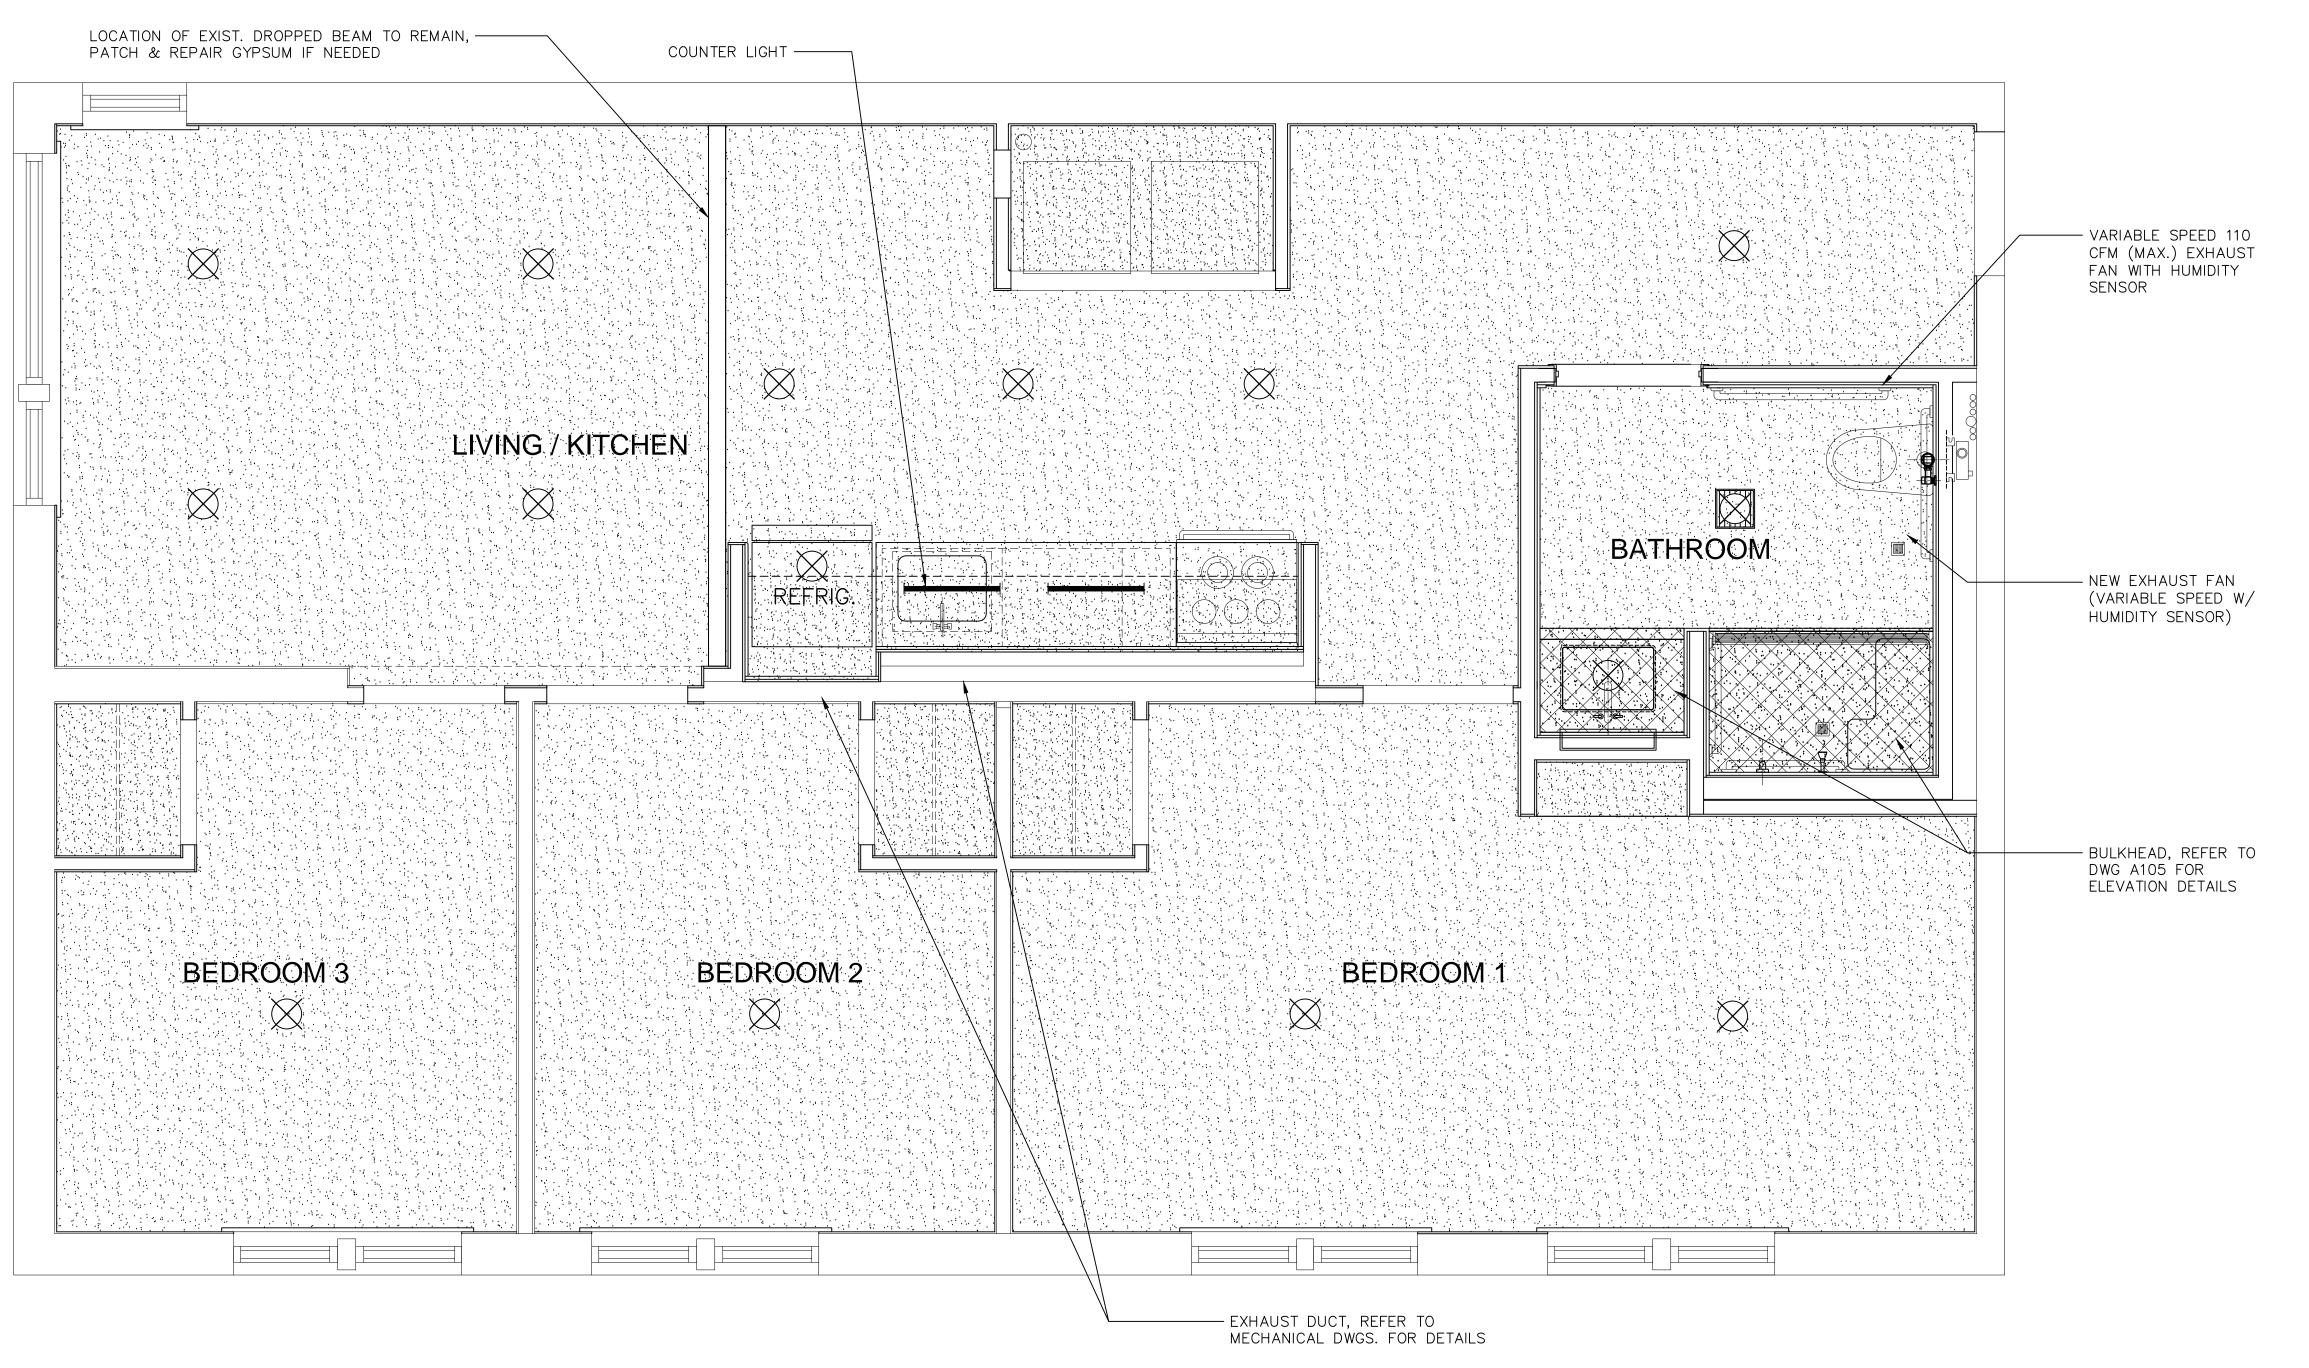

FINISH SCHEDULE

**CEILING FINISH** 

FIN. DESCRIPTION

GYPSUM WALL BOARD CEILING

WONDERBOARD LITE, BACKER

BOARD OR APPROVED EQUAL.

GOLD BOND, PURPLE XP MOLD

& MOISTURE RESISTANT

DRYWALL

MANUFACTURER

USG

CUSTOM BUILDING

PRODUCTS

GOLD BOND BUILDING

PRODUCTS

FIN. SPECS

%" GYPSUM WALL BOARD WITH USG

DRYWALL SUSPENSION SYSTEM OR LIGHT

GAUGE FRAMING AT SOFFITS, FINISH AS NOTED

7/6" WONDERBOARD LITE OR APPROVED

½" GOLD BOND, PURPLE XP MOLD &

FRAMING, AS SHOWN IN DRAWING.

MOISTURE RESISTANT DRYWALL ON WOOD

KITCHEN WALLS

EQUAL, BACKER BOARD FOR BATHROOM AND

FIN. TAG

GWB-01

GWB-03

REFLECTED CEILING PLAN

A303

SCALE: 1/2" = 1'-0"

### LEGEND



SHEETROCK (MOISTURE RESISTANT)



GWB-02WET AREA



CEILING MOUNTED LUMINAIRE



NOTES

BATHROOM CEILING, SINK AND SHOWER AREA

FOR EXISTING DRYWALL REPAIR AND NEW

WALLS IN FOYER, LIVING AREA, BEDROOM

FOYER, LIVING AREA, BEDROOM

REFER TO CEILING PLAN

SOFFIT, KITCHEN SOFFIT

REFER TO CEILING PLAN

CEILING MOUNTED EXHAUST FAN (15"x15")

W/ LIGHT & HUMIDITY SENSOR

2 04/06/2023 100% SUBMISSION 1 09/24/2022 80% SUBMISSION

No. Date Revision

### AFRIDI ASSOCIATES **CONSULTING ENGINEERS**

19 West 21st Street New York, NY 10010

510 Broadhollow Road Melville, NY 11747 Tel: (212) 243-0725 Tel: (631) 465-0786 Fax: (631) 465-0788 Fax: (212) 243-0725 aafridi@afridiassociates.com

# LIZARDOS

LONG ISLAND | NEW YORK CITY | CHARLOTTE | DANBURY

200 Old Country Road | Suite 670 Mineola | NY 11501 516 484 1020 Lizardos.com

Lizardos Engineering Associates D.P.C.

Designer:	AKBER AFRIDI, P.E.
Drawn by:	AZHER MALIK
Checked by:	AKBER AFRIDI, P.E.

INTERIOR RENOVATIONS OF ALUMNI VILLAGE APARTMENTS

# 10.1 (ADA COMPLIANT) & 10.3


Address: 735 Anderson Hill Road Purchase NY 10577

FINISHES (CEILING & SOFFIT) **ADA APARTMENT 10.1** 

> Drawing No.: A303.00

SU-040623

Scale: AS NOTED 08/24/2020 Date:

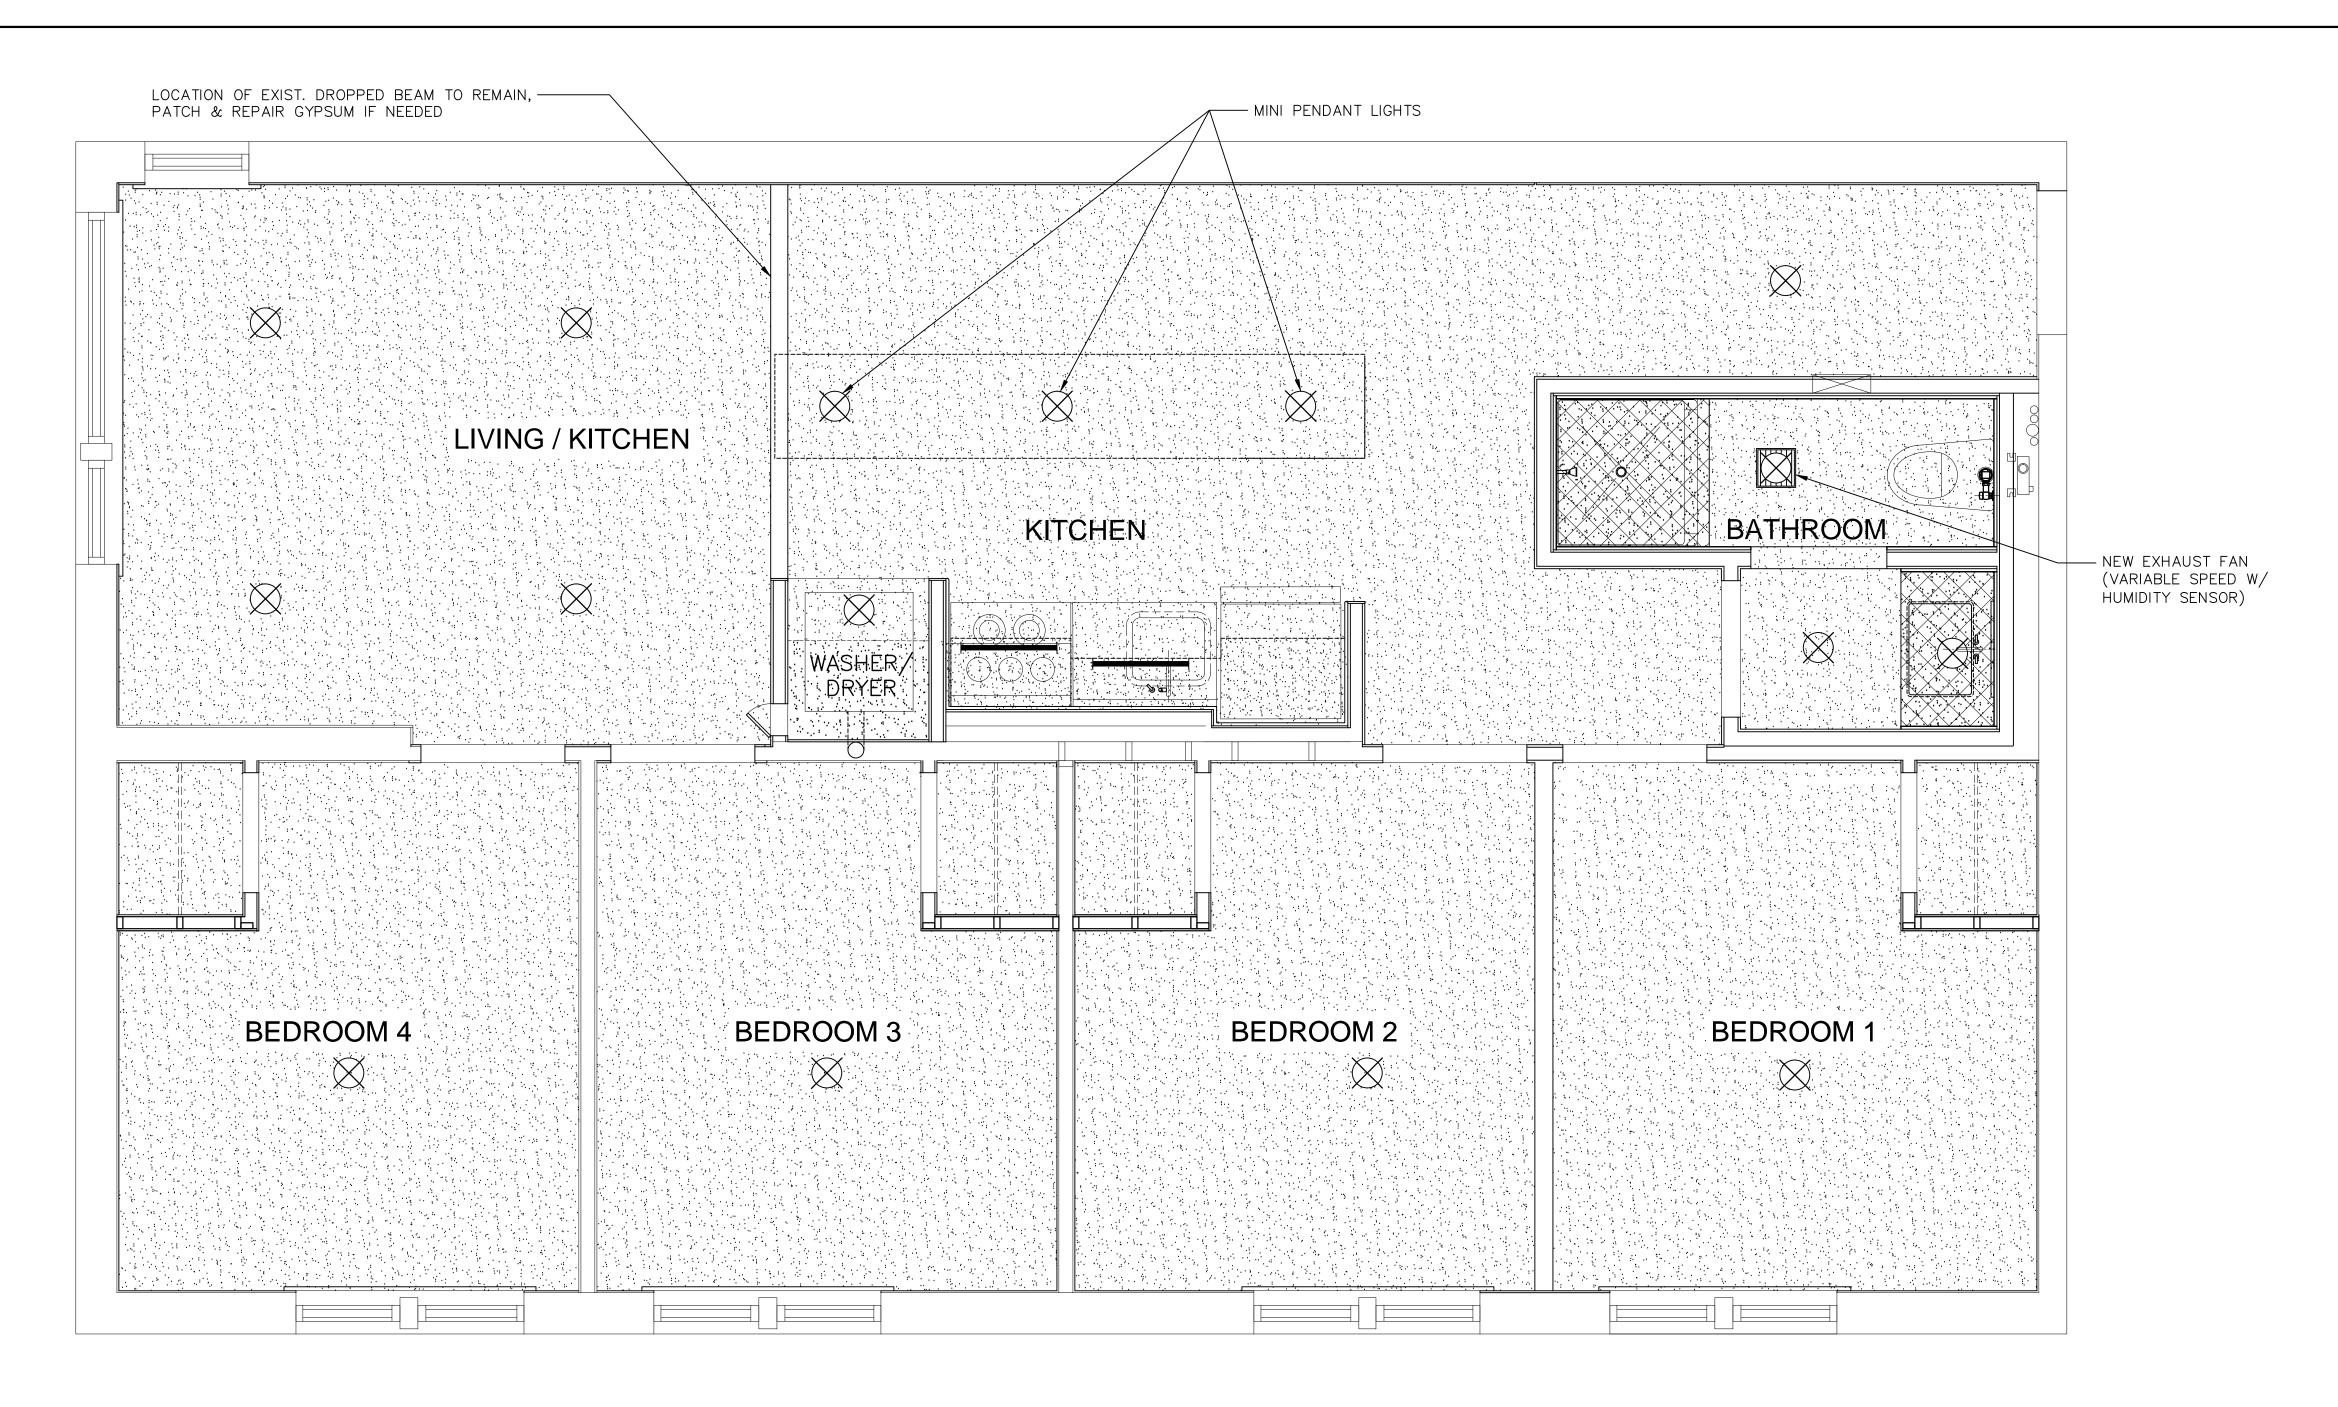



SCALE: 1/2" = 1'-0"

FINISH SCHEDULE							
FIN. TAG	FIN. DESCRIPTION	MANUFACTURER	FIN. SPECS	NOTES			
CEILING FINISH							
GWB-01	GYPSUM WALL BOARD CEILING	USG	%" GYPSUM WALL BOARD WITH USG DRYWALL SUSPENSION SYSTEM OR LIGHT GAUGE FRAMING AT SOFFITS, FINISH AS NOTED	FOYER, LIVING AREA, BEDROOM REFER TO CEILING PLAN			
GWB-02	WONDERBOARD LITE, BACKER BOARD OR APPROVED EQUAL.	CUSTOM BUILDING PRODUCTS	%。" WONDERBOARD LITE OR APPROVED EQUAL, BACKER BOARD FOR BATHROOM AND KITCHEN WALLS	BATHROOM CEILING, SINK AND SHOWER AREA SOFFIT, KITCHEN SOFFIT REFER TO CEILING PLAN			
GWB-03	GOLD BOND, PURPLE XP MOLD & MOISTURE RESISTANT DRYWALL	GOLD BOND BUILDING PRODUCTS	½" GOLD BOND, PURPLE XP MOLD & MOISTURE RESISTANT DRYWALL ON WOOD FRAMING, AS SHOWN IN DRAWING.	FOR EXISTING DRYWALL REPAIR AND NEW WALLS IN FOYER, LIVING AREA, BEDROOM			


## LEGEND



SHEETROCK (MOISTURE RESISTANT)



SHEETROCK (ABOVE CABINETS/SHELVES)

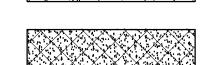

GWB-02 WET AREA



CEILING MOUNTED LUMINAIRE



CEILING MOUNTED EXHAUST FAN (15"x15")

W/ LIGHT & HUMIDITY SENSOR

2 04/06/2023 100% SUBMISSION 1 09/24/2022 80% SUBMISSION

No. Date Revision

### AFRIDI ASSOCIATES CONSULTING ENGINEERS

19 West 21st Street New York, NY 10010 Tel: (212) 243-0725

510 Broadhollow Road Melville, NY 11747 Tel: (631) 465-0786 Fax: (212) 243-0725 Fax: (631) 465-0788

aafridi@afridiassociates.com

# **LIZARDOS**

LONG ISLAND | NEW YORK CITY | CHARLOTTE | DANBURY

200 Old Country Road | Suite 670 Mineola | NY 11501 516 484 1020 Lizardos.com

Lizardos Engineering Associates D.P.C.

AKBER AFRIDI, P.E. Designer: AZHER MALIK Drawn by: AKBER AFRIDI, P.E. Checked by:


INTERIOR RENOVATIONS OF ALUMNI VILLAGE APARTMENTS 10.1 (ADA COMPLIANT) & 10.3


Address: 735 Anderson Hill Road Purchase NY 10577


Drawing Title: FINISHES (CEILING & SOFFIT) **APARTMENT 10.3** 

> Drawing No.: A304.00

Scale: AS NOTED

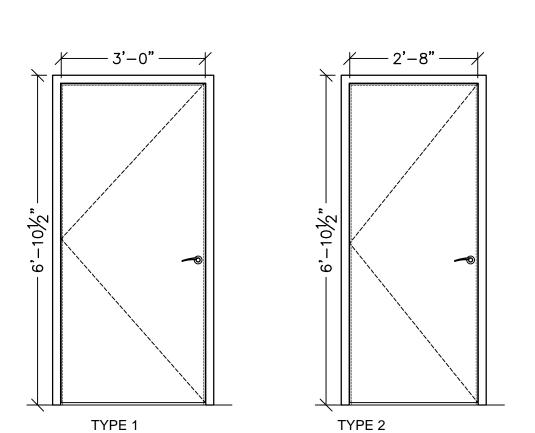

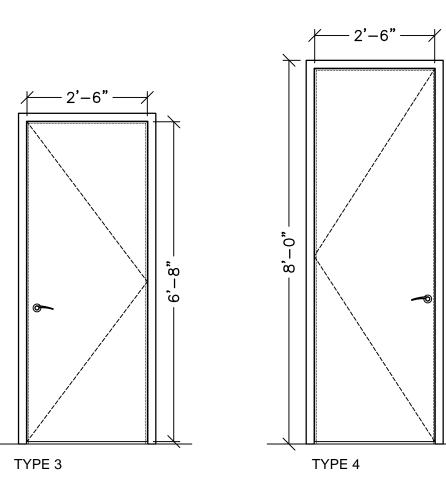

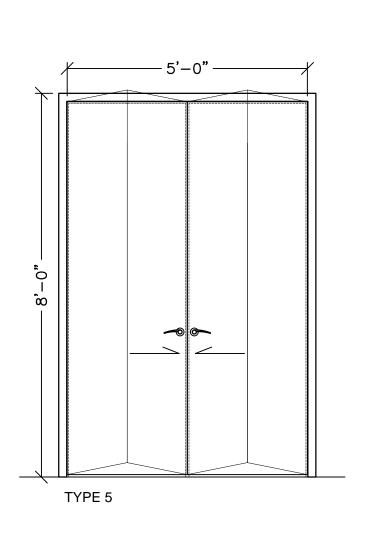

NOTES:

HARDWARE.

EOR'S APPROVAL.

TO PLACING ORDER.

HARDWARE REQUIREMENTS:

KNOB ON LOCK OR LATCH

TOP OF HINGE.

AND BOTTOM HINGE.

UNDERSIDE OF HINGE.

ALL DOORS SHALL HAVE HOLLOW METAL DOOR, SHOP PAINTED JAMBS, MATCHING TO DOOR FINISH, WITH APPROPRIATE DOOR

2. G.C. TO PROVIDE DESIGN CATALOGUE FOR

3. G.C. TO SUBMIT HARDWARE SAMPLES PRIOR


SEE DOOR SCHEDULE AND SPECIFICATION FOR

FINISH FLOOR TO CENTER LINE OF HARDWARE:

TOP HINGE - 5" FROM FRAME HEAD RABBET TO

CENTER HINGE — EQUAL DISTANCE FROM TOP


BOTTOM HINGE - 10" FROM FINISH FLOOR TO

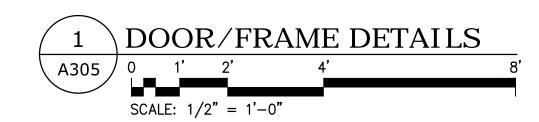

				OPE	ENING				DO	OR		HARDWARE
DOOR NO.	ROOM NAME	DOOR TYPE	WIDTH	HEIGHT	FRAME TYPE	FRAME MATERIAL / PAINT	DOOR TYPE	WIDTH	HEIGHT	THICKNESS	MATERIAL	SET
D1	MAIN (EXIST.)	_										
D2	BATHROOM (ADA APT 10.1), (NEW)	1	3'-4"	6'-10 1/2"	H.M.	STEEL/WHITE	INSULATED	3'-0"	6'-8"	1 3/4"	COMPOSITE MDF	1
D2a	BATHROOM (APT 10.3), (NEW)	1	2'-10"	6'-10 1/2"	H.M.	STEEL/WHITE	INSULATED	2'-6"	6'-8"	1 3/4"	COMPOSITE MDF	2
D2b	BATHROOM (APT 10.3), (NEW)	1	2'-10"	6'-10 1/2"	H.M.	STEEL/WHITE	INSULATED	2'-6"	6'-8"	1 3/4"	COMPOSITE MDF	3
D3	BEDROOM 1 ADA, (NEW)	1	3'-4"	6'-10 1/2"	H.M.	STEEL/WHITE	INSULATED	3'-0"	6'-8"	1 3/4"	COMPOSITE MDF	4
D4	BEDROOM 2, (NEW)	2	3'-0"	6'-10 1/2"	H.M.	STEEL/WHITE	INSULATED	2'-8"	6'-8"	1 3/4"	COMPOSITE MDF	5
D5	BEDROOM 3, (NEW)	2	3'-0"	6'-10 1/2"	H.M.	STEEL/WHITE	INSULATED	2'-8"	6'-8"	1 3/4"	COMPOSITE MDF	5
D6	BEDROOM 4, (NEW)	2	3'-0"	6'-10 1/2"	H.M.	STEEL/WHITE	INSULATED	2'-8"	6'-8"	1 3/4"	COMPOSITE MDF	5
D7	CLOSET (NEW)	3	2'-10"	6'-10 1/2"	H.M.	STEEL/WHITE	INSULATED	2'-6"	6'-8"	1 3/4"	COMPOSITE MDF	6
D8	CLOSET (NEW)	3	2'-10"	6'-10 1/2"	H.M.	STEEL/WHITE	INSULATED	2'-6"	6'-8"	1 3/4"	COMPOSITE MDF	6
D9	CLOSET (NEW)	3	2'-10"	6'-10 1/2"	H.M.	STEEL/WHITE	INSULATED	2'-6"	6'-8"	1 3/4"	COMPOSITE MDF	6
D10	CLOSET (NEW)	3	2'-10"	6'-10 1/2"	H.M.	STEEL/WHITE	INSULATED	2'-6"	6'-8"	1 3/4"	COMPOSITE MDF	6
D12	WASHER/DRYER (NEW), APT 10.3	4	2'-10"	6'-10 1/2"	H.M.	STEEL/WHITE	INSULATED	2'-6"	6'-8"	1 3/4"	COMPOSITE MDF	7
D11	WASHER/DRYER (NEW), ADA APT 10.1	5	5'-4"	6'-10 1/2"	H.M.	STEEL/WHITE	INSULATED	(2) 2'-6"	6'-8"	1 3/4"	COMPOSITE MDF	8

### NOTE: ALL HARDWARE (IVES, ROCKWOOD OR AS BELOW) TO BE SATIN CHROME FINISH, COLOR/FINISH TO BE APPROVED BY EOR.

KE	ER TO SPECIFICATIONS — SECTION 08 70 00 FINISH HARDWARE		
SE1	`1:	SET	2:
3	DOOR HARDWARE/4" ROUND HINGE %"	3	DOOR HARDWARE/4" ROUND HINGE %"
1	F40MER626 - MERANO PRIVACY DOOR LEVER SET	1	F40MER626 - MERANO PRIVACY DOOR LEVER SET
1	61-C619, DOOR ACCESSORIES / SOLID DOOR STOP	1	61-C619, DOOR ACCESSORIES / SOLID DOOR STOP
SE1	3:	SET	<sup>-</sup> 4:
3	DOOR HARDWARE/4" ROUND HINGE %"	3	DOOR HARDWARE/4" ROUND HINGE %"
1	F40ACC619 - ACCENT PRIVACY DOOR SET	1	F51AMER626 - MERANO SINGLE CYLINDER KEYED/DOOR LEVER SET
		1	436-619, DOOR ACCESSORIES / FLOOR DOOR STOP
SE1	· 5:	SET	6:
	5: DOOR HARDWARE/4" ROUND HINGE %"	SET	6: DOOR HARDWARE/4" ROUND HINGE %"
SE1 3	<u> </u>		
	DOOR HARDWARE/4" ROUND HINGE %"		DOOR HARDWARE/4" ROUND HINGE %"
3	DOOR HARDWARE/4" ROUND HINGE %"  F51AMER626 - MERANO SINGLE CYLINDER KEYED/DOOR LEVER SET		DOOR HARDWARE/4" ROUND HINGE %"
3 1 1	DOOR HARDWARE/4" ROUND HINGE %"  F51AMER626 - MERANO SINGLE CYLINDER KEYED/DOOR LEVER SET		DOOR HARDWARE/4" ROUND HINGE %"  F40ACC619 — ACCENT PRIVACY DOOR SET
3 1 1	DOOR HARDWARE/4" ROUND HINGE %"  F51AMER626 - MERANO SINGLE CYLINDER KEYED/DOOR LEVER SET  436-619, DOOR ACCESSORIES / FLOOR DOOR STOP	1 1	DOOR HARDWARE/4" ROUND HINGE %"  F40ACC619 — ACCENT PRIVACY DOOR SET

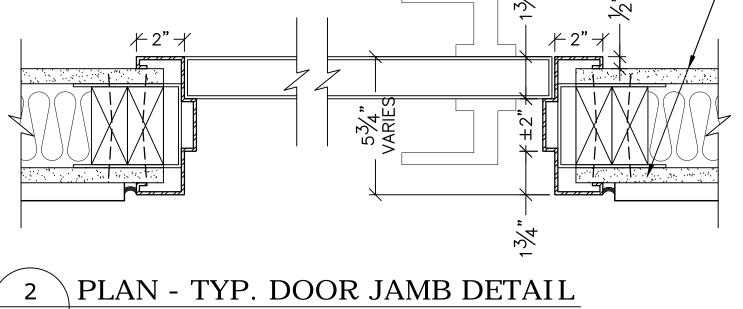


%" GYPSUM BOARD SCREWED TO FRAMING WITH DRYWALL SCREWS. SKIM COAT AND JOINT COMPOUND, USG SHEETROCK OR APPROVED EQUAL

NOTE:

THICKNESS AND MATERIAL OF DRYWALL VARIES.

FOR KITCHEN AND BATHROOM WALLS WITH TILE FINISH WILL HAVE ½" THICK MOISTURE RESISTANT TREATED CORE BACKER BOARD, WONDERBOARD OR APPROVED EQUAL (TYP.)

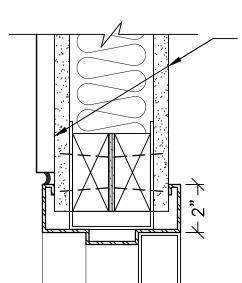

SCALE: 3'' = 1'-0''

%" GYPSUM BOARD SCREWED TO FRAMING WITH DRYWALL SCREWS. SKIM COAT AND JOINT COMPOUND, USG SHEETROCK OR APPROVED EQUAL

SECTION - TYP. DOOR (A305 JAMB DETAIL

SCALE: 3" = 1'-0"

2 04/06/2023 100% SUBMISSION 1 09/24/2022 80% SUBMISSION No. Date Revision

# AFRIDI ASSOCIATES

CONSULTING ENGINEERS 510 Broadhollow Road

19 West 21st Street New York, NY 10010 Tel: (212) 243-0725 Fax: (212) 243-0725

Melville, NY 11747 Tel: (631) 465-0786 Fax: (631) 465-0788

aafridi@afridiassociates.com

# **LIZARDOS**

LONG ISLAND | NEW YORK CITY | CHARLOTTE | DANBURY

200 Old Country Road | Suite 670 Mineola | NY 11501 516 484 1020 Lizardos.com

Lizardos Engineering Associates D.P.C.

Designer:	AKBER AFRIDI, P.E.
Drawn by:	AZHER MALIK
Checked by:	AKRER AFRIDI P.F.

INTERIOR RENOVATIONS OF ALUMNI VILLAGE APARTMENTS 10.1 (ADA COMPLIANT) & 10.3


Address: 735 Anderson Hill Road Purchase NY 10577


Drawing Title: DOOR DETAILS (TYPICAL)

> Drawing No.: A305.00

Scale: AS NOTED

SU-040623

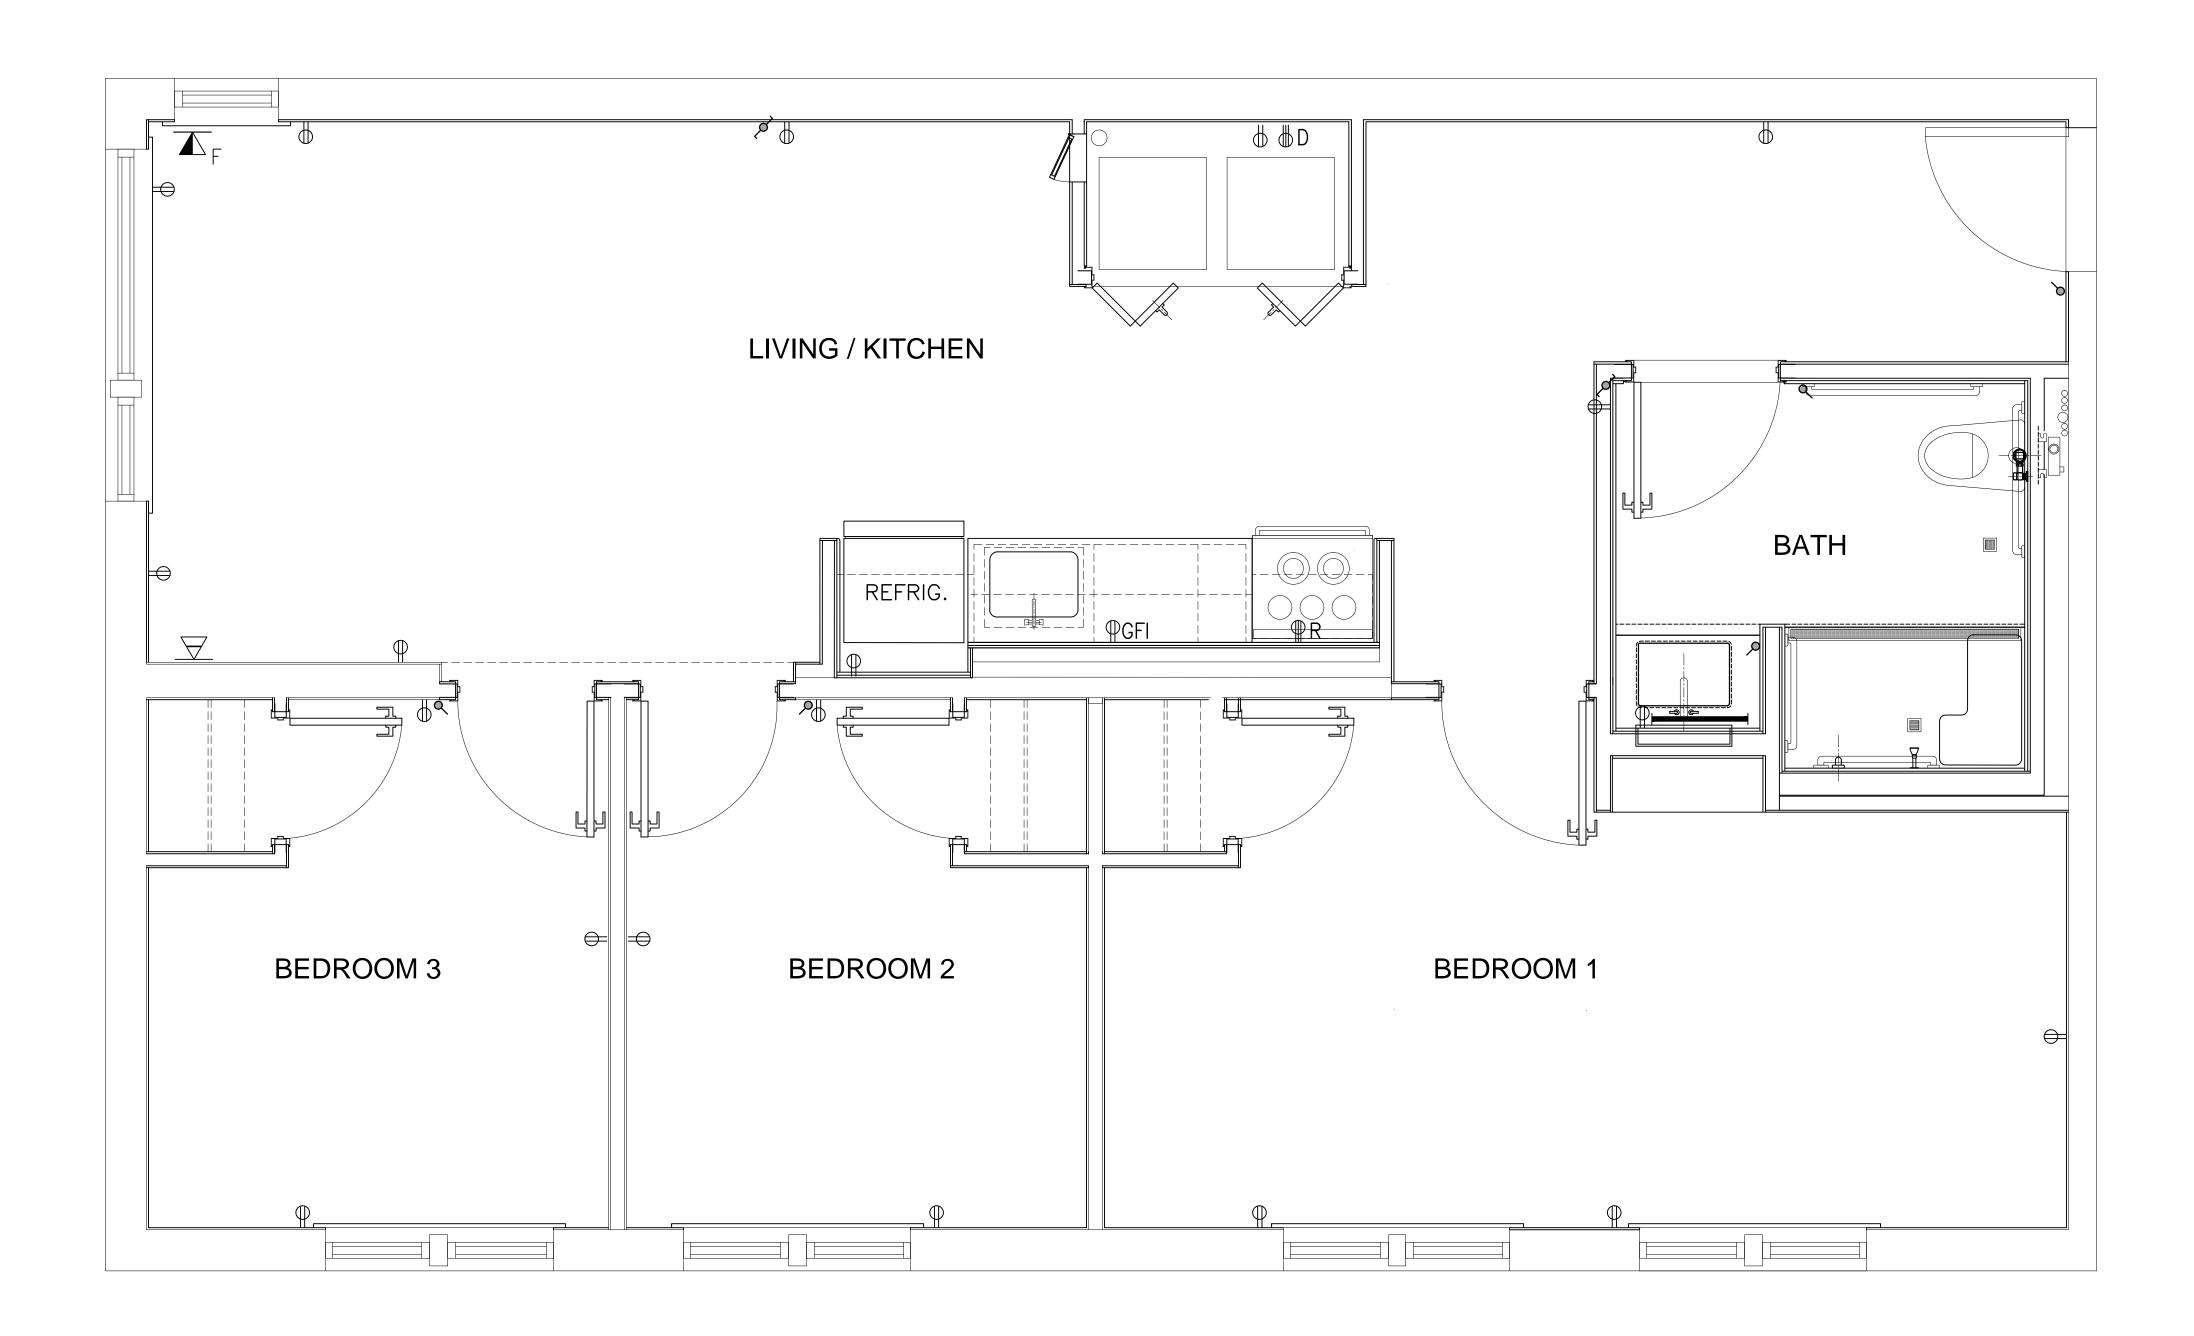

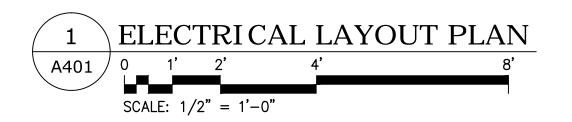

### LIGHTING AND POWER

SYMBOL	DESCRIPTION
$\boxtimes$	CEILING MOUNTED LUMINAIRE
<u> </u>	WALL MOUNTED (MIRROR) LIGHT
<b>b</b>	15AMP - 20 AMP RECEPTACLE (12" A.F.F)
<b>⊕</b> D	240v - 40 AMP RECEPTACLE (12" A.F.F)
фR	240v - 60 AMP RECEPTACLE (12" A.F.F)
8	SWITCH
ý	3-WAY SWITCH
	COMBINATION DATA/TV OUTLET W/DUPLEX JACKS LABELLED "DATA" & "TV" (MOUNTED AT 18" A.F.F.)
TV	TV OUTLET WITH SINGLE JACK LABELLED "TV" MOUNTED AT 18" A.F.F.
<b>⊢</b> <sub>F</sub>	TELEPHONE OUTLET FOR STANDARD DESK INSTRUMENT, WITH DUPLEX-JACKS, LABELED 'VOICE' AND 'DATA', MOUNTED AT 18" A.F.F, 'F' INDICATES FURNITURE MOUNTED.
	CEILING MOUNTED EXHAUST FAN (15"x15") W/ LIGHT & HUMIDITY SENSOR

NOTE: REFER TO ELECTRICAL DRAWINGS

2	04/06/2023	100% SUBMISSION
1	09/24/2022	80% SUBMISSION

# AFRIDI ASSOCIATES CONSULTING ENGINEERS

19 West 21st Street 510 Broadhollow Road New York, NY 10010 Tel: (212) 243-0725

No. Date Revision

Melville, NY 11747 Tel: (631) 465-0786 Fax: (631) 465-0788 Fax: (212) 243-0725

aafridi@afridiassociates.com

# **LIZARDOS**

LONG ISLAND | NEW YORK CITY | CHARLOTTE | DANBURY

200 Old Country Road | Suite 670 Mineola | NY 11501 516 484 1020 Lizardos.com

Lizardos Engineering Associates D.P.C.

Designer:	AKBER AFRIDI, P.E.
Drawn by:	AZHER MALIK
Checked by:	AKBER AFRIDI, P.E.


INTERIOR RENOVATIONS OF ALUMNI VILLAGE APARTMENTS 10.1 (ADA COMPLIANT) & 10.3


Address: 735 Anderson Hill Road Purchase NY 10577

ELECTRICAL LAYOUT PLAN **ADA APARTMENT 10.1** 

> Drawing No.: A401.00

Scale: AS NOTED

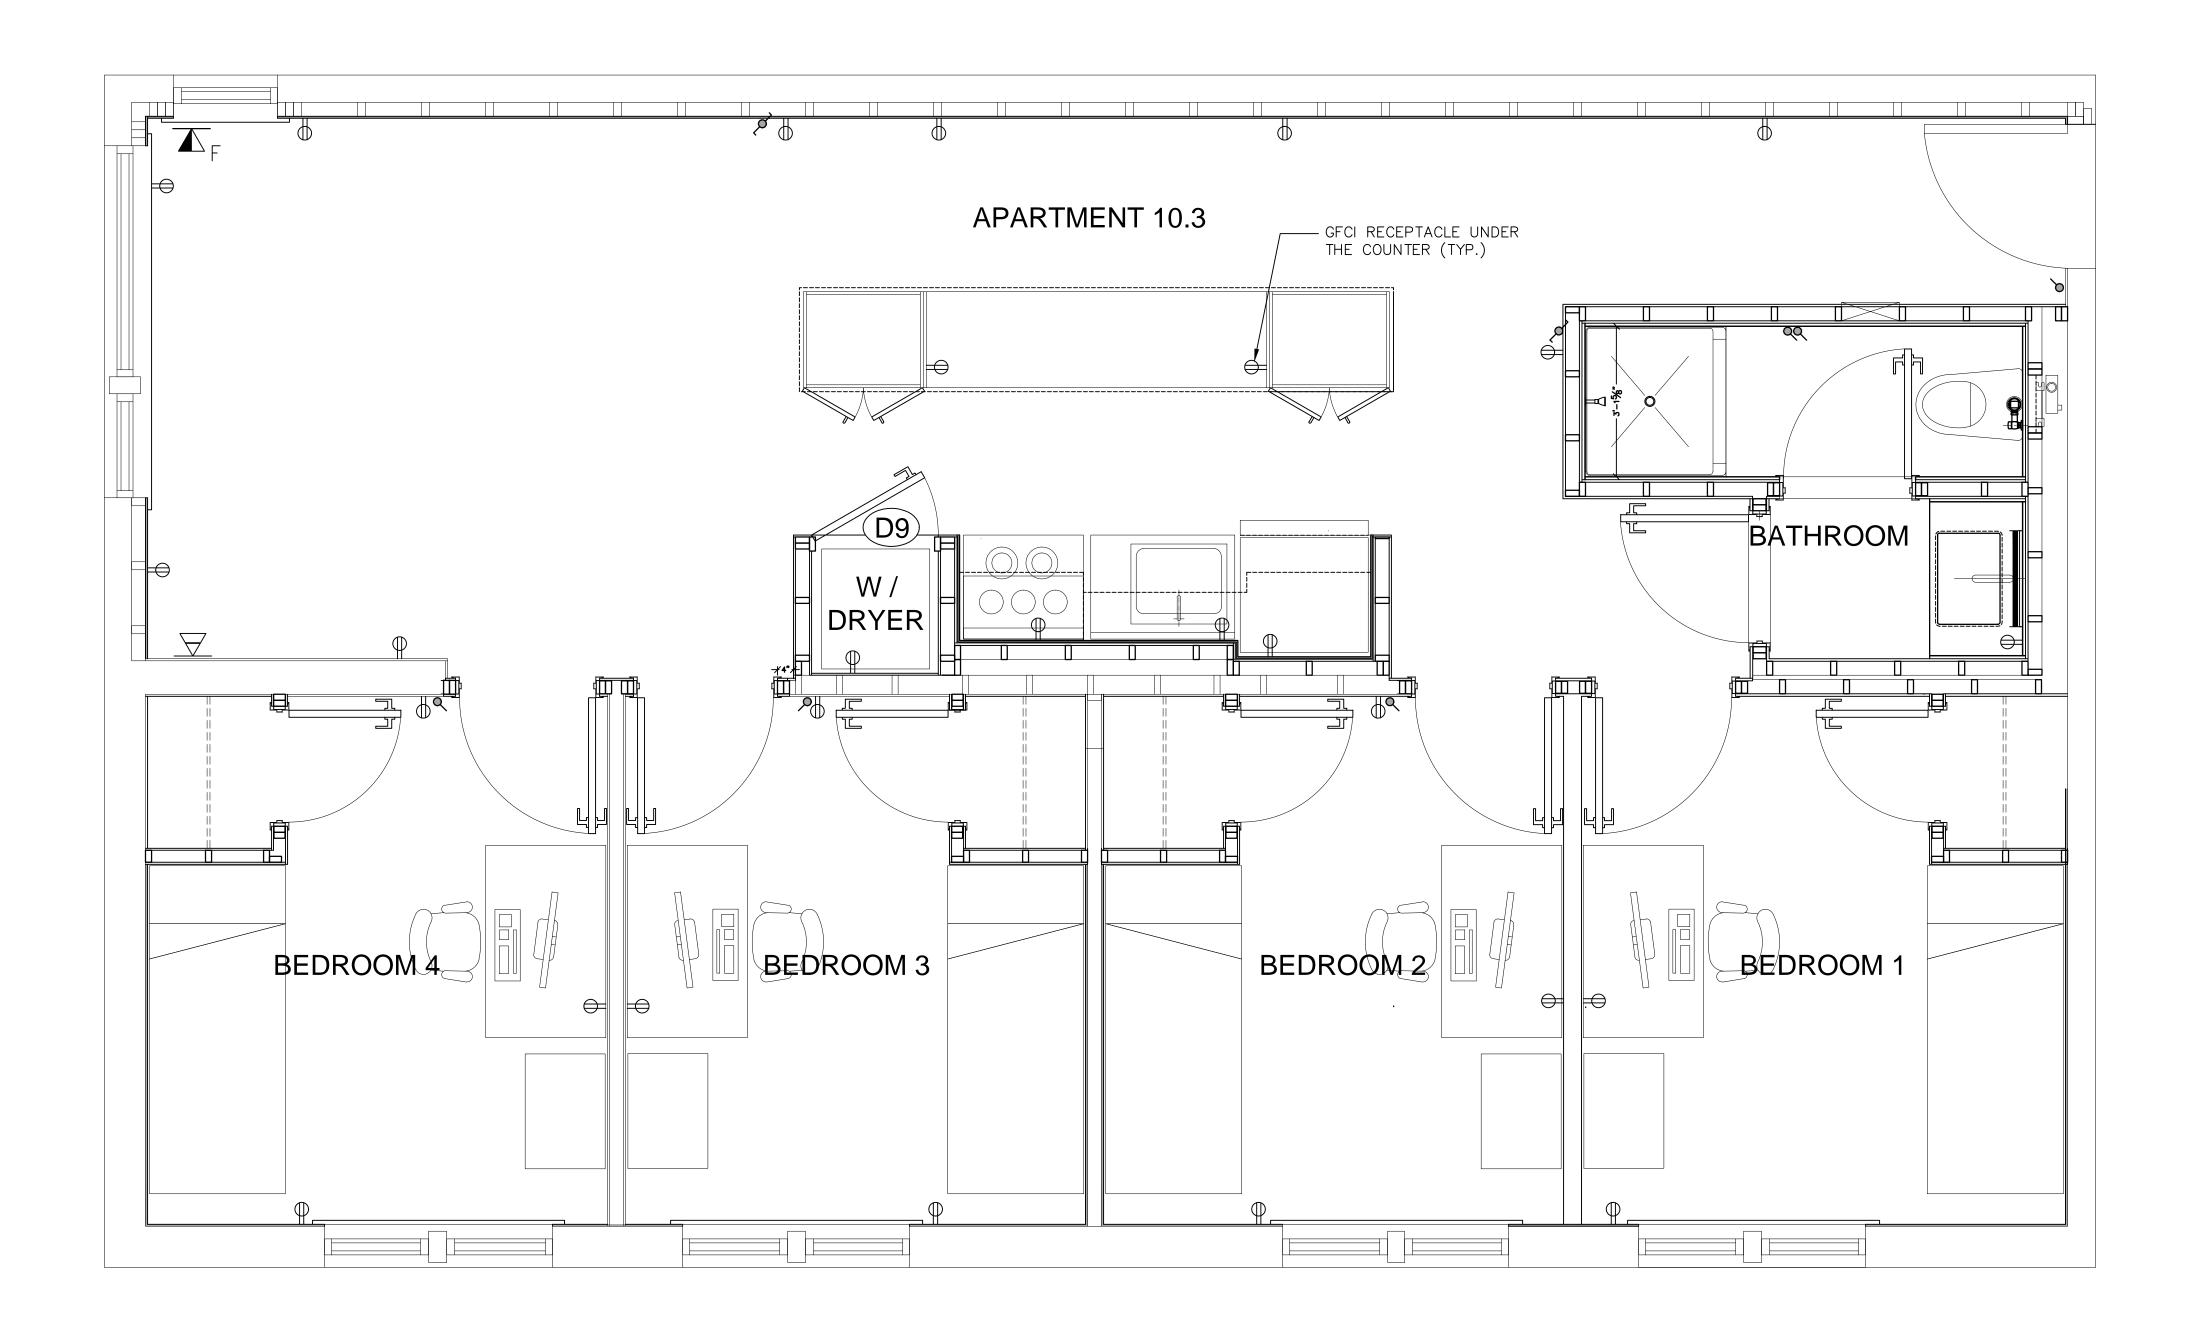

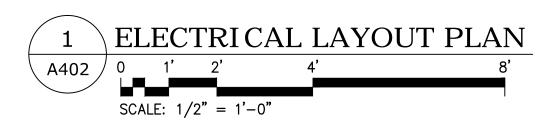

### LIGHTING AND POWER

SYMBOL	DESCRIPTION
$\boxtimes$	CEILING MOUNTED LUMINAIRE
×	WALL MOUNTED (MIRROR) LIGHT
ф	15AMP - 20 AMP RECEPTACLE (12" A.F.F)
8	SWITCH
\delta \	TWO WAY SWITCH
M	COMBINATION DATA/TV OUTLET W/DUPLEX JACKS LABELLED "DATA" & "TV" (MOUNTED AT 18" A.F.F.)
TV	TV OUTLET WITH SINGLE JACK LABELLED "TV" MOUNTED AT 18" A.F.F.
<b>⊢</b> <sub>F</sub>	TELEPHONE OUTLET FOR STANDARD DESK INSTRUMENT, WITH DUPLEX-JACKS, LABELED 'VOICE' AND 'DATA', MOUNTED AT 18" A.F.F, 'F' INDICATES FURNITURE MOUNTED.
	CEILING MOUNTED EXHAUST FAN (15"x15") W/HUMIDITY SENSOR

NOTE: REFER TO ELECTRICAL DRAWINGS

2	04/06/2023	100% SUBMISSION
1	09/24/2022	80% SUBMISSION

No. Date Revision

## AFRIDI ASSOCIATES

CONSULTING ENGINEERS

19 West 21st Street 510 Broadhollow Road New York, NY 10010 Melville, NY 11747 Tel: (212) 243-0725 Tel: (631) 465-0786 Fax: (212) 243-0725 Fax: (631) 465-0788

aafridi@afridiassociates.com

# **LIZARDOS**

LONG ISLAND | NEW YORK CITY | CHARLOTTE | DANBURY

200 Old Country Road | Suite 670 Mineola | NY 11501 516 484 1020 Lizardos.com

Lizardos Engineering Associates D.P.C.

Designer:	AKBER AFRIDI, P.E.
Drawn by:	AZHER MALIK
Checked by:	AKBER AFRIDI, P.E.

INTERIOR RENOVATIONS OF

ALUMNI VILLAGE APARTMENTS 10.1 (ADA COMPLIANT) & 10.3 Address:

735 Anderson Hill Road Purchase NY 10577

ELECTRICAL LAYOUT PLAN APARTMENT 10.3

> Drawing No.: A402.00 Scale: AS NOTED

SU-040623