GENERAL CONCRETE NOTES

- 1. DESIGN IS IN ACCORDANCE WITH THE REQUIREMENTS
 OF THE 2014 NEW YORK CITY BUILDING CODE.
- 2. STRUCTURAL MEMBERS LOCATION, SIZES AND SHAPES SHOWN ON DRAWINGS ARE FOR ILLUSTRATION AND INFORMATION PURPOSE ONLY, CONTRACTOR TO FIELD VERIFY THE EXISTING CONDITIONS.
- 3. IF EXISTING CONDITIONS ARE FOUND TO BE DIFFERENT IN FIELD THAN SHOWN ON DRAWINGS, CONTRACTOR TO NOTIFY EOR AND PROJECT OFFICER IMMEDIATELY.
- 4. CONTRACTOR TO SUBMIT SHOP DRAWINGS OF SUPPORT SYSTEM WITH STRUCTURAL CALCULATION PREPARED, SIGNED AND SEALED BY A NYS PROFESSIONAL ENGINEER FOR EOR'S APPROVAL BEFORE THE COMMENCEMENT OF WORK.
- 5. PROVIDE PRODUCT DATA SUBMITTALS FOR ALL PROPOSED PRODUCTS FOR EOR'S REVIEW BEFORE THE COMMENCEMENT OF WORK.
- 6. ANY DAMAGE INCURRED ON ADJOINING/ ADJACENT
 MATERIALS DURING WORK SHALL BE REPLACED BY THE
 CONTRACTOR IN KIND AT HIS OWN COST.
- 7. ALL NEW WORK SHALL COMPLY WITH THE APPLICABLE BUILDING / CONSTRUCTION CODES.

CONCRETE NOTES:

- 1. CONCRETE FOR SITE WORK SHALL BE LIGHT WEIGHT WEIGHT CONCRETE WITH A MINIMUM COMPRESSIVE STRENGTH OF 4000 PSI AT 28 DAYS AND A MAXIMUM WATER TO CEMENT RATIO OF 0.45 BY WEIGHT (LB. PER LB.).
- 2. ALL CONCRETE WORK MIXES, INSPECTIONS, AND FORMWORK SHALL CONFORM TO THE REQUIREMENTS OF THE 2014 NYC BUILDING CODE, SECTION BC 1901.
- 3. PROPORTION, BATCH, AND MIX CONCRETE IN ACCORDANCE WITH SECTION BC 1905 OF THE 2014 NYC BUILDING CODE. PROPORTION CONCRETE MIX IN ACCORDANCE WITH SECTION BC 1905.3. MIXES SHALL HAVE INCLUDED ALL ADMIXTURES THAT WILL BE USED DURING THIS CONSTRUCTION.
- 4. ALL CONCRETE USED IN THE STRUCTURE
 SHALL CONFORM IN ALL RESPECTS TO THE
 MATERIAL AND PROPORTIONS OF THESE
 MATERIALS USED IN THE APPROVED DESIGN
 MIX. THE USE OF ANY ADDITIVES NOT
 PRESENT APPROVED DESIGN MIX IS
 PROHIBITED.
- 5. THE METHOD FOR CONVEYING CONCRETE TO THE PLACE OF DEPOSIT SHALL COMPLY WITH SECTION BC 1905.9.
- 6. CONSTRUCTION JOINTS OF CONCRETE COMPONENTS SHALL COMPLY WITH THE PROVISIONS OF SECTION BC 1906.4.
- 7. ROUGHENED SURFACE AT INTERFACE OF SEPARATE CONCRETE POURS (JOINTS) SHALL BE PREPARED AS FOLLOWS:
- a) ROUGHEN SURFACE TO A FULL AMPLITUDE OF APPROXIMATELY 1/4" WITH STIFF BROOM AFTER INITIAL SET.
- b) BEFORE PLACING FRESH CONCRETE, CLEAN SURFACE AND REMOVE LAITANCE WITH WIRE BRUSH.
- c) IMMEDIATELY BEFORE NEW CONCRETE IS PLACED, WET SURFACE AND REMOVE STANDING WATER.

SITE WORK NOTES

1. THE CONTRACTOR IS RESPONSIBLE FOR PROTECTION OF ADJOINING PROPERTY DURING CONSTRUCTION OR DEMOLITION, AS PER BC 3309.

- 2. FOR EXCAVATIONS, BACKFILL, ETC., SEE SPECIFICATIONS. ALL FILL AND BACKFILL, IF REQUIRED, SHALL BE CONTROLLED FILL AND COMPLY WITH PROVISIONS OF SECTIONS BC 1803 AND BC 1804.2.2 OF THE 2014 NYC BUILDING CODE.
- 3. PRIOR TO COMMENCEMENT OF WORK,

 CONTRACTOR SHALL CALL "CODE 53"

 (CALL-BEFORE-YOU-DIG. IN NYC, TEL#

 212-460-4883 FOR NYC ONE CALL CENTER)

 FOR LOCATION OF UTILITIES (NYS INDUSTRIAL

 CODE RULE 53-12 NYC RR 53).
- 4. THE CONTRACTOR SHALL CONFORM TO SAFETY REQUIREMENTS DURING EXCAVATION AND COMPLY WITH SECTION BC 3304 OF THE 2014 NYC BUILDING CODE.

SUGGESTED SEQUENCE OF CONSTRUCTION

- 1. INSTALLATION OF TEMPORARY FENCING TO SECURE THE WORK AREA.
- 2. INSTALLATION OF SILT FENCING, INLET PROTECTION, AND STABILIZED CONSTRUCTION ENTRANCE LOCATED AS SHOWN ON THE PLANS;
- 3. CLEARING AND GRUBBING OF THE PROJECT SITE AREAS INDICATED FOR REDEVELOPMENT AND REMOVAL OF EXIST. SITE FEATURES AS NECESSARY FOR THE INSTALLATION OF THE PROPOSED IMPROVEMENTS;
- 4. FINAL GRADING OF THE DISTURBED AREAS TO FINISHED GRADE;
- 5. INSTALLATION OF NEW AGGREGATE BASE COURSE IN AREAS OF NEW PAVEMENT. INSTALLATION OF NEW LIGHT CONCRETE;
- 6. INSTALLATION OF NEW PAVEMENTS.

 ADJUSTMENT OF EXIST. DRAINAGE STRUCTURES

 TO MATCH FINISHED GRADE AT THE EXIST.

 STOREFRONT;
- 7. SILT REMOVAL AND CLEANING OF INLETS AND DRAINAGE PIPES PROTECTED DURING CONSTRUCTION.

EXIST. SITE CONDITIONS

- 1. THE CONTRACTOR SHALL VERIFY ALL DIMENSIONS AND ELEVATIONS IN THE FIELD PRIOR TO COMMENCING WORK.
- THE CONTRACTOR SHALL SUBMIT SHOP DRAWINGS AND CATALOGUE CUTS FOR APPROVAL PRIOR TO COMMENCING WORK.
- 3. THE CONTRACTOR SHALL MAINTAIN AND KEEP CLEAR ALL ACCESS TO AND EGRESS FROM THE WORK SITE. STORING AND PILING OF RUBBLE AND CONSTRUCTION WASTE IS PROHIBITED.
- 4. THE INFORMATION FOR LOCATIONS OF EXIST.

 UTILITY LINES WITHIN THE CONSTRUCTION SITE
 IS FOR REFERENCE ONLY. THE CONTRACTOR
 SHALL EXERCISE EXTREME CAUTION WHEN
 WORKING ADJACENT TO ACTIVE POWER AND
 COMMUNICATION LINES (IF ANY) TO PREVENT
 DAMAGE TO THESE LINES.THE CONTRACTOR
 SHALL HAND EXCAVATE TO EXPOSE THOSE
 LINES PRIOR TO PERFORMING ANY EXCAVATION
 WORK IN THE AREA. THE CONTRACTOR SHALL
 IMMEDIATELY REPAIR ANY POWER OR
 COMMUNICATION INTERRUPTION.

SUGGESTED SEQUENCE OF CONSTRUCTION

- 1. INSTALLATION OF TEMPORARY FENCING TO SECURE THE WORK AREA.
- 2. INSTALLATION OF SILT FENCING, INLET PROTECTION, AND STABILIZED CONSTRUCTION ENTRANCE LOCATED AS SHOWN ON THE PLANS;
- 3. CLEARING AND GRUBBING OF THE PROJECT SITE AREAS INDICATED FOR REDEVELOPMENT AND REMOVAL OF EXIST. SITE FEATURES AS NECESSARY FOR THE INSTALLATION OF THE PROPOSED IMPROVEMENTS;
- 4. FINAL GRADING OF THE DISTURBED AREAS TO FINISHED GRADE;
- 5. INSTALLATION OF NEW AGGREGATE BASE COURSE IN AREAS OF NEW PAVEMENT. INSTALLATION OF NEW LIGHT CONCRETE;
- 6. INSTALLATION OF NEW PAVEMENTS.

 ADJUSTMENT OF EXIST. DRAINAGE STRUCTURES

 TO MATCH FINISHED GRADE AT THE EXIST.

 STOREFRONT;
- 7. SILT REMOVAL AND CLEANING OF INLETS AND DRAINAGE PIPES PROTECTED DURING CONSTRUCTION.

EXIST. SITE CONDITIONS

- 1. THE CONTRACTOR SHALL VERIFY ALL DIMENSIONS AND ELEVATIONS IN THE FIELD PRIOR TO COMMENCING WORK.
- 2. THE CONTRACTOR SHALL SUBMIT SHOP
 DRAWINGS AND CATALOGUE CUTS FOR
 APPROVAL PRIOR TO COMMENCING WORK.
- 3. THE CONTRACTOR SHALL MAINTAIN AND KEEP CLEAR ALL ACCESS TO AND EGRESS FROM THE WORK SITE. STORING AND PILING OF RUBBLE AND CONSTRUCTION WASTE IS PROHIBITED.
- 4. THE INFORMATION FOR LOCATIONS OF EXIST.

 UTILITY LINES WITHIN THE CONSTRUCTION SITE
 IS FOR REFERENCE ONLY. THE CONTRACTOR
 SHALL EXERCISE EXTREME CAUTION WHEN
 WORKING ADJACENT TO ACTIVE POWER AND
 COMMUNICATION LINES (IF ANY) TO PREVENT
 DAMAGE TO THESE LINES.THE CONTRACTOR
 SHALL HAND EXCAVATE TO EXPOSE THOSE
 LINES PRIOR TO PERFORMING ANY EXCAVATION
 WORK IN THE AREA. THE CONTRACTOR SHALL
 IMMEDIATELY REPAIR ANY POWER OR
 COMMUNICATION INTERRUPTION.

SITE PLAN NOTES

- 1. THE CONTRACTOR SHALL VERIFY ALL DIMENSIONS AND ELEVATIONS IN THE FIELD PRIOR TO COMMENCING WORK.
- 2. THE CONTRACTOR SHALL SUBMIT SHOP
 DRAWINGS AND CATALOGUE CUTS FOR
 APPROVAL PRIOR TO COMMENCING WORK.
- 3. THE CONTRACTOR SHALL MAINTAIN AND KEEP CLEAR ALL ACCESS TO AND EGRESS FROM THE WORK SITE. STORING AND PILING OF RUBBLE AND CONSTRUCTION WASTE IS PROHIBITED.
- 4. THE INFORMATION FOR LOCATIONS OF EXIST.

 UTILITY LINES WITHIN THE CONSTRUCTION SITE
 IS FOR REFERENCE ONLY. THE CONTRACTOR

 SHALL EXERCISE EXTREME CAUTION WHEN

 WORKING ADJACENT TO ACTIVE POWER AND

 COMMUNICATION LINES (IF ANY) TO PREVENT

- DAMAGE TO THESE LINES.THE CONTRACTOR
 SHALL HAND EXCAVATE TO EXPOSE THOSE
 LINES PRIOR TO PERFORMING ANY EXCAVATION
 WORK IN THE AREA. THE CONTRACTOR SHALL
 IMMEDIATELY REPAIR ANY POWER OR
 COMMUNICATION INTERRUPTION.
- 5. INSPECT THE SITE PRIOR TO SUBMISSION OF BIDS AND MAKE NO ADDITIONAL CLAIMS REGARDING SITE CONDITIONS THEREAFTER.
- 6. COMPLETE ALL SURVEY AND STAKEOUT AS REQUIRED TO PROPERLY COMPLETE THE WORK.
- 7. PERFORM DAILY CLEANUP OPERATIONS
 INCLUDING REMOVAL OF DEBRIS AND EXCESS
 CONSTRUCTION MATERIAL, AND
 DRIVEWAY/STREET CLEANING TO THE
 SATISFACTION OF THE OWNER.
- 8. DURING ALL NON-WORKING HOURS,
 STORE ALL EQUIPMENT AND MATERIALS
 WITHIN AN AREA DESIGNATED BY THE OWNER
 AT THE PROJECT SITE.
- 9. ALL CURB DIMENSIONS SHOWN REFER TO THE FACE OF CURB.
- 10. ALL CONSTRUCTION TO CONFORM WITH ALL APPLICABLE FEDERAL, STATE AND LOCAL CODE REQUIREMENTS.
- 11. COORDINATE CONSTRUCTION ACTIVITIES WITH OWNER TO MINIMIZE INTERRUPTION TO THE OWNER'S OPERATIONS.
- 12. RESTORE SURROUNDING AREAS DAMAGED OR DISTURBED DURING CONSTRUCTION. RESTORE TO NEW CONDITIONS AT NO ADDITIONAL COST TO THE OWNER.
- 13. SEAL ALL JOINTS BETWEEN NEW PAVEMENT AND CONCRETE WITH SPECIFIED SEALANTS.

SITE REMOVAL NOTES

- REPORT ANY DISCREPANCIES BETWEEN ACTUAL FIELD CONDITIONS AND THE PLANS TO THE ENGINEER IN WRITING IMMEDIATELY.
- 2. UNDERGROUND UTILITY INFORMATION SHOWN ON THESE PLANS WAS OBTAINED FOR DESIGN PURPOSES ONLY. PROVIDE FOR CONSTRUCTION MARKOUT AND LOCATE EXIST. UNDERGROUND UTILITIES. NO EXCAVATION CAN COMMENCE UNTIL UTILITY DOCUMENTATION HAS BEEN COMPLETED.
- 3. AFTER MARKOUT AND PRIOR TO DISTURBING THE SITE, UNCOVER ALL SUBSURFACE UTILITIES AND STRUCTURES WITHIN LIMITS OF DISTURBANCE TO CONFIRM THEIR LOCATION AND DEPTH.
- 4. NO COMPENSATION WILL BE MADE FOR ANY INCONVENIENCE CAUSED BY ENCOUNTERING UTILITIES AND STRUCTURES WHICH ARE NOT SHOWN, OR ARE INACCURATELY SHOWN ON THE PLANS.
- 5. TAKE APPROPRIATE MEASURES TO PROTECT EXIST. UTILITIES WITHIN THE LIMITS OF WORK. REPAIR ANY DAMAGE TO EXIST. UTILITIES RESULTING FROM CONTRACTOR OPERATIONS IMMEDIATELY AT NO COST TO OWNER.
- 6. REPAIR ANY DAMAGE TO EXIST. SITE FEATURES SCHEDULED TO REMAIN RESULTING FROM CONTRACTOR OPERATIONS AT NO COST TO OWNER.
- 8. PROVIDE TEMPORARY FENCING TO PROTECT WORK AREAS.
- 9. INSTALL SEDIMENT BAG INLET PROTECTION ON ALL EXIST. INLETS WITHIN THE WORK AREA PRIOR TO ANY GROUND DISTURBANCE.
- 10. DELINEATE THE LIMITS OF CLEARING AND REVIEW WITH THE OWNER PRIOR TO COMMENCING WORK.
- 11. NOTIFY OWNER AND ENGINEER IMMEDIATELY IN WRITING WHEN UNKNOWN STRUCTURES OR SUSPECTED HAZARDOUS OR CONTAMINATED MATERIALS ARE ENCOUNTERED PRIOR TO REMOVAL OR DISTURBANCE.
- 12. TAKE APPROPRIATE MEASURES TO PROTECT PEDESTRIANS AND VEHICULAR TRAFFIC DURING REMOVAL ACTIVITIES, AND PROVIDE TEMPORARY MEASURES FOR THE PROTECTION AND SAFETY OF THE PUBLIC UNTIL FINAL ACCEPTANCE BY THE OWNER.
- 13. BACKFILL ALL VOIDS RESULTING FROM THE REMOVAL OF EXIST. SITE FEATURES. BACKFILL TO BE SOIL, FREE OF ORGANIC MATERIAL, DEBRIS, TRASH, CLAY AND STONES LARGER THAN 4 INCHES.

SITE REMOVAL LEGEND

- 1. EXIST. SIGNS TO REMAIN.
- 2. REMOVE AND STORE ALL EXIST. CONCRETE PAVEMENT TILES AND BRICK.
- 3. EXIST. DRAIN / CATCH BASIN AND STORM PIPING NOTES:
 - a. CONTRACTOR TO SECURE & TAKE ALL PRECAUTIONARY MEASURES TO PROTECT EXIST. DRAIN FROM DAMAGE OR INTRUSION OF SILT, SEDIMENT AND DEBRIS DURING CONSTRUCTION WORK.
- SIZES OF EXIST. STORM PIPES AND LOCATION OF EXIST. DRAINAGE/CATCH BASIN IS FOR INFORMATION ONLY. CONTRACTOR TO FIELD VERIFY EXIST. CONDITIONS.
- 4. COMPLETELY REMOVE AND DISPOSE OF EXIST. BRICK MASONRY WALL, CONCRETE PLANTER CURB, AND SUBSTRATE AS MARKED ON DRAWINGS.
- 5. EXIST. LIGHT POLE AND BASE TO REMAIN. CONTRACTOR TO SECURE & TAKE ALL PRECAUTIONARY MEASURES TO PROTECT EXIST. LIGHT POLE & BASE, AND ELECTRICAL CONDUIT DURING WORK.
- 6. EXIST. SIGNS TO BE COMPLETELY REMOVED AND REINSTALLED IN KIND.
- 7. PLANTS OUTSIDE THE EXIST. BOUNDARY WALL TO BE SECURED DURING CONSTRUCTION PERIOD. COORDINATE THE STOCK PILING AND REUSE OF TOP SOIL WITH OWNER'S REPRESENTATIVE.

GRADING & DRAINAGE NOTES

- 1. FOR NEW CONSTRUCTION THAT MEETS EXIST. CONDITIONS, ABUTTING SURFACES SHALL BE FLUSH AND ALIGNED.
- ADJUST ALL EXIST. CASTINGS AND VALVE COVERS TO MEET PROPOSED GRADE.
- 3. EXCESS TOP SOIL IS TO BE STOCKPILED, AND RE-USE SHALL BE COORDINATED WITH THE OWNERS. CONSTRUCTION DEBRIS AND EXCESS SOIL SHALL BE REMOVED AND LEGALLY DISPOSED OFF SITE.
- 4. SOILS DEEMED UNSUITABLE FOR SUPPORTING THE PROPOSED IMPROVEMENTS ENCOUNTERED DURING CONSTRUCTION SHALL BE BROUGHT TO THE ATTENTION OF THE OWNER AND ENGINEER IMMEDIATELY IN WRITING BEFORE REMOVAL OR DISTURBANCE.
- 5. THE INFORMATION FOR LOCATIONS OF EXIST.

 UTILITY LINES WITHIN THE CONSTRUCTION SITE
 IS FOR REFERENCE ONLY. THE CONTRACTOR
 SHALL EXERCISE EXTREME CAUTION WHEN
 WORKING ADJACENT TO ACTIVE POWER AND
 COMMUNICATION LINES (IF ANY) TO PREVENT
 DAMAGE TO THESE LINES.THE CONTRACTOR
 SHALL HAND EXCAVATE TO EXPOSE THOSE
 LINES PRIOR TO PERFORMING ANY EXCAVATION
 WORK IN THE AREA. THE CONTRACTOR SHALL
 IMMEDIATELY REPAIR ANY POWER OR
 COMMUNICATION INTERRUPTION.
- 6. THE CONTRACTOR SHALL PROVIDE ADEQUATE SUPPORT, APPROVED BY THE ENGINEER FOR ALL UTILITIES (IF ANY) THAT ARE EXPOSED DURING CONSTRUCTION TO ENSURE AGAINST DAMAGE.
- 7. WHERE CONSTRUCTION CROSSES THE EXIST. DRAIN LINE, OR IS ADJACENT TO EXIST. UTILITY LINES (IF ANY), THE CONTRACTOR SHALL CAREFULLY HAND EXCAVATE SO AS TO LOCATE, MARK, PROTECT THE UTILITY LINES AGAINST DISTURBANCE OR DAMAGE.
- 8. ALL AREAS THAT ARE DISTURBED BY CONSTRUCTION SHALL BE RESTORED AS INDICATED OR TO THEIR ORIGINAL CONDITION.
- 9. THE CONTRACTOR SHALL FURNISH "AS BUILT" DRAWINGS AFTER COMPLETION OF WORK.
- 10. ALL MATERIALS INDICATED ON THE PLANS TO BE REMOVED SHALL BECOME THE PROPERTY OF THE CONTRACTOR AND SHALL LEGALLY BE DISPOSED OF OFF THE SITE. THOSE ITEMS TO BE REMOVED AND RELOCATED SHALL BE CAREFULLY REMOVED, STORED, AND RELOCATED. ANY DAMAGE CAUSED BY THE REMOVAL OPERATION OR OCCURRING WHILE STORED OR BEING RELOCATED SHALL BE REPAIRED AT THE CONTRACTOR'S EXPENSE.
- 11. EXCAVATION SHALL BE TO THE LIMITS SHOWN AND SHALL INCLUDE SAW CUTTING OF PAVEMENTS, EXCAVATION, DISPOSAL, PUMPING,

SHEETING, BACKFILLING WITH ACCEPTABLE SITE EXCAVATED MATERIAL, FURNISHING AND INSTALLING CLEAN GRANULAR FILL AND ALL OTHER WORK NECESSARY TO COMPLETE THE CONSTRUCTION.

- 12. THE EXIST. AND/OR NEW GRAVEL SHALL BE GRADED AND ROLLED WITH MANUAL TOOLS
- 13. CRUSHED STONE BASE COURSE FOR
 PAVEMENT SHALL BE COMPOSED OF LEDGE
 ROCK, TALUS, OR GRAVEL WHICH IS UNIFORM
 IN QUALITY AND FREE FROM DUST OR OTHER
 DELETERIOUS MATTER GRADED WITHIN THE
 FOLLOWING LIMITS:

SIEVE SIZE % PASSING (WEIGHTS)

1 1/2" 90 - 100

3/4" 60 - 97

3/8" 25 - 60

16 15 - 40

20 0 - 10

PLACEMENT REQUIREMENTS SHALL BE AS PER STONE SCREENINGS EXCEPT FOR SPRINKLING.

08/24/2020 ISSUED FOR CONSTRUCTION

No. Date Revision

AFRIDI ASSOCIATES CONSULTING ENGINEERS

19 West 21st Street New York, NY 10010 Tel: (212) 243-0725 Fax: (212) 243-0725 510 Broadhollow Road Melville, NY 11747 Tel: (631) 465-0786 Fax: (631) 465-0788

Designer: AKBER AFRIDI, P.E.

Drawn by: AZHER MALIK

Checked by: AKBER AFRIDI, P.E.

aafridi@afridiassociates.com

SUNY PURCHASE
NEUBERGER MUSEUM
SOUTH COURTYARD
WATERPROOFING

Address:
735 Anderson Hill Road
Purchase NY 10577


Drawing Title:

CIVIL WORKS NOTES



Drawing No.:
C001.00

ale: AS NOTED

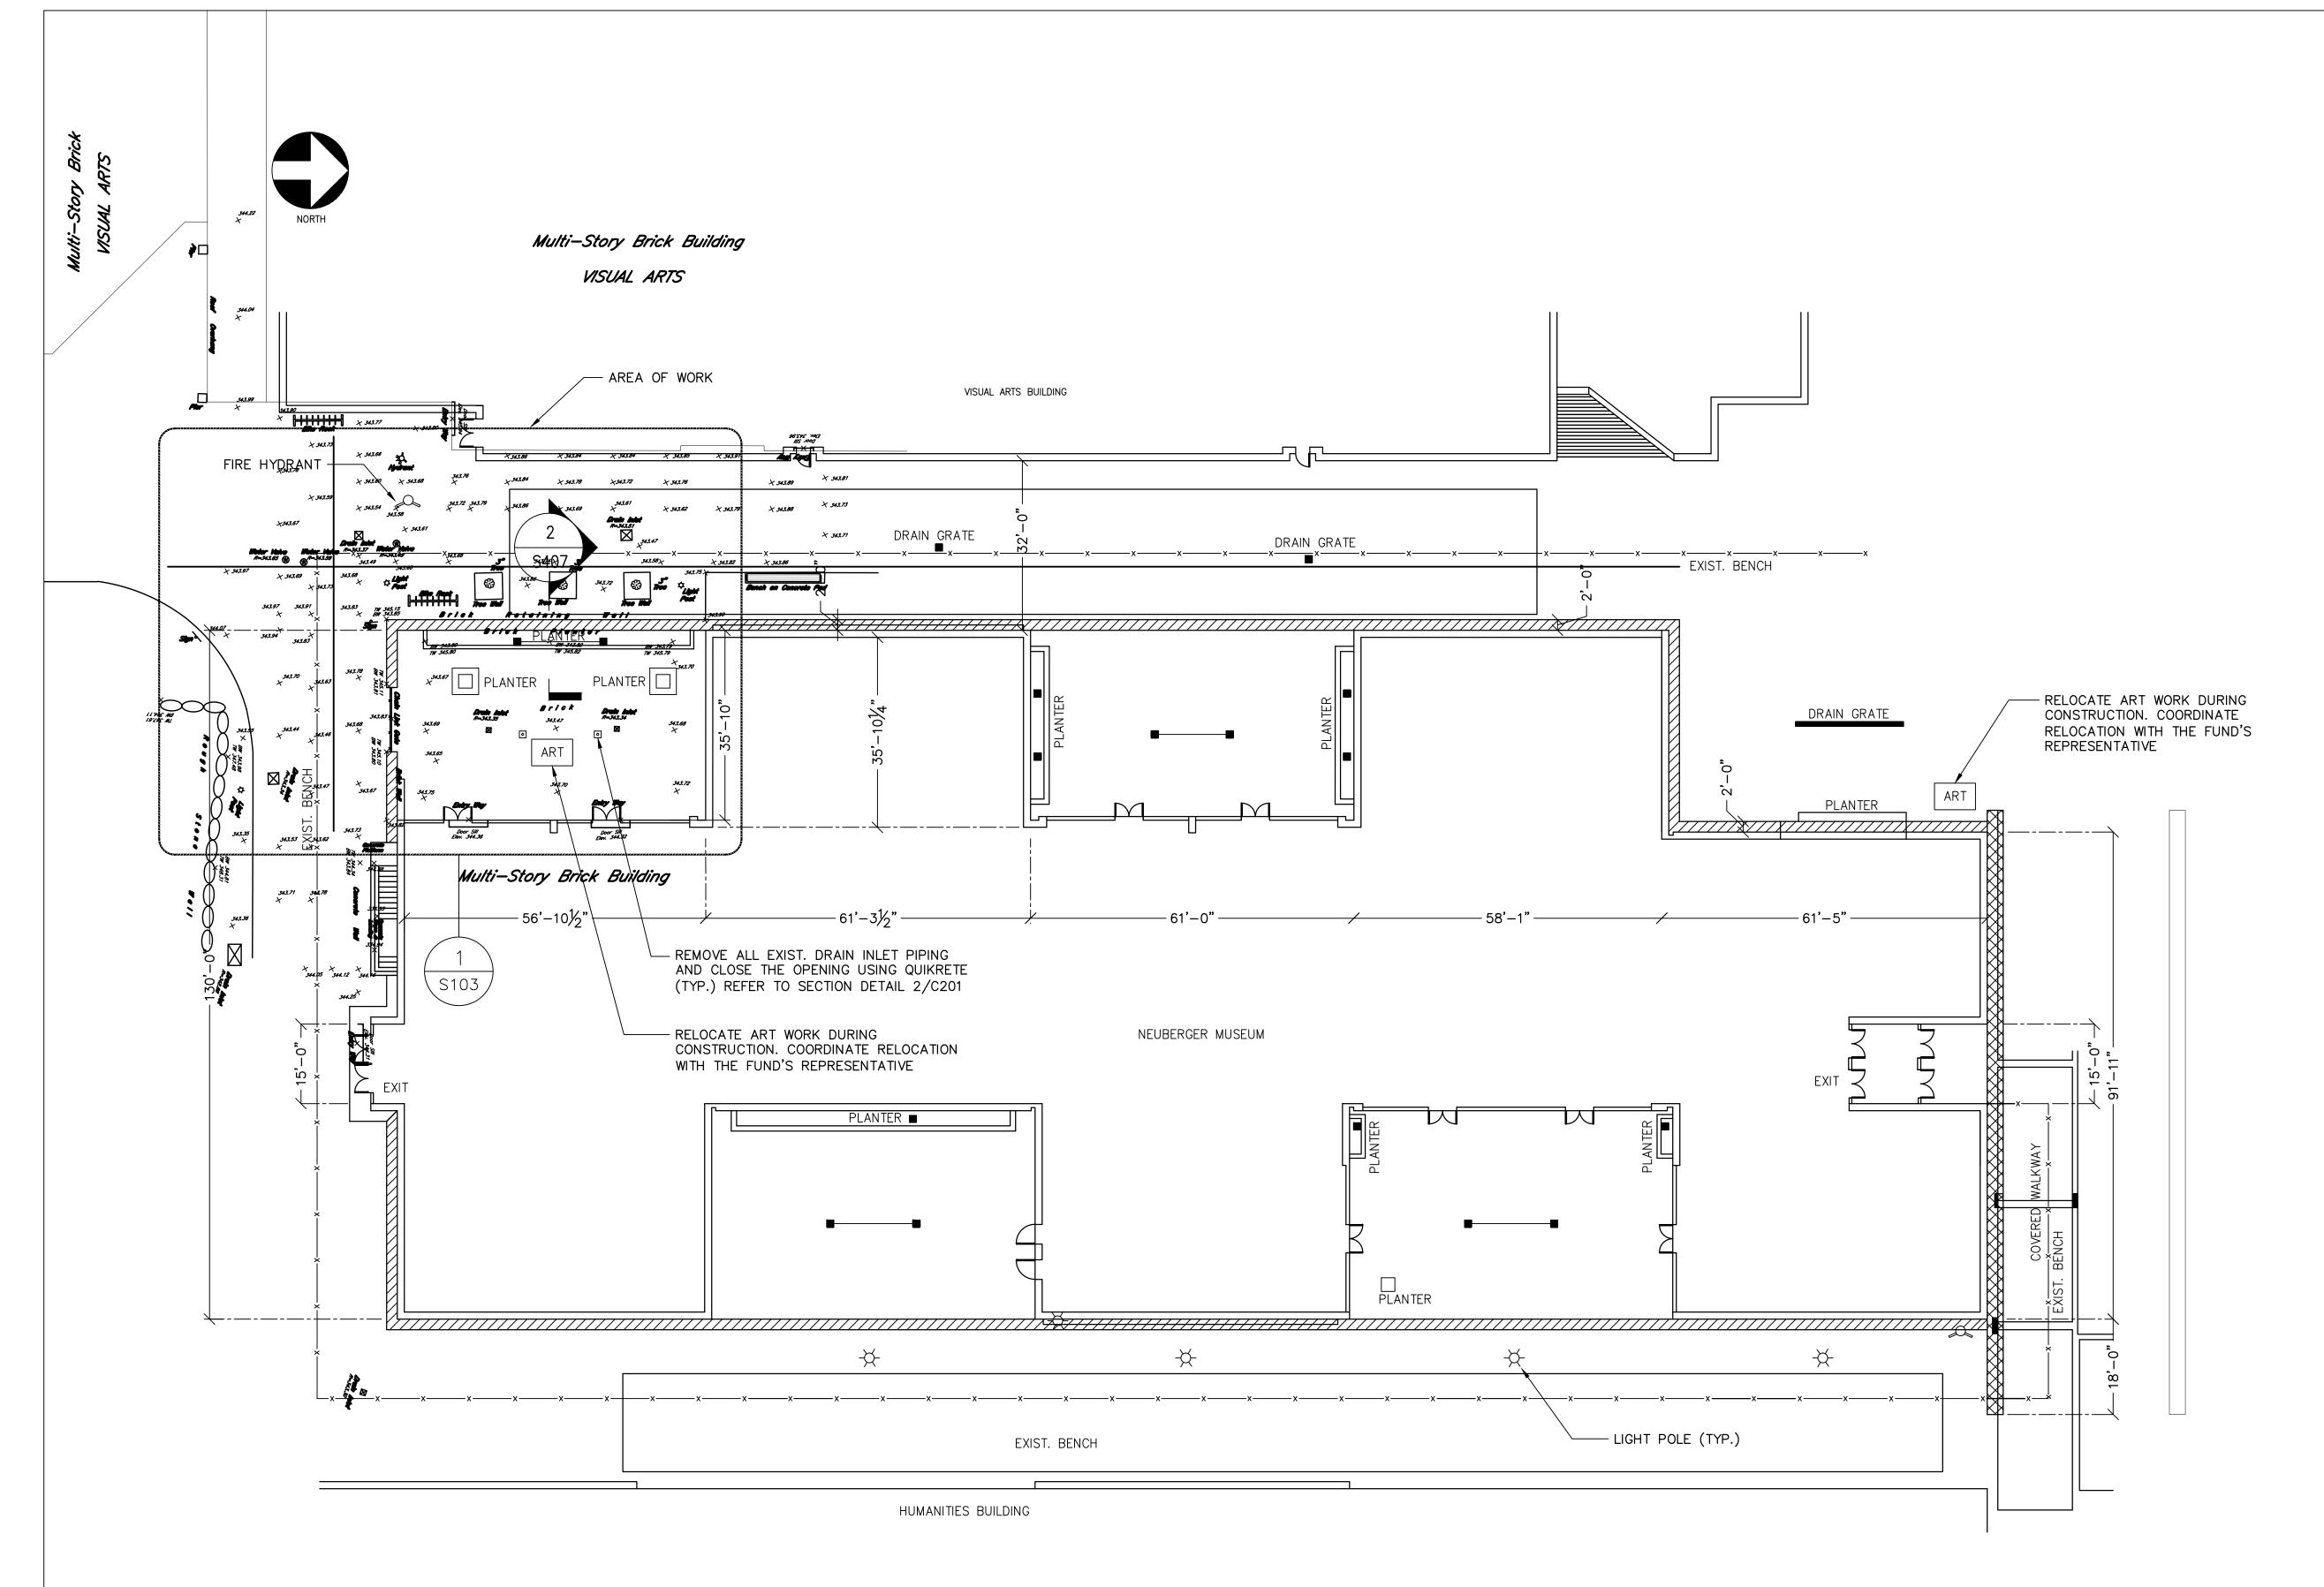

1 NEUBERGER MUSEUM SITE PLAN - EXIST.

C101 0 8' 16' 32' 64'

SCALE: 1/16" = 1'-0"

08/24/2020 ISSUED FOR CONSTRUCTION

No. Date Revision

AFRIDI ASSOCIATES CONSULTING ENGINEERS

19 West 21st Street New York, NY 10010 Tel: (212) 243-0725 Fax: (212) 243-0725

510 Broadhollow Road Melville, NY 11747 Tel: (631) 465-0786 Fax: (631) 465-0788

aafridi@afridiassociates.com

Designer: AKBER AFRIDI, P.E.

Drawn by: AZHER MALIK

Checked by: AKBER AFRIDI, P.E.

SUNY PURCHASE
NEUBERGER MUSEUM
SOUTH COURTYARD
WATERPROOFING


735 Anderson Hill Road Purchase NY 10577

SITE WORKS LOCATION PLAN



Drawing No.: C101.00

Scale: AS NOTED

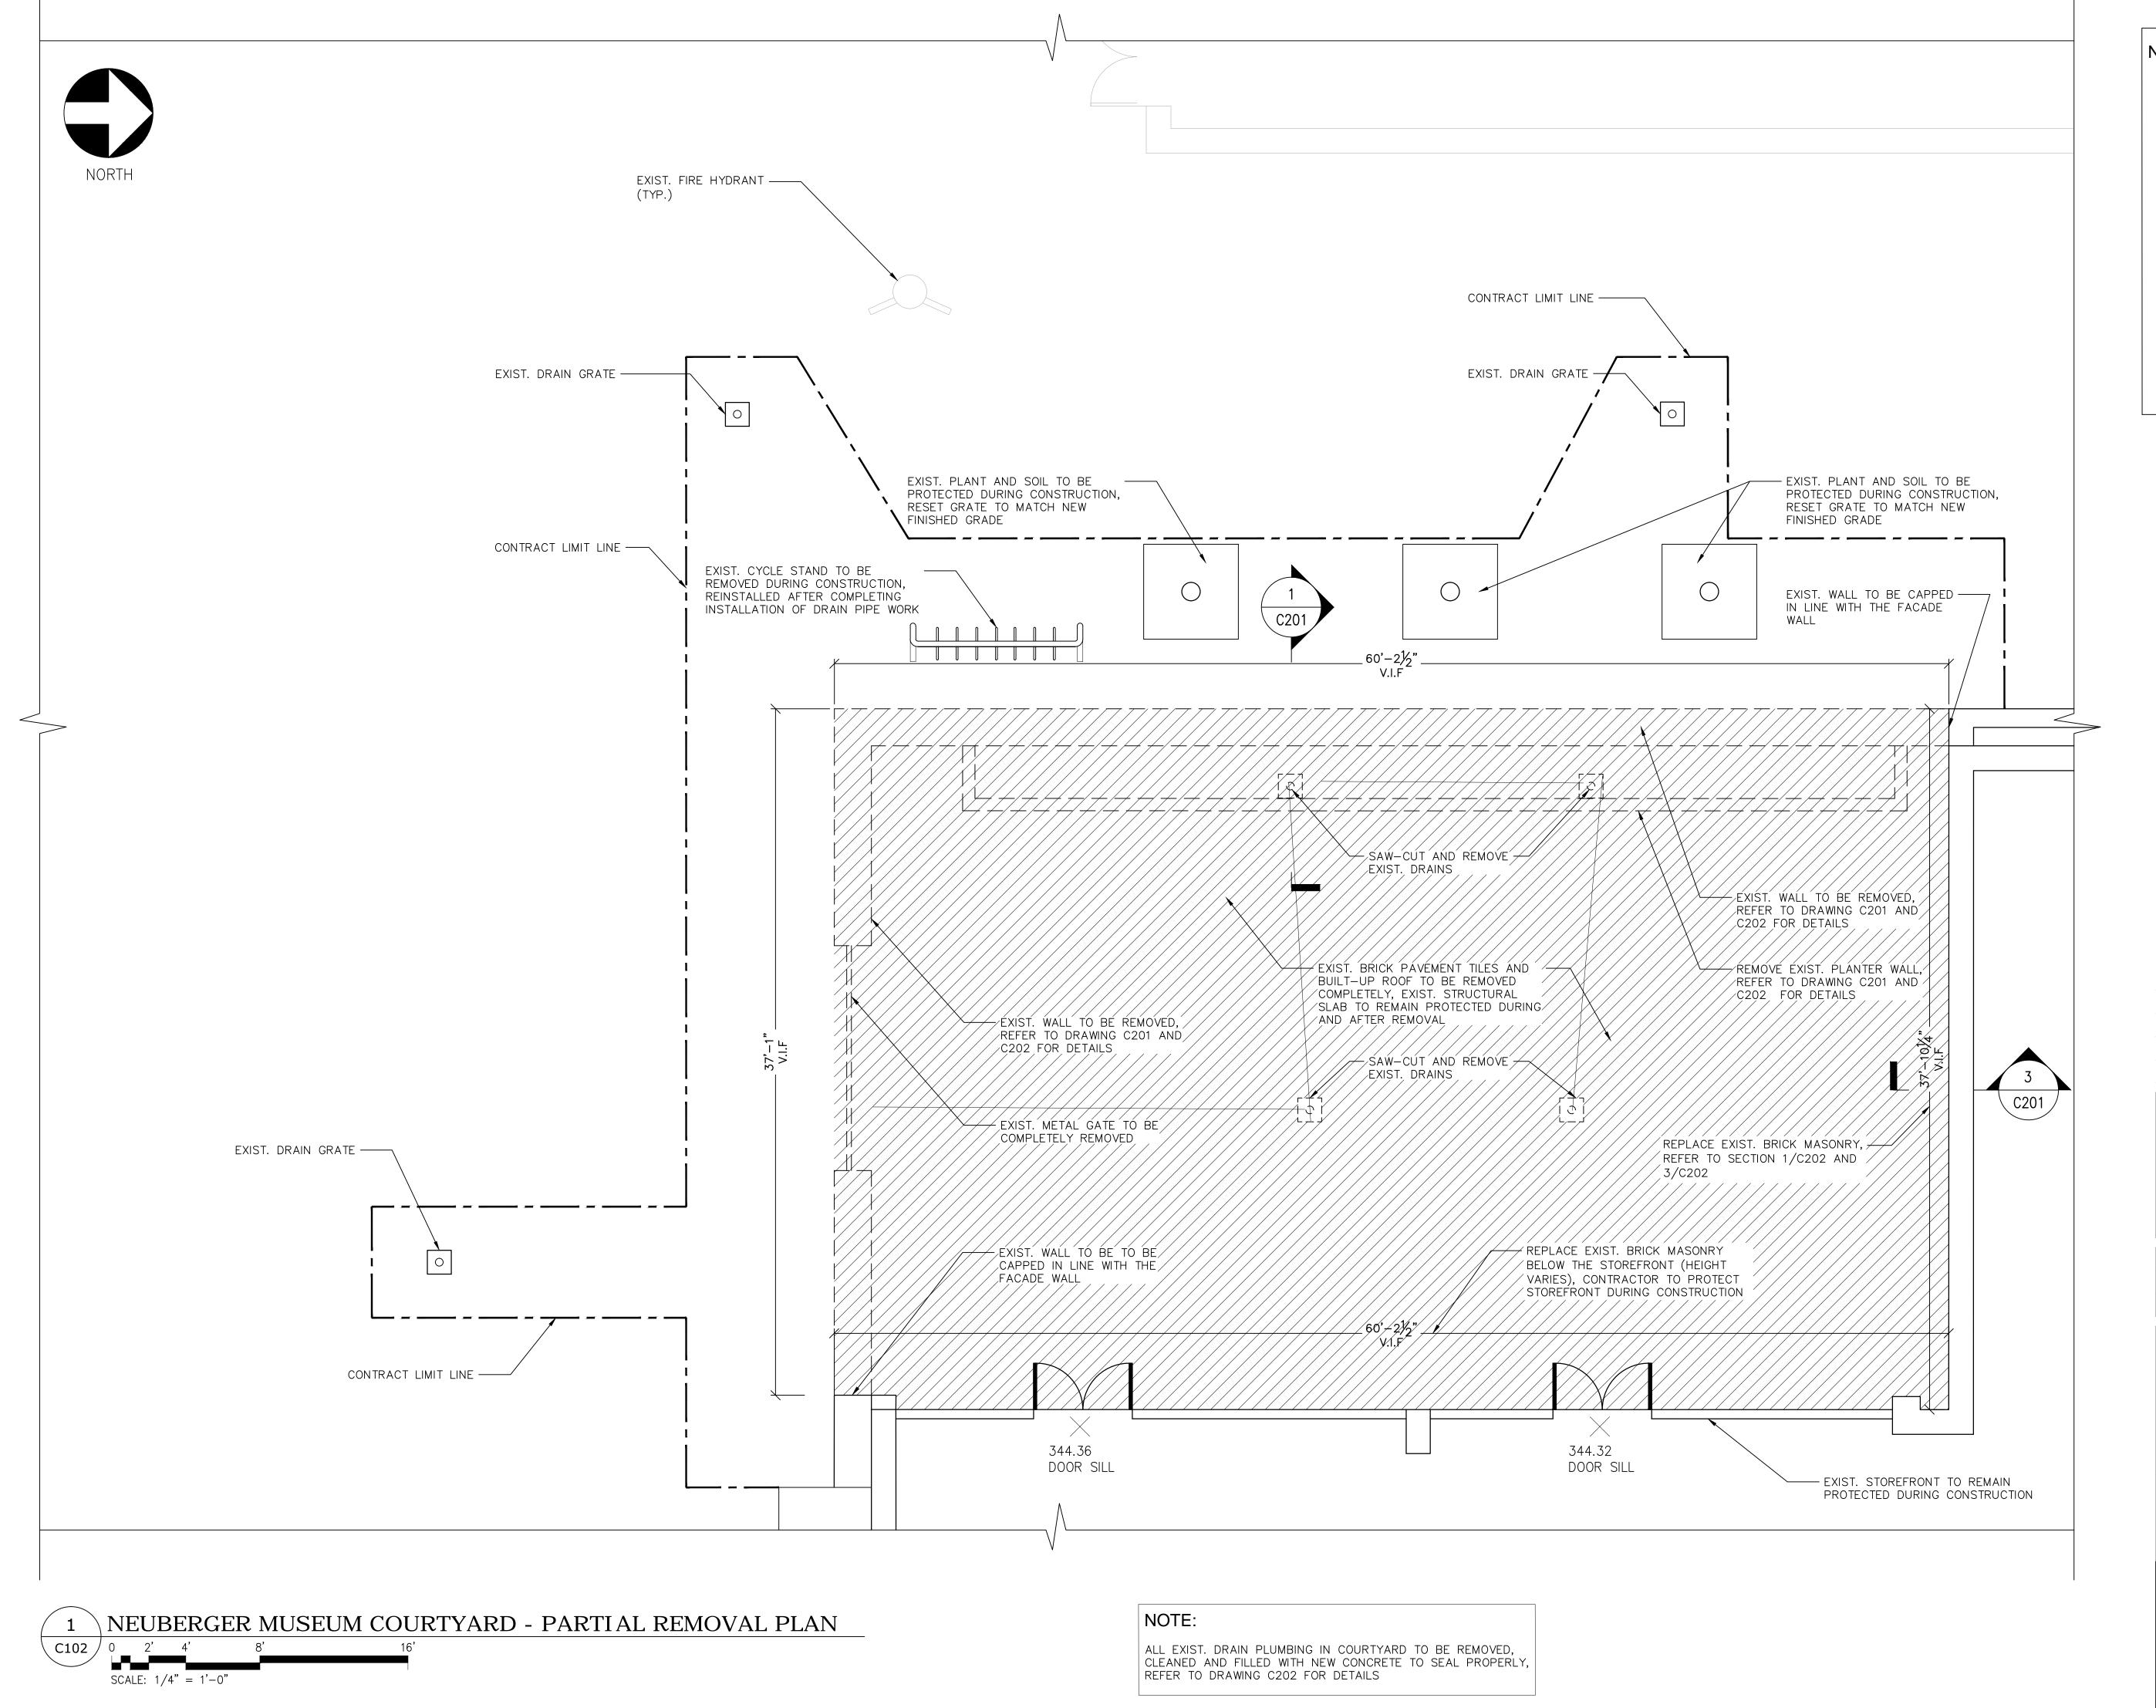

NOTE:

- 1. ALL EXIST. DRAIN PLUMBING IN COURTYARD TO BE REMOVED, CLEANED AND FILLED WITH NEW CONCRETE TO SEAL PROPERLY, REFER TO SECTION 2/S201 FOR DETAILS.
- 2. CAP DRAIN PIPES AT BASEMENT LEVEL AS INSTRUCTED BY THE ENGINEER.
- 3. CONTRACTOR TO ASCERTAIN NO SOIL OR SILT GOES INTO THE EXIST. DRAINS TO BE REUSED.
- 4. CONTRACTOR TO REINSTALL ALL EXIST. EQUIPMENT IN ITS ORIGINAL POSITION.
- 5. ALL DIMENSIONS ARE TO BE VERIFIED IN FIELD, ANY DISCREPANCY IN FIELD DIMENSIONS ARE TO BE NOTIFIED IMMEDIATELY.
- 6. CONTRACTOR WILL NOTIFY OF ANY DISCREPANCY DUE TO EXISTING SITE CONDITIONS.

08/24/2020 ISSUED FOR CONSTRUCTION

No. Date Revision

AFRIDI ASSOCIATES CONSULTING ENGINEERS

19 West 21st Street New York, NY 10010 Tel: (212) 243-0725 Fax: (212) 243-0725

510 Broadhollow Road Melville, NY 11747 Tel: (631) 465-0786 Fax: (631) 465-0788

aafridi@afridiassociates.com

Designer: AKBER AFRIDI, P.E.

Drawn by: AZHER MALIK


Checked by: AKBER AFRIDI, P.E.

SUNY PURCHASE NEUBERGER MUSEUM SOUTH COURTYARD WATERPROOFING

735 Anderson Hill Road Purchase NY 10577


Drawing Title:

SITE PARTIAL REMOVAL PLAN

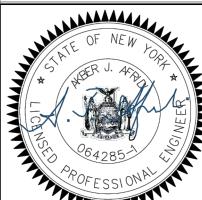

Drawing No.: C102.00

Scale: AS NOTED

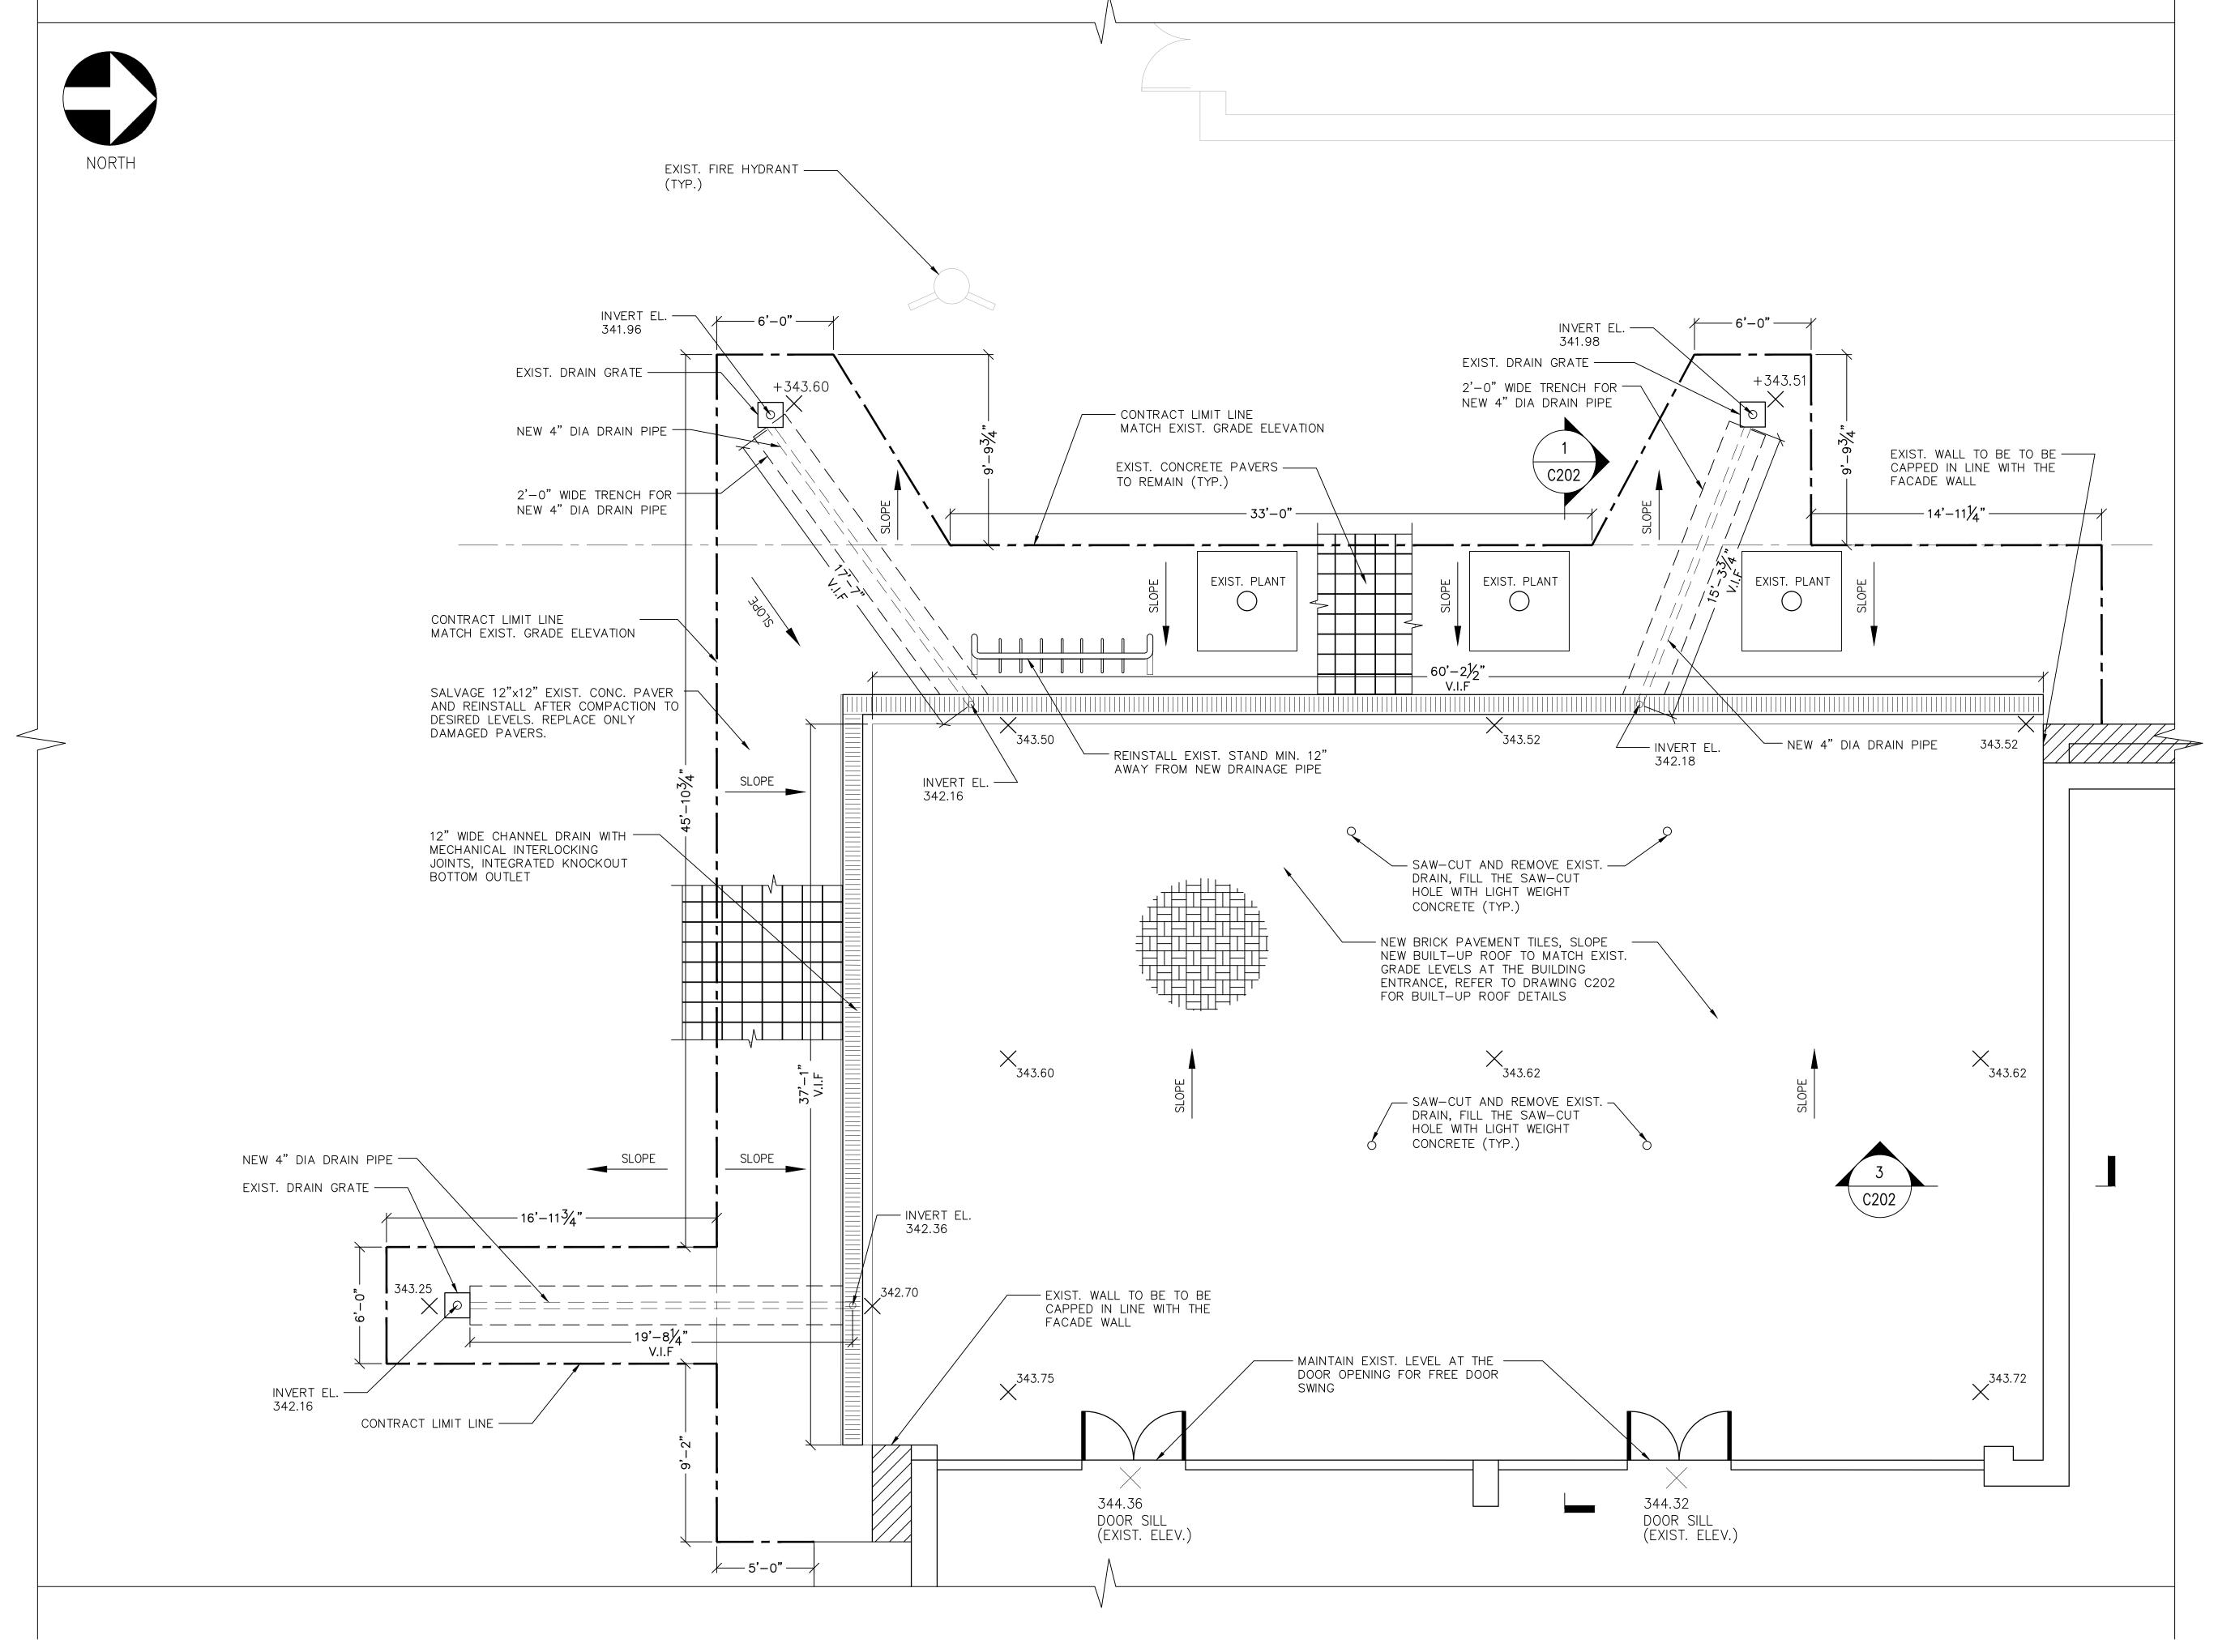

NOTE:

- 1. ALL EXIST. DRAIN PLUMBING IN COURTYARD TO BE REMOVED, CLEANED AND FILLED WITH NEW CONCRETE TO SEAL PROPERLY, REFER TO SECTION 2/S201 FOR DETAILS.
- 2. CONTRACTOR TO PROTECT OTHER APPERTINENT ELEMENTS (AT GRADE LEVEL AND BASEMENT) FROM DAMAGE AND DUST DURING CONSTRUCTION.
- 3. CONTRACTOR TO REPLACE IN KIND OTHER APPERTINENT ELEMENTS (AT GRADE LEVEL AND BASEMENT) THAT ARE DAMAGED DURING CONSTRUCTION AT NO COST.
- 4. CONTRACTOR TO SUBMIT TO EOR FOR APPROVAL"MEANS AND METHODS" TO PLAN AN ENCLOSURE DURING DEMOLITION TO CURTAIL DUST AND DEBRIS (AT GRADE LEVEL AND BASEMENT).
- 5. CAP DRAIN PIPES AT BASEMENT LEVEL AS INSTRUCTED BY EOR.
- 6. CONTRACTOR TO ASCERTAIN NO SOIL OR SILT GOES INTO THE EXIST. DRAINS TO BE REUSED.
- 7. CONTRACTOR TO REINSTALL ALL EXIST. EQUIPMENT IN ITS ORIGINAL POSITION.
- 8. ALL DIMENSIONS ARE TO BE VERIFIED IN FIELD, ANY DISCREPANCY IN FIELD DIMENSIONS ARE TO BE NOTIFIED IMMEDIATELY.
- 9. CONTRACTOR WILL NOTIFY OF ANY DISCREPANCY DUE TO EXISTING SITE CONDITIONS.

08/24/2020 ISSUED FOR CONSTRUCTION

No. Date Revision

AFRIDI ASSOCIATES

19 West 21st Street New York, NY 10010 Tel: (212) 243-0725 Fax: (212) 243-0725

NY 10010 Melville, NY 11747
) 243-0725 Tel: (631) 465-0786
) 243-0725 Fax: (631) 465-0788
aafridi@afridiassociates.com

AKBER AFRIDI, P.E.

510 Broadhollow Road

Designer: AKBER AFRIDI, P.E.

Drawn by: AZHER MALIK

SUNY PURCHASE
NEUBERGER MUSEUM
SOUTH COURTYARD
WATERPROOFING

735 Anderson Hill Road
Purchase NY 10577

Drawing Tit

Checked by:

PROPOSED SITE WORKS PLAN



Drawing No.: C103.00


ale: AS NOTED

Date: 08/24/2020

PROPOSED SITE WORKS PLAN

16'

C103 $\begin{vmatrix} 0 & 2' & 4' & 8' \\ & & & & \\$

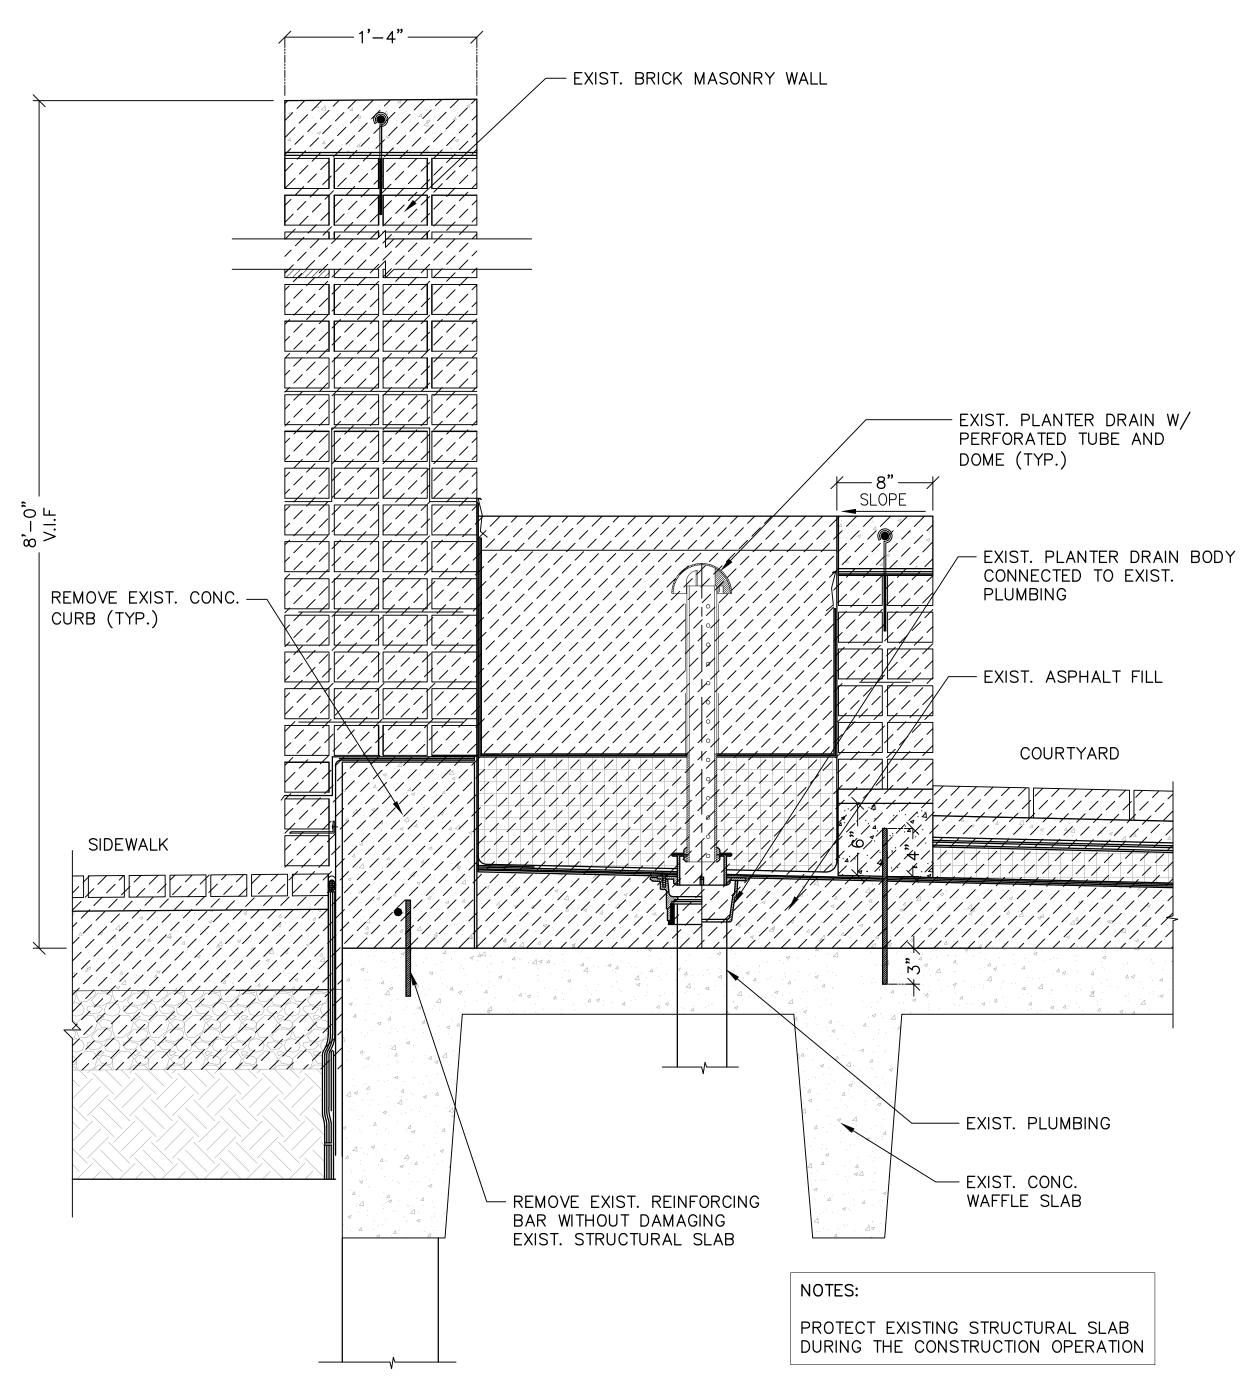

1 COURTYARD TYPICAL WALL SECTION (TO BE REMOVED)

C201 0 6" 1' 2'

SCALE: $1 \frac{1}{2}$ " = 1'-0"

08/24/2020 ISSUED FOR CONSTRUCTION

No. Date Revision

AFRIDI ASSOCIATES CONSULTING ENGINEERS

19 West 21st Street New York, NY 10010 Tel: (212) 243-0725 Fax: (212) 243-0725

510 Broadhollow Road Melville, NY 11747 Tel: (631) 465-0786 Fax: (631) 465-0788

aafridi@afridiassociates.com

Designer: AKBER AFRIDI, P.E.

Drawn by: AZHER MALIK

Checked by: AKBER AFRIDI, P.E.

SUNY PURCHASE
NEUBERGER MUSEUM
SOUTH COURTYARD
WATERPROOFING

735 Anderson Hill Road Purchase NY 10577

Drawing Title:

COURTYARD TYPICAL WALL SECTION
EXISTING



Drawing No.: C201.00

Scale: AS NOTED

