
# Project # SU-111618

Purchase College State University of New York Purchase, New York 10577 Purchase College Athletic Field Complex -Multi-Field Synthetic Turf Replacement

**BID DOCUMENT SET DATE: JANUARY 17, 2019** 

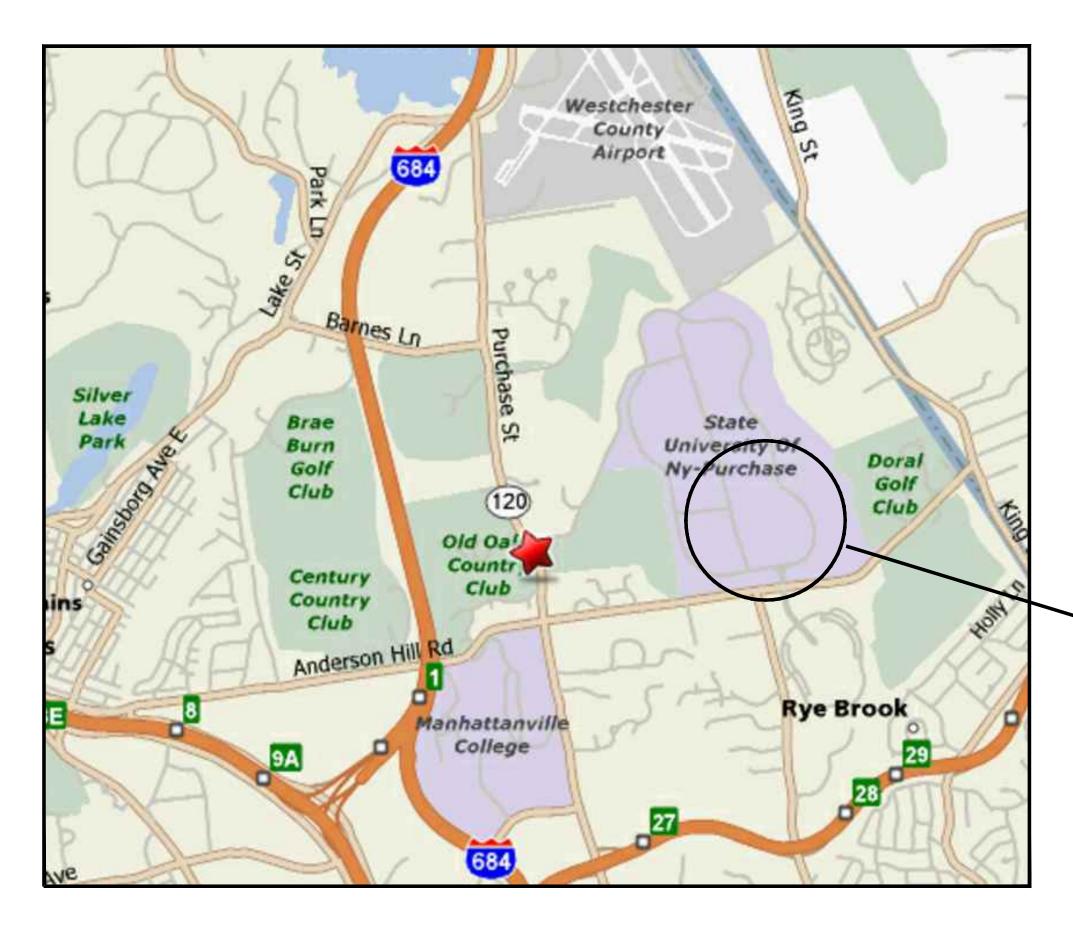

PROJECT LOCATION MAP



330 East State Street 2nd Floor Ithaca, NY 14850

p: 607-277-4000 f: 607-277-4004 www.thelagroup.com

People. Purpose. Place.

## DRAWING LIST:

TITLE SHEET

TOPOGRAPHIC SURVEY

SITE KEY PLAN

SITE DEMOLITION, LAYOUT PLAN AND GRADING PLAN

SITE DETAILS

SYNTHETIC TURF LINESTRIPING PLAN & DETAILS

PRESSBOX PLAN & DETAILS - ALTERNATE #1

PRESSBOX ELEVATIONS & DETAILS - ALTERNATE #1

ELECTRICAL PRESSBOX PLAN & DETAILS - ALTERNATE #1


**ELECTRICAL NOTES, ABBREVIATIONS, LEGEND & DETAILS** 


ELECTRICAL SITE LAYOUT PLAN


# LOCATION

## **PROJECT**


## **COMMON PATTERNS:**

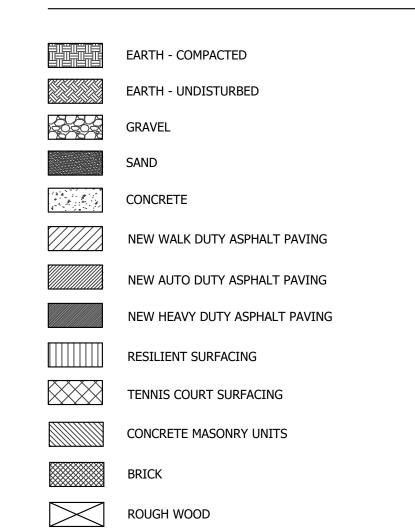


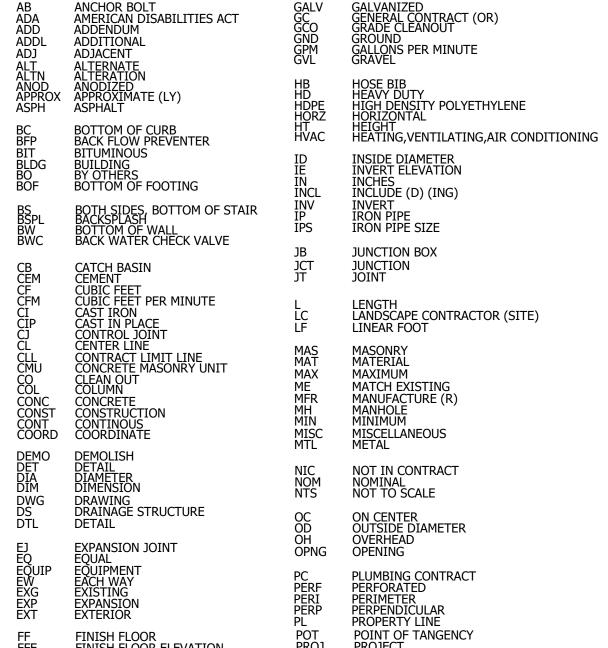

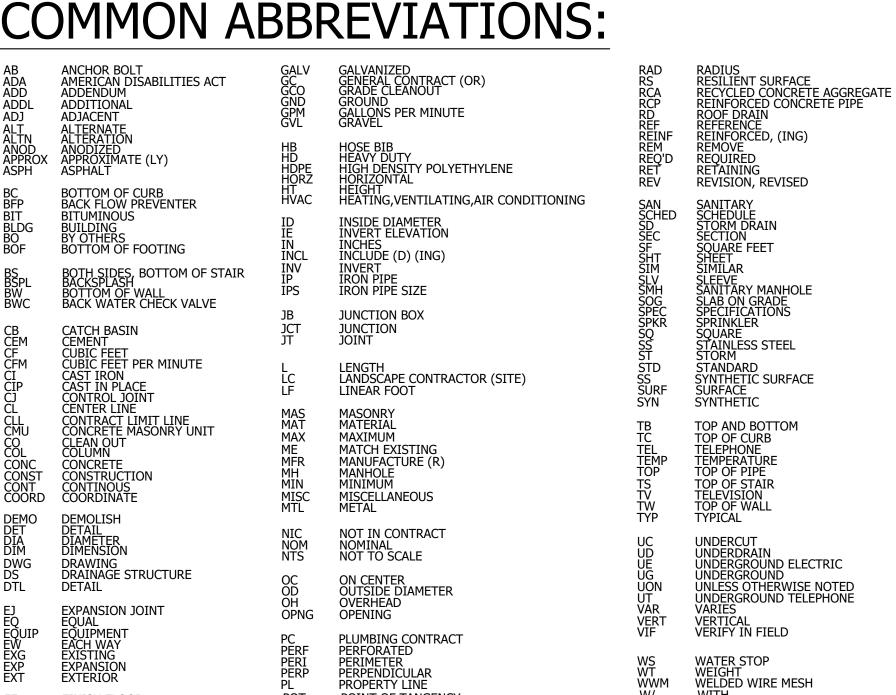


## COMMON SYMBOLS:

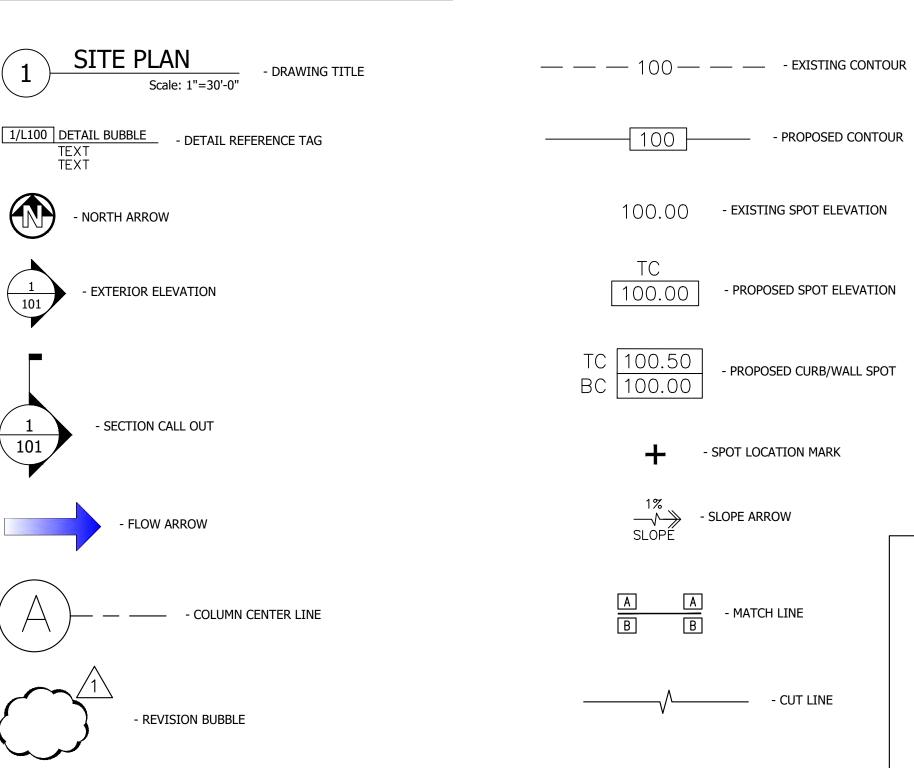

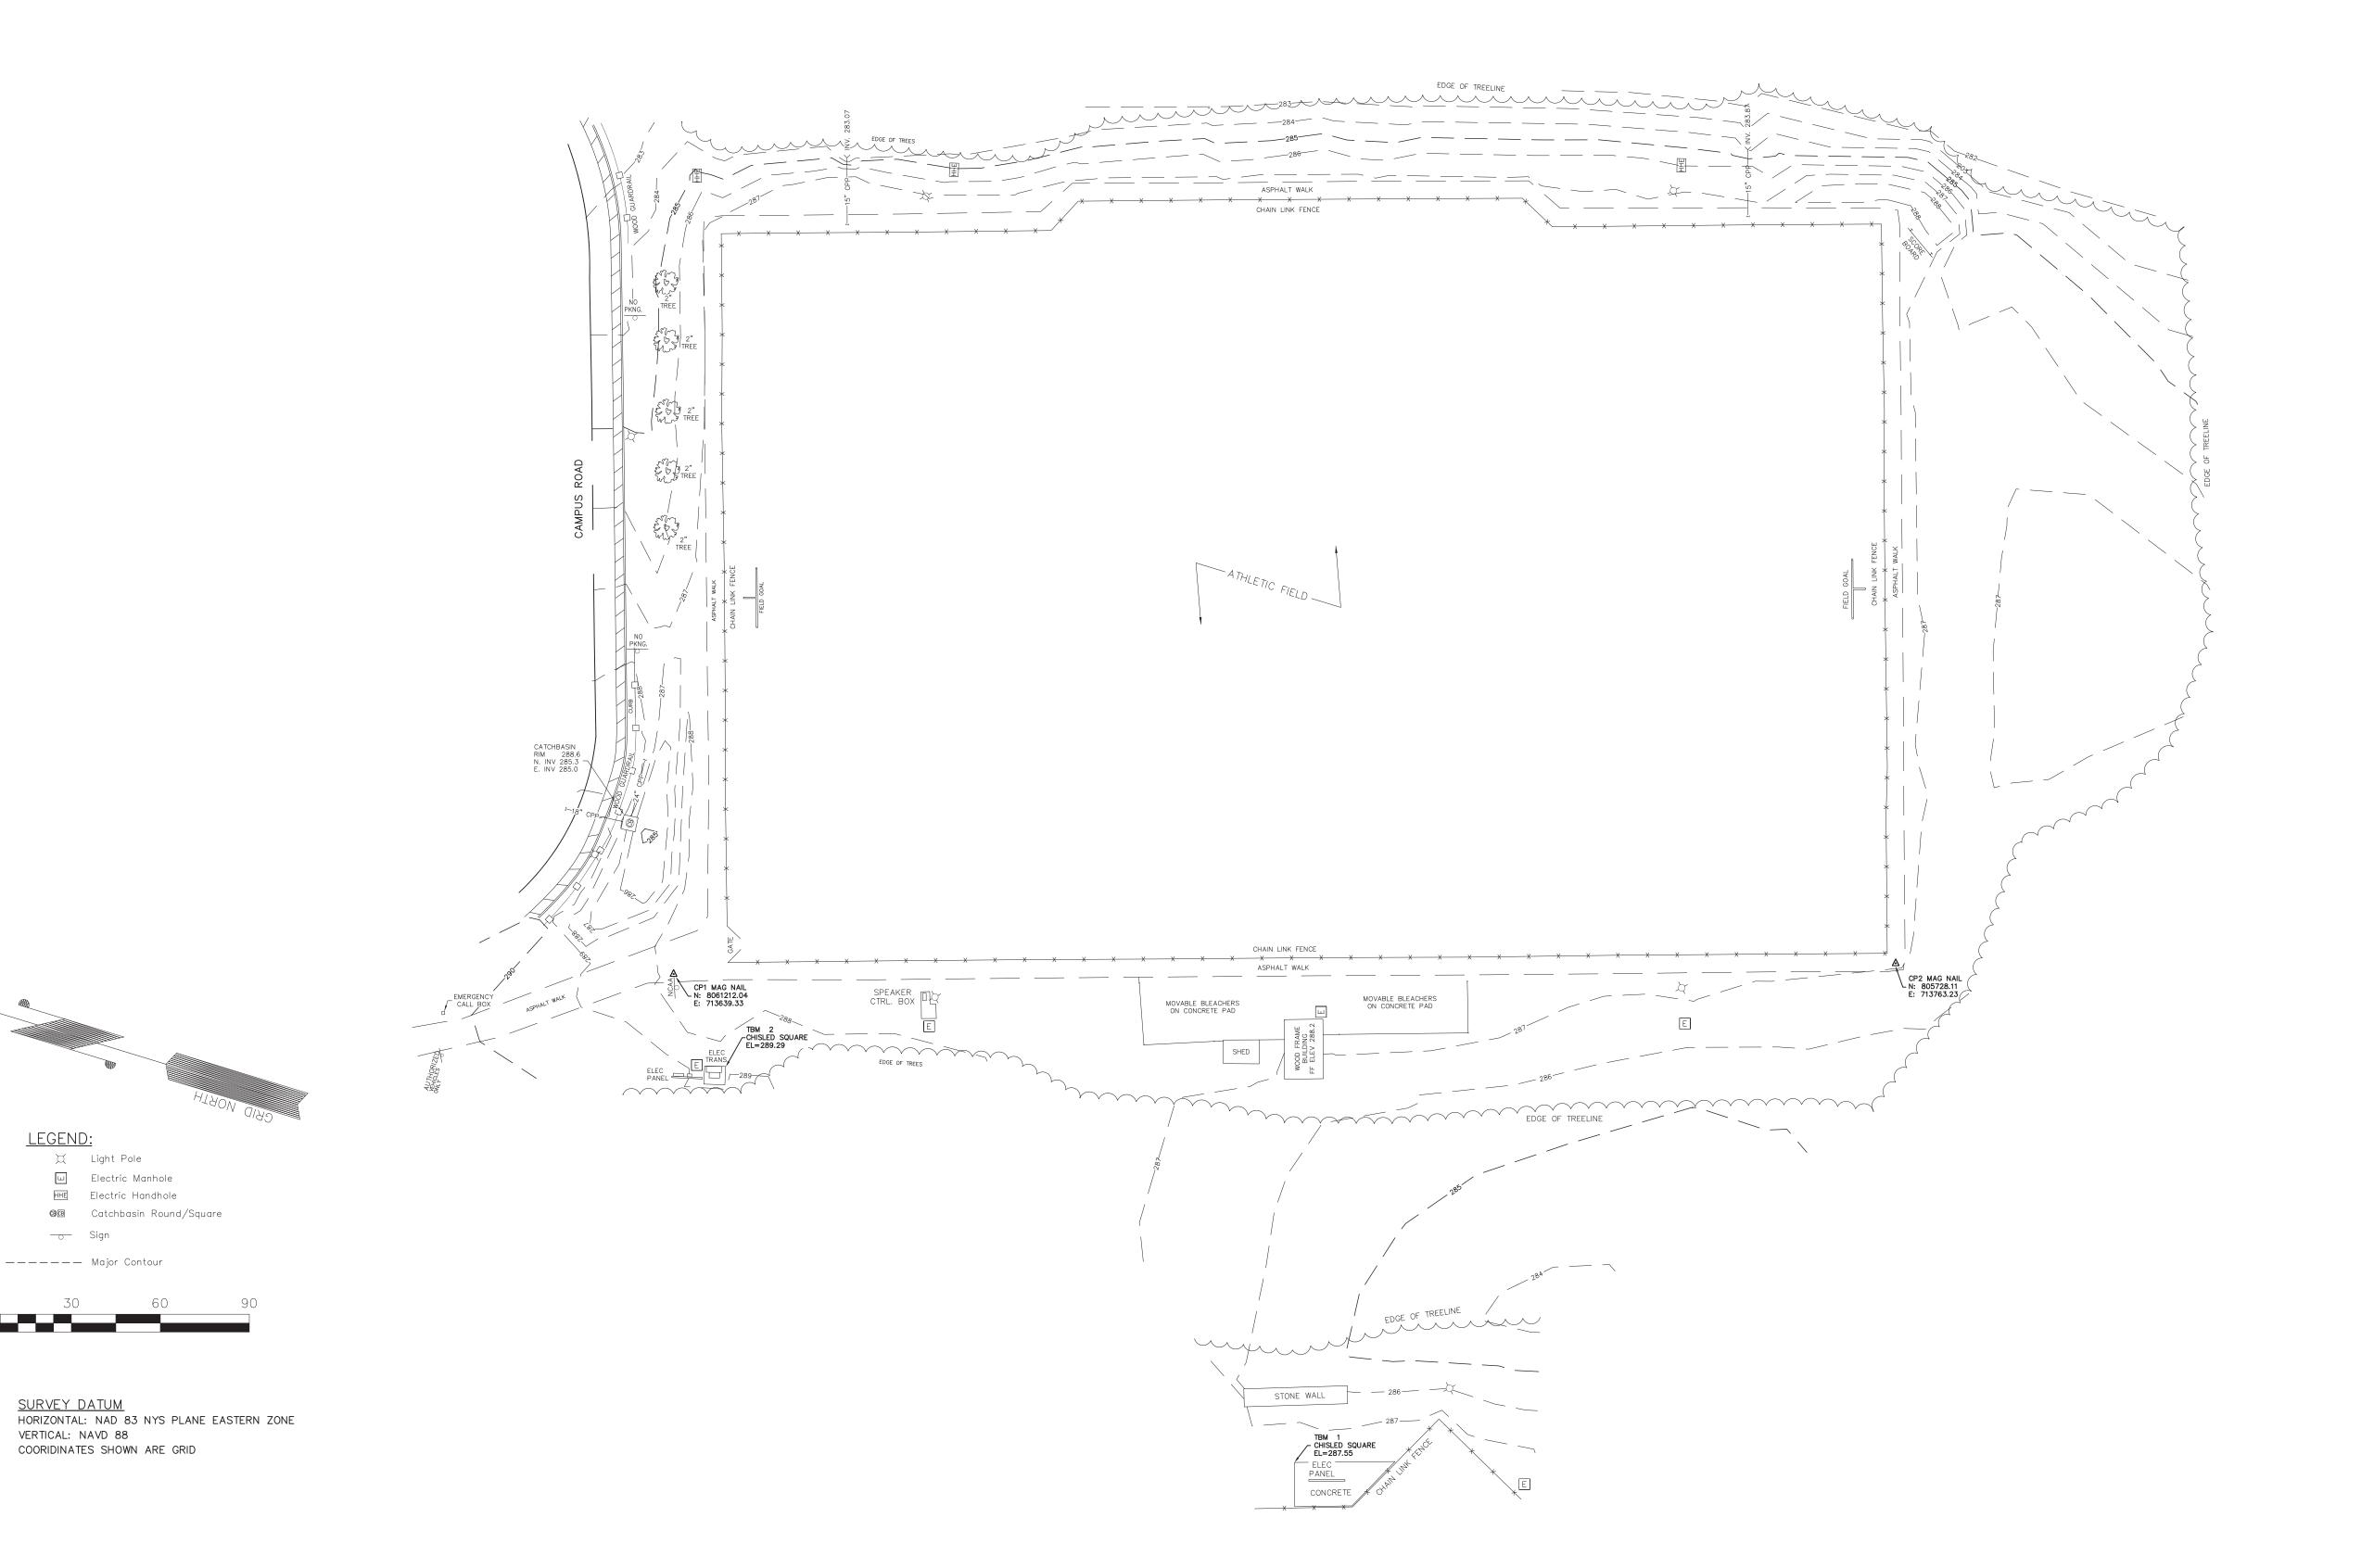

35 ANDERSON HILL RO PURCHASE, NY 10577

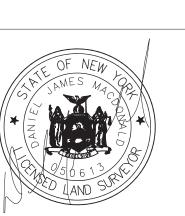

LEGEND:

💢 Light Pole Ш Electric Manhole HHE Electric Handhole

── Sign

————— Major Contour

©⊞ Catchbasin Round∕Square

- ALL SITE PLANS WERE PREPARED USING SURVEY INFORMATION OBTAINED FROM \_ SURVEYING, P.C. DATED \_ AND TITLED "TOPOGRAPHIC SURVEY" PREPARED FOR PURCHASE COLLEGE. ALL SURVEY DATA USED TO PREPARE THE SITE PLANS HAVE BEEN PROVIDED IN THIS SET FOR REFERENCE. SURVEY INTERPRETATIONS MADE BY THE CONTRACTOR ARE NOT THE RESPONSIBILITY OF THE OWNER, OR THE LA GROUP, PC. CONTRACTOR SHALL NOTIFY THE LANDSCAPE ARCHITECT OF ANY DISCREPANCIES BETWEEN SURVEY AND EXISTING CONDITIONS PRIOR TO THE START OF CONSTRUCTION. HORIZONTAL AND VERTICAL DATUM IS AS NOTED ON PROJECT SURVEY.
- THE CONTRACTOR SHALL ESTABLISH PERMANENT BENCH MARKS. MAINTAIN ALL ESTABLISHED BOUNDS AND BENCH MARKS AND REPLACE AS DIRECTED ANY WHICH ARE DISTURBED OR DESTROYED.
- CONTRACTORS SHALL VERIFY ALL EXISTING CONDITIONS AND DIMENSIONS IN FIELD PRIOR TO COMMENCEMENT OF WORK AND NOTIFY THE ARCHITECT OF ANY DISCREPANCIES IMMEDIATELY.

- 4. CONTRACT LIMIT LINE IS TEN FEET OUTSIDE THE LIMITS OF DISTURBANCE UNLESS NOTED OTHERWISE.
- 5. NO ATTEMPT HAS BEEN MADE TO SHOW ALL UNDERGROUND UTILITIES ON THESE DRAWINGS. DIG SAFELY NEW YORK AND LOCAL UTILITY COMPANIES AND AUTHORITIES SHOULD BE CONTACTED TO VERIFY THE LOCATION OF ALL UTILITIES PRIOR TO TRENCHING OR EXCAVATION OPERATIONS. ANY COSTS INCURRED BY THE CONTRACTOR DUE TO FAILURE TO CONTACT THE PROPER AUTHORITIES SHALL BECOME THE RESPONSIBILITY OF THE CONTRACTOR.
- 6. SEE SPECIFICATION SECTION 023000 SUBSURFACE INVESTIGATIONS FOR BORING LOCATIONS AND GEOTECHNICAL INFORMATION.
- 7. CONTRACTOR SHALL PROVIDE CONSTRUCTION AND PROTECTIVE FENCING OR OTHER MEANS NECESSARY TO PROTECT WORK AND TO ENSURE SAFETY OF PEDESTRIAN AND VEHICULAR TRAFFIC DURING CONSTRUCTION.
- 8. CONTRACTOR SHALL EMPLOY SPECIAL CARE IN SCHEDULING CONSTRUCTION SO AS TO MAINTAIN EXISTING VEHICULAR TRAFFIC PATTERNS, AND MINIMIZE DISRUPTION TO SURROUNDING PEDESTRIAN TRAFFIC. CONTRACTOR SHALL EMPLOY SPECIAL CARE TO PROTECT SAFETY OF PEDESTRIANS

INSIDE AND OUTSIDE OF THE LIMIT OF WORK LINE.

- 9. IT IS THE CONTRACTOR'S RESPONSIBILITY TO ENSURE ALL REQUIRED PERMITS FROM ALL JURISDICTIONS AFFECTED BY THIS WORK ARE IN PLACE PRIOR TO CONSTRUCTION. FOR PERMITS ALREADY ISSUED, CONTRACTOR SHALL OBTAIN COPIES OF PERMITS AND STRICTLY ADHERE TO PERMIT CONDITIONS. PERMITS THAT ARE OUTSTANDING SHALL BE SECURED BY THE CONTRACTOR AND COORDINATED WITH THE OWNER'S REPRESENTATIVE.
- 10. INSTALL SOIL AND EROSION CONTROL FACILITIES PRIOR TO START OF EARTHWORK OPERATIONS PER LOCAL GOVERNING SOIL AND WATER CONSERVATION AGENCY RECOMMENDATIONS AND STANDARDS.
- 11. ALL ALTERATIONS TO THESE DRAWINGS MADE IN THE FIELD DURING CONSTRUCTION SHALL BE RECORDED BY THE CONTRACTOR ON "AS-BUILT DRAWINGS," AS SPECIFIED.
- 12. STORAGE AREAS FOR THE GENERAL CONTRACTOR'S EQUIPMENT AND MATERIALS SHALL BE LOCATED WITHIN THE LIMITS OF WORK AS SHOWN ON THE PLANS OR AS APPROVED BY THE OWNER'S REPRESENTATIVE.
- 13. SHOULD ANYTHING BE OMITTED FROM THE PLANS WHICH IS NECESSARY FOR A COMPLETE UNDERSTANDING OF THE WORK, OR SHALL ANY ERROR APPEAR IN THE VARIOUS INSTRUMENTS FURNISHED OR IN THE WORK BY OTHER CONTRACTORS AFFECTING THE WORK COVERED HEREBY, THE CONTRACTOR SHALL AND WILL PROMPTLY NOTIFY THE OWNER'S REPRESENTATIVE, AND IN THE EVENT OF THE CONTRACTOR'S FAILURE TO DO SO, HE SHALL AND WILL MAKE GOOD OF ANY DAMAGE OR DEFECT IN HIS WORK CAUSED THEREBY.
- 14. CONTRACTOR SHALL MAINTAIN THE INTEGRITY OF ALL EXISTING INFRASTRUCTURE FOR THE DURATION OF CONSTRUCTION. CONTRACTOR SHALL PROTECT AND SUSTAIN IN NORMAL SERVICE ALL EXISTING UTILITIES, STRUCTURES, EQUIPMENT, ROADWAYS AND DRIVEWAYS.
- 15. THE CONTRACTOR SHALL BE RESPONSIBLE TO COORDINATE HIS EFFORTS OF DEMOLITION, REMOVALS AND OR RELOCATION WORK WITH ALL TRADES, IF APPLICABLE. CONSULT ALL DRAWINGS AND SPECIFICATIONS FOR COORDINATION REQUIREMENTS BEFORE COMMENCING CONSTRUCTION.
- 16. CONTRACTOR TO COMPLY WITH ALL OSHA AND OTHER STATE AND LOCAL SAFETY REQUIREMENTS DURING CONSTRUCTION.
- 17. CONTRACTOR SHALL MAINTAIN PROPER SIGNS, BARRICADES, FENCES, TO PROPERLY PROTECT THE WORK, EQUIPMENT, PERSONS AND PROPERTY FROM DAMAGE. ALL DAILY TRAFFIC IN THE VICINITY OF THE SITE SHALL NOT BE IMPEDED.



Ch'k'd: Date: January 17, 2019 Scale:

•	2 000p 0.0	- 410.
•		

SU-111618

Purchase College

Purchase College Athletic Field Complex- Multi-Field Synthetic Turf Replacement

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State University of

Purchase College Purchase, New York 10577

New York State Education Law.

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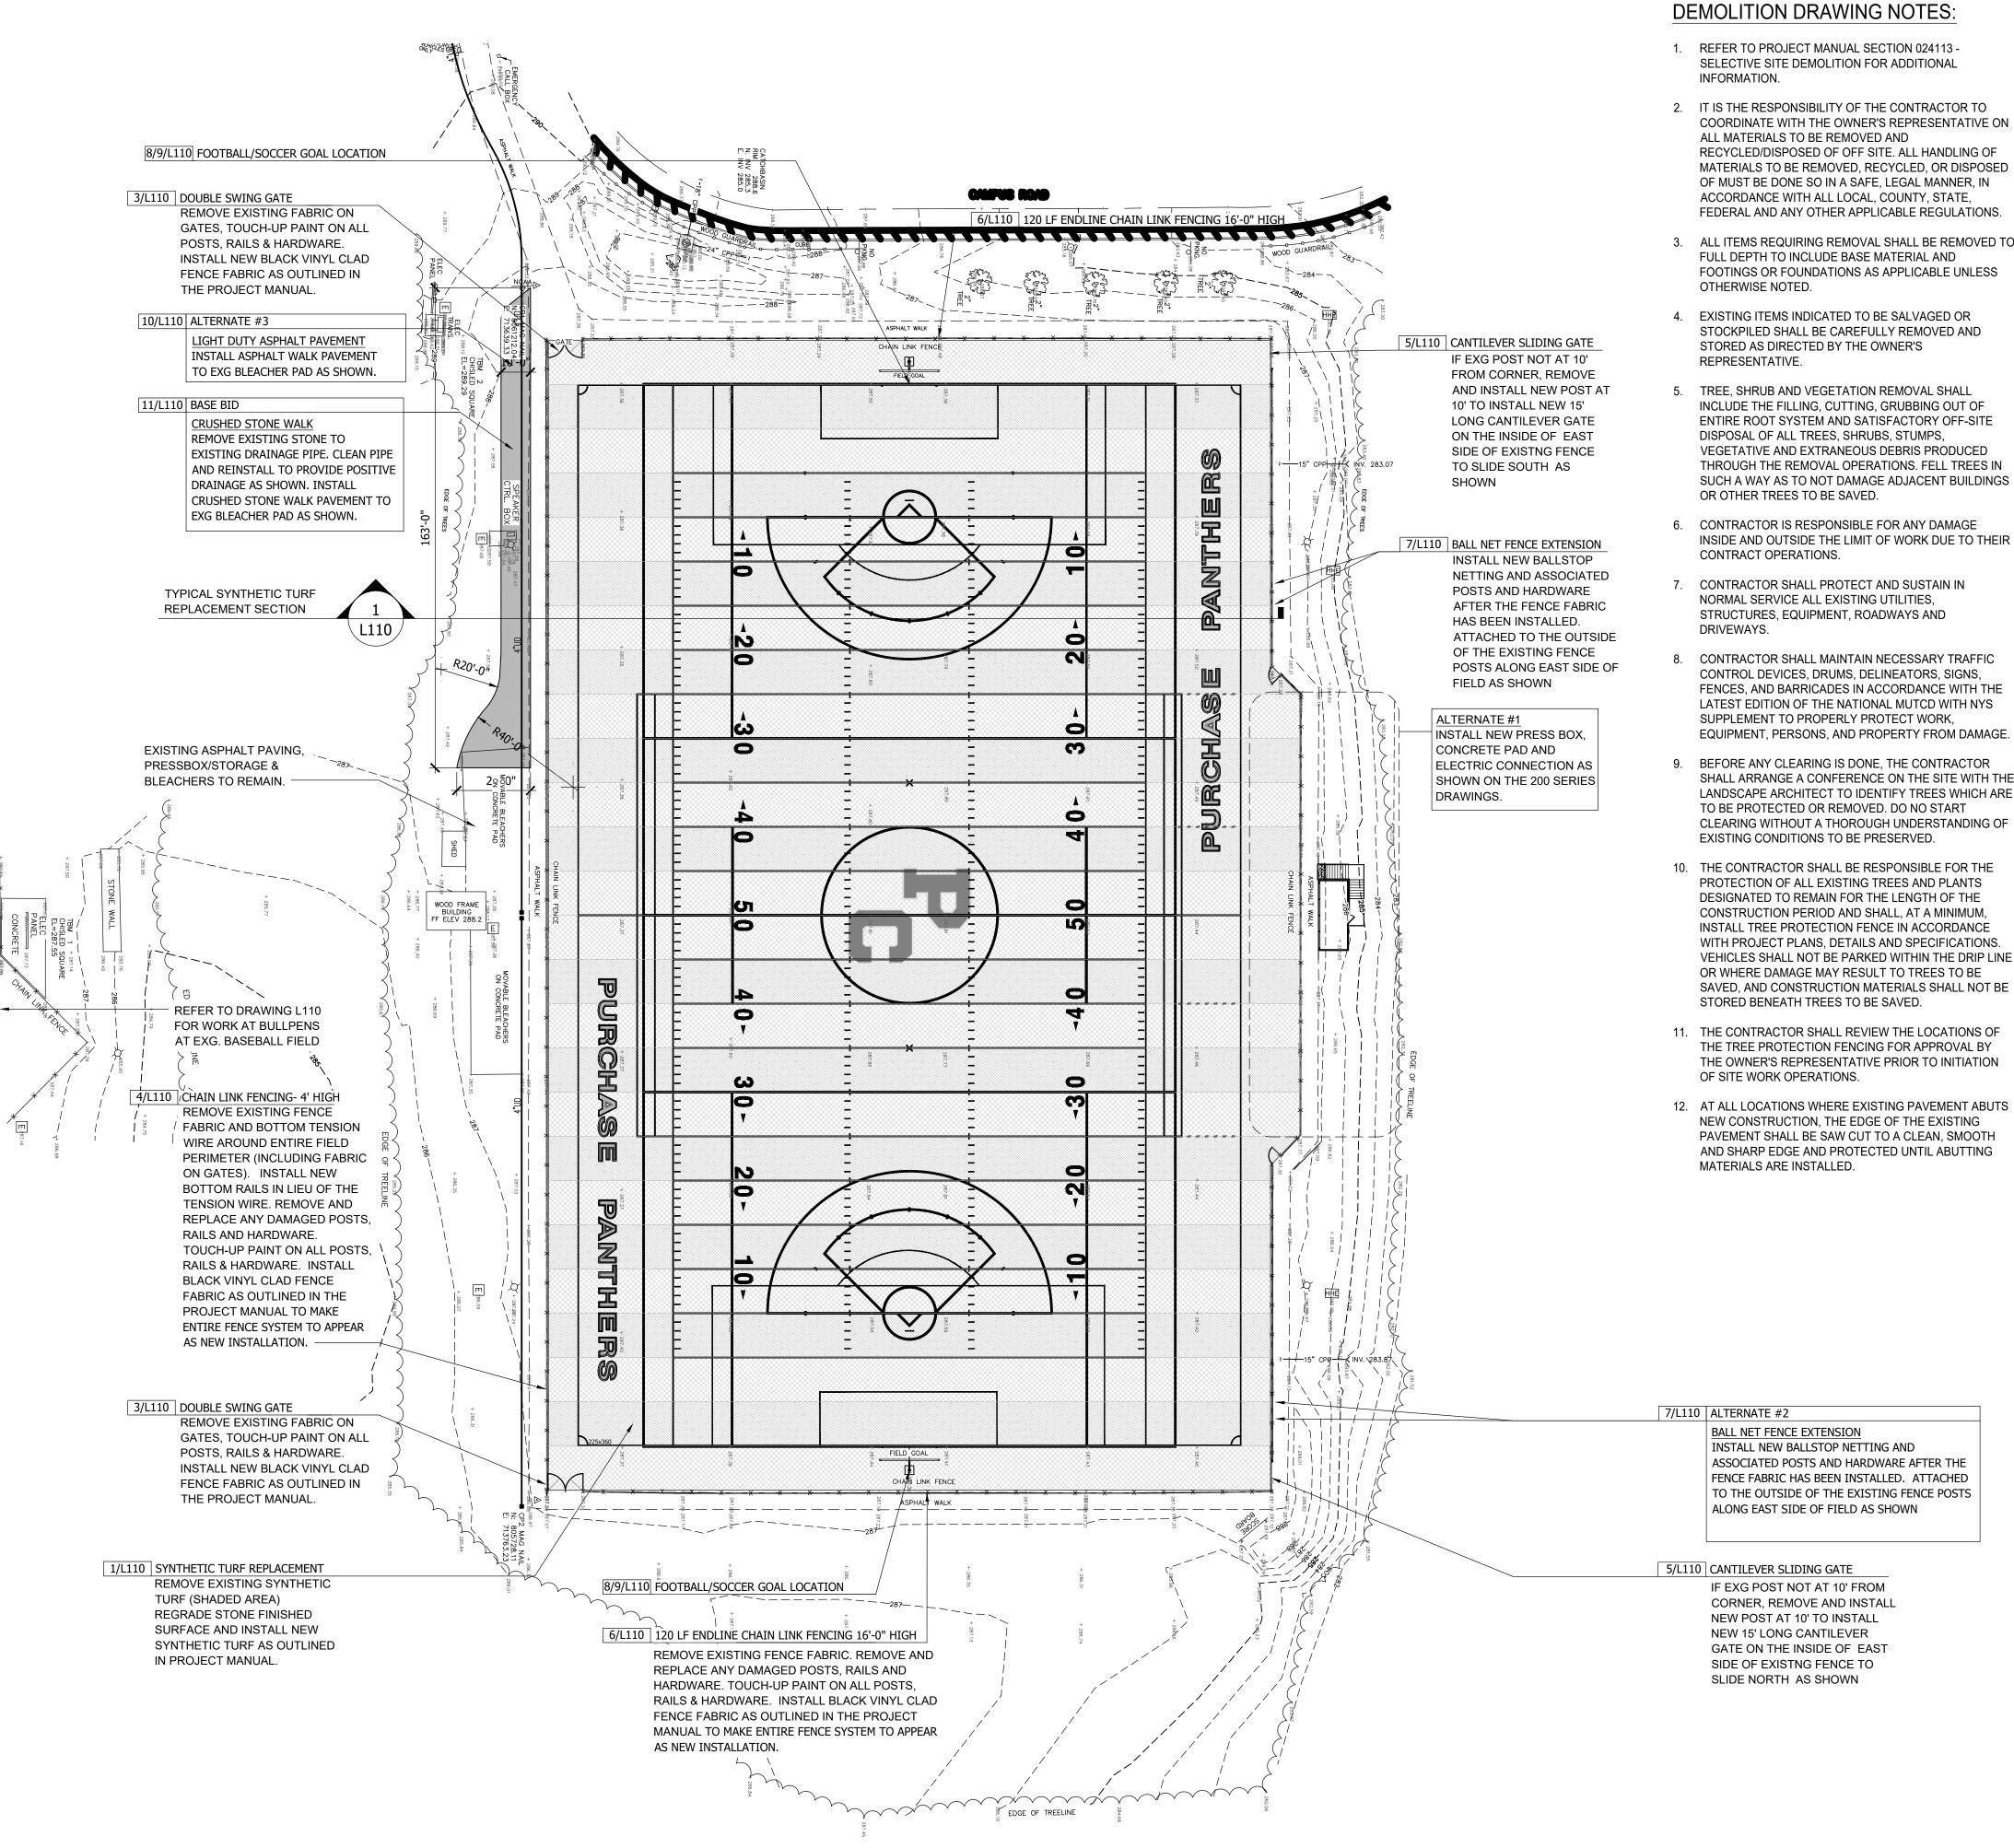
New York

Drawing Title

SITE KEY PLAN

Drawing No.

L100



#### **DEMOLITION DRAWING NOTES:**

- SELECTIVE SITE DEMOLITION FOR ADDITIONAL
- 2. IT IS THE RESPONSIBILITY OF THE CONTRACTOR TO COORDINATE WITH THE OWNER'S REPRESENTATIVE ON RECYCLED/DISPOSED OF OFF SITE. ALL HANDLING OF MATERIALS TO BE REMOVED, RECYCLED, OR DISPOSED OF MUST BE DONE SO IN A SAFE, LEGAL MANNER, IN ACCORDANCE WITH ALL LOCAL, COUNTY, STATE, FEDERAL AND ANY OTHER APPLICABLE REGULATIONS.
- . ALL ITEMS REQUIRING REMOVAL SHALL BE REMOVED TO FULL DEPTH TO INCLUDE BASE MATERIAL AND FOOTINGS OR FOUNDATIONS AS APPLICABLE UNLESS
- 4. EXISTING ITEMS INDICATED TO BE SALVAGED OR STOCKPILED SHALL BE CAREFULLY REMOVED AND
- TREE, SHRUB AND VEGETATION REMOVAL SHALL INCLUDE THE FILLING, CUTTING, GRUBBING OUT OF ENTIRE ROOT SYSTEM AND SATISFACTORY OFF-SITE DISPOSAL OF ALL TREES, SHRUBS, STUMPS, VEGETATIVE AND EXTRANEOUS DEBRIS PRODUCED THROUGH THE REMOVAL OPERATIONS. FELL TREES IN SUCH A WAY AS TO NOT DAMAGE ADJACENT BUILDINGS
- 6. CONTRACTOR IS RESPONSIBLE FOR ANY DAMAGE INSIDE AND OUTSIDE THE LIMIT OF WORK DUE TO THEIR
- 7. CONTRACTOR SHALL PROTECT AND SUSTAIN IN NORMAL SERVICE ALL EXISTING UTILITIES. STRUCTURES, EQUIPMENT, ROADWAYS AND
- 8. CONTRACTOR SHALL MAINTAIN NECESSARY TRAFFIC CONTROL DEVICES, DRUMS, DELINEATORS, SIGNS, FENCES, AND BARRICADES IN ACCORDANCE WITH THE LATEST EDITION OF THE NATIONAL MUTCD WITH NYS SUPPLEMENT TO PROPERLY PROTECT WORK, EQUIPMENT, PERSONS, AND PROPERTY FROM DAMAGE.
- 9. BEFORE ANY CLEARING IS DONE, THE CONTRACTOR SHALL ARRANGE A CONFERENCE ON THE SITE WITH THE LANDSCAPE ARCHITECT TO IDENTIFY TREES WHICH ARE TO BE PROTECTED OR REMOVED. DO NO START CLEARING WITHOUT A THOROUGH UNDERSTANDING OF EXISTING CONDITIONS TO BE PRESERVED.
- THE CONTRACTOR SHALL BE RESPONSIBLE FOR THE PROTECTION OF ALL EXISTING TREES AND PLANTS DESIGNATED TO REMAIN FOR THE LENGTH OF THE CONSTRUCTION PERIOD AND SHALL, AT A MINIMUM INSTALL TREE PROTECTION FENCE IN ACCORDANCE WITH PROJECT PLANS, DETAILS AND SPECIFICATIONS. VEHICLES SHALL NOT BE PARKED WITHIN THE DRIP LINE OR WHERE DAMAGE MAY RESULT TO TREES TO BE SAVED, AND CONSTRUCTION MATERIALS SHALL NOT BE
- 11. THE CONTRACTOR SHALL REVIEW THE LOCATIONS OF THE TREE PROTECTION FENCING FOR APPROVAL BY THE OWNER'S REPRESENTATIVE PRIOR TO INITIATION
- NEW CONSTRUCTION, THE EDGE OF THE EXISTING PAVEMENT SHALL BE SAW CUT TO A CLEAN, SMOOTH AND SHARP EDGE AND PROTECTED UNTIL ABUTTING

ASSOCIATED POSTS AND HARDWARE AFTER THE FENCE FABRIC HAS BEEN INSTALLED. ATTACHED TO THE OUTSIDE OF THE EXISTING FENCE POSTS

### LAYOUT PLAN GENERAL NOTES:

- 1. REFER TO DRAWING L100 FOR ADDITIONAL GENERAL NOTE INFORMATION.
  - 2. ALL LINE AND GRADE INFORMATION SHALL BE LAID OUT BY A NEW YORK STATE REGISTERED SURVEYOR ENGAGED BY THE CONTRACTOR.
  - ALL NEW WORK SHALL BE STAKED OUT PRIOR TO CONSTRUCTION. THE OWNER'S REPRESENTATIVE SHALL BE NOTIFIED OF ANY DISCREPANCIES. FIELD ADJUSTMENTS MUST BE APPROVED BY THE OWNER'S REPRESENTATIVE PRIOR TO CONSTRUCTION.
  - ALL LINES AND DIMENSIONS ARE PARALLEL OR PERPENDICULAR TO THE LINES FROM WHICH THEY ARE MEASURED UNLESS OTHERWISE NOTED.
- 5. DIMENSIONS TO CURBS ARE FROM FACE OR BOTTOM OF CURB TO FACE OR BOTTOM OF CURB.
- 6. FIELD ADJUSTMENTS MUST BE APPROVED BY THE OWNER'S REPRESENTATIVE AND IF NECESSARY APPROPRIATE MUNICIPAL OFFICIALS.
- 7. ALL LAYOUTS FOR WALKS AND PATHS SHALL BE ADEQUATELY STAKED BY THE CONTRACTOR AND APPROVED BY THE OWNER'S REPRESENTATIVE PRIOR TO CONSTRUCTION.
- 3. ALL PROPOSED WALKS, PAVEMENTS, LIGHTS AND SITE IMPROVEMENTS SHALL BE STAKED IN THE FIELD FOR APPROVAL BY THE OWNER'S REPRESENTATIVE PRIOR TO CONSTRUCTION.
- CONTRACTOR SHALL COORDINATE LOCATION OF ALL UTILITIES (LINES, DUCTS, CONDUITS, SLEEVES, FOOTINGS, ETC.) WITH LOCATIONS OF PROPOSED LANDSCAPE ELEMENTS (WALLS, FENCE, FOOTINGS, TREE ROOTBALLS, PROPOSED LIGHTING FOOTINGS, ETC.). CONTRACTOR SHALL REPORT ANY DISCREPANCIES TO OWNER'S REPRESENTATIVE PRIOR TO CONTINUING WORK.
- ALL EXISTING UTILITIES ARE SHOWN IN THEIR RELATIVE POSITION. CONTRACTOR IS RESPONSIBLE FOR VERIFYING THE VERTICAL & HORIZONTAL POSITION OF EXISTING UTILITIES PRIOR TO CONSTRUCTION.

### **UTILITY NOTES:**

- NO ATTEMPT HAS BEEN MADE TO SHOW ALL UNDERGROUND UTILITIES ON THESE DRAWINGS. DIG SAFELY NEW YORK AND LOCAL UTILITY COMPANIES AND AUTHORITIES SHOULD BE CONTACTED TO VERIFY THE LOCATION OF ALL UTILITIES PRIOR TO TRENCHING OR EXCAVATION OPERATIONS. ANY COSTS INCURRED BY THE CONTRACTOR DUE TO FAILURE TO CONTACT THE PROPER AUTHORITIES SHALL BECOME THE RESPONSIBILITY OF THE CONTRACTOR.
- 2. THE LOCATIONS OF ALL UNDERGROUND UTILITIES SHOWN ON THIS PLAN ARE DIAGRAMMATIC ONLY. CONTRACTOR SHALL COORDINATE LOCATION OF ALL UTILITIES (LINES, DUCTS, CONDUITS, SLEEVES, FOOTINGS, ETC.) WITH LOCATIONS OF PROPOSED LANDSCAPE ELEMENTS (WALLS, FENCE, FOOTINGS, TREE ROOTBALLS, PROPOSED LIGHTING FOOTINGS, ETC.). EXCAVATION REQUIRED WITHIN PROXIMITY OF UTILITY LINES SHALL BE DONE BY HAND. ANY DAMAGE AND INCURRED COSTS DUE TO FAILURE OF THE CONTRACTOR TO CONTACT THE PROPER AUTHORITIES SHALL BE BORNE BY THE CONTRACTOR.
- 3. CONTRACTOR SHALL MAINTAIN THE INTEGRITY OF ALL EXISTING INFRASTRUCTURE FOR THE DURATION OF CONSTRUCTION. CONTRACTOR SHALL PROTECT AND SUSTAIN IN NORMAL SERVICE ALL EXISTING UTILITIES, STRUCTURES, EQUIPMENT, ROADWAYS AND DRIVEWAYS.

#### **GRADING NOTES:**

- EXISTING BASE INFORMATION DERIVED FROM FIELD SURVEY DATED 8/21/18 PERFORMED BY PATRIOT DESIGN & CONSULTING.
- 2. CONTRACTOR SHALL ESTABLISH PERMANENT SECONDARY BENCHMARKS PRIOR TO THE START OF CONSTRUCTION. ALL SECONDARY BENCHMARKS SHALL BE SO LOCATED THAT THEY WILL NOT BE DISTURBED BY CONSTRUCTION.
- 3. FOR INFORMATION REGARDING SUBSURFACE CONDITIONS AT TEST BORING LOCATIONS, SEE PROJECT MANUAL SECTION: 02 30 00-SUBSURFACE INVESTIGATION.
- ALL PROPOSED GRADES SHALL BE SET IN THE FIELD BY A NEW YORK STATE LICENSED LAND SURVEYOR.
- PITCH EVENLY BETWEEN SPOT GRADES. ALL PAVED AREAS MUST PITCH TO DRAIN AT A MINIMUM SLOPE OF ONE-EIGHTH INCH (1/8") PER FOOT. MAXIMUM CROSSPITCH OF ALL SIDEWALKS IS 25 ANY DISCREPANCIES NOT ALLOWING THIS TO OCCUR SHALL BE REPORTED TO THE OWNER'S REPRESENTATIVE PRIOR TO CONTINUING WORK
- **EXCAVATION REQUIRED WITHIN 3 FEET OF** EXISTING UTILITY LINE SHALL BE DONE BY HAND. CONTRACTOR SHALL REPAIR ANY DAMAGE TO EXISTING UTILITY LINES OR STRUCTURES INCURRED DURING CONSTRUCTION OPERATIONS AT NO ADDITIONAL COST TO OWNER.
- 7. ALL AREAS REQUIRING FILL SHALL BE BROUGHT TO GRADE REQUIRED IN 6" MAXIMUM COMPACTED LIFTS. GENERAL FILL SHALL BE FREE OF DELETERIOUS MATERIAL, CONTAIN NO GRAVEL LARGER THAN 2", AND SHALL BE COMPACTED IN AN APPROVED MANNER.
- GRADE AREAS ADJACENT TO BUILDING LINES TO DRAIN AWAY FROM STRUCTURE AND PREVENT PONDING. FINISH SURFACES SHALL BE FREE FROM IRREGULAR SURFACE CHANGES.
- EXCAVATION REQUIRED WITHIN DRIP LINE OF TREES DESIGNATED TO REMAIN SHALL BE DONE BY HAND. PLANT MATERIALS DAMAGED BY CONTRACTOR SHALL BE REPLACED IN KIND.
- 10. SLOPE SIDES OF EXCAVATIONS TO COMPLY WITH LOCAL CODES AND ORDINANCES HAVING JURISDICTION AND OSHA REGULATIONS. MAINTAIN SIDE SLOPES OF EXCAVATIONS IN A SAFE CONDITION UNTIL COMPLETION OF BACKFILLING.
- 11. THE GENERAL CONTRACTOR SHALL MAINTAIN OR ADJUST TO NEW FINISH GRADE AS NECESSARY ALL UTILITY AND SITE STRUCTURES SUCH AS LIGHT POLES, SIGN POLES, MANHOLES, CATCH BASINS HAND HOLES, WATER AND GAS GATES, HYDRANTS, ETC., FROM MAINTAINED UTILITY AND SITE SYSTEMS UNLESS OTHERWISE NOTED ON THE UTILITY DRAWINGS OR AS DIRECTED BY THE OWNER'S REPRESENTATIVE.
- 12. CONTRACTOR SHALL BLEND NEW EARTHWORK SMOOTHLY INTO EXISTING, PROVIDING VERTICAL CURVES OR ROUNDINGS AT ALL TOP AND BOTTOM OF SLOPES.
- 13. CONTRACTOR SHALL MAINTAIN THE INTEGRITY OF THE EXISTING DRAINAGE SYSTEM AT ALL TIMES. DURING EARTHWORK OPERATIONS, DRAINAGE OF THE SITE AND ADJACENT AREAS SHALL BE MAINTAINED CONTINUOUSLY TO PREVENT EROSION OR DAMAGE RESULTING FROM CONCENTRATED RUN-OFF. WHEN IT IS NECESSARY TO INTERRUPT THE EXISTING DRAINAGE PATTERNS AND/OR UTILITIES. PROVIDE TEMPORARY FACILITIES UNTIL WORK IS PERMANENTLY STABILIZED AND APPROVED BY OWNER'S REPRESENTATIVE.
- 14. TOPSOIL SHALL BE STRIPPED FROM "CUT AREAS" TO FULL DEPTH AND STOCKPILED AT LOCATIONS AGREED UPON AT PRECONSTRUCTION MEETING. MECHANICALLY SCREENED, THEN REDISTRIBUTED DURING FINAL GRADING OPERATIONS.
- 15. ALL ON SITE TOPSOIL SHALL BE MECHANICALLY SCREENED BEFORE USE. REFER TO PROJECT MANUAL SECTION 31 20 00 - EARTH MOVING FOR ADDITIONAL INFORMATION.
- 16. SPREAD ALL TOPSOIL FROM STRIPPING OPERATION TO A MINIMUM DEPTH OF 6" OVER ALL AREAS OF SITE WHERE EARTH HAS BEEN EXPOSED BY EXCAVATING, CUTTING, FILLING OR GRADING EXCEPT WHERE ASPHALT OR CONCRETE PAVING IS REQUIRED.
- 17. AFTER FINE GRADING IS COMPLETED, INFORM OWNER AND A/E SO THAT AN INSPECTION OF THE FINE GRADING CAN TAKE PLACE BEFORE SEEDING IS BEGUN.
- 18. THE CONTRACTOR SHALL FIELD VERIFY EXISTING TOPOGRAPHY PRIOR TO COMMENCEMENT OF EARTHWORK OPERATION. ANY ELEVATIONAL DISCREPANCIES WHICH WILL AFFECT THE WORK REQUIRED AS PART OF THE CONTRACT DOCUMENTS SHALL BE IMMEDIATELY REPORTED TO THE ARCHITECT. COMMENCEMENT OF WORK WITHOUT THIS WRITTEN NOTIFICATION SHALL CONSTITUTE CONTRACTOR ACCEPTANCE OF THE EXISTING TOPOGRAPHY INDICATED ON THE DRAWINGS AS ACCURATE. NO ADJUSTMENTS TO THE CONTRACT WILL BE MADE FOR THE DISCREPANCIES BROUGHT TO THE OWNER'S ATTENTION AFTER WORK HAS BEGUN.



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Prepared for: State University of New York Purchase College

Purchase, New York 10577



Project Title:

State University of New York Purchase College

Purchase ,New York 10577 Purchase College Athletic Field Complex- Multi-Field

Synthetic Turf Replacement


Project No.: SU-111618 Ch'k'd: Date: January 17, 2019 Scale: 1"=30' Description:


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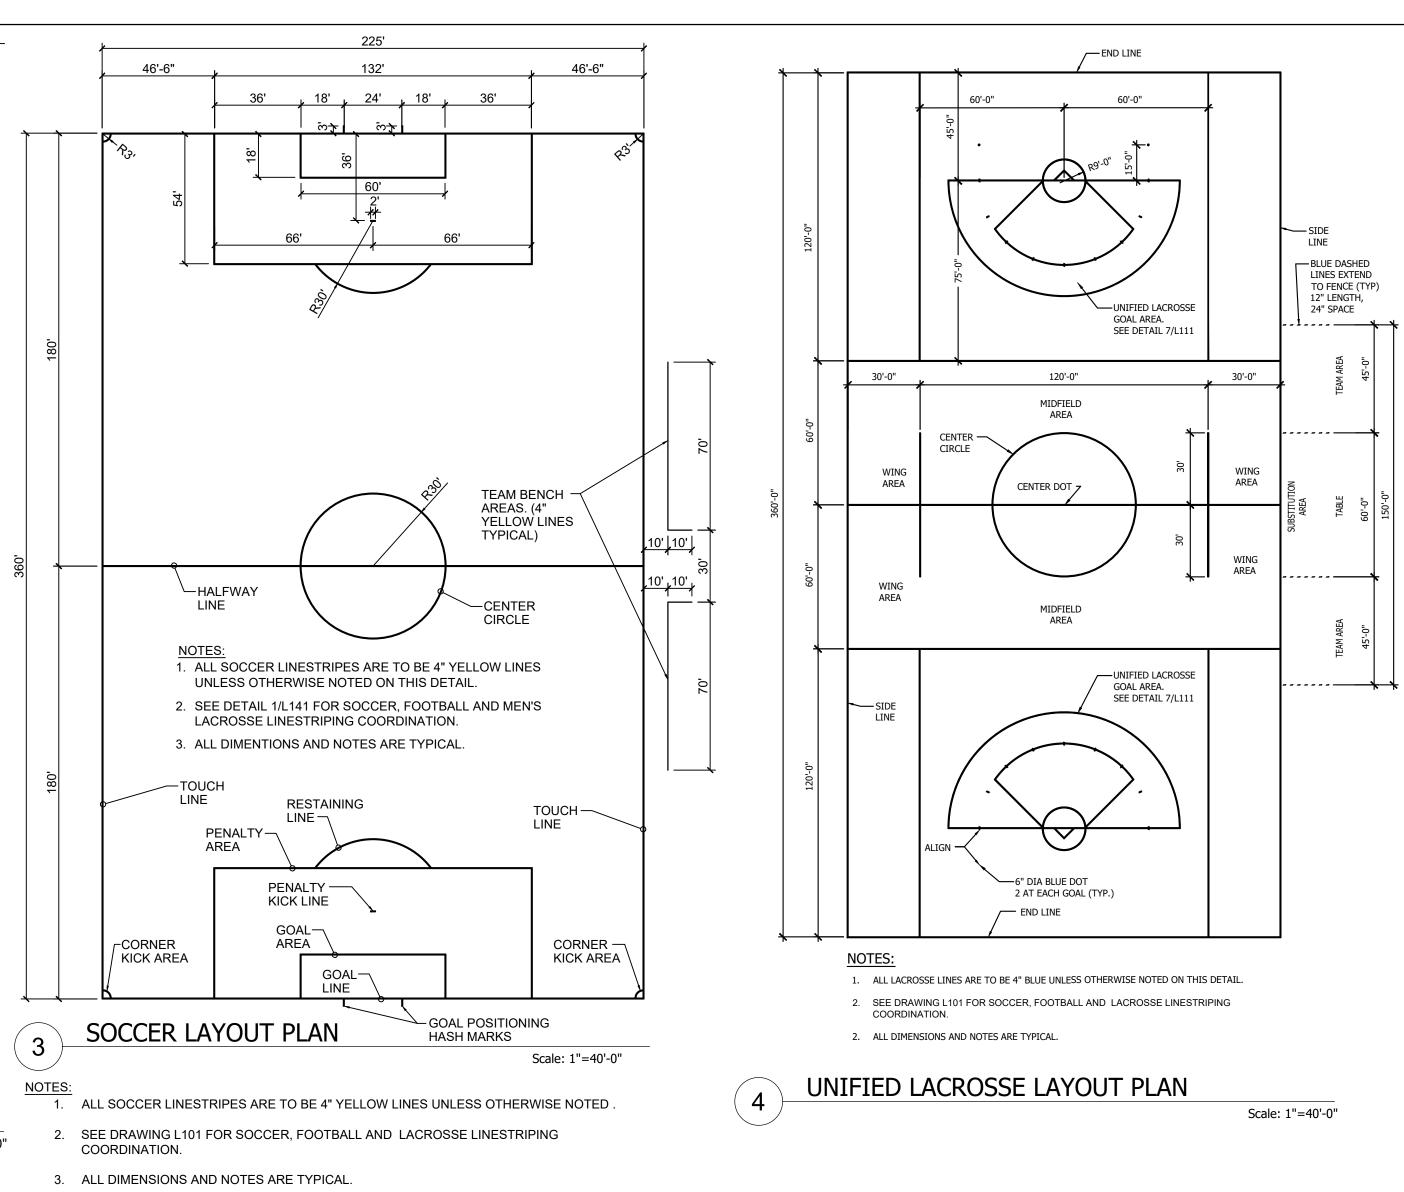
SITE DEMOLITION, LAYOUT PLAN AND **GRADING PLAN** 

Drawing No.

L101



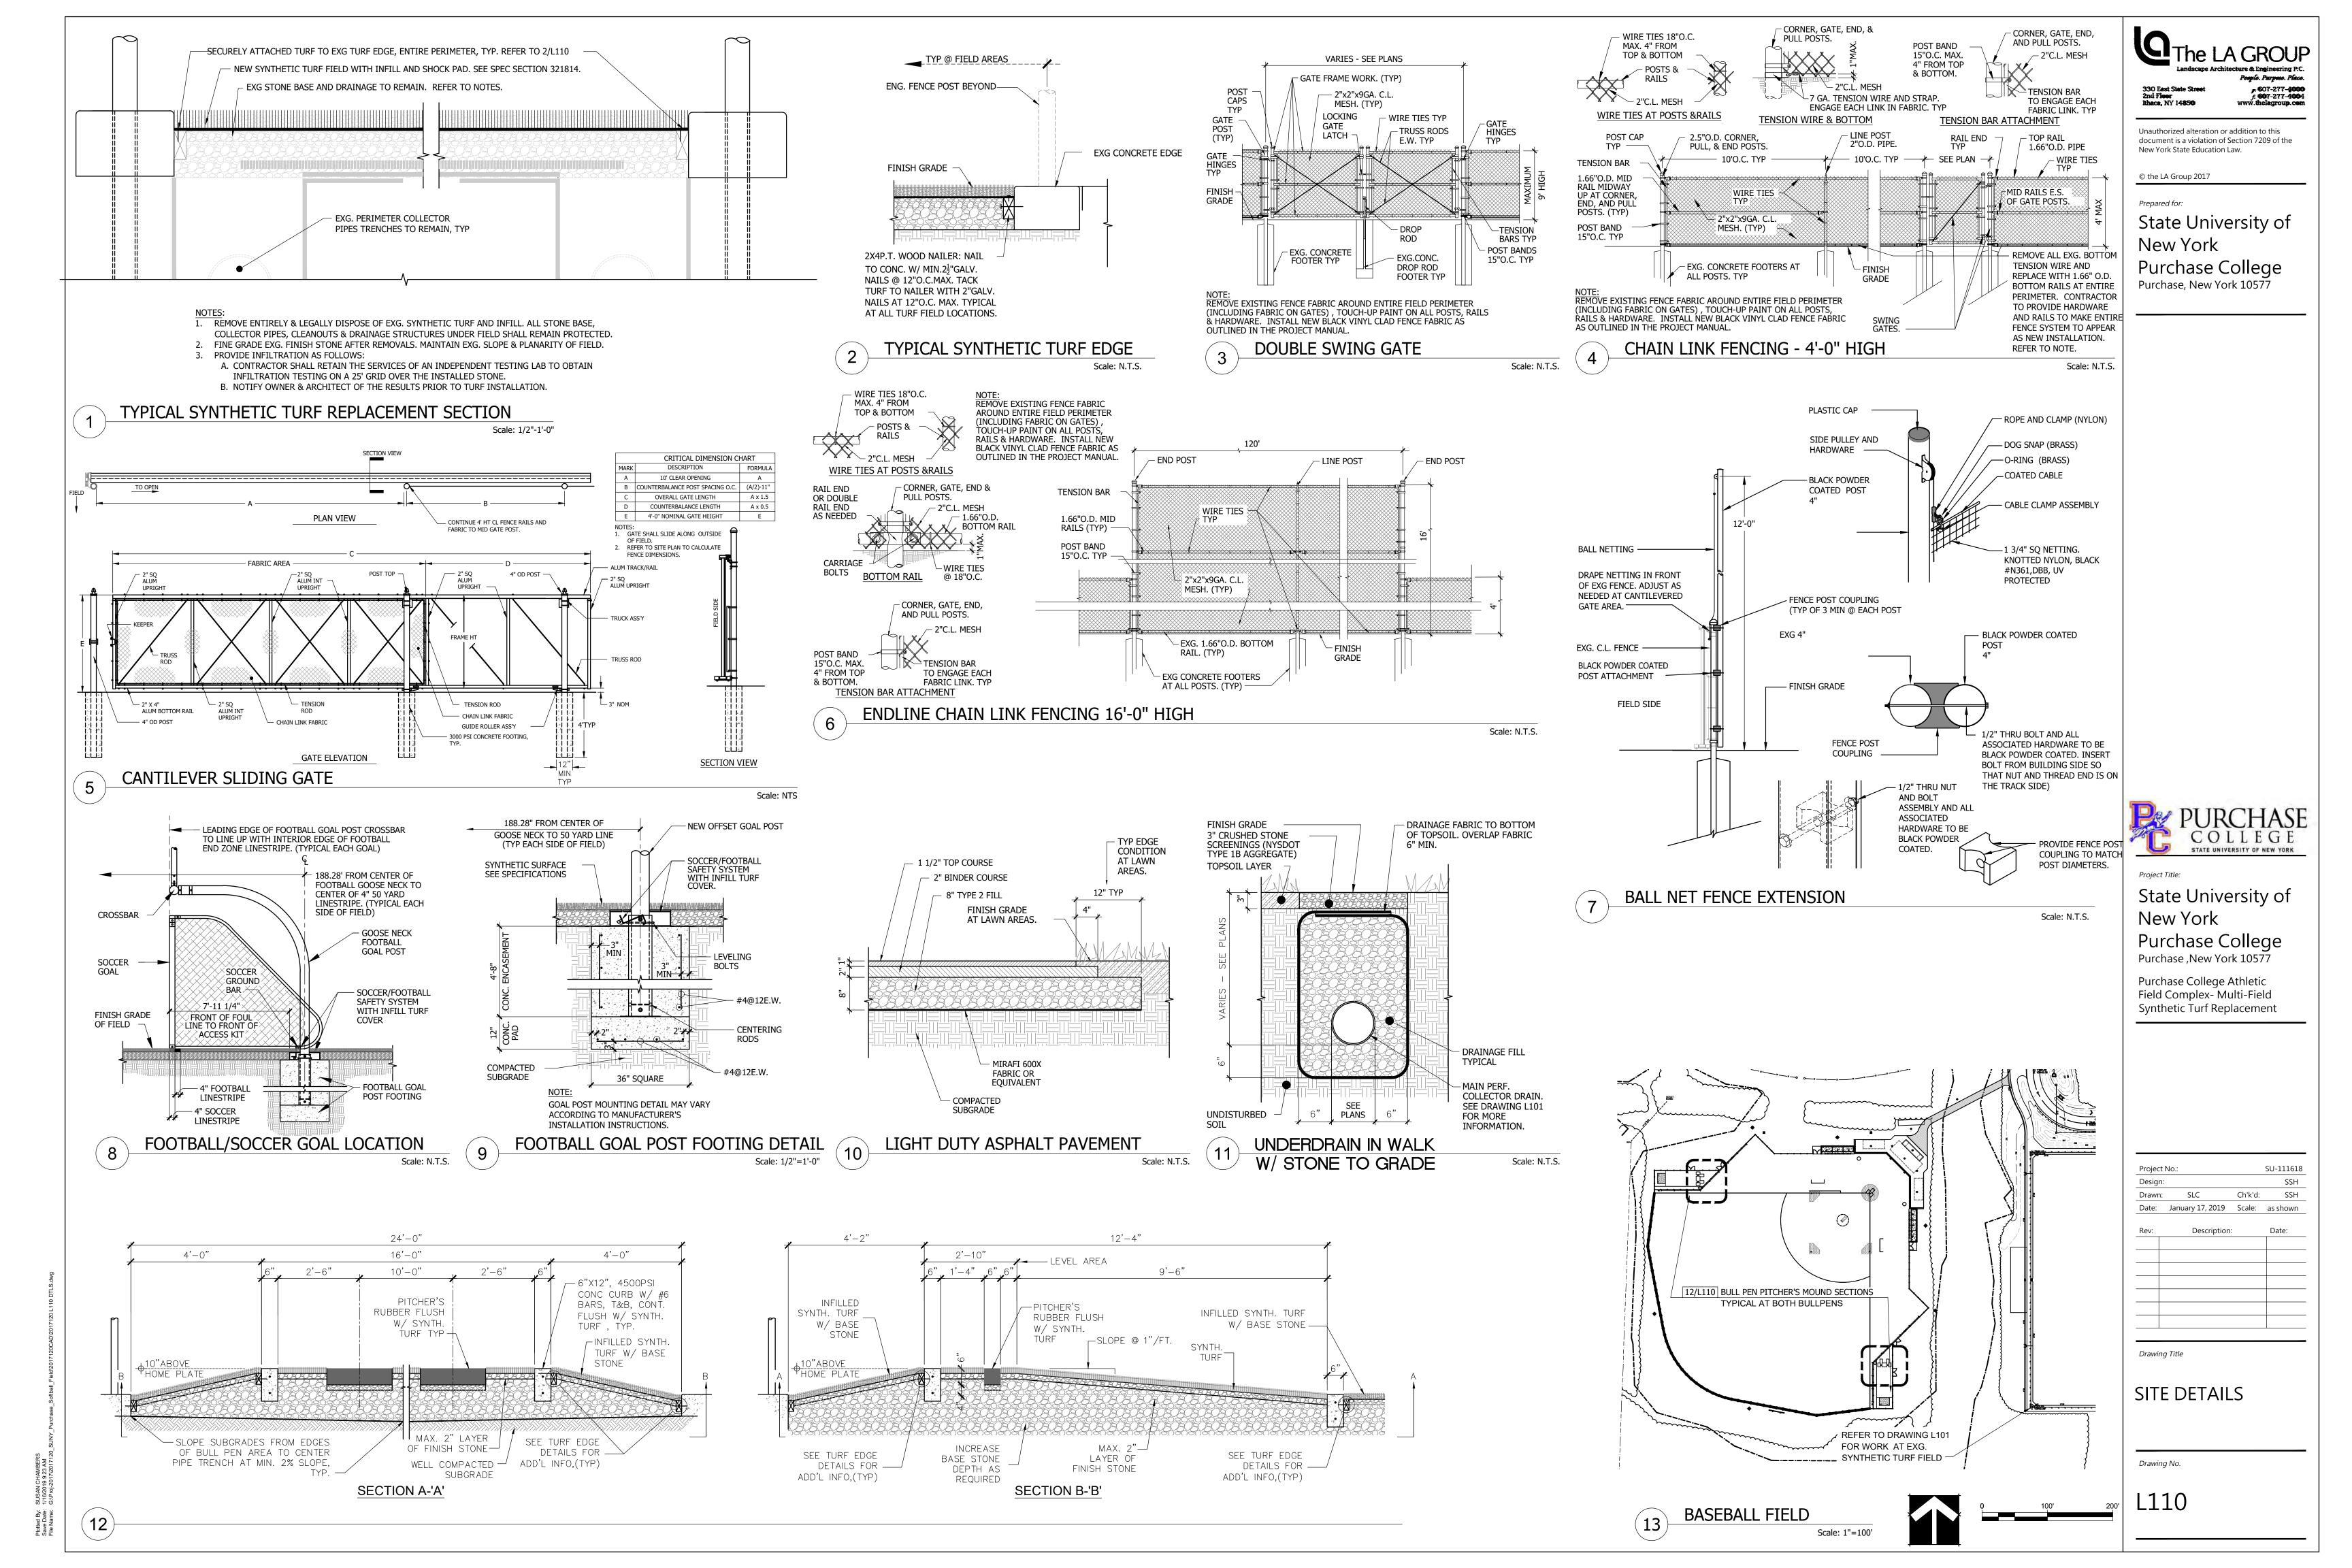

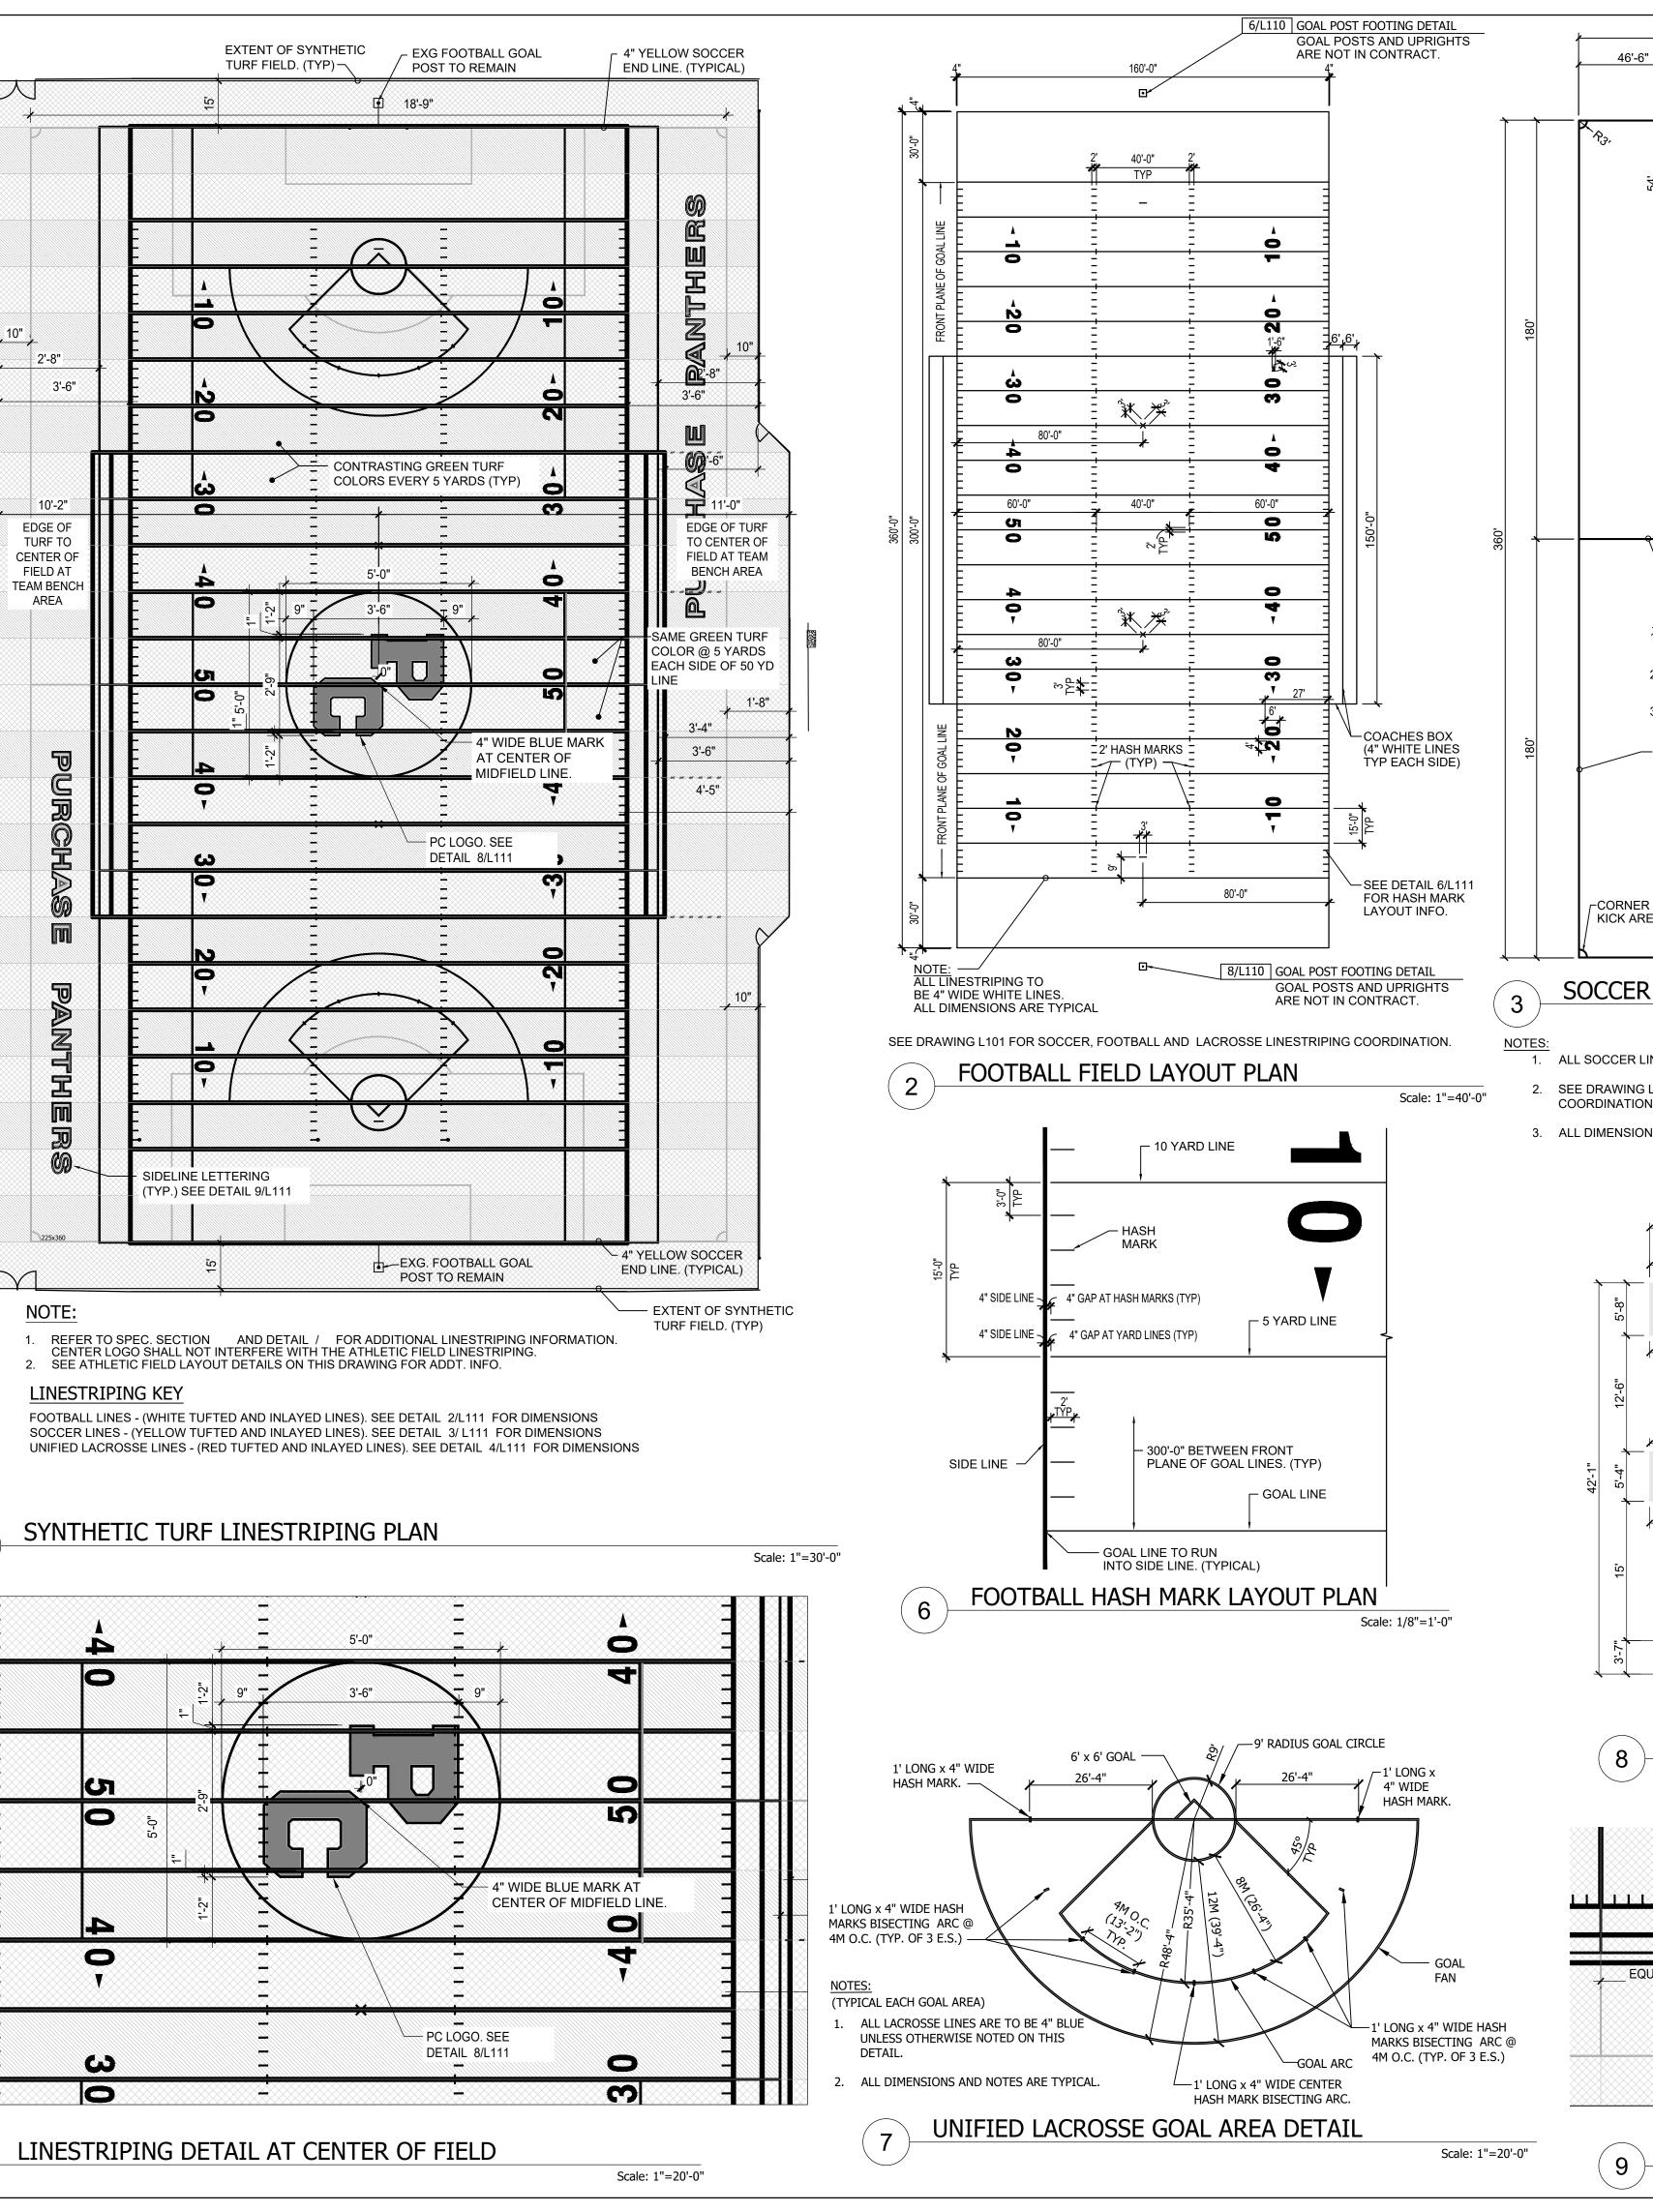

LINESTRIPE COLOR KEY:

(BLUE LINES)

NOTES:

- OUTER LINES IN LOGO ARE TO BE A 6" WIDE WHITE

COLOR CHOSEN BY OWNER)

- INNER PORTIONS OF LOGO ARE TO BE ROYAL BLUE

INLAYED LINES. (EXACT

INLAYED LINES AS

1. LOGO IS TO BE PART OF ALTERNATE#L1.

LOGO LINES ARE NOT TO OBLITERATE THE ATHLETIC FIELD LINESTRIPING AS

SHOWN ON THIS DRAWING.

DIMENSIONED. (EXACT

COLOR CHOSEN BY OWNER)



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Purchase College

Purchase, New York 10577

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New York

Prepared for:

Project Title:

State University of New York

Purchase College Purchase ,New York 10577


Purchase College Athletic Field Complex- Multi-Field Synthetic Turf Replacement

SU-111618 Ch'k'd: Date: January 17, 2019 Scale: as shown Description:

Drawing Title

SYNTHETIC TURF LINESTRIPING PLAN & DETAILS

Drawing No.

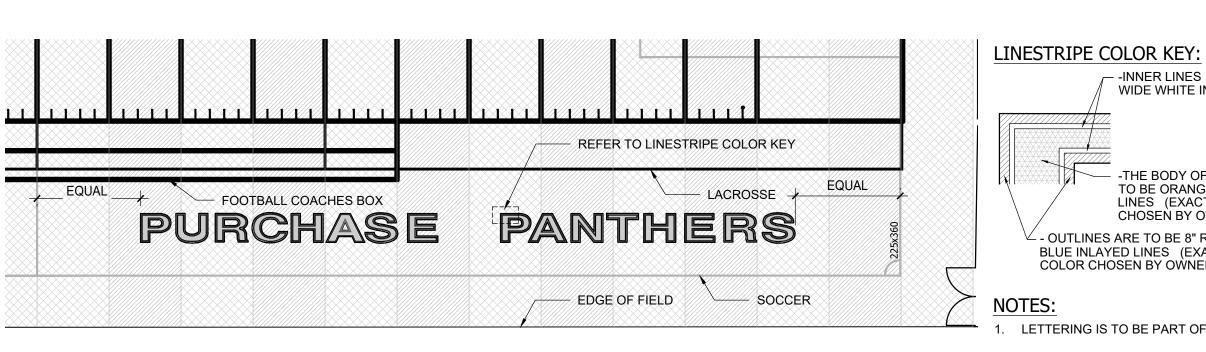

Scale: 1"=10'-0"

- -THE BODY OF THE LETTERS TO BE ORANGE INLAYED LINES (EXACT COLOR CHOSEN BY OWNER)  $\stackrel{/}{-}$  - OUTLINES ARE TO BE 8" ROYAL BLUE INLAYED LINES (EXACT COLOR CHOSEN BY OWNER)

-INNER LINES ARE TO BE 4" WIDE WHITE INLAYED LINES.

LETTERING IS TO BE PART OF ALTERNATE#L1.


LETTERING @ SIDELINES


LOGO AT CENTER FIELD


16'-7"


Scale: 1"=20'-0"


2. LETTERING IS BASED ON TRUTYPE FONT SWIS721. EXACT FONT STYLE TO BE CHOSEN BY OWNER

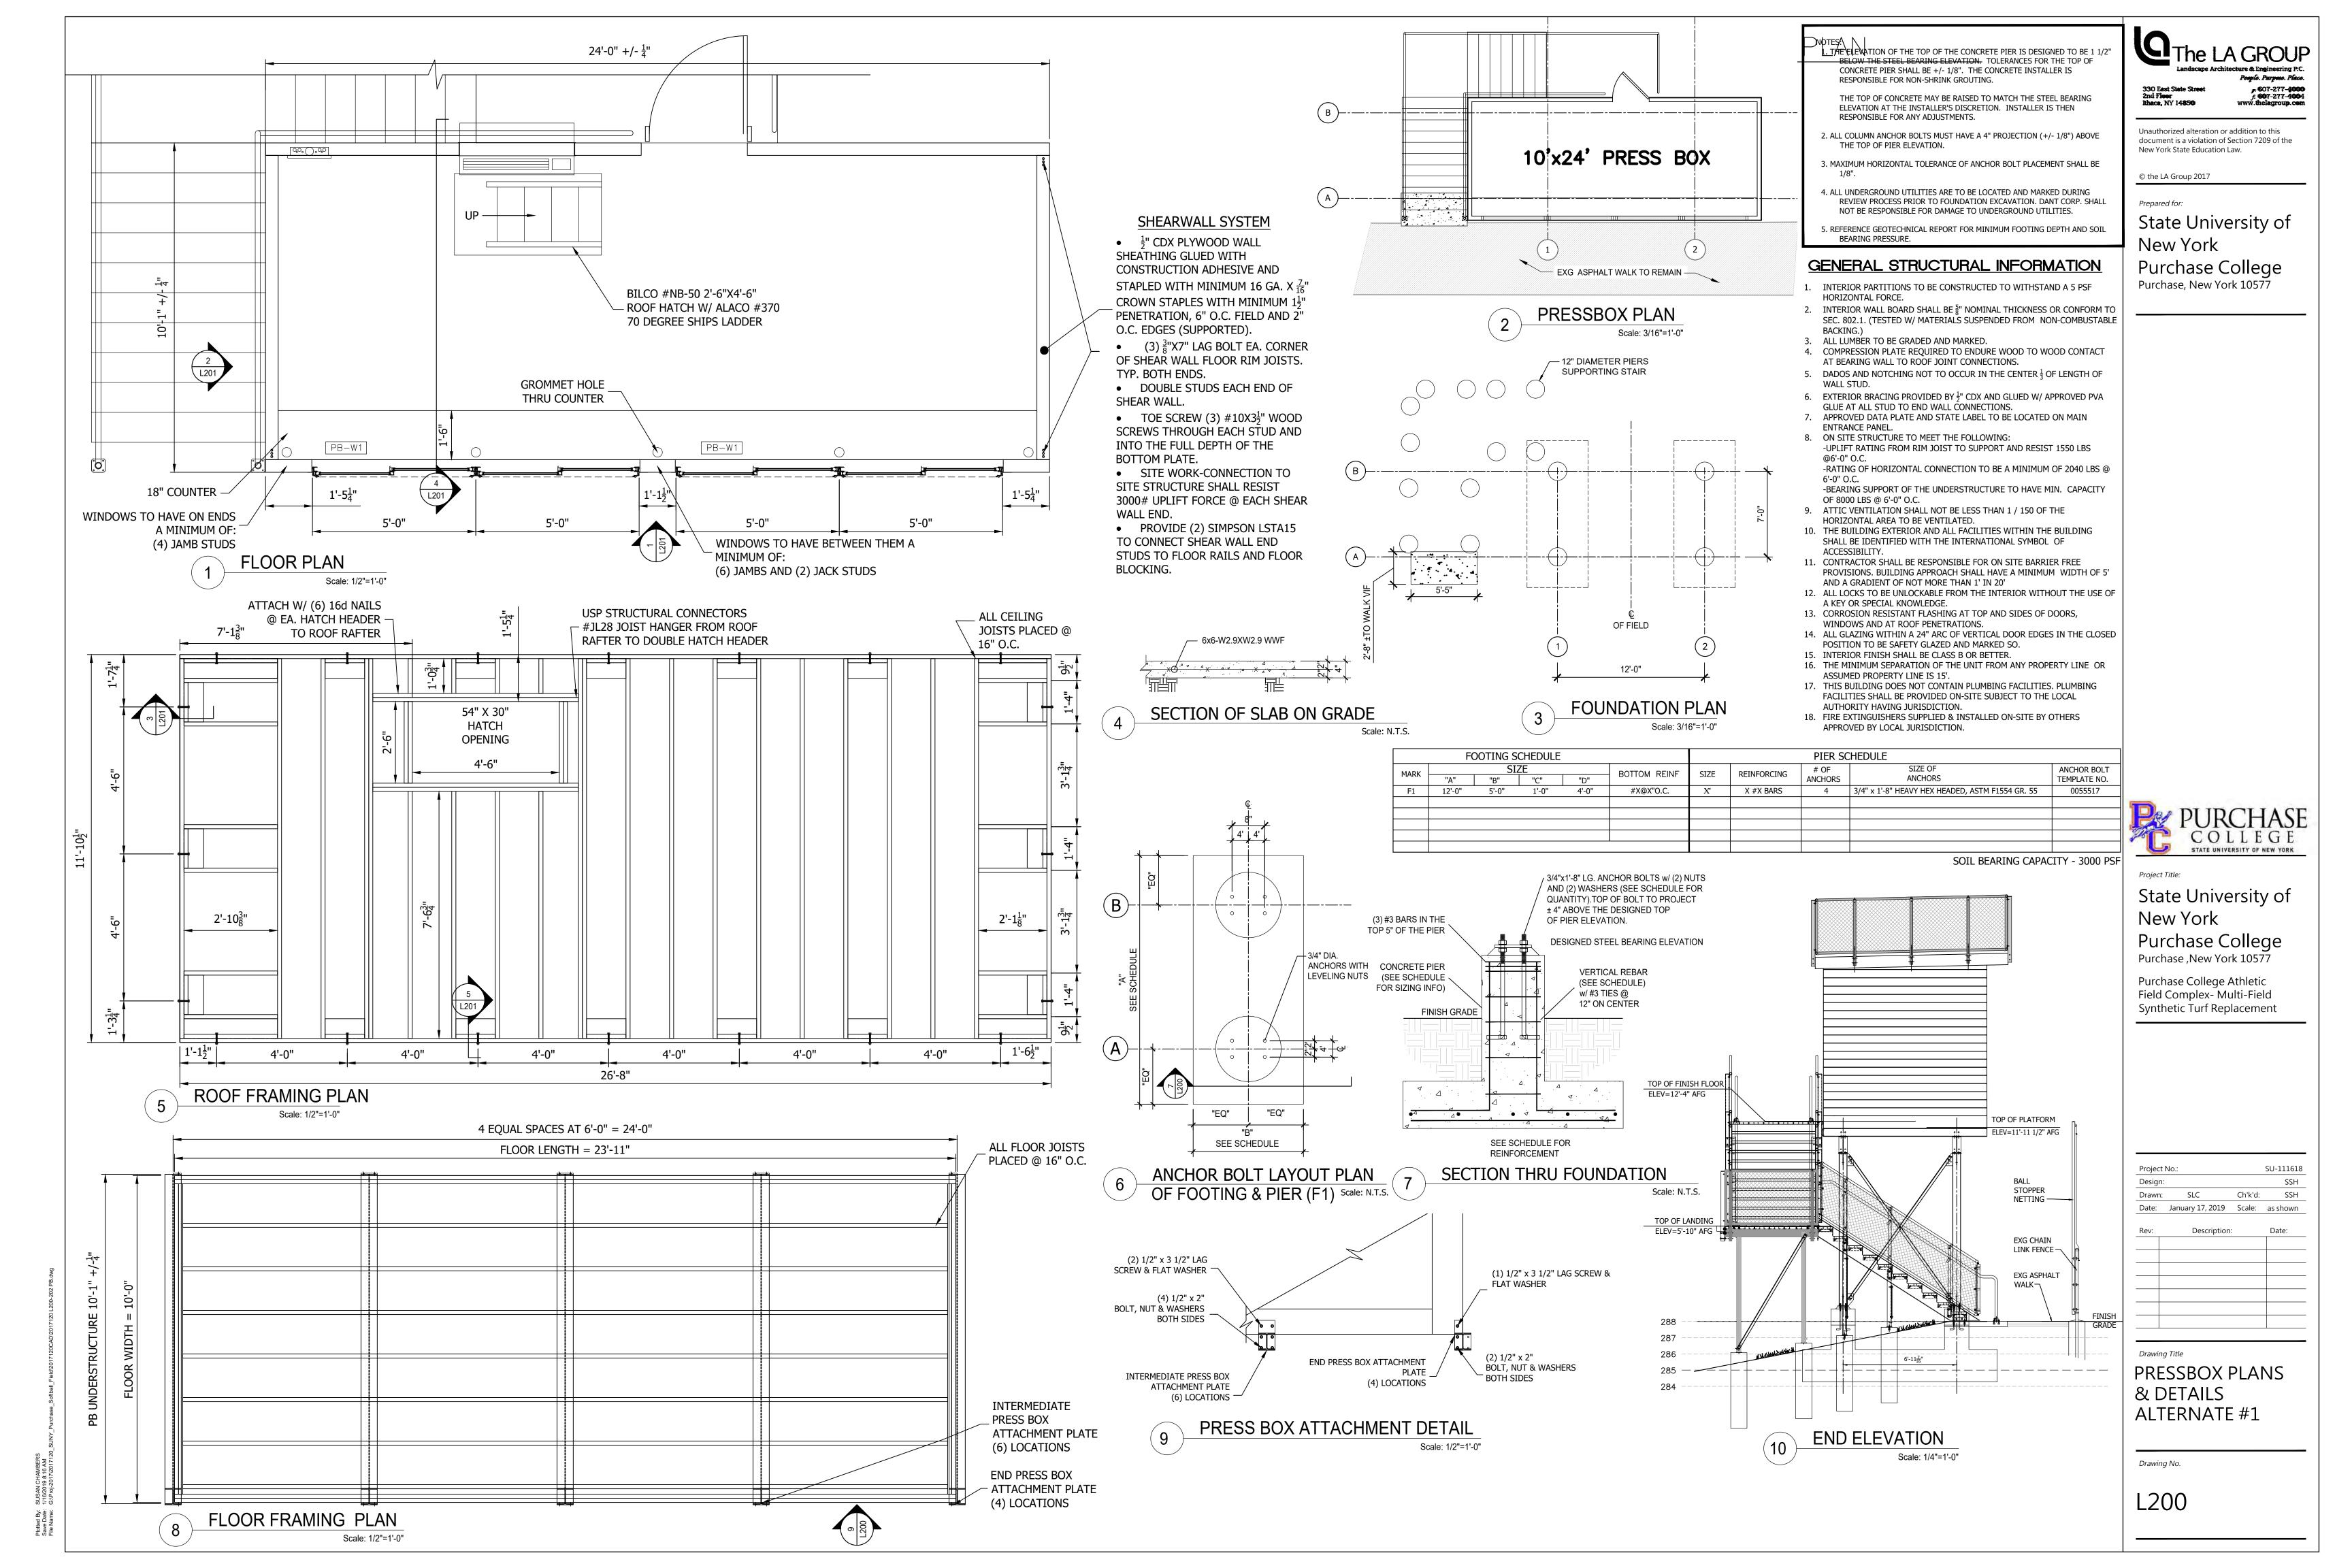

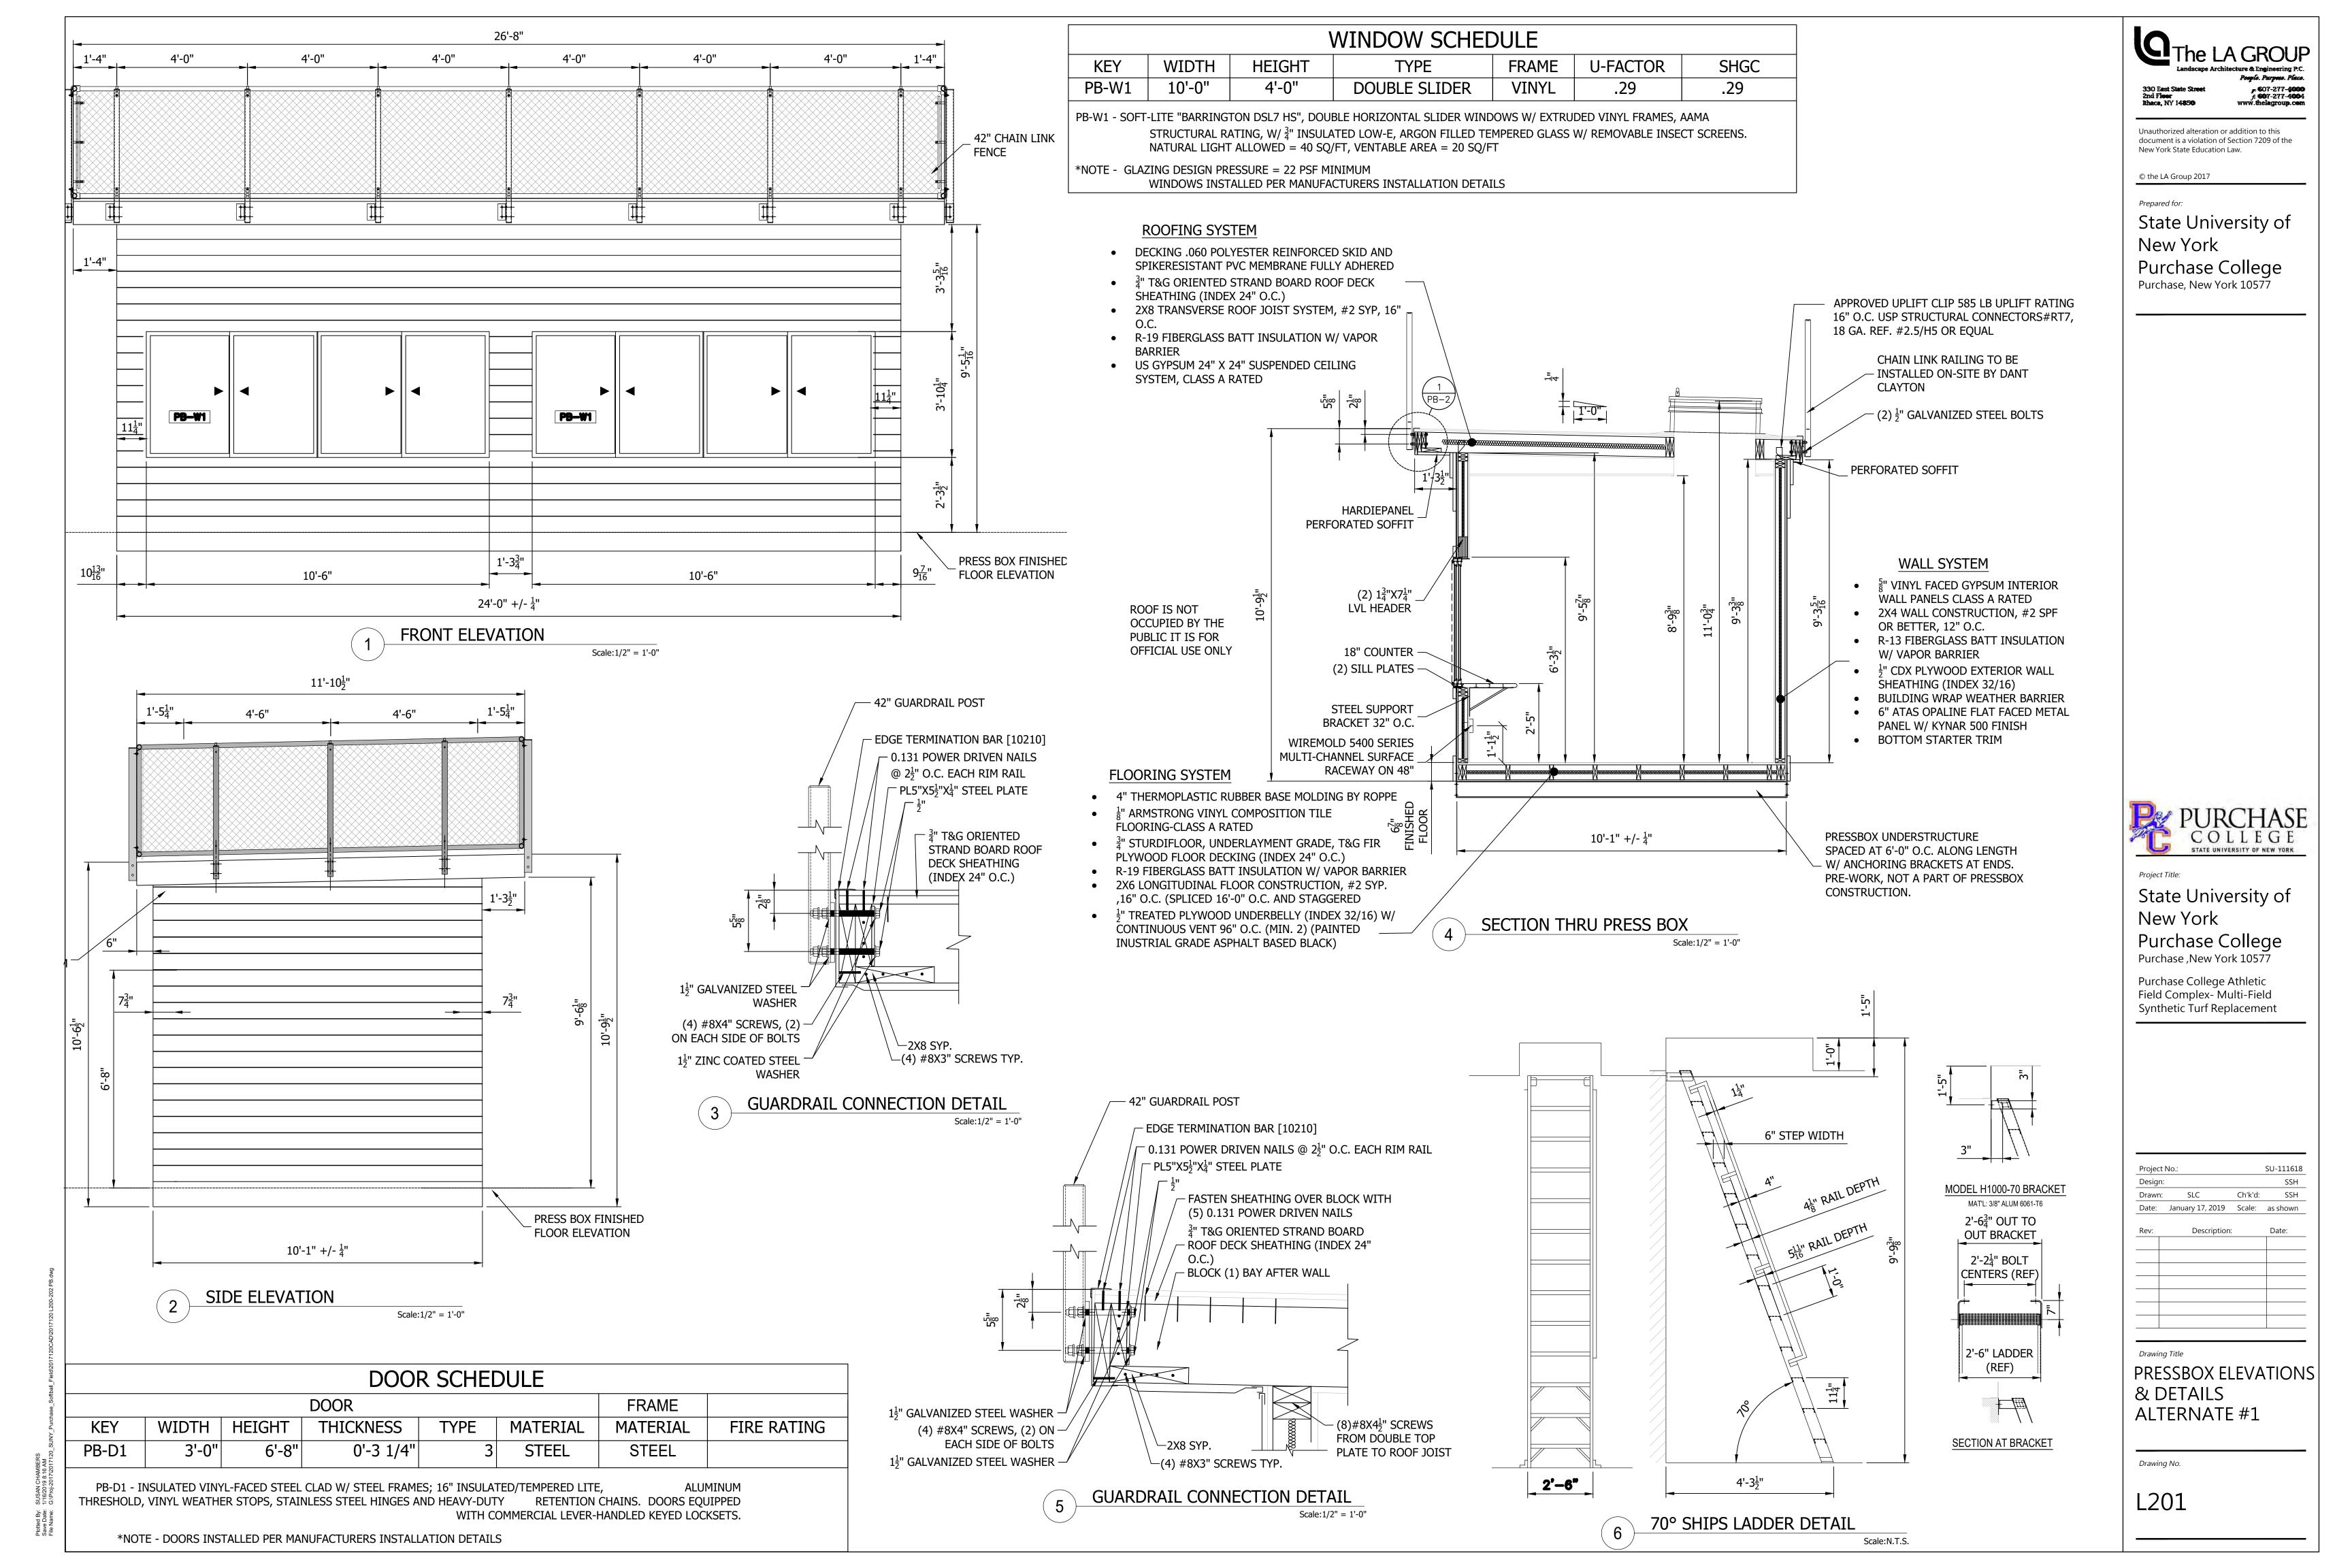

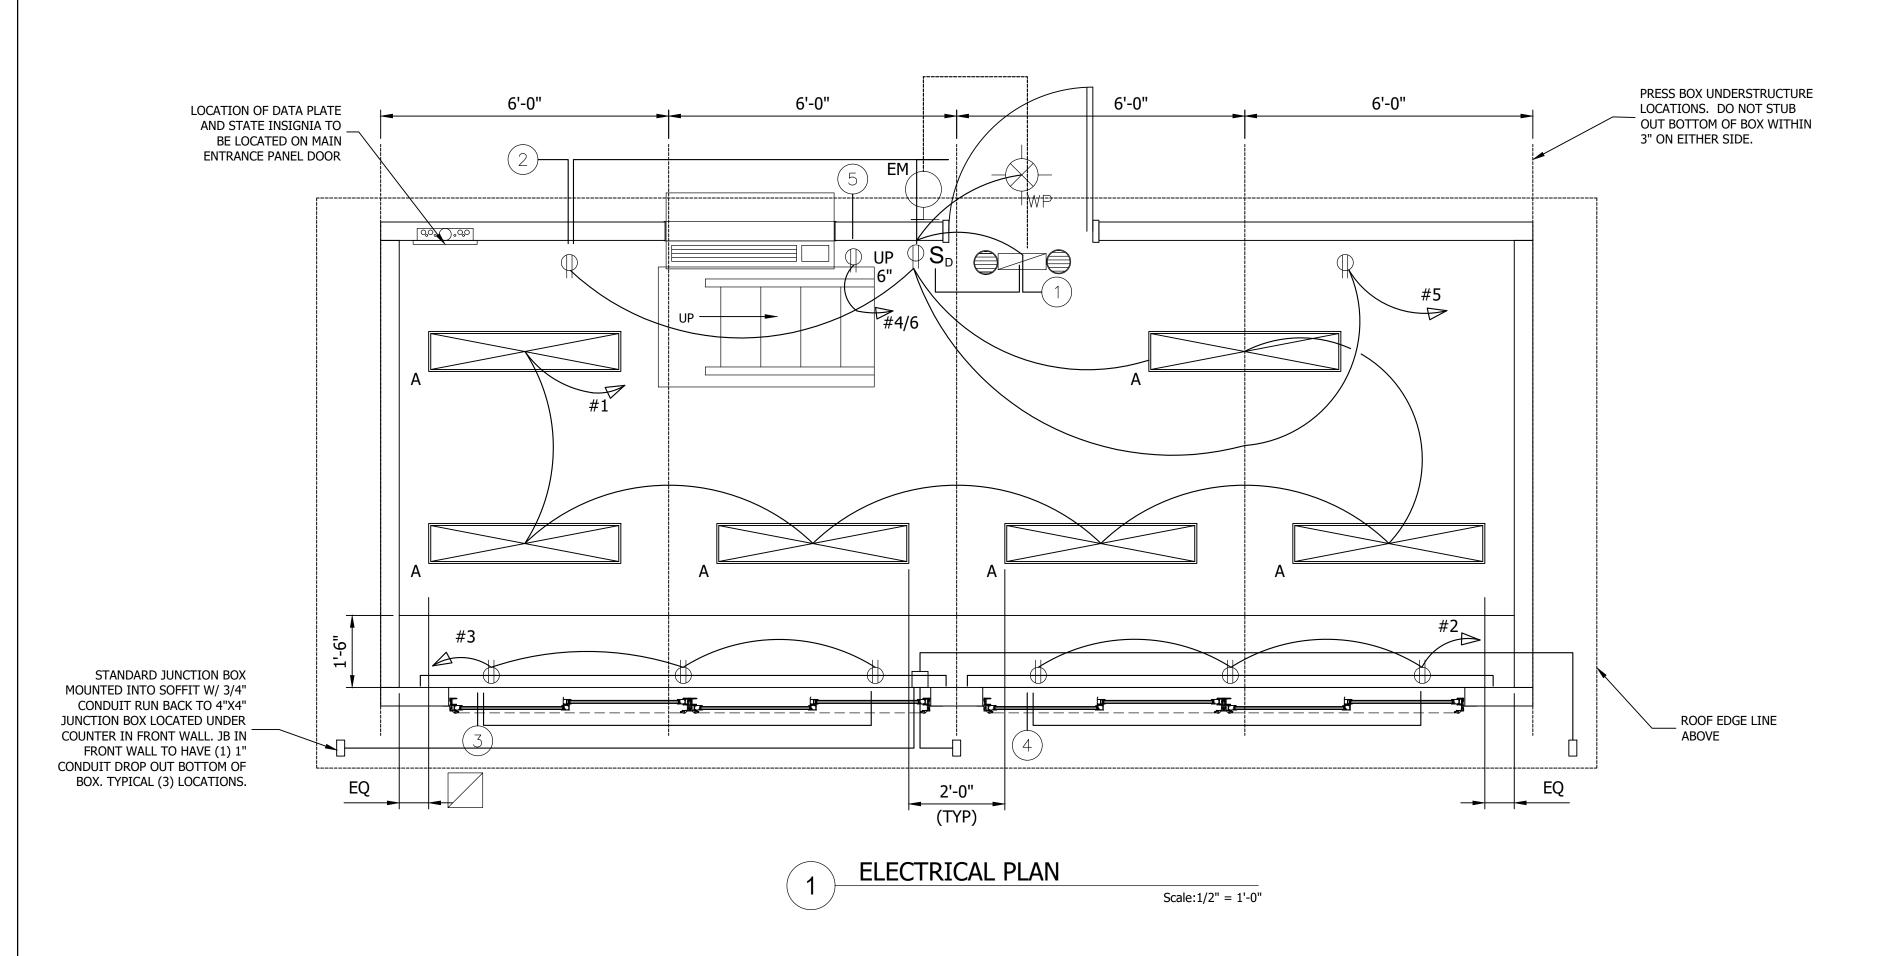

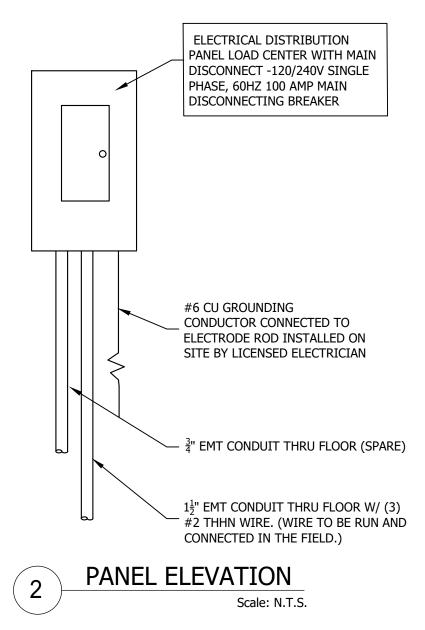

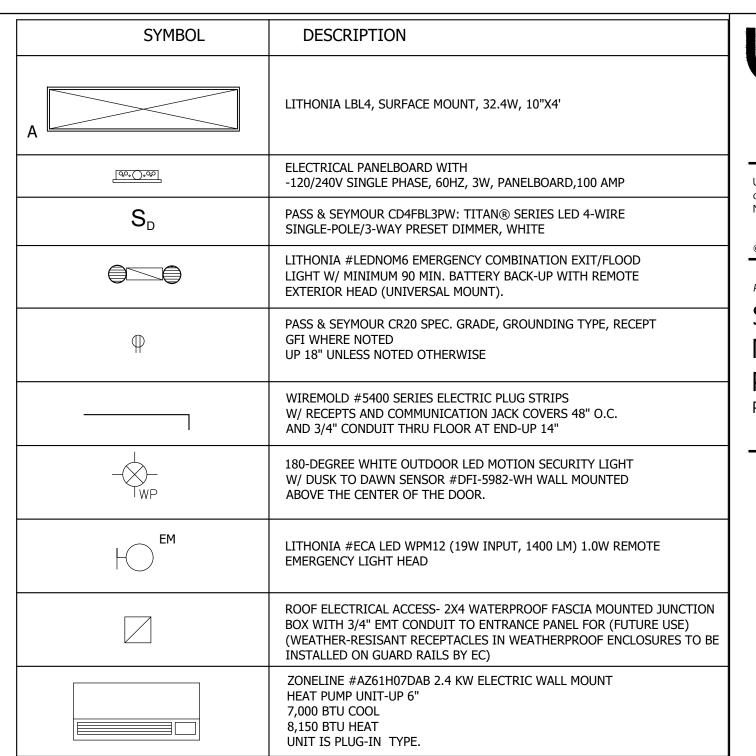

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## DESIGN SPECIFICATIONS

	ACCORDANCE WITH THE FOLLOWING								
	2015 INTERNATIONAL BUILD 2015 INTERNATIONAL MECH 2014 NATIONAL ELECTRICAL 2012 INTERNATIONAL ENER 2012 INTERNATIONAL PLUM 2009 ICC/ANSI A117.1 2015 NEW YORK STATE BU		AMENDMENTS W/ AMENDMENTS MENDMENTS TION CODE W/ AMENDMENTS I/ AMENDMENTS						
	DE	ESIGN LC	DADS						
	1. FLOOR DEAD LOAD	10 PSF							
	2. FLOOR LIVE LOAD	100 PSF							
	3. ROOF DEAD LOAD	10 PSF							
	4. ROOF LIVE LOAD	50 PSF							
	5. WALLS	25 PSF 8 PSF	UNIFORM VERTICAL PROJECTION DEAD LOAD						
<sub></sub> δ	6. GROUND SNOW LOAD	30 PSF							
20CAD\2017120 L200-202 PB.dwg	7. OCCUPANCY GROUP	В							
120 L200-:	8. CONSTRUCTION TYPE	V-B							
:AD\20171	9. OCCUPANCY LOAD	14 PERSONS							
~	10. SWAY	24 PLF	PARALLEL PER FT. OF ROW PARALLEL TO SEAT RUN						
s:\Proj-2017/2017120_SUNY_Purchase_Softball_Field\2017	11.GUARD RAILS	200 LB 50 LB/FT 100 LB/FT	CONCENTRATED LATERAL LOAD UNIFORM LATERAL LOAD UNIFORM VERTICAL LOAD						
120_SUN`	12.ULTIMATE WIND LOAD	<b>'</b>	150 MPH, EXPOSURE C @ 30'						
:017\2017	13. WIND IMPORTANCE FACTOR	1.0							
3:\Proj-2	14. SEISMIC ZONE SITE CLASS D								

DESIGN CATEGORY B

DESIGN AND CONSTRUCTION

ALL DESIGN, MATERIALS AND WORKMANSHIP SHALL BE IN

ACCORDANCE WITH THE FOLLOWING

BUILDING ELEMENT	FASTENER
STUD TO SOLE PLATE	15GA X 2 1/2" LONG GALVANIZED STAPLE
STUD TO CAP PLATE	15GA X 2 1/2" LONG GALVANIZED STAPLE
CORNER STUDS	#8X3" SCREW
SOLE PLATE TO JOIST OR BLOCKING	16d COMMON
DOUBLE CAP PLATE	15GA X 2 1/2" LONG GALVANIZED STAPLE
FLOOR JOISTS	16d COMMON
DOUBLE EDGE RAIL	16d COMMON
CEILING JOISTS TO PLATE	16d COMMON
HEADER BEAMS TO TRIMMERS	15GA X 2 1/2" LONG GALVANIZED STAPLE
PLYWOOD ROOF AND WALL SHEATHING (1/2" OR LESS)	16GA X 1 1/2" LONG GALVANIZED STAPLE
PLYWOOD ROOF AND WALL SHEATHING (5/8" OR GREATER)	16GA X 2" LONG GALVANIZED STAPLE
PLYWOOD SUBFLOORING (5/8", 3/4")	6d RING SHANK
PARTICLE BOARD ROOF AND WALL SHEATHING (1/2" OR LESS)	16GA X 1 1/2" LONG GALVANIZED STAPLE

PARTICLE BOARD ROOF AND WALL

SHEARWALL (END) TO RAFTERS

RAFTER TO TOP PLATES

SHEATHING (5/8" OR GREATER)

FASTENING SCHEDULE

16GA X 2" LONG

(1) #8X4 SCREW

16d NAILS

GALVANIZED STAPLE

## NUMBER AND LOCATION 5 PSF HORIZONTAL FORCE. (4) DIRECT (4) DIRECT 12" O.C. DIRECT 16" O.C. (9" O.C. AT SHEARWALLS) (2) 12" O.C. DIRECT MIN. (3) DIRECT MIN. (3) DIRECT MIN. (3) DIRECT

(6) EACH END OR (8) TOE NAIL 4" O.C. DIRECT EDGES & 8" O.C. INTERMEDIATE SUPPORTS 4" O.C. DIRECT EDGES & 8" O.C. INTERMEDIATE SUPPORTS 6" O.C. DIRECT EDGES & 12" O.C. INTERMEDIATE SUPPORTS 4" O.C. DIRECT EDGES & 8" O.C. INTERMEDIATE SUPPORTS 4" O.C. DIRECT EDGES & 8" O.C. INTERMEDIATE SUPPORTS

12" O.C.

TOED EACH RAFTER

## GENERAL STRUCTURAL INFORMATION 1. INTERIOR PARTITIONS TO BE CONSTRUCTED TO WITHSTAND A

- 2. INTERIOR WALL BOARD SHALL BE  $\frac{5}{8}$ " NOMINAL THICKNESS OR CONFORM TO SEC. 802.1. (TESTED W/ MATERIALS SUSPENDED FROM NON-COMBUSTABLE BACKING.) 3. ALL LUMBER TO BE GRADED AND MARKED.
- 4. COMPRESSION PLATE REQUIRED TO ENDURE WOOD TO WOOD CONTACT AT BEARING WALL TO ROOF JOINT CONNECTIONS. 5. DADOS AND NOTCHING NOT TO OCCUR IN THE CENTER  $\frac{1}{3}$  OF LENGTH OF WALL STUD.
- 6. EXTERIOR BRACING PROVIDED BY  $\frac{1}{2}$ " CDX AND GLUED W/ APPROVED PVA GLUE AT ALL STUD TO END WALL CONNECTIONS. 7. APPROVED DATA PLATE AND STATE LABEL TO BE LOCATED ON MAIN ENTRANCE PANEL.
- 8. ON SITE STRUCTURE TO MEET THE FOLLOWING: -UPLIFT RATING FROM RIM JOIST TO SUPPORT AND RESIST
- 1550 LBS @6'-0" O.C. -RATING OF HORIZONTAL CONNECTION TO BE A MINIMUM OF 2040 LBS @ 6'-0" O.C.
- -BEARING SUPPORT OF THE UNDERSTRUCTURE TO HAVE MIN. CAPACITY OF 8000 LBS @ 6'-0" O.C.
- 9. ATTIC VENTILATION SHALL NOT BE LESS THAN 1 / 150 OF THE HORIZONTAL AREA TO BE VENTILATED.
- 10. THE BUILDING EXTERIOR AND ALL FACILITIES WITHIN THE BUILDING SHALL BE IDENTIFIED WITH THE INTERNATIONAL SYMBOL OF ACCESSIBILITY. 11. CONTRACTOR SHALL BE RESPONSIBLE FOR ON SITE BARRIER
- FREE PROVISIONS. BUILDING APPROACH SHALL HAVE A MINIMUM WIDTH OF 5' AND A GRADIENT OF NOT MORE THAN 1' IN 20' 12. ALL LOCKS TO BE UNLOCKABLE FROM THE INTERIOR WITHOUT THE
- USE OF A KEY OR SPECIAL KNOWLEDGE. 13. CORROSION RESISTANT FLASHING AT TOP AND SIDES OF DOORS,
- WINDOWS AND AT ROOF PENETRATIONS. 14. ALL GLAZING WITHIN A 24" ARC OF VERTICAL DOOR EDGES IN THE

CLOSED POSITION TO BE SAFETY GLAZED AND MARKED SO.

- 15. INTERIOR FINISH SHALL BE CLASS B OR BETTER. 16. THE MINIMUM SEPARATION OF THE UNIT FROM ANY PROPERTY LINE OR ASSUMED PROPERTY LINE IS 15'.
- 17. THIS BUILDING DOES NOT CONTAIN PLUMBING FACILITIES. PLUMBING FACILITIES SHALL BE PROVIDED ON-SITE SUBJECT TO THE LOCAL AUTHORITY HAVING JURISDICTION. 18. FIRE EXTINGUISHERS SUPPLIED & INSTALLED ON-SITE BY OTHERS APPROVED BY LOCAL JURISDICTION.

## GENERAL ELECTRICAL INFORMATION

- 1. ALL WIRING TO BE ENCASED IN THIN ALL EMT CONDUIT MIN. 12THHN COPPER WIRE.
- 2. ALL RECEPTACLES TO BE GROUNDING TYPE.
- 3. MAIN PANEL TO BE MARKED SUITABLE FOR USE AS SERVICE EQUIPMENT, AND TO BE EQUIPPED WITH BREAKER/FUSE TYPE OVER CURRENT PROTECTION.
- 4. PROPER THERMAL OVERLOAD PROTECTION TO BE PROVIDED FOR ALL MOTORS.

5. DISCONNECTING MEANS WITHIN SITE REQUIRED FOR ALL MOTORS.

- 6. WEATHERPROOF PROTECTION REQUIRED FOR ALL OUTDOOR LIGHTS, RECEPTACLES AND DISCONNECTS.
- 7. PROPER WORKING CLEARANCES TO BE PROVIDED AND MAINTAINED AROUND ALL ELECTRICAL EQUIPMENT.
- 8. ALL FLUORESCENT FIXTURES REQUIRE THERMAL PROTECTION AND PROPER CLEARANCES FROM INSULATION, ALSO APPLICABLE FOR INCANDESCENT FIXTURES.
- 9. EXIT LIGHTS (IF ELECTRIC) MUST BE FED FROM AN APPROVED EMERGENCY SERVICE CONNECTED AHEAD OF, BUT NOT WITHIN MAIN SERVICE DISCONNECTING MEANS ENCLOSURE, AND INSTALLED AS PER SERVICE REQUIREMENTS, OR BE BATTERY BACK UP TYPE UNITS.
- 10. SERVICE CONDUCTORS LOCATED WITHIN THE PERIMETER OF THE BUILDING SHALL BE INSTALLED PER NEC.
- 11. ELECTRICAL WIRING TO BE INSTALLED PER NEC.
- 12. ALL DATA/ TELECOMMUNICATION CONDUCTORS TO BE INSTALLED AND TERMINATED ON-SITE BY OTHERS.
- 13. ALL WIRING TO BE COPPER 0 TO 2,000 VOLTS, COMPLYING W/ ARTICLE 310, NEC AND NO SMALLER THAN #12, AWG, INSULATED CONDUCTORS SHALL NOT EXCEED THE CAPACITY RATINGS AS SCHEDULED IN TABLES 310. NEC AND PROVIDED AND COMPLYING CIRCUIT PROTECTION.



Project Title:

State University of New York

Purchase College Purchase ,New York 10577

Purchase College Athletic Field Complex- Multi-Field Synthetic Turf Replacement



SU-111618

Design:			SSH
Drawn:	SLC	Ch'k'd:	SSH
Date:	January 17, 2019	Scale:	as shown
Rev:	Description:		Date:

Rev:	Description:	Date:
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Drawing Title PRESSBOX ELECTRICAL PLAN & DETAILS **ALTERNATE #1** 

Drawing No.

L202

Project No.:

PA	NELBOARD SC	NOTES: F	PANEL SHA	LL BE FUL	LY RATED.	NEMA 1								
	PANEL	SOURCE		RATINGS	S (AMPS)		PHASE	/ WIRE	VOLT	-AGE	MOUNTING	UL LISTING INT. RATING (RMS SYM. AMPS)	DESIGN MAKE SQ-D	NEMA TYPE
	TURF FIELD PRESS BOX	P-FLVP-3		/ICB 10A	M	LO -	1PH	3W	240/	<b>′</b> 120	SURFACE	10 KAIC	NQOD	1
CKT	DESCRIPTION	BREAKER		VA L	OAD			VA L	.OAD		BREAKER	DESCE	RIPTION	CKT
NO.	DESCRIT FIOR	DILAKEN	MISC	RCPT	MOTOR	HTG	HTG	MOTOR	RCPT	MISC	DIVEAREN	DESCI	an mon	NO.
1	LIGHTING	20A/1P	218.2						1440.0		20A/1P	RCPTS - P	LUGMOLD	2
3	RCPTS - PLUGMOLD	20A/1P		1440.0										4
5	RCPTS - GENERAL	20A/1P		540.0			2438.0				15A/2P	HEAT	PUMP	6
7	SPARE	20A/1P									20A/1P	SP.	ARE	8
9	SPARE	20A/1P									20A/1P	SP	ARE	10
11	SPARE	20A/1P									20A/1P	SP	ARE	12
LEFT	SIDE SUB-TOTAL		218.2	1980	0	0	2438	0	1440	0	RIGHT SIC	DE SUB-TOTA	۸L	
TOTA	AL CONNECTED LOAD		218.2	3420	0	2438	A PHASE B PHASE		ASE	TOTAL CONNECTED LOAD PER F				
DEM	AND FACTOR		1	100%/50%	0.8	0.8						TOTAL CONNE	CTED LOAD PE	R PHASE
ESTII	MATED DEMAND		218.2	3420	0	1950.4	NOTES:							
TOTA	AL ESTIMATED DEMAND (\	/A)		558	8.6									
	AL AMPS			23.	29									

NOTES: PANEL SHALL BE FULLY RATED. NEMA 3R.														
EXI	STING PANEL	BOARD S	CHEL	OULE										
	PANEL	SOURCE		RATINGS	(AMPS)		PHASE	/ WIRE	VOL	TAGE	MOUNTING	UL LISTING INT. RATING (RMS SYM. AMPS)	DESIGN MAKE SQ-D	NEMA TYPE
	(E) P-FLVP-3	(E) P-FHVP-3		1CB 0A	M	ILO -	1PH	3W	240	/120	SURFACE	10 KAIC	NQOD	3R
CKT NO.	DESCRIPTION	BREAKER	MISC	VA LO	DAD MOTOR	HTG	HTG	VA L	OAD RCPT	MISC	BREAKER	DESC	RIPTION	CKT NO.
1 3	(E) BASEBALL PRESS BOX PANEL	(E) 50A/2P	840.0	4000.0						500.0 500.0	(E) 20A/1P (E) 20A/1P	` '	OUG OUT #1 OUG OUT #2	2 4
5 7	(E) POLE A1 FIXTURE (E) POLE A2 FIXTURE	(E) 15A/1P (E) 15A/1P	300.0 300.0						400.0 400.0	2.2	(E) 20A/1P (E) 20A/1P	(E) RCPTS - I	DOUG OUT #1	6 8
9 11	(E)MUSCO LTG PANEL	(E) 15A/1P	300.0						400.0 400.0		(E) 20A/1P (E) 20A/1P	(E) RCPTS -	BULL PEN #1 BULL PEN #2	. 10
13 15	TURF FIELD PRESS BOX SPACE	40A/2P	218.2	3420.0	0.0	2438.0			300.0 800.0		(E) 20A/1P (E) 20A/1P	(E) SCOREBOA	ARD - SOFTBALL ARD - BASEBALL	14 16
17 19	SPACE SPACE								200.0		(E) 20A/1P	(E) SCOREBOA	ACE	18 20
21	SPACE											SP	ACE	22
23 25	SPACE SPACE											SP	ACE ACE	24 26
27 29	SPACE SPACE											SP	ACE ACE	28 30
31 33	SPACE SPACE												ACE ACE	32 34
35 LFFT	SPACE SIDE SUB-TOTAL		1958.2	7420	0	2438	0	0	2900	1000	RIGHT SIF	SP DE SUB-TOTA	ACE	36
TOTA	AL CONNECTED LOAD AND FACTOR		2958.2 1	10320 100%/50%	0	2438 2438 0.8	A PH			HASE	MOITI JIL		ECTED LOAD PE	R PHASE
ESTI	MATED DEMAND AL ESTIMATED DEMAND (	(VA)	2958.2	10320 1522	0		NOTES:							
	AL AMPS			63.	45									



BRANCH CIRCUIT PANELBOARD - SURFACE MOUNTED

O JUNCTION BOX
-WALL OR CEILING MOUNTED, AS INDICATED

HANDHOLE

NOTE: LINES MAY BE CURVED OR STRAIGHT

POWER CIRCUIT OR FEEDER

POWER HOMERUN TO PANEL

—UE— UNDERGROUND ELECTRIC UTILITY

CONDUIT OR CABLE

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Prepared for:

State University of New York Purchase College Purchase, New York 10577





Project Title:

State University of New York

Purchase College Purchase ,New York 10577

Purchase College Athletic Field Complex- Multi-Field Synthetic Turf Replacement




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Drawing Title ELECTRICAL NOTES,

ABBREVIATIONS, LEGEND & DETAILS

Drawing No.

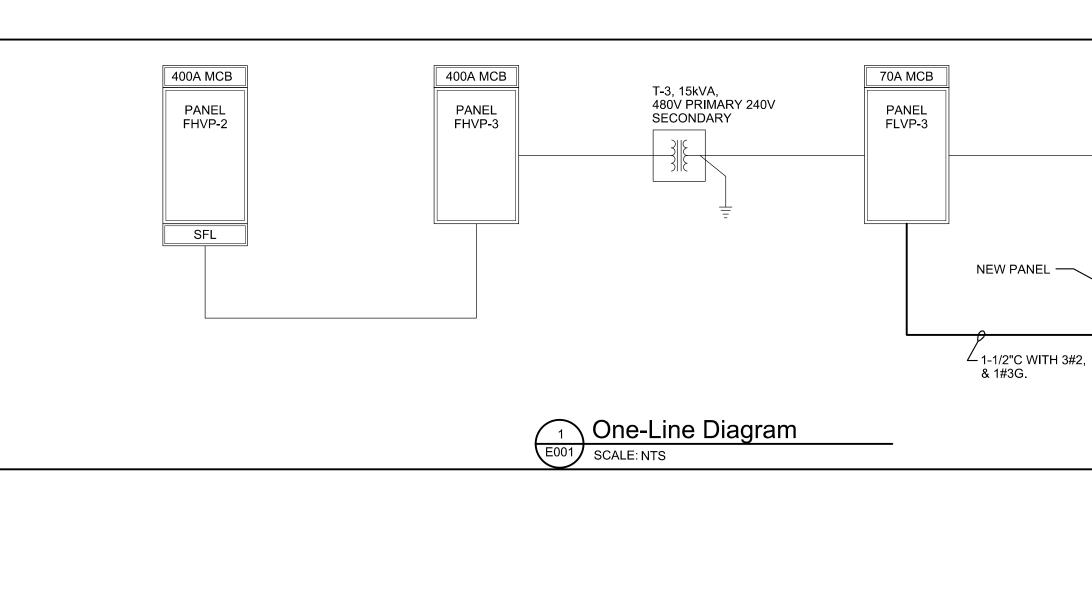

**ABBREVIATIONS** KVA KILOVOLT AMPS Ø PHASE L, LTG LIGHTING LTFMC LIQUID TIGHT FLEXIBLE METAL CONDUIT AFF ABOVE FINISHED FLOOR MC MECHANICAL CONTRACTOR AFG ABOVE FINISHED GRADE NO, # NUMBER BFC BELOW FINISHED CEILING R, RCPT RECEPTACLE C CONDUIT RGS IGID GALVANIZED STEEL CKT CIRCUIT SINGLE MODE CLG CEILING TBB TELEPHONE BACKBOARD DTB DATA TERMINAL BOARD DWG DRAWING PLUMBING CONTRACTOR EC ELECTRICAL CONTRACTOR UNDER COUNTER EMT ELECTRICAL METAL TUBING UON UNLESS OTHERWISE NOTED EX'G EXISTING EXISTING TO REMAIN FACP FIRE ALARM CONTROL PANEL EXISTING TO BE RELOCATED GC GENERAL CONTRACTOR WIRE GUARD GFI GROUND FAULT INTERRUPTER WEATHER PROOF GND GROUND VOLT(S) HP HORSEPOWER


IECC C103.2.2: TO THE BEST OF MY KNOWLEDGE, BELIEF, AND PROFESSIONAL JUDGEMENT, THE PLANS AND SPECIFICATIONS ARE IN COMPLIANCE WITH THE 2015 IECC COMMERCIAL PROVISIONS (AS AMENDED).

MUSCO FIELD LIGHTING CONTROL

PANEL

40A MCB

PRESS

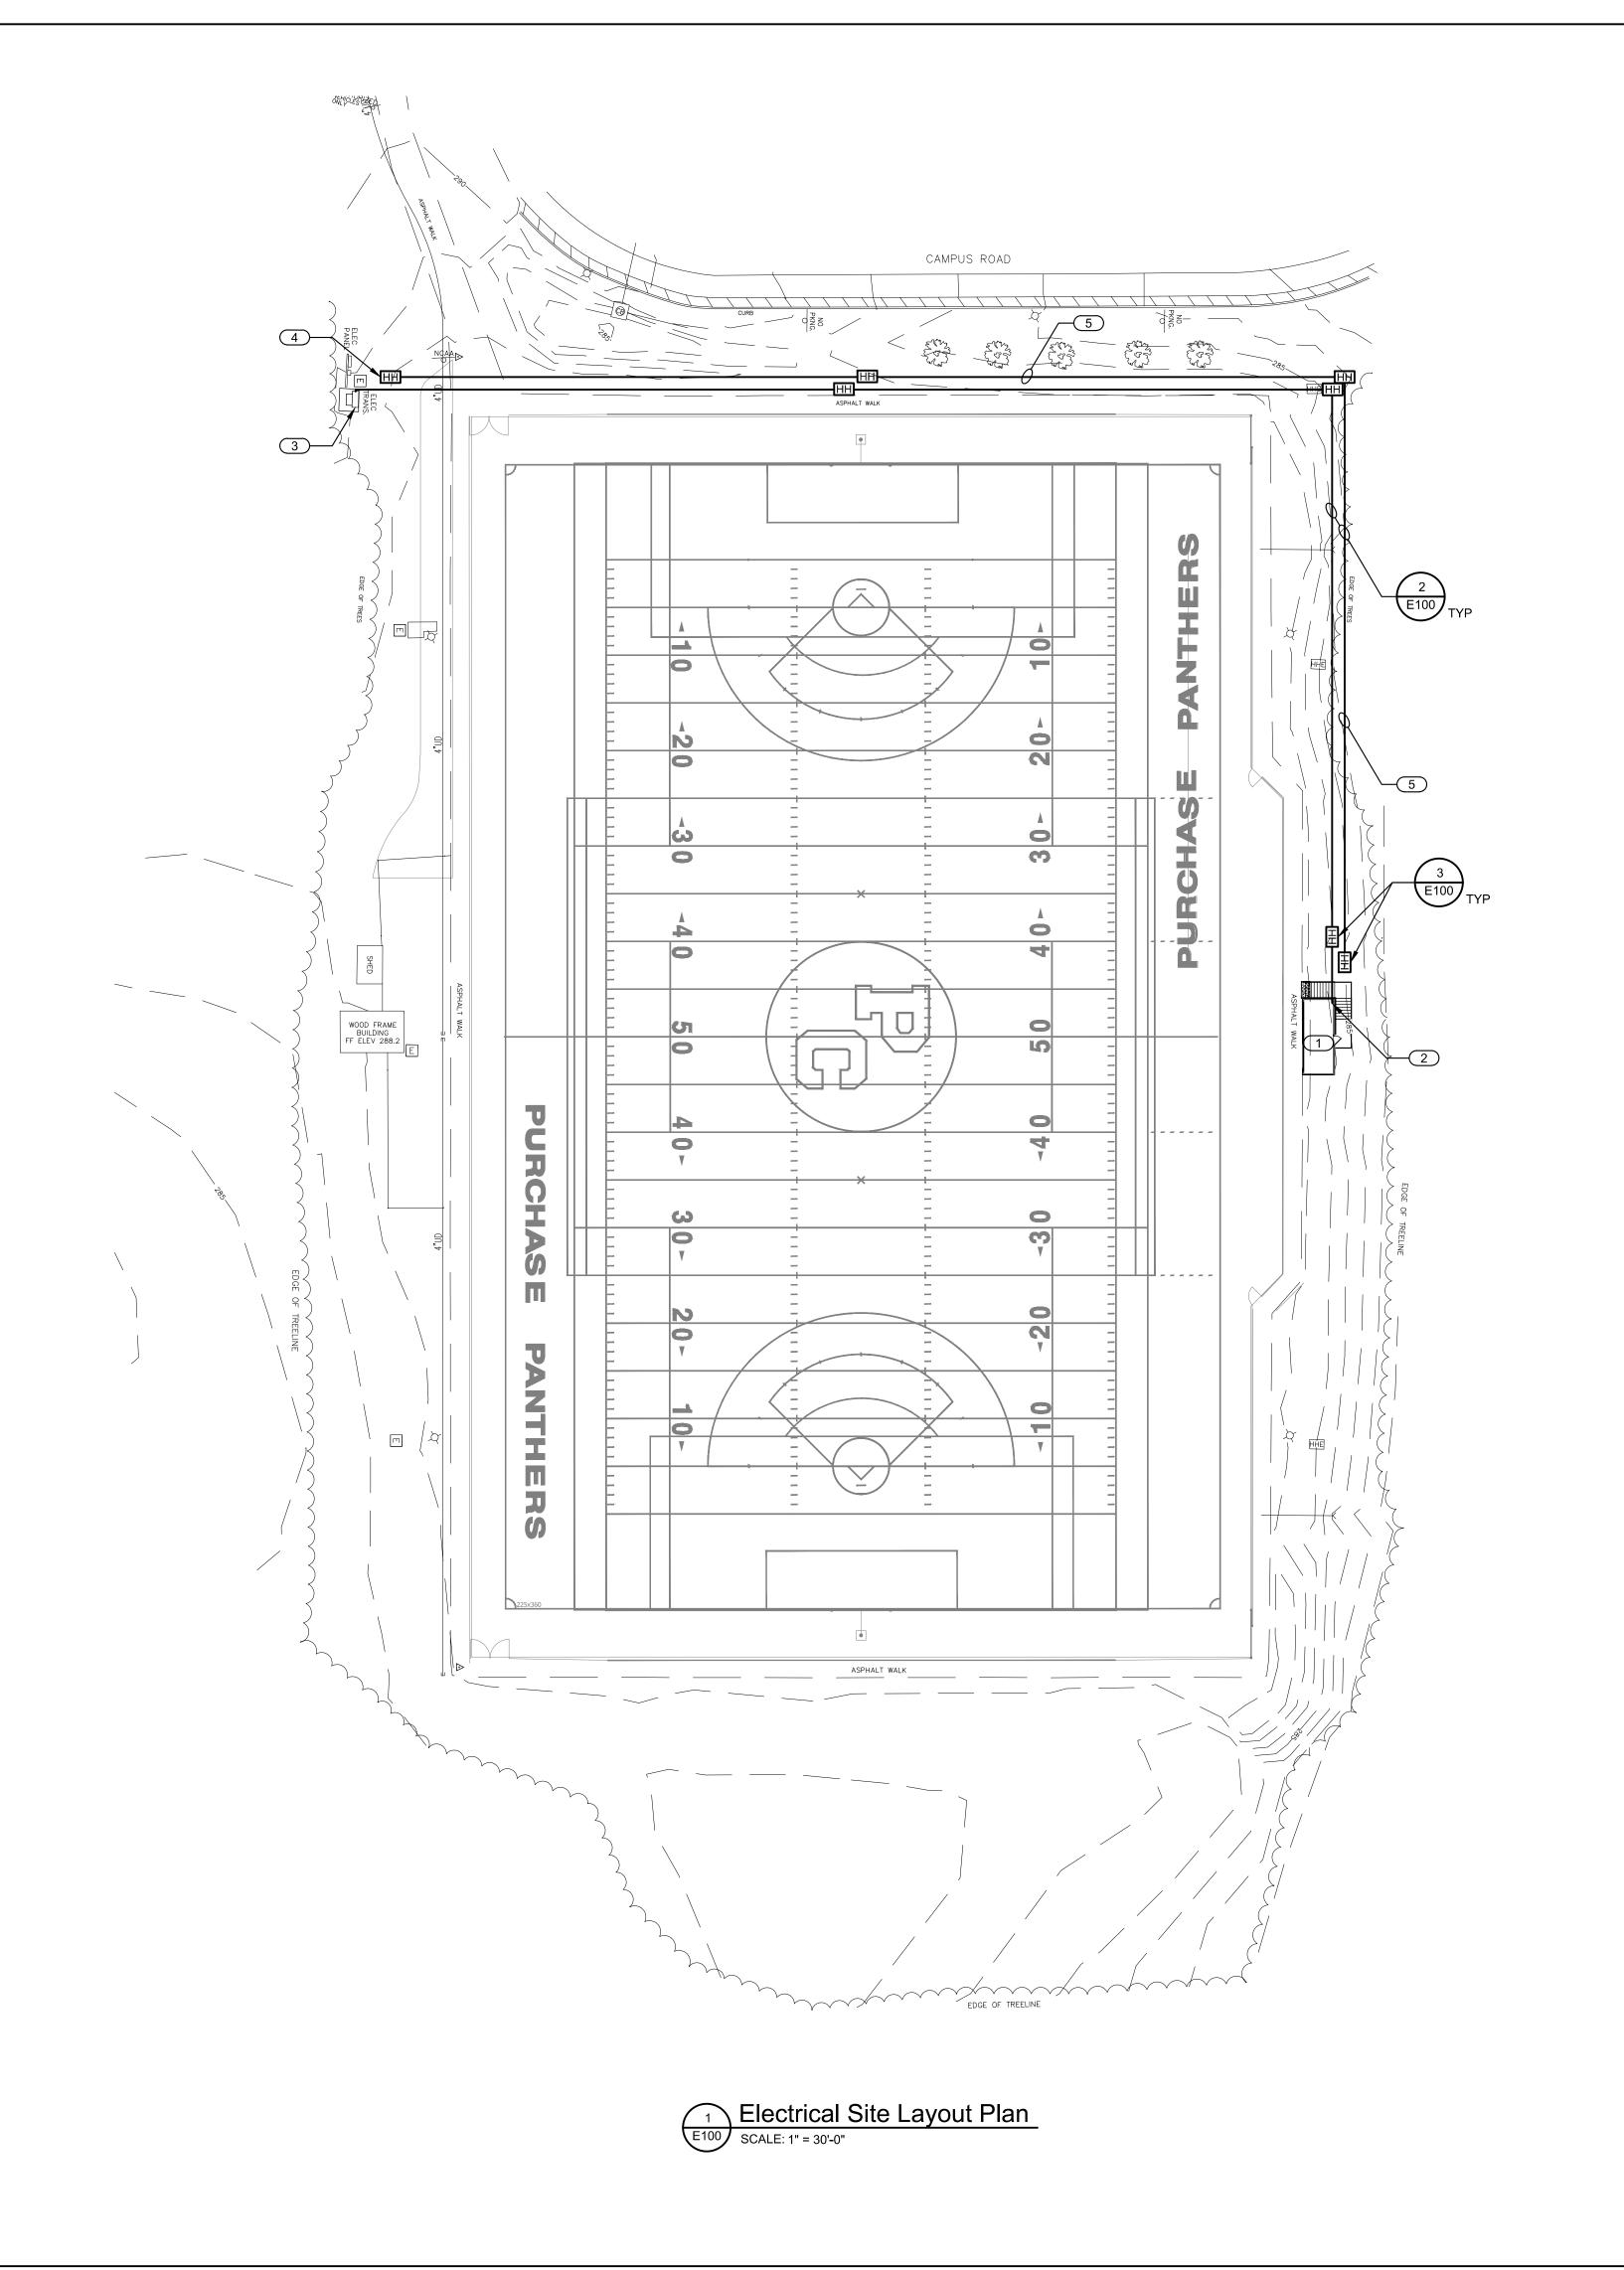

#### **KEYED NOTES**

- 1.) 10' x 24' PRE-MANUFACTURED PRESSBOX. PROVIDE THE FOLLOWING:
  - 1.1. #6 COPPER GROUNDING CONDUCTOR FROM INTEGRAL 100A PANELBOARD TO 3/4" x 10' COPPER
  - CLAD GROUND ROD IN ACCORDANCE WITH 2014 NEC. 1.2. 3/4" EMT THROUGH FLOOR.
  - 1.3. PROVIDE CONDUIT SLEEVE THROUGH FLOOR, SIZE AS INDICATED WITH FEEDER SIZE.
- (2.) RISE UP INTO THE PRESSBOX.
- (3.) LOCATION OF EXISTING POWER BACKBOARD. PROVIDE 40A/2P CIRCUIT BREAKER IN EXISTING PANEL "P-FLVP-3". REFER TO DRAWING E001 FOR PANELBOARD SCHEDULES.
- 4.) LOCATE DATA HANDHOLE IN THE FIELD.
- 5. PROVIDE (1) 2" PVC CONDUIT WITH PULLROPE FOR FUTURE

A. PROVIDE A HANDHOLE FOR ALL CONDUIT RUNS OVER 200'-0" UNDERGROUND.

**GENERAL NOTES** 

- B. PROVIDE 90 DEGREE SWEEPS INTO HANDHOLES.
- C. PRIOR TO EXCAVATION, LOCATE ALL EXISTING UTILITIES.
- D. WHERE EXISTING UNDERGROUND UTILITIES ARE TO BE REMOVED, EXISTING UNDERGROUND CONDUITS AND CABLING MAY REMAIN ABANDONED IN PLACE. REMOVE ALL ABOVE GRADE AND EXPOSED CONDUITS AND CABLING.
- E. PROVIDE A PULL STRING IN ALL EMPTY AND SPARE CONDUIT(S) SHOWN ON THIS PLAN.
- F. VERIFY FINAL GRADE ELEVATIONS PRIOR TO EXCAVATION FOR ALL TRENCHING, HANDHOLES, PULLBOXES, AND POLES. CONDUITS, HANDHOLE COVERS, AND CONCRETE EQUIPMENT PADS SHALL BE COORDINATED WITH FINAL GRADES INDICATED ON THE SITE CONTRACTOR'S PLANS.
- G. COORDINATE ALL SHUTDOWNS WITH THE OWNER AND PROJECT DESIGNER PRIOR TO BEGINNING WORK.
- H. REFER TO SPECIFICATIONS FOR ADDITIONAL INFORMATION.
- I. UNLESS OTHERWISE NOTED, FOR UNDERGROUND CONDUIT RUNS, PROVIDE SCHEDULE 80 PVC CONDUITS FOR HORIZONTAL UNDERGROUND CONDUIT SECTIONS. PROVIDE PVC TO RGS ADAPTERS, RGS 90 DEGREE SWEEPS, AND RGS VERTICAL CONDUIT SECTIONS.



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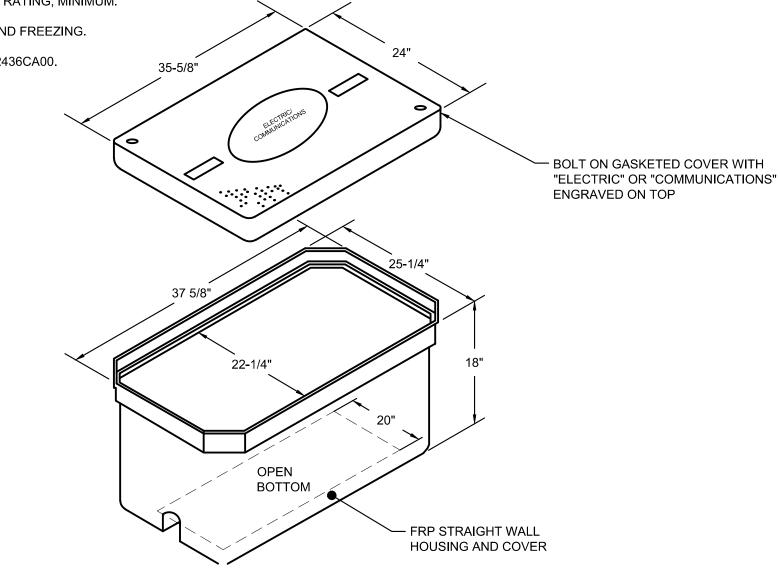
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### NOTES:


- A. SUITABLE FOR DIRECT BURIAL IN CONCRETE AND GRASS AREAS.
- B. COVER SHALL SUPPORT 12,000 LBS, TIER 8 RATING, MINIMUM.
- C. RESISTANT TO SUNLIGHT, WEATHERING, AND FREEZING.
- D. DESIGN MAKE QUAZITE, PG2436BA18 & PG2436CA00.



Hand Hole Detail

SCALE: NTS

(BY ELECTRIC WORK CONTRACTOR)

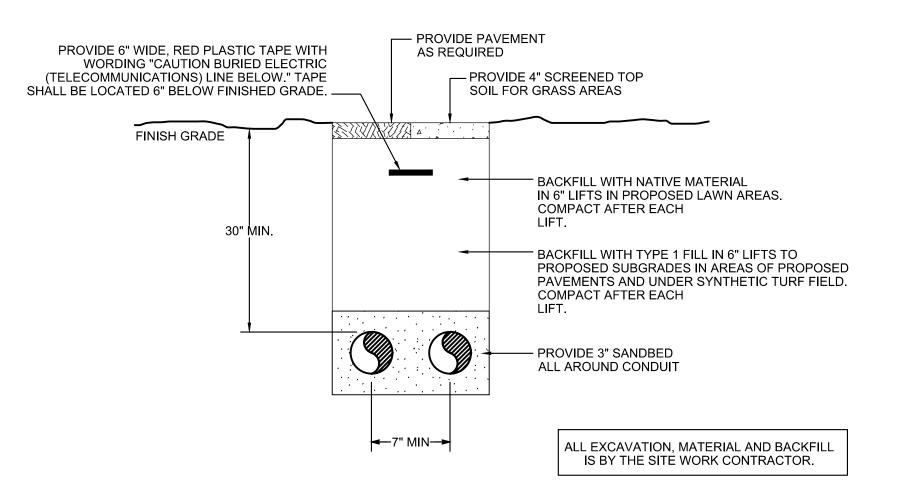

Direct Buried Conduit Detail (Typ)

SCALE: NTS

IECC C103.2.2: TO THE BEST OF MY KNOWLEDGE, BELIEF, AND PROFESSIONAL JUDGEMENT, THE PLANS AND



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Drawing Title

ELECTRICAL SITE LAYOUT PLAN

Drawing No.

E100

SPECIFICATIONS ARE IN COMPLIANCE WITH THE 2015 IECC COMMERCIAL PROVISIONS (AS AMENDED).