

















PROJECT DATA		
ITEM	CODE SECTION(S)	
CONSTRUCTION TYPE	IBC: 602	2B
USE & OCCUPANCY CLASSIFICATION	IBC: 302	SEPERATED MIXED USE: (A-2) / (S-2) / (B) / (R-2)
INCIDENTAL ACCESSORY	IBC: 509	MECHANICAL ROOM
ACCESSORY USE AREA	IBC: 508.2	N/A
TABULAR ALLOWABLE BUILDING HEIGHT	IBC: TABLE 504.3 & 504.4	(A-2) = 75'-0", 3 STORY(S) SPRINKLERED (S-2) = 55'-0", 3 STORY(S) NON - SPRINKLERED (B) = 55'-0", 3 STORY(S) NON - SPRINKLERED (R-2) = 55'-0", 3 STORY(S) NON - SPRINKLERED
ACTUAL BUILDING HEIGHT	--	3 STORY(S), 53'-0"
TABULAR ALLOWABLE BUILDING AREA	IBC: TABLE 506.2	(A-2) = 28,500 SF., NON SPRINKLERED (S-2) = 26,000 SF, NON SPRINKLERED (B) = 23,000 NON SPRINKLERED (R-2) = 16,000 SF, NON SPRINKLERED SEE KEY PLANS FOR MIXED AREA CALCULATIONS
ACTUAL BUILDING AREA (SEE PLANS FOR USE SEPERATION S.F.)	IBC: TABLE 506.2	BASEMENT = 17,220 SF FIRST FLOOR = 19,839 SF SECOND FLOOR = 4,000 SF THIRD FLOOR = 4,000 SF TOTAL BUILDING = 45,059 SF
FIRE SURPRESSION	IBC: 903.2.1.2	PARTIAL - (A-2) & (S-2) FIRE AREA WILL BE PROVIDED WITH AUTOMATIC SPRINKLER SYSTEM
FIRE DETECTION	IBC: 907	PROVIDED
TOTAL BUILDING OCCUPANT LOAD	IBC: TABLE 1004.1.2	SEE CODE PLAN
AREA OF REFUGE	IBC: 1009.3 - EXCEPTION 5	NOT REQUIRED WHERE EQUIPPED THROUGHOUT WITH AN AUTOMATIC SPRINKLER SYSTEM. (A-2) FIRE AREA ONLY WILL BE PROVIDED WITH AUTOMATIC SPRINKLER SYSTEM
STAIR WIDTH	IBC: 1009.3 - EXCEPTION 2 & 1011.2	CLEAR WIDTH OF 48" IS NOT REQUIRED WHERE EQUIPPED THROUGHOUT WITH AN AUTOMATIC SPRINKLER SYSTEM. (A-2) FIRE AREA ONLY WILL BE PROVIDED WITH AUTOMATIC SPRINKLER SYSTEM. 44" MINIMUM
MAX TRAVEL DISTANCE	IBC: TABLE 1017.2	(A-2) 250' WITH AUTOMATIC SPRINKLER SYSTEM (S-2) 300' W/OUT AUTOMATIC SPRINKLER SYSTEM (B) 200' W/OUT AUTOMATIC SPRINKLER SYSTEM (R-2) 200' W/OUT AUTOMATIC SPRINKLER SYSTEM
CORRIDOR WIDTH	IBC: TABLE 1020.2	44", MINIMUM
DEAD END CORRIDOR	IBC: TABLE 1020.4	(A-2) = 20' W/OUT AUTOMATIC SPRINKLER SYSTEM (S-2) = 20' W/OUT AUTOMATIC SPRINKLER SYSTEM (B) = 20' W/OUT AUTOMATIC SPRINKLER SYSTEM (R-2) = 20' W/OUT AUTOMATIC SPRINKLER SYSTEM
NUMBER OF EXITS	IBC: 1006.2.11 & IBC: TABLE 1006.2.1	(A-2) = 2 WHEN 500 OR LESS OCCUPANTS (S-2) = 2 WHEN GREATER THAN 75' TRAVEL DISTANCE & 30 OCCUPANTS (B) = 2 WHEN GREATER THAN 75' DISTANCE TRAVEL & 30 OCCUPANTS (R-2) = 2 MINIMUM

PLUMBING FIXTURE COUNT									
ASSEMBLY TOTAL OCCUPANTS = 493.47 / BUSINESS TOTAL OCCUPANTS = 98.33 / STORAGE TOTAL OCCUPANTS = 10.93									
		REQUIRED FIXTURE COUNT		CALCULATED FIXTURE COUNT		TOTAL FIXTURES REQUIRED		TOTAL FIXTURES PROVIDED	
OCCUPANCY CLASS		MALE	FEMALE	MALE	FEMALE	MALE	FEMALE	MALE	FEMALE
A-2, ASSEMBLY	WATER CLOSETS	1 PER 75	1 PER 75	3.29	3.29	5.31 (6)	5.31 (6)	2 WC* 3 URINALS*	4*
B, BUSINESS	WATER CLOSETS	1 PER 25	1 PER 25	1.97	1.97				
S-2, STORAGE	WATER CLOSETS	1 PER 100	1 PER 100	.05	.05				
A-2, ASSEMBLY	LAVATORIES	1 PER 200	1 PER 200	1.23	1.23	2.51 (3)	2.51 (3)	2*	5
B, BUSINESS	LAVATORIES	1 PER 40	1 PER 40	1.23	1.23				
S-2, STORAGE	LAVATORIES	1 PER 100	1 PER 100	.05	.05				
A-2, ASSEMBLY	DRINKING FOUNTAIN	1 PER 500		.98		1.18 (2)		2	
B, BUSINESS	DRINKING FOUNTAIN	1 PER 500		.19					
S-2, STORAGE	DRINKING FOUNTAIN	1 PER 1000		.01					
A-2, ASSEMBLY	SERVICE SINK	1 SERVICE SINK		1 SERVICE SINK		1		1	
B, BUSINESS	SERVICE SINK	1 SERVICE SINK		1 SERVICE SINK					
S-2, STORAGE	SERVICE SINK	1 SERVICE SINK		1 SERVICE SINK					

\* ADDITIONAL BATHROOM FIXTURES TO BE ADDED UNDER SEPARATE PROJECT BY THE UNIVERSITY











## FIRE RESISTANCE RATINGS

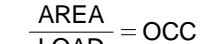ITEM	CODE SECTION(S)	
PRIMARY STRUCTURE FRAME	IBC: TABLE 601	0 HOUR(S)
BEARING WALLS		EXTERIOR: 0 HOUR(S) INTERIOR: 0 HOUR(S)
NON - BEARING WALLS		EXTERIOR: 0 HOUR(S) INTERIOR: 0 HOUR(S)
FLOOR CONSTRUCTION		0 HOUR(S)
ROOF CONSTRUCTION		0 HOUR(S)
SHAFT ENCLOSURES	IBC: 713.4	2 HOUR(S) - CONNECTING 4 STORIES OR MORE, OR WHERE PENETRATING 2 HR FLOOR CONSTRUCTION
EXIT ENCLOSURES	IBC: 1023.2	2 HOUR(S) - CONNECTING 4 STORIES OR MORE, OR WHERE PENETRATING 2 HR FLOOR CONSTRUCTION
CORRIDORS	IBC: TABLE 1020.1	1 HOUR(S) WITHOUT SPRINKLER SYSTEM 0 HOUR(S) WITH SPRINKLER SYSTEM
DOOR RATING	IBC: TABLE 716.5	1 HOUR(S) EXIT ENCLOSURE = 1 HOUR(S) DOOR 1 HOUR(S) CORRIDOR WALL = 1/3 HOUR(S) DOOR
USE GROUPS	IBC: 302	A-2: DINING & KITCHEN B: EDUCATIONAL R-2 DORMITORY S-2: STORAGE
USE GROUPS	IBC: 508.4, TABLE 508.4	2 HOUR(S): A-2 / B 1 HOUR(S) - A-2 / S-2 2 HOUR(S) S-2 / B 2 HOUR(S) R-2 / B (NOT IN RENOVATION SCOPE)
VERTICAL DWELLING UNIT SEPARATION	IBC: 420.2, 708.1	1 HOUR(S) (NOT IN SCOPE)
HORIZONTAL DWELLING UNIT SEPARATION	IBC: 420.3, 711.2.4.3	1 HOUR(S) (NOT IN SCOPE)

## APPLICABLE CODE

CODE	CODE SECTION(S)
BUILDING CODE	2015 INTERNATIONAL BUILDING CODE
	2015 INTERNATIONAL RESIDENTIAL BUILDING CODE
	2017 UNIFORM CODE SUPPLEMENT
PLUMBING CODE	2015 INTERNATIONAL PLUMBING CODE
MECHANICAL CODE	2015 INTERNATIONAL MECHANICAL CODE
ELECTRICAL CODE	2014 NATIONAL ELECTRICAL CODE (NFPA 70)
FUEL & GAS	2015 INTERNATIONAL FUEL & GAS CODE
ACCESSIBILITY	ACCESSIBILITY
ENERGY CODE COMPLIANCE	2015 INTERNATIONAL ENERGY CONSERVATION CODE W/ 2016 SUPPLEMENT





### CODE INFORMATION KEY

	CALCULATED OCCUPANT LOAD		
	MAXIMUM TRAVEL DISTANCE		DIRECTION OF EGRESS TRAVEL
	ACTUAL DOOR/STAIR OCC. LOAD ALLOWED DOOR/STAIR CAPACITY.		NON SIMULTANEOUS OCCUPANCY
	HC ACCESSIBLE ROUTE		OCCUPANT LOAD
	1 HOUR RATED WALL ASSEMBLY		2 HOUR RATED VERTICAL SHAFT ASSEMBLY
	2 HOUR RATED WALL ASSEMBLY		







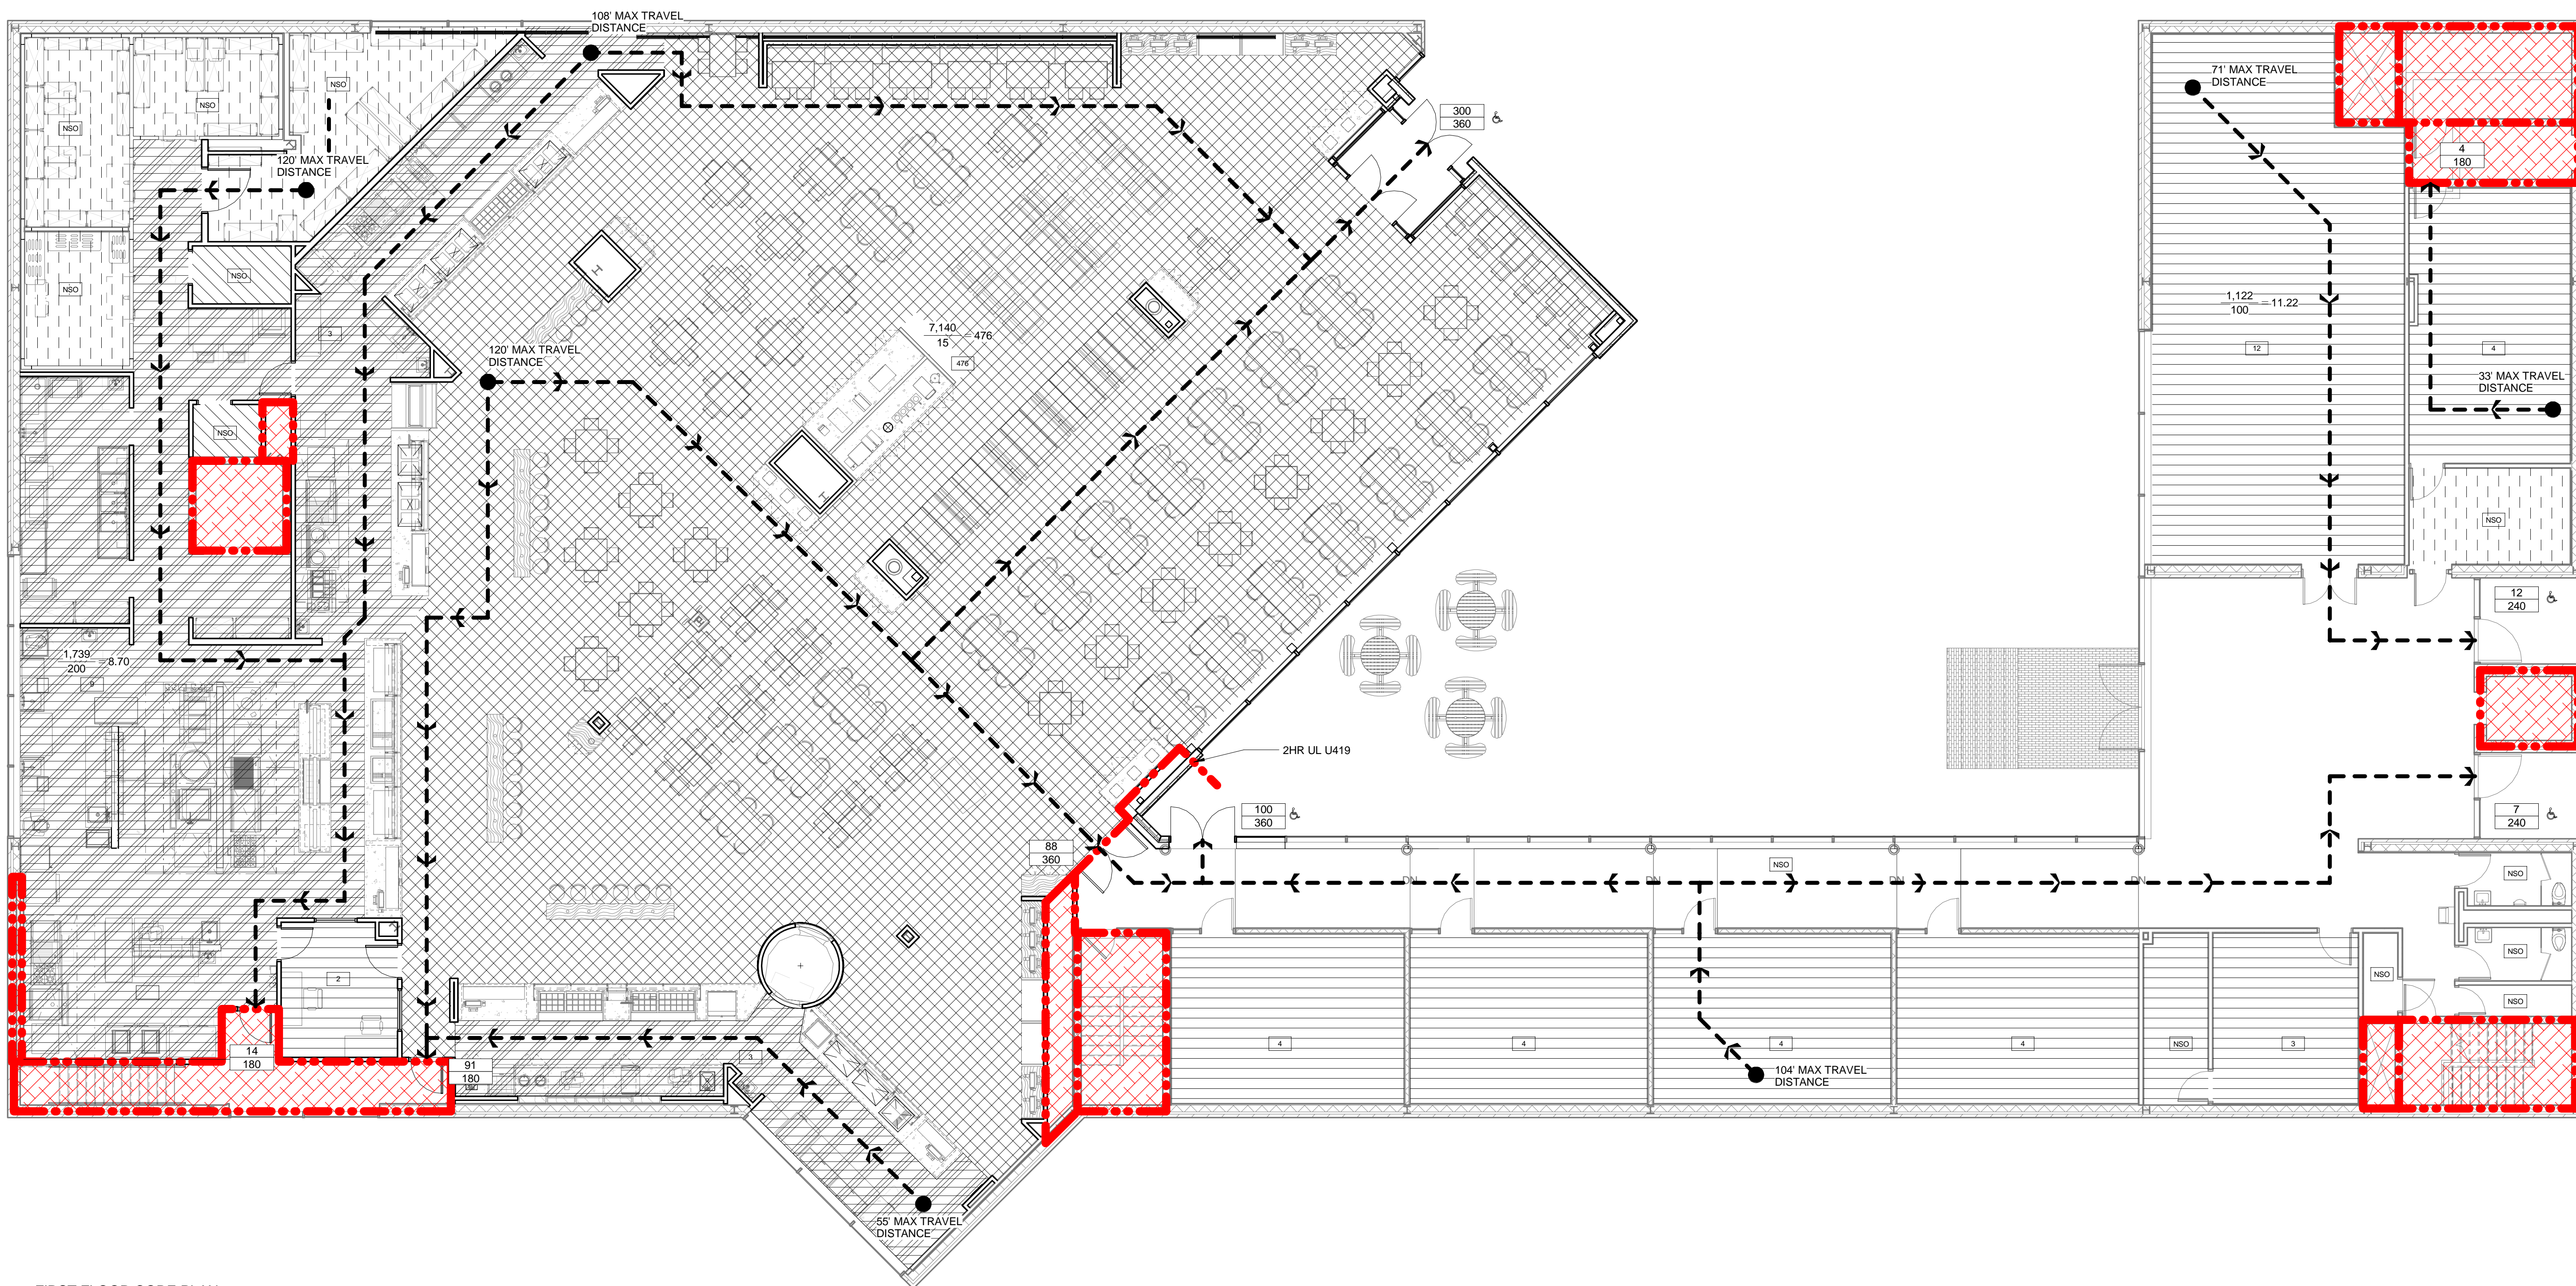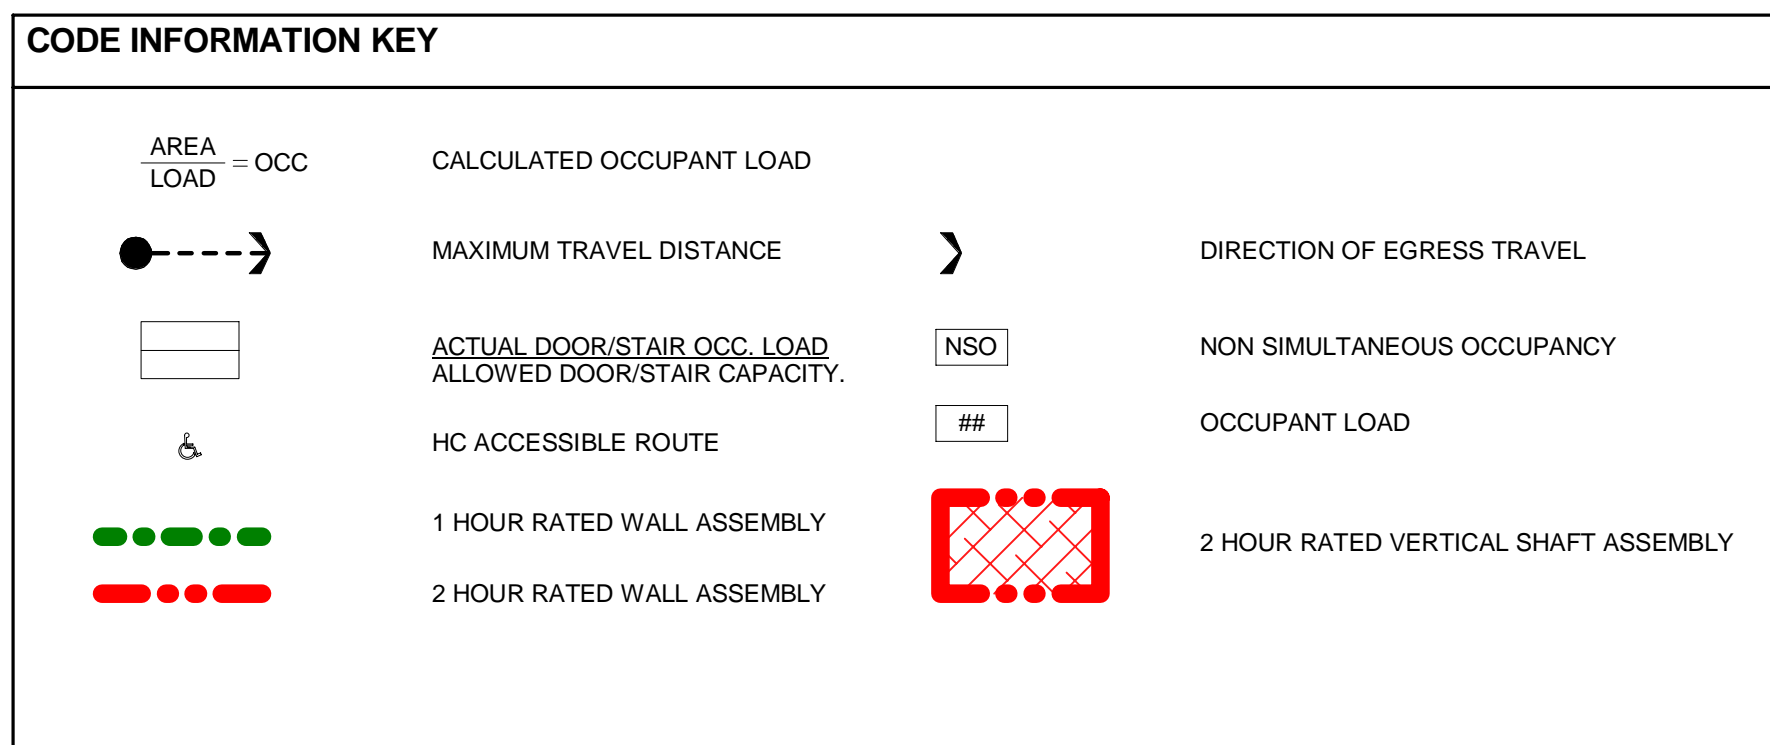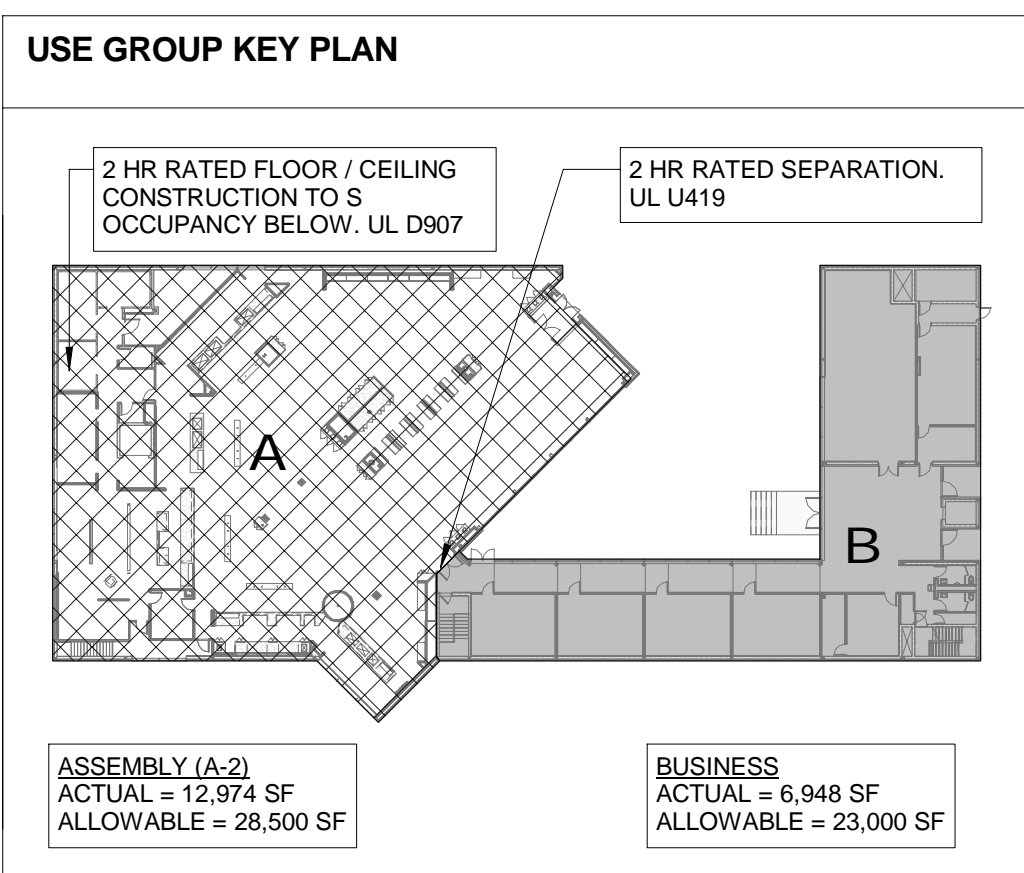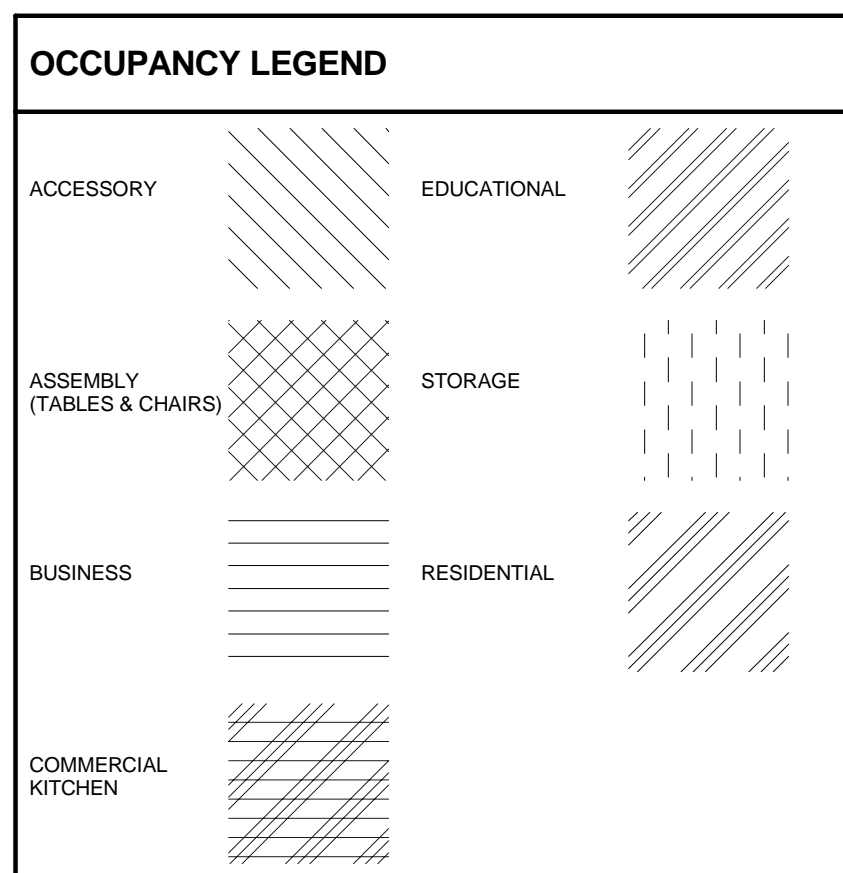

① FIRST FLOOR CODE PLAN  
1/8" = 1'-0"



Plot Date: 2/20/2018 5:42:14 PM Dwg Filename: C:\Users\woodworth\Documents\SUNY Purchase - Hub\_1\_woodworth.rvt

AREA  
LOAD = OCC

MAXIMUM TRAVEL DISTANCE

HC ACCESSIBLE ROUTE

1 HOUR RATED WALL ASSEMBLY

2 HOUR RATED WALL ASSEMBLY

CALCULATED OCCUPANT LOAD

NSO

##

DIRECTION OF EGRESS TRAVEL

NON SIMULTANEOUS OCCUPANCY

OCCUPANT LOAD

2 HOUR RATED VERTICAL SHAFT ASSEMBLY

THIRD FLOOR

SECOND FLOOR

RESIDENTIAL (R-2)  
ACTUAL = 4,000 SF  
ALLOWABLE = 16,000 SF

BUSINESS  
ACTUAL = 4,000 SF  
ALLOWABLE = 23,000 SF

OCCUPANCY LEGEND

ACCESSORY

EDUCATIONAL


ASSEMBLY (TABLES & CHAIRS)

BUSINESS

COMMERCIAL KITCHEN

STORAGE

RESIDENTIAL

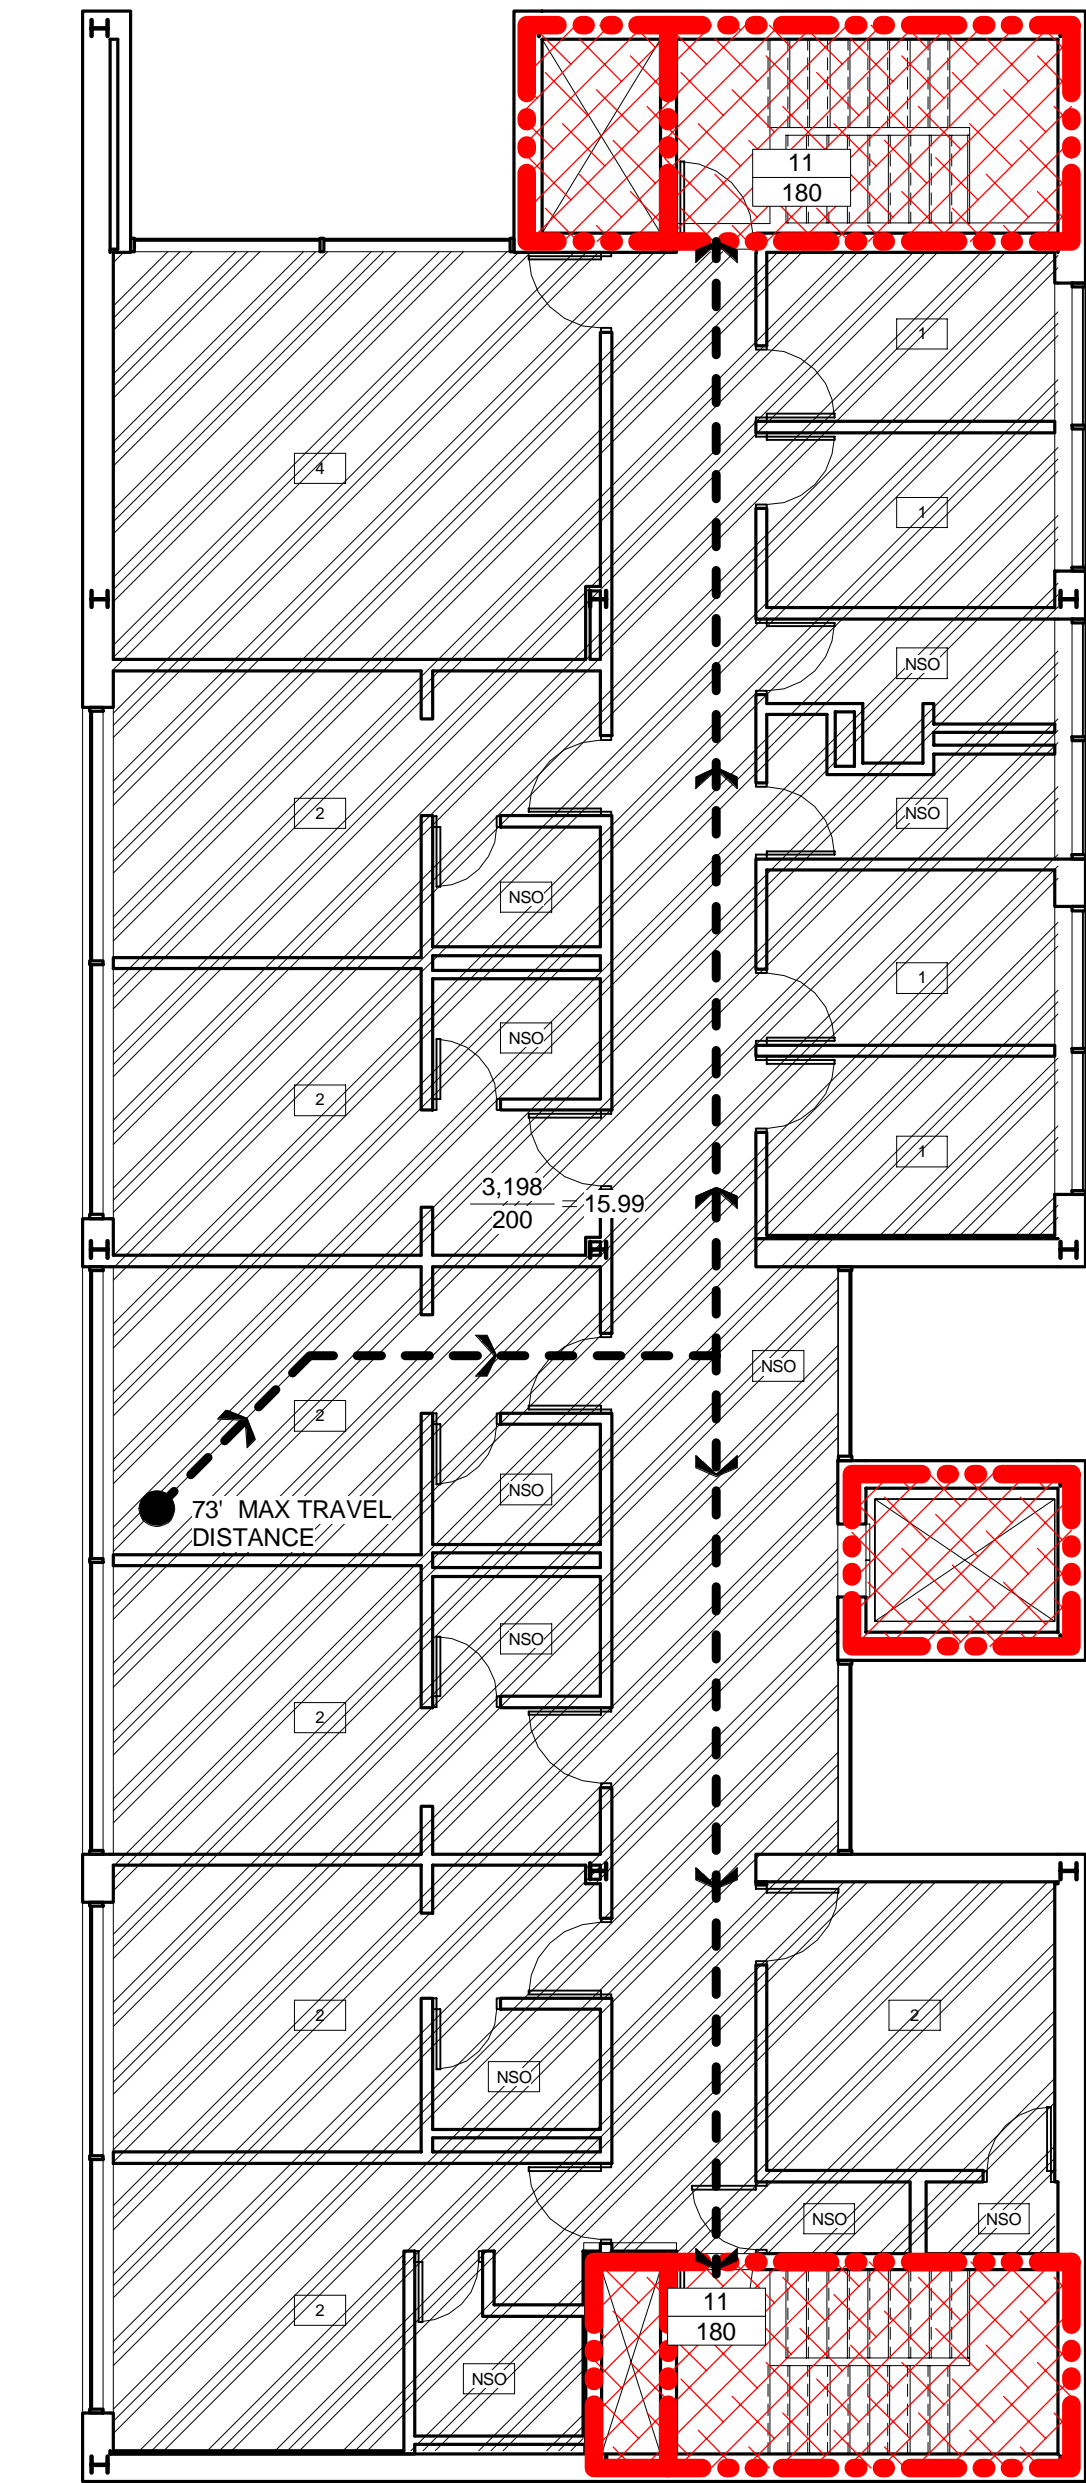



# DESIGN DEVELOPMENT PLANS

for

# Cafe Addition and Remodel


Purchase, NY 10577

## SITE INDEX

NO.	DRAWING TITLE	LATEST ISSUE
C-1	Cover Sheet	2/16/2018
C-2	General Notes	2/16/2018
C-3	Site Layout & Materials Plan	2/16/2018
C-4	Site Grading Plan	2/16/2018
C-5a	Site Utilities Plan	2/16/2018
C-5b	Site Utilities Plan	2/16/2018
C-6	Site Demolition & Erosion Control	2/16/2018
C-7	Site Details	2/16/2018
C-8	Site Details	2/16/2018

## SURVEY INDEX

NO.	DRAWING TITLE	LATEST ISSUE
TS105	Topographic Survey 5 Prepared by Badey & Watson	1/18/2012

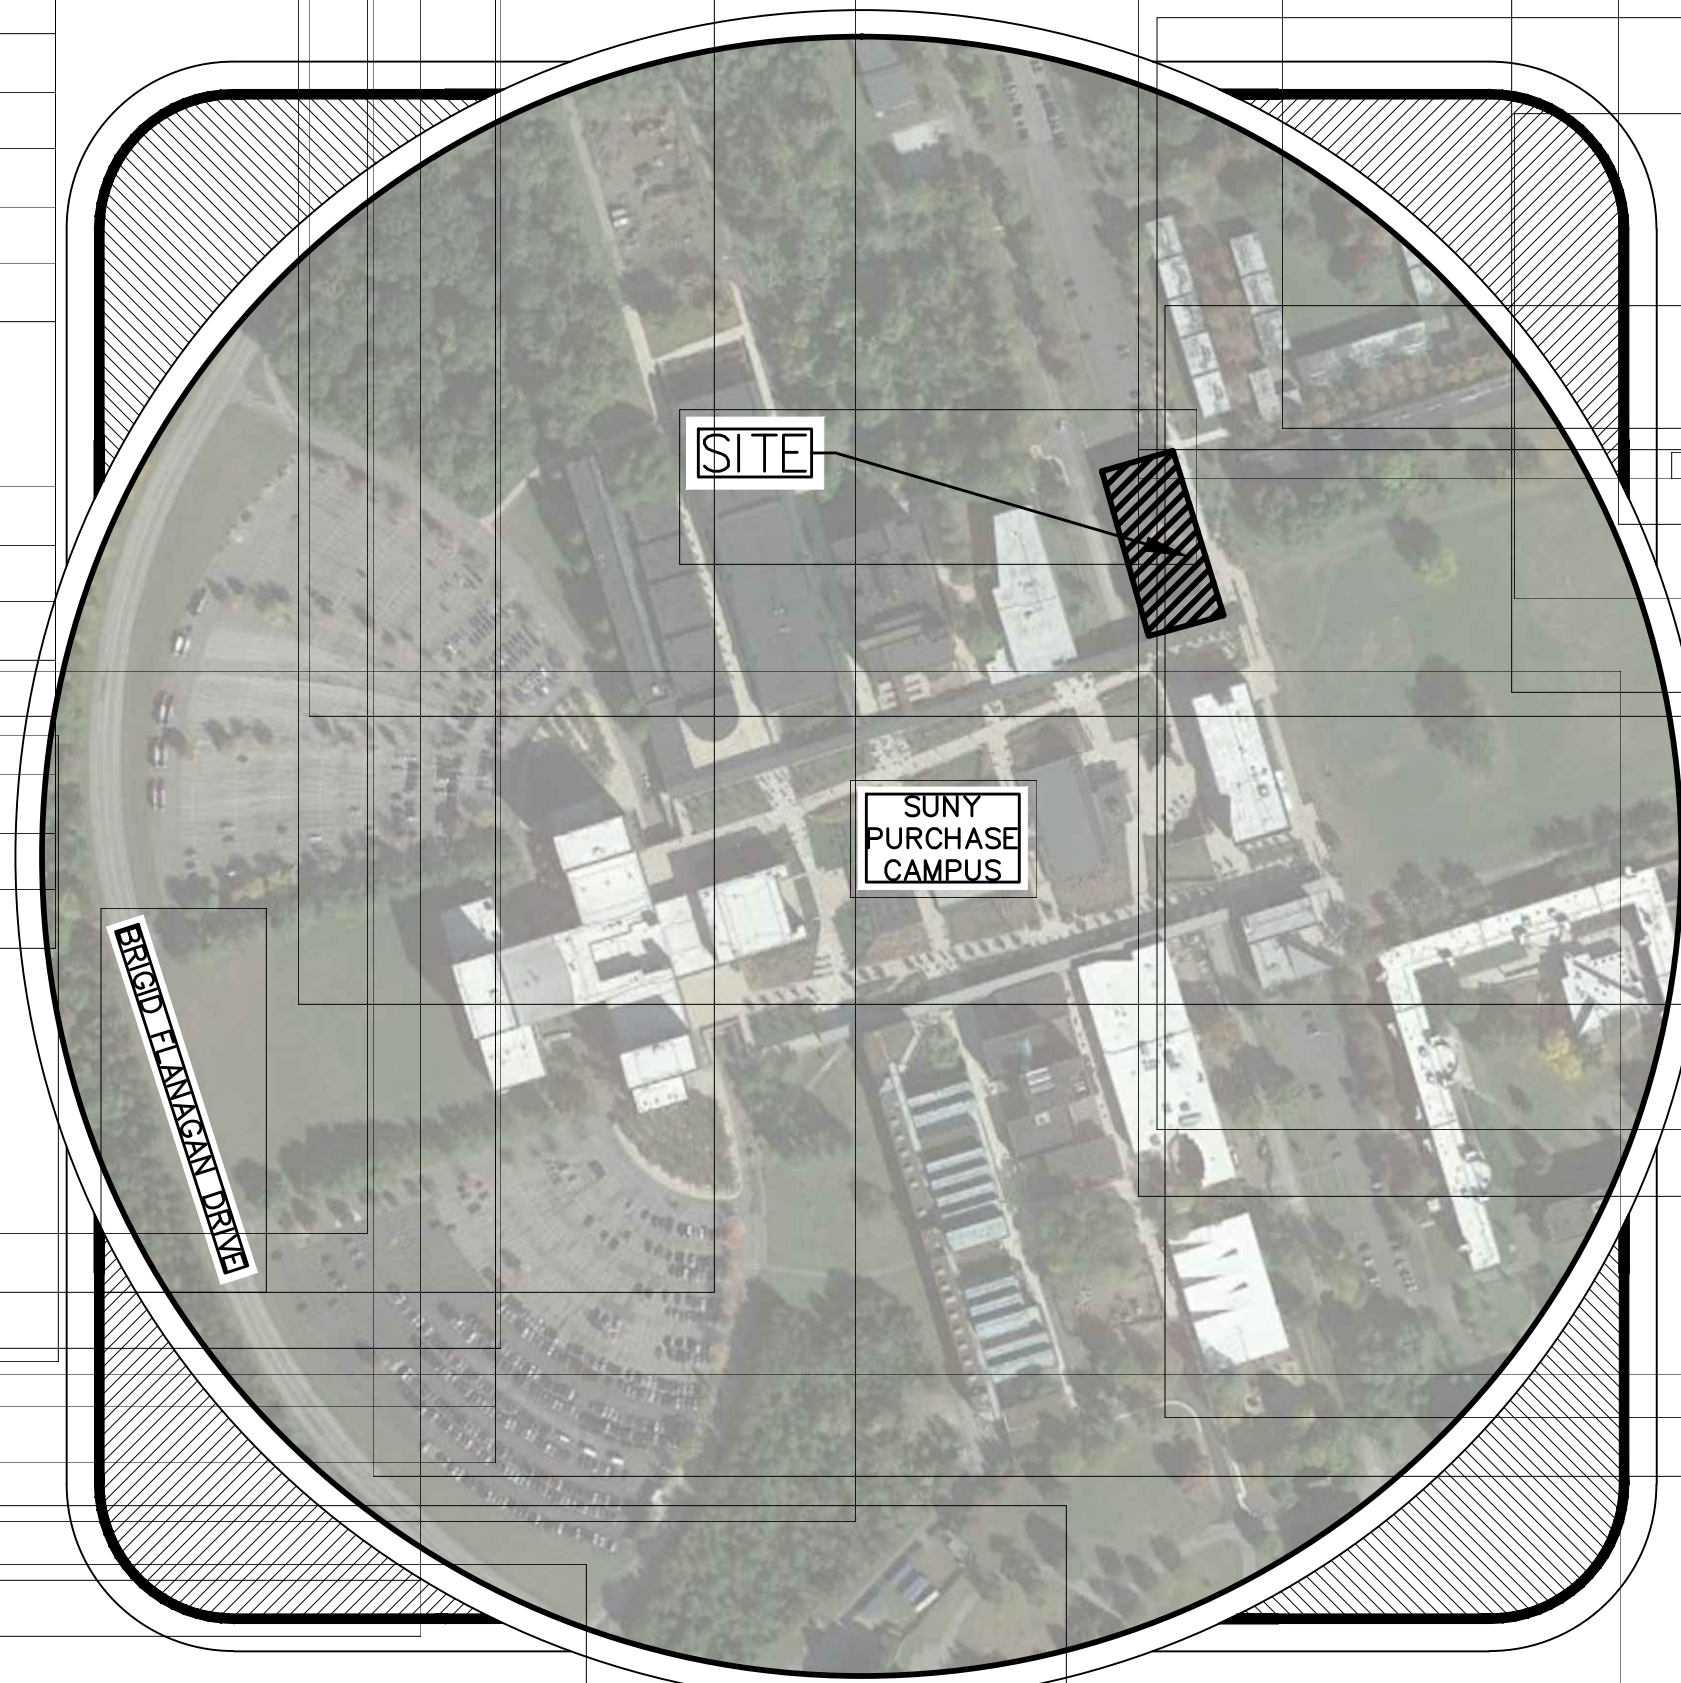

## UTILITY CONTACT

UTILITY	UTILITY CO.	CONTACT	TELEPHONE
ELECTRIC	CON EDISON	Bayly Tyler	PH. (800) 752-6633
	511 Theodore Fremd Aven Rye, NY 10580	WORK REQUEST	PH. 914-925-6036
WATER	WESTCHESTER JOINT WATER WORKS		PH. (914) 698-3500
	1625 Mamaroneck Ave. Mamaroneck NY 10543	COMMISSIONER	EMGCY. (914) 424-4371
SEWER	WESTCHESTER SEWER DISTRICT #1B		PH. (914) 995-8353
	1 FERNBROOK ST. YONKERS, NY 10705		
GAS	CON EDISON	Bayly Tyler	PH. (800) 752-6633
	511 Theodore Fremd Aven Rye, NY 10580	WORK REQUEST	PH. 914-925-6036
TELEPHONE	VERIZON		PH. (212) 890-0200
	BUSINESS SERVICES		FAX
	NEW YORK, NY 10001		
FIRE CHIEF	PURCHASE FIRE DEPARTMENT	MARTIN GOTTE	PH. (914) 253-9044
	614 ANDERSON HILL ROAD PURCHASE, NY 01105	CHIEF	
BUILDING OFFICIAL	HARRISON BUILDING DEPARTMENT	ROCCO GERMANI	PH. (914) 670-3053
	1 HEINEMAN PLACE HARRISON, NY 10528	BUILDING INSPECTOR	

## VICINITY MAP


$$1'' = 400$$

<b>OWNER:</b>	State University of New York Purchase College 735 Anderson Hill Road Purchase, NY 10577
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<b>APPLICANT:</b> State University of New York Purchase College 735 Anderson Hill Road Purchase, NY 10577	
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**DA DOUCET**  
**& ASSOCIATES**

Austin, Texas - Gonzales, Texas - Northampton, Massachusetts  
www.doucetandassociates.com

SUNY PURCHASE COLLEGE	CAFE ADDITION AND REMODEL
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PURCHASE, NY 10577

ARCHITECT



EIGHT WILCOX STREET  
SIMSBURY, CONNECTICUT 06070  
PHONE: (860) 264-1624  
FAX: (860) 264-1628  
[www.phasezerodesign.com](http://www.phasezerodesign.com)

CLIENT



SUNY PURCHASE COLLEGE  
735 ANDERSON HILL ROAD,  
PURCHASE, NY 10577

CONSULTANT



Civil Engineering & Planning  
123 Union Street - Suite 302  
Easthampton, MA 01027  
Phone: (413) 203-2349  
[www.doucetandassociates.com](http://www.doucetandassociates.com)

## REVISIONS

EV	DATE	DESCRIPTION / COMMENTS
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REAL

ISSUED FOR: OUT-TO-BID

ISSUED DATE: 2.16.2018

DRAWN BY: JBB

CHECKED BY: LAR

PROJECT NUMBER:

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DRAWING NAME

COVER SHEET

DRAWING NO.

C-1



EXISTING	PROPOSED	
		- LOCUS PROPERTY LINE
		- ABUTTER PROPERTY LINE
		- CHAIN LINK FENCE
		- STOCKADE FENCE
		- BASELINE
		- MAJOR CONTOUR (5 FEET)
		- MINOR CONTOUR (1 FOOT)
		- TREE LINE
		- UNDERGROUND WATER LINE
		- UNDERGROUND SEWER LINE
		- UNDERGROUND TELEPHONE LINE
		- UNDERGROUND DRAIN LINE
		- UNDERGROUND ELECTRIC LINE
		- UNDERGROUND GAS LINE
		- OVERHEAD WIRE
		- BOLLARD
		- SIGN
		- DOUBLE SIGN
		- IRON PIPE
		- PULL BOX
		- UTILITY POLE
		- BORING LOCATION
		- CATCH BASIN
		- DOUBLE CATCH BASIN
		- DRAIN MANHOLE
		- SEWER MANHOLE
		- HYDRANT
		- WATER VALVE
		- PLUG/STUB
		- LAMP POST
		- TEMPORARY BENCHMARK
		- GUARDRAIL
		- TREE (DECIDUOUS)
		- TREE (CONIFEROUS)
		- PARKING COUNT
		- HANDICAP RAMP
		- HANDICAP PARKING
		- VAN-ACCESSIBLE HANDICAP PARKING

ABAN	ABANDON
ACR	ACCESSIBLE CURB RAMP
ADJ	ADJUST
APPROX	APPROXIMATE
BB	BITUMINOUS BERM
BC	BITUMINOUS CURB
BOS	BOTTOM OF SLOPE
BS	BOTTOM OF SLOP
CC	CONCRETE CURB
CCB	CAPE COD BERM
CO&G	CONCRETE CURB & GUTTER
ELEV	ELEVATION
EXIST	EXISTING
FDN	FOUNDATION
GC	GRANITE CURB
GE	GRANITE EDGING
MAX	MAXIMUM
MCC	MONOLITHIC CONCRETE CURB
MIN	MINIMUM
NIC	NOT IN CONTRACT
NTS	NOT TO SCALE
PCC	PRECAST CONCRETE CURB
PROP	PROPOSED
REM	REMOVE
RET	RETAIN
REMOD	REMODEL
R&R	REMOVE AND RESET
R&S	REMOVE AND STACK
SGE	SLOPED GRANITE EDGING
SKF	STOCKADE FENCE
TOS	TOP OF SLOPE
TS	TOP OF SLOPE
TYP	TYPICAL
VCC	VERTICAL GRANITE CURB

ACCMP	ASPHALT COATED CORRUGATED METAL PIPE
CAP	CORRUGATED ALUMINUM PIPE
C&C	CUT AND CAPPED
CIP	CAST IRON PIPE
CIT	CHANGE IN TYPE
COND	CONDUIT
DIP	DUCTILE IRON PIPE
FES	FLARED END SECTION
F&G	FRAME AND GRATE
F&C	FRAME AND COVER
HDPE	HIGH DENSITY POLYETHYLENE PIPE
HH	ELECTRIC HANDHOLE
HYD	HYDRANT
INVT	INVERT ELEVATION
PVI	POST INDICATOR VALVE
PWW	PAVED WATER WAY
PVC	POLYVINYLCHLORIDE PIPE
RPV	REINFORCED CONCRETE PIPE
TSCV&B	TAPPING SLEEVE, VALVE AND BOX
UP	UTILITY POLE
VCP	VITRIFIED CLAY PIPE

1. EXISTING CONDITIONS INFORMATION WAS TAKEN FROM A SURVEY PERFORMED BY NORTHEAST SURVEY CONSULTANTS, DATE NOVEMBER 13, 2014 AND COMPILED FROM INFRASTRUCTURE CONSTRUCTION PLANS.
2. ALL WORK AND MATERIALS SHALL COMPLY WITH ALL LOCAL, STATE, AND/OR FEDERAL REGULATIONS GOVERNING SUCH OPERATIONS AND ALL OTHER O.S.H.A. STANDARDS.
3. CONTRACTOR SHALL REFER TO THE ARCHITECTURAL PLANS FOR EXACT LOCATIONS AND DIMENSIONS OF VESTIBULES, SLOPE PAVING, SIDEWALKS, EXIT PORCHES, PRECISE BUILDING DIMENSIONS, STAIRWAYS AND EXACT BUILDING UTILITY ENTRANCE LOCATIONS.
4. ALL DISTURBED AREAS ARE TO RECEIVE MINIMUM FOUR INCHES OF TOPSOIL, SEED, MULCH AND WATER UNTIL A HEALTHY STAND OF GRASS IS ESTABLISHED.
5. ALL EDGES OF PAVEMENT TO BE CURBED. BACK OF CURB SHALL BE FLUSH WITH GRADE UNLESS NOTED OTHERWISE. ALL CURBING AS NOTED ON THE DRAWINGS.
6. ALL PAVED RADII ARE TO BE 2' UNLESS OTHERWISE NOTED.
7. ALL DIMENSIONS AND RADII ARE TO THE EDGE OF PAVEMENT UNLESS OTHERWISE NOTED.
8. EXISTING STRUCTURES WITHIN CONSTRUCTION LIMITS ARE TO BE ABANDONED, REMOVED, REMODELED OR RELOCATED AS NECESSARY. ALL COST SHALL BE INCLUDED IN BASE BID.
9. EXISTING PAVED AREAS ON SITE (SITE DRIVE, SIDEWALKS, PARKING AREAS) SHALL RECEIVE A SURFACE COURSE AS SPECIFIED IN THE PAVING DETAILS. ADJUST STRUCTURE FRAMES TO MATCH FINISHED GRADE.
10. ALL CONSTRUCTION IN TOWN RIGHT-OF-WAYS AND/OR EASEMENTS SHALL BE IN ACCORDANCE WITH THE TOWN OF PURCHASE STANDARD SPECIFICATIONS.
11. IN THE EVENT OF DISCREPANCIES BETWEEN LOCAL SPECIFICATIONS & STATE SPECIFICATIONS, THE MORE STRINGENT REQUIREMENT SHALL GOVERN.
12. CONTRACTOR SHALL REFER TO ARCHITECTURAL DETAILS AND SPECIFICATIONS FOR REQUIREMENTS OF CONSTRUCTION AND JOINT SPACING OF SIDEWALKS, RAMPS, AND CURBING ADJACENT TO BUILDING.
13. CONTRACTOR IS RESPONSIBLE FOR REPAIRS OF DAMAGE TO ANY EXISTING IMPROVEMENTS DURING CONSTRUCTION, SUCH AS, BUT NOT LIMITED TO, DRAINAGE, UTILITIES, PAVEMENT, STRIPING, CURB, ETC. REPAIRS SHALL BE EQUAL TO OR BETTER THAN EXISTING CONDITIONS.
14. THE CONTRACTOR SHALL PROTECT ALL BENCHMARKS AND PROPERTY MONUMENTATION. BENCHMARKS AND MONUMENTATION DISTURBED DURING CONSTRUCTION SHALL BE REPLACED OR REPAIRED BY A LICENSED SURVEYOR AT THE CONTRACTORS EXPENSE.
15. ALL STRIPING, PAVEMENT MARKINGS, AND TRAFFIC SIGNAGE SHALL BE IN ACCORDANCE WITH THE TOWN OF PURCHASE TRAFFIC CONTROL DEVICES, LATEST EDITION, UNLESS OTHERWISE NOTED ON THE PLANS. STRIPED AREAS SHALL BE 2 FEET O.C. UNLESS OTHERWISE NOTED.

SITE ADDRESS:	735 ANDERSON HILL ROAD PURCHASE, NEW YORK 10577
PARCEL ID:	11110-0454
1. TOTAL PARCEL AREA:	479,595 SF. (11.0 AC.)
2. DEED REFERENCES:	Plan 211 Page 97
3. CURRENT ZONING:	R-2 ONE - FAMILY RESIDENCE
4. PROPOSED USES:	EDUCATIONAL
5. PROPOSED STRUCTURES:	+/-1,400 SF EXPANSION
6. FLOOD CERTIFICATION: THIS SITE IS ZONED "X" AS PER FIRM, FLOOD INSURANCE RATE MAP.	
7. TOPOGRAPHIC & BOUNDARY SURVEY, INCLUDING PROPERTY LINES, EXISTING UTILITIES, SITE TOPOGRAPHY WITH SPOT ELEVATIONS, OUTSTANDING PHYSICAL FEATURES AND EXISTING STRUCTURE LOCATIONS WAS PROVIDED BY THE FOLLOWING COMPANY & WAS DATED DECEMBER 23, 2014:	
	BADEY & WATSON 3043 ROUTE 9 COLD SPRING, NY 10516
	PRIOR TO RECORDING THE FINAL APPROVED SITE PLAN, AN AS-BUILT PLAN SHALL BE PROVIDED TO THE OWNER AND DUCUET & ASSOCIATES, INC.
8. DISPOSAL OF MATERIALS SHALL BE IN ACCORDANCE WITH ALL LOCAL, STATE, AND/OR FEDERAL REGULATIONS GOVERNING SUCH OPERATIONS.	
9. ALL CONSTRUCTION IN TOWN RIGHT-OF-WAY SHALL BE COORDINATED WITH THE PURCHASE DPW AND PURCHASE WATER & SEWER COMMISSION.	
10. ANY DEVELOPMENT, EXCAVATION, CONSTRUCTION IS SUBJECT TO LOCAL, STATE, AND FEDERAL APPROVALS. THE CONTRACTOR SHALL COMPLY WITH ALL PERMIT REQUIREMENTS AND/OR REGULATIONS AND ANY VIOLATION WILL BE SUBJECT TO PENALTY. THE CONTRACTOR SHALL HOLD THE OWNER/APPLICANT, THE ENGINEER AND THE LOCAL GOVERNING AGENCIES HARMLESS AGAINST SUCH VIOLATION.	
11. CONSTRUCTION OF BUILDING, AND UTILITY ENTRANCES SHALL BE IN ACCORDANCE WITH ASSOCIATED ARCHITECTS PLANS PREPARED BY PHASE ZERO DESIGN..	
12. THE AREA SHALL BE KEPT CLEAN AND FREE FROM DEBRIS AT ALL TIMES DURING CONSTRUCTION.	
13. ALL AREAS DISTURBED BY CONSTRUCTION SHALL BE RESTORED AND GRADED TO ORIGINAL GRADES UNLESS OTHERWISE SHOWN ON THE CONSTRUCTION DRAWINGS.	
14. A STORMWATER POLLUTION PREVENTION PLAN SHALL BE PREPARED FOR THIS PROJECT. THE CONTRACTOR IS RESPONSIBLE FOR IMPLEMENTING THIS PLAN AT THE JOB SITE.	
15. THE CONTRACTOR SHALL NOTIFY DIG SAFE @ 1-888-DIG-SAFE OR 811 PRIOR TO COMMENCEMENT OF ANY DEMOLITION/CONSTRUCTION ACTIVITY.	

1. PRIOR TO BEGINNING CONSTRUCTION, THE CONTRACTOR OR HIS AUTHORIZED REPRESENTATIVE SHALL CONVEY A PRE-CONSTRUCTION CONFERENCE BETWEEN THE TOWN OF PURCHASE REPRESENTATIVES, ENGINEER, ARCHITECT, UTILITY COMPANY REPRESENTATIVES, A.L.C. REPRESENTATIVE AND ANY OTHER AFFECTED PARTIES.
2. ALL AREAS DISTURBED BY CONSTRUCTION SHALL BE RESTORED AND GRADED TO ORIGINAL GRADATIONS UNLESS OTHERWISE SHOWN ON THE CONSTRUCTION DRAWINGS.
3. THE CONTRACTOR IS RESPONSIBLE FOR IMPLEMENTING THE STORMWATER POLLUTION PREVENTION PLAN AT THE WORK SITE. CONTRACTOR SHALL PROVIDE INLET PROTECTION TO ADJACENT SITE DRAINS AND/OR CATCH BASINS.
4. THE CONTRACTOR SHALL NOTIFY DPW SAFE @ 1-888-344-7233 PRIOR TO COMMENCEMENT OF ANY DEMOLITION/CONSTRUCTION ACTIVITY.
5. CONTRACTOR SHALL PROVIDE TWO SETS OF AS-BUILT DRAWINGS, PRIOR TO FINAL PRESENTATION. AS-BUILT DRAWINGS SHALL INCLUDE ALL INSTALLED UTILITIES WITH VERTICAL AND HORIZONTAL LOCATIONS. CONTRACTOR SHALL PROVIDE TWO SETS OF BUILDING OFFICIALS FOR ISSUANCE OF A CERTIFICATE OF OCCUPANCY. THE AS-BUILT DRAWINGS SHALL ALSO INCLUDE PIPE INVERTS, SPOT GRADES AND CONTOUR ELEVATIONS. THE FINAL PLAN SHALL BE STAMPED AND SIGNED BY A MASSACHUSETTS REGISTERED PROFESSIONAL LAND SURVEYOR.
6. PRIOR TO SUBMITTING THE NOTICE OF TERMINATION, CONTRACT SHALL CLEAN ALL STORMWATER DRAINAGE STRUCTURES, CATCH BASINS, OUTLET CONTROL STRUCTURES AND SUBSURFACE STORMWATER INFILTRATION ACCESS PORTS.
7. CONTACT THE PURCHASE WATER AND SEWER COMMISSION & DPW FOR REVIEW & APPROVAL OF ANY MODIFICATIONS TO THE APPROVED SITE PLANS PRIOR TO THE WORK BEING PERFORMED.
8. ANY WORK & MATERIAL WITHIN THE TOWN RIGHT-OF-WAY SHALL CONFORM TO THE TOWN OF PURCHASE STANDARD SPECIFICATIONS AND REQUIREMENTS.
9. THE PURCHASE WATER AND SEWER COMMISSION IS NOT PART OF DIGSAFE. FOR ANY UNDERGROUND UTILITY MARK OUT OF WATER OR SANITARY SEWER STRUCTURES, CONTACT THE COMMISSION OF FIELD SERVICES OFFICE AT 413-787-6206 A MINIMUM OF 72 HOURS BEFORE ANY EXCAVATION OCCURS.
10. CONSTRUCTION UPGRADES TO THE WATER AND SEWER SERVICES MAY ONLY BE PERFORMED BY COMMISSION APPROVED CONTRACTORS.
11. CONTRACTOR SHALL COORDINATE WITH THE COLLEGE AND ALL OTHER APPLICABLE AGENCIES FOR TEMPORARY LAND CLOSURES OR SHUT-DOWN OF LINCOLN AVENUE. CONTRACTOR SHALL PROVIDE SAFETY MEASURES INCLUDING FLAG MEN IF NEEDED.

1. THE CONTRACTOR IS SPECIFICALLY CAUTIONED THAT THE LOCATION AND/OR ELEVATION OF EXISTING UTILITIES AS SHOWN ON THESE PLANS IS BASED ON RECORDS OF THE VARIOUS UTILITY COMPANIES, AND WHERE POSSIBLE, MEASUREMENTS TAKEN IN THE FIELD. THE INFORMATION IS NOT TO BE RELIED ON AS BEING EXACT OR COMPLETE. THE CONTRACTOR SHALL NOT COLLAGE AN DIG-SAFE # 1-888-DIG-SAFE AT LEAST 72 HOURS PRIOR TO BEGINNING CONSTRUCTION TO REQUEST EXACT FIELD LOCATION OF UTILITIES. IT SHALL BE THE RESPONSIBILITY OF THE CONTRACTOR TO IDENTIFY ALL EXISTING UTILITIES WHICH CONFLICT WITH THE PROPOSED IMPROVEMENTS SHOWN ON THE PLANS.
2. ALL CUT OR FILL SLOPES SHALL BE 3:1 OR FLATTER UNLESS OTHERWISE NOTED.
3. PRECAST STRUCTURES MAY BE USED AT CONTRACTORS OPTION.
4. STORM PIPE SHALL BE AS FOLLOWS UNLESS OTHERWISE NOTED: HIGH DENSITY POLYETHYLENE PIPE (HDPE) SMOOTH INTERIOR/ANNUALER EXTERIOR. PIPE JOINTS AND FITTINGS SHALL CONFORM TO AASHTO M252 AND M294.
5. EXISTING DRAINAGE STRUCTURES TO BE INSPECTED AND REPAIRED AS NEEDED, AND EXISTING PIPES TO BE CLEANED OUT TO REMOVE ALL SILT AND DEBRIS.
6. EXISTING GRADE CONTOUR INTERVALS SHOWN AT 1 FOOT INTERVALS.
7. PROPOSED GRADE CONTOUR INTERVALS SHOWN AT 1 FOOT INTERVALS.
8. IF ANY EXISTING STRUCTURES TO REMAIN ARE DAMAGED DURING CONSTRUCTION IT SHALL BE THE CONTRACTORS RESPONSIBILITY TO REPAIR AND/OR REPLACE THE EXISTING STRUCTURE AS NECESSARY TO RETURN IT TO EXISTING CONDITIONS OR BETTER.
9. ALL STORM PIPES ENTERING STRUCTURES SHALL BE GROUTED TO ASSURE CONNECTION AT STRUCTURE IS WATERTIGHT.
10. ALL STORM SEWER MANHOLES IN PAVED AREAS SHALL BE FLUSH WITH PAVEMENT, AND SHALL HAVE TRAFFIC BEARING (H20) RIG & COVER MANHOLES
11. CONTRACTOR SHALL ADJUST AND/OR SAWCUT EXISTING PAVEMENT AS NECESSARY TO ASSURE A SMOOTH FIT AND CONTINUOUS GRADE.
12. CONTRACTOR SHALL ASSURE POSITIVE DRAINAGE AWAY FROM BUILDINGS FOR ALL NATURAL AND PAVED AREAS.
13. EXISTING CONDITIONS INFORMATION WAS TAKEN FROM A SURVEY PERFORMED BY NORTHEAST SURVEY CONSULTANTS. DATED NOVEMBER 13, 2014 AND COMPILED FROM INFRASTRUCTURE DESIGN PLANS.
14. ALL UNSURFACED AREAS DISTURBED BY GRADING OPERATION SHALL RECEIVE 4 INCHES OF TOPSOIL. CONTRACTOR SHALL APPLY STABILIZATION FABRIC TO ALL SLOPES STEEPER THAN 3H:1V. CONTRACTOR SHALL GRASS DISTURBED AREAS IN ACCORDANCE WITH THE SPECIFICATIONS UNTIL A PERMANENT STAND OF GRASS IS OBTAINED.
15. ALL STORM MANHOLES SHALL HAVE A SMOOTH UNIFORM POURED MORTAR INVERT FROM INVERT IN TO INVERT OUT.
16. IF CONTRACTOR RELOCATES OR SETS NEW BENCHMARKS, THE VERTICAL ELEVATIONS OF THE BENCHMARKS SHALL BE SET, BY A LICENSED SURVEYOR, WITHIN A TOLERANCE OF 0.010 FT.
17. ALL UTILITY ADJUSTMENTS SHALL BE COMPLETED PRIOR TO FINAL PAVING CONSTRUCTION.

1. ALL FILL MATERIAL IS TO BE IN PLACE, AND COMPACTED BEFORE INSTALLATION OF PROPOSED UTILITIES.
2. CONTRACTOR SHALL NOTIFY THE COLLEGE AND APPLICABLE UTILITY AUTHORITY INSPECTORS 72 HOURS BEFORE CONNECTING TO ANY EXISTING LINE.
3. SANITARY SEWER PIPE SHALL BE AS FOLLOWS:  
SDR35 PER ASTM D 3034, FOR PIPES LESS THAN 12" DEEP  
SDR26 PER ASTM D 3034, FOR PIPES MORE THAN 12" DEEP
4. WATER LINES SHALL BE AS FOLLOWS: ALL WATER SYSTEM COMPONENTS AND WATER LINES SHALL COMPLY WITH TOWN OF PURCHASE WATER & SEWER COMMISSION GUIDELINES & POLICIES AND ANY OTHER PUBLISHED TOWN SPECIFICATIONS OR REQUIREMENTS.
5. CONTRACTOR SHALL MAINTAIN A MINIMUM OF 5' COVER ON ALL WATERLINES.
6. WATER AND SANITARY SEWER SEPARATION SHALL BE 10' MIN. HORIZONTAL FROM OUTSIDE EDGE OF PIPES. IF HORIZONTAL SEPARATION CAN NOT BE OBTAINED, THE WATER LINE SHALL BE INSTALLED A MIN. OF 18" ABOVE SANITARY SEWER LINE. THE SANITARY SEWER LINE SHALL BE DUCTILE IRON PIPE WITH MECHANICAL JOINTS AT LEAST 10 FEET ON BOTH SIDES OF CROSSING, THE WATER LINE SHALL HAVE MECHANICAL JOINTS WITH APPROPRIATE THRU-BLOCKING AS REQUIRED TO PROVIDE AN 18" VERTICAL CLEARANCE. MEETING REQUIREMENTS OF ASTM A21.10 OR ANSI 21.11 (AWWA C-151) (CLASS 52).
7. LINES UNDERGROUND SHALL BE INSTALLED, INSPECTED AND APPROVED BEFORE BACKFILLING.
8. TOPS OF EXISTING MANHOLES AND OTHER STRUCTURES SHALL BE RAISED AS NECESSARY TO BE FLUSH WITH PROPOSED PAVEMENT ELEVATIONS. ALL UTILITY ADJUSTMENTS SHALL BE COMPLETED PRIOR TO FINAL PAVING CONSTRUCTION.
9. ALL CONCRETE FOR ENCASEMENTS SHALL HAVE A MINIMUM 28 DAY COMPRESSION STRENGTH AT 3000 P.S.I.
10. DRAWINGS DO NOT PURPORT TO SHOW ALL EXISTING UTILITIES.
11. EXISTING UTILITIES SHALL BE VERIFIED IN FIELD PRIOR TO INSTALLATION OF ANY NEW LINES.
12. REFER TO ARCHITECTURAL INTERIOR DRAWINGS FOR TIE-IN OF ALL UTILITIES.
13. CONTRACTOR IS RESPONSIBLE FOR COMPLYING TO THE SPECIFICATIONS OF THE TOWN OF PURCHASE WITH REGARDS TO MATERIALS OF THE WATER AND SEWER LINES.
14. THE CONTRACTOR IS SPECIFICALLY CAUTIONED THAT THE LOCATION AND/OR ELEVATION OF EXISTING UTILITIES AS SHOWN ON THESE PLANS IS BASED ON RECORDS AND FIELD SURVEY. UTILITY LOCATIONS MAY VARY FROM POSSIBLE MEASUREMENTS TAKEN IN THE FIELD. THE INFORMATION IS NOT TO BE RELIED ON AS BEING EXACT OR COMPLETE. THE CONTRACTOR SHALL CONTACT DIG SAFE @ 1-888-DIG-SAFE AT LEAST 48 HOURS PRIOR TO ANY EXCAVATION. IN ORDER TO REQUEST EXACT FIELD LOCATION OF UTILITIES, IT SHALL BE THE RESPONSIBILITY OF THE CONTRACTOR TO RELOCATE ALL EXISTING UTILITIES WHICH CONFLICT WITH THE PROPOSED IMPROVEMENTS SHOWN ON THE PLANS.
15. ALL NECESSARY INSPECTIONS AND/OR CERTIFICATIONS REQUIRED BY CODES AND/OR UTILITY SERVICE COMPANIES SHALL BE PERFORMED PRIOR TO ANNOUNCED BUILDING POSSESSION AND THE FINAL SECTION OF SERVICE.
16. CONTRACTOR SHALL COORDINATE WITH ALL UTILITY COMPANIES FOR INSTALLATION REQUIREMENTS AND SPECIFICATIONS.
17. REFER TO ARCHITECT PLANS FOR SITE LIGHTING ELECTRICAL PLAN
18. CONTRACTOR SHALL COMPLY WITH THE LATEST OSHA STANDARDS & TOWN OF PURCHASE DPW SPECIFICATIONS FOR EXCAVATION AND TRENCHING PROCEDURES. THE CONTRACTOR SHALL BE RESPONSIBLE FOR THE DESIGN AND MAINTENANCE OF ALL SUPPORT SYSTEMS, SLOPING, BENCHING, AND OTHER MEANS OF PROTECTION.
19. CONTRACTOR SHALL ENSURE UNINTERRUPTED SERVICE OF ALL EXISTING UTILITIES ON THE SITE INCLUDING BUT NOT LIMITED TO SEWER, WATER, ELECTRIC, GAS, TELEPHONE, CATV AND OTHERS.
20. SITE LIGHT POLES ARE TO REMAIN AND BE RELOCATED AS INDICATED ON THE PLAN.

[illegible]

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**CAFE ADDITION AND REMODEL**  
735 ANDERSON HILL ROAD  
PURCHASE, NY 10577

103

[illegible]

SEA

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ISSUED DATE: 2.16.2018

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CHECKED BY: LAR  
PROJECT NUMBER:  
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## LEGEND & GENERAL NOTES

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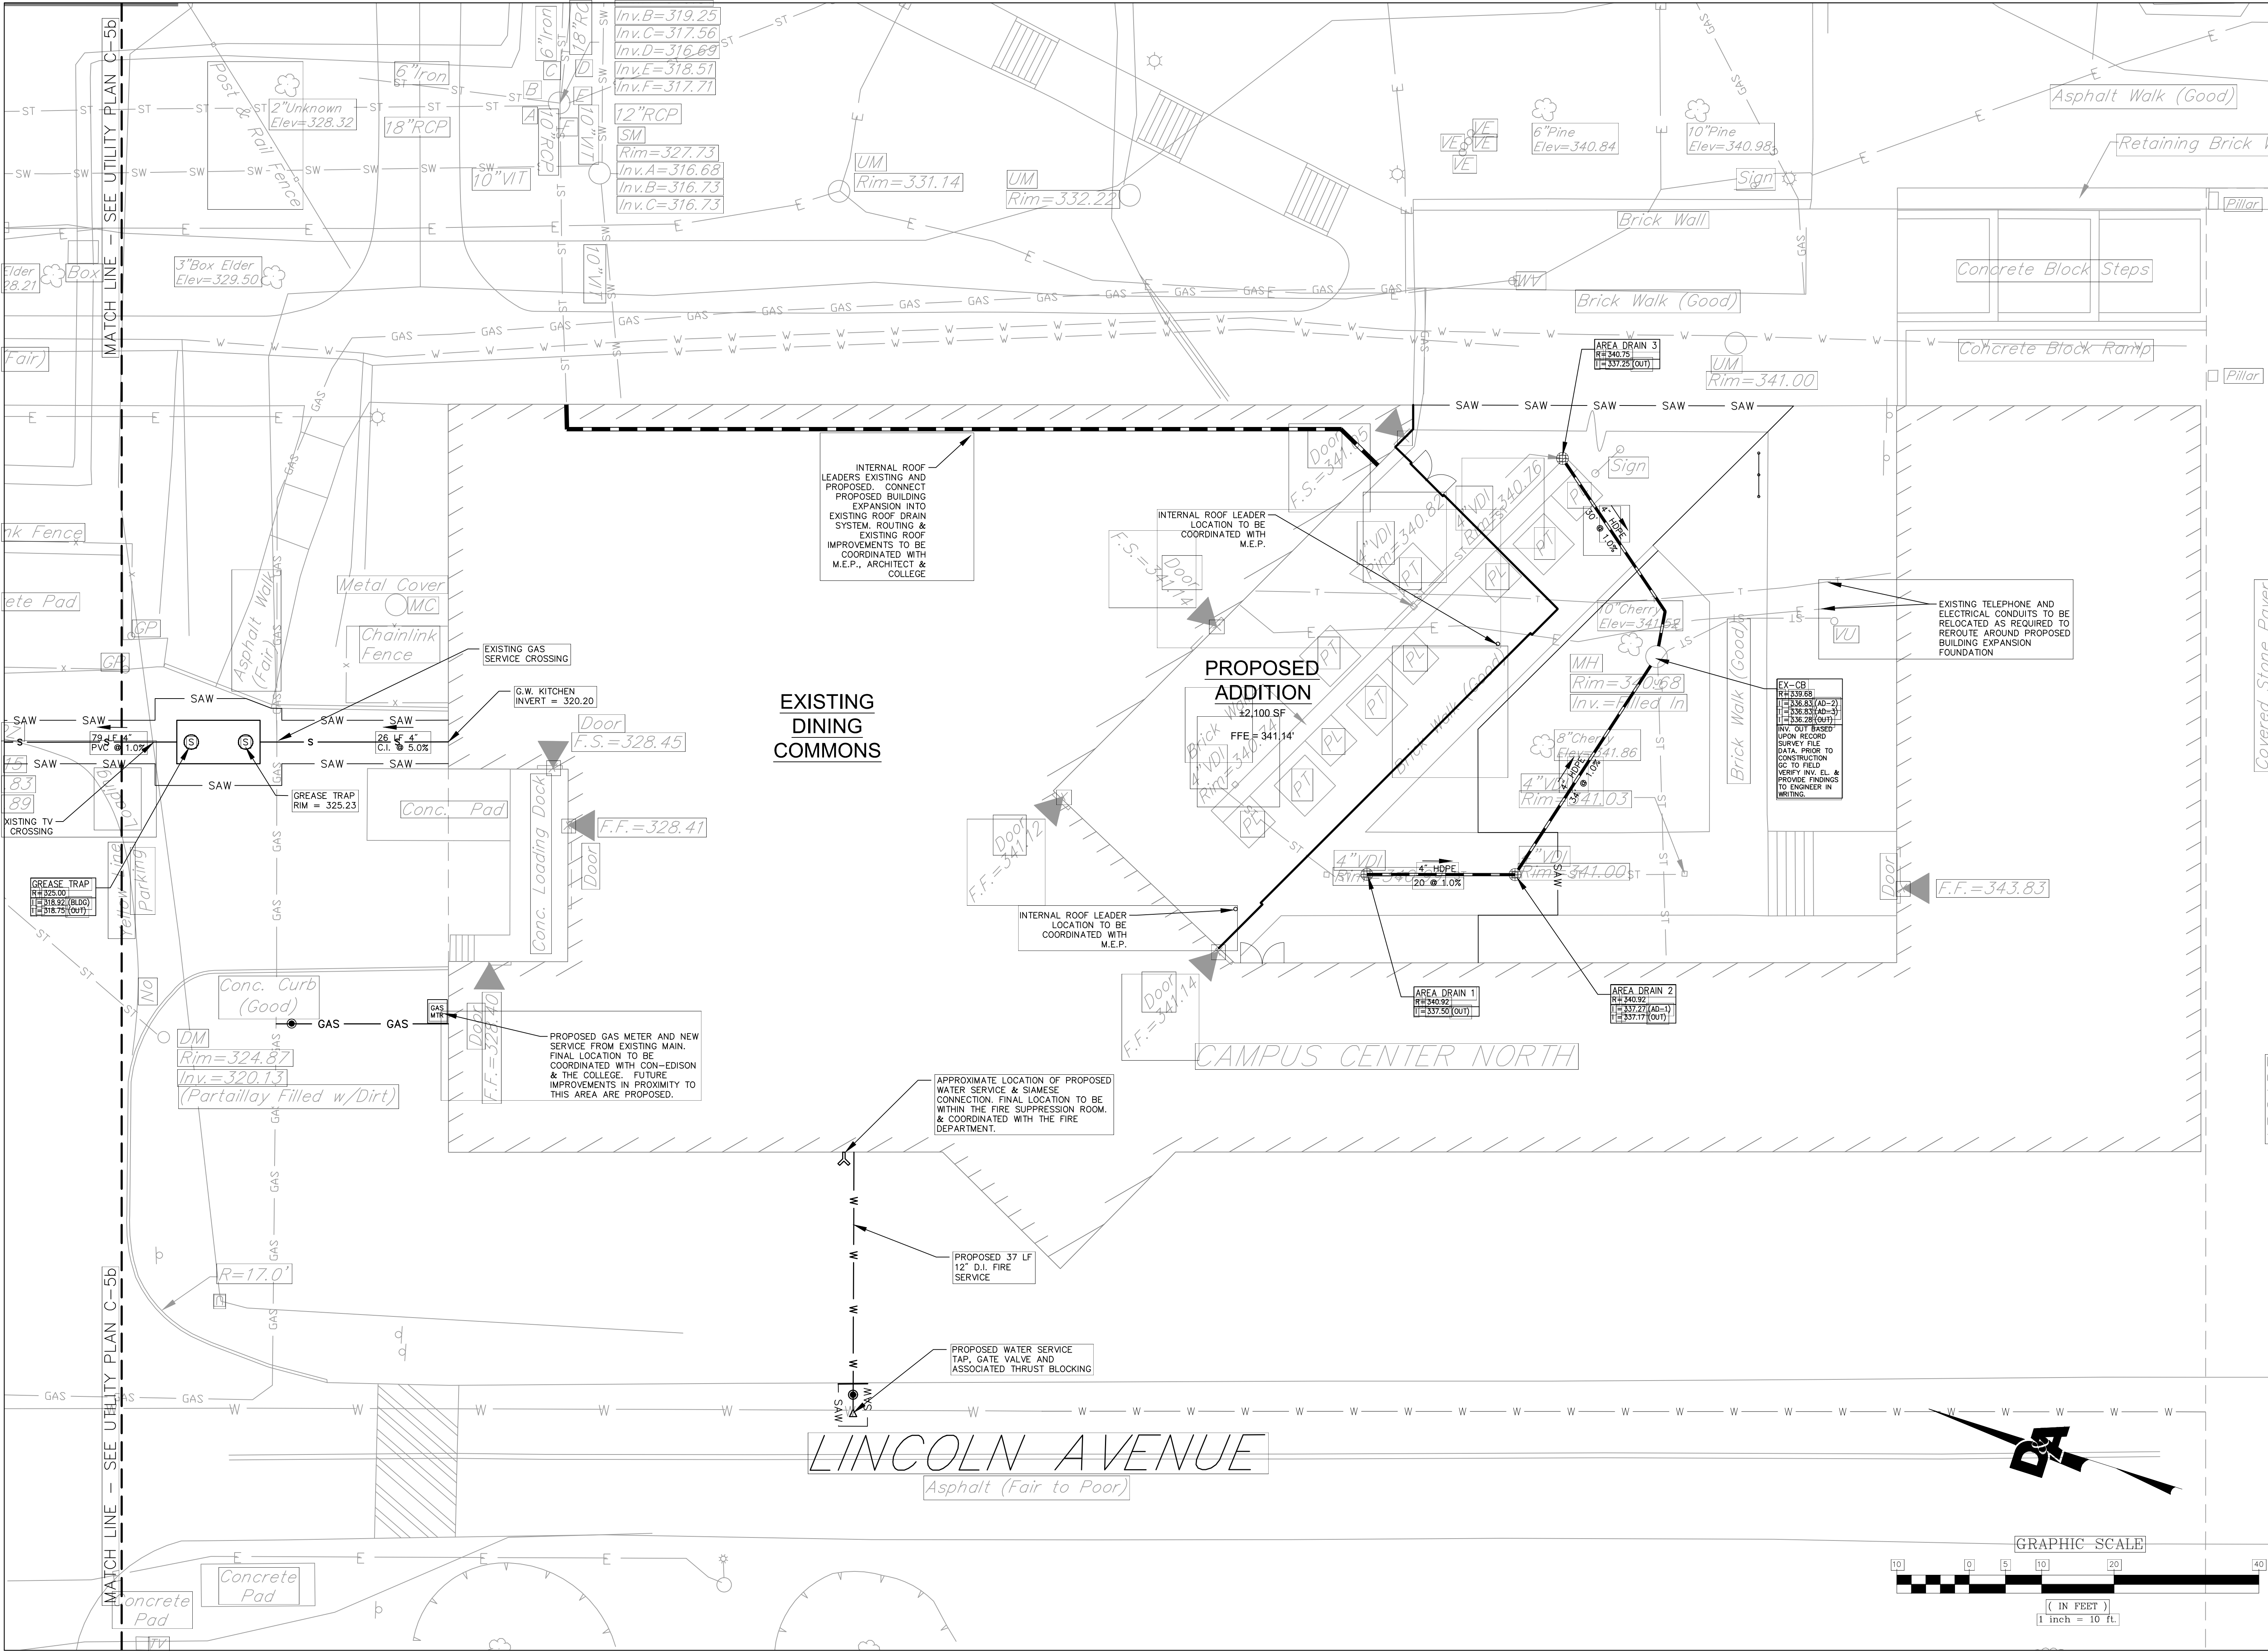
















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
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PURCHASE, NY 10577

PROJECT

REV	DATE	DESCRIPTION / COMMENTS
1	1-26-2018	ADD NEW WATER & GAS SERVICES TO DC


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**SITE  
UTILITY  
PLAN**

DRAWING NO.  
**C-5a**





ARCHITECT
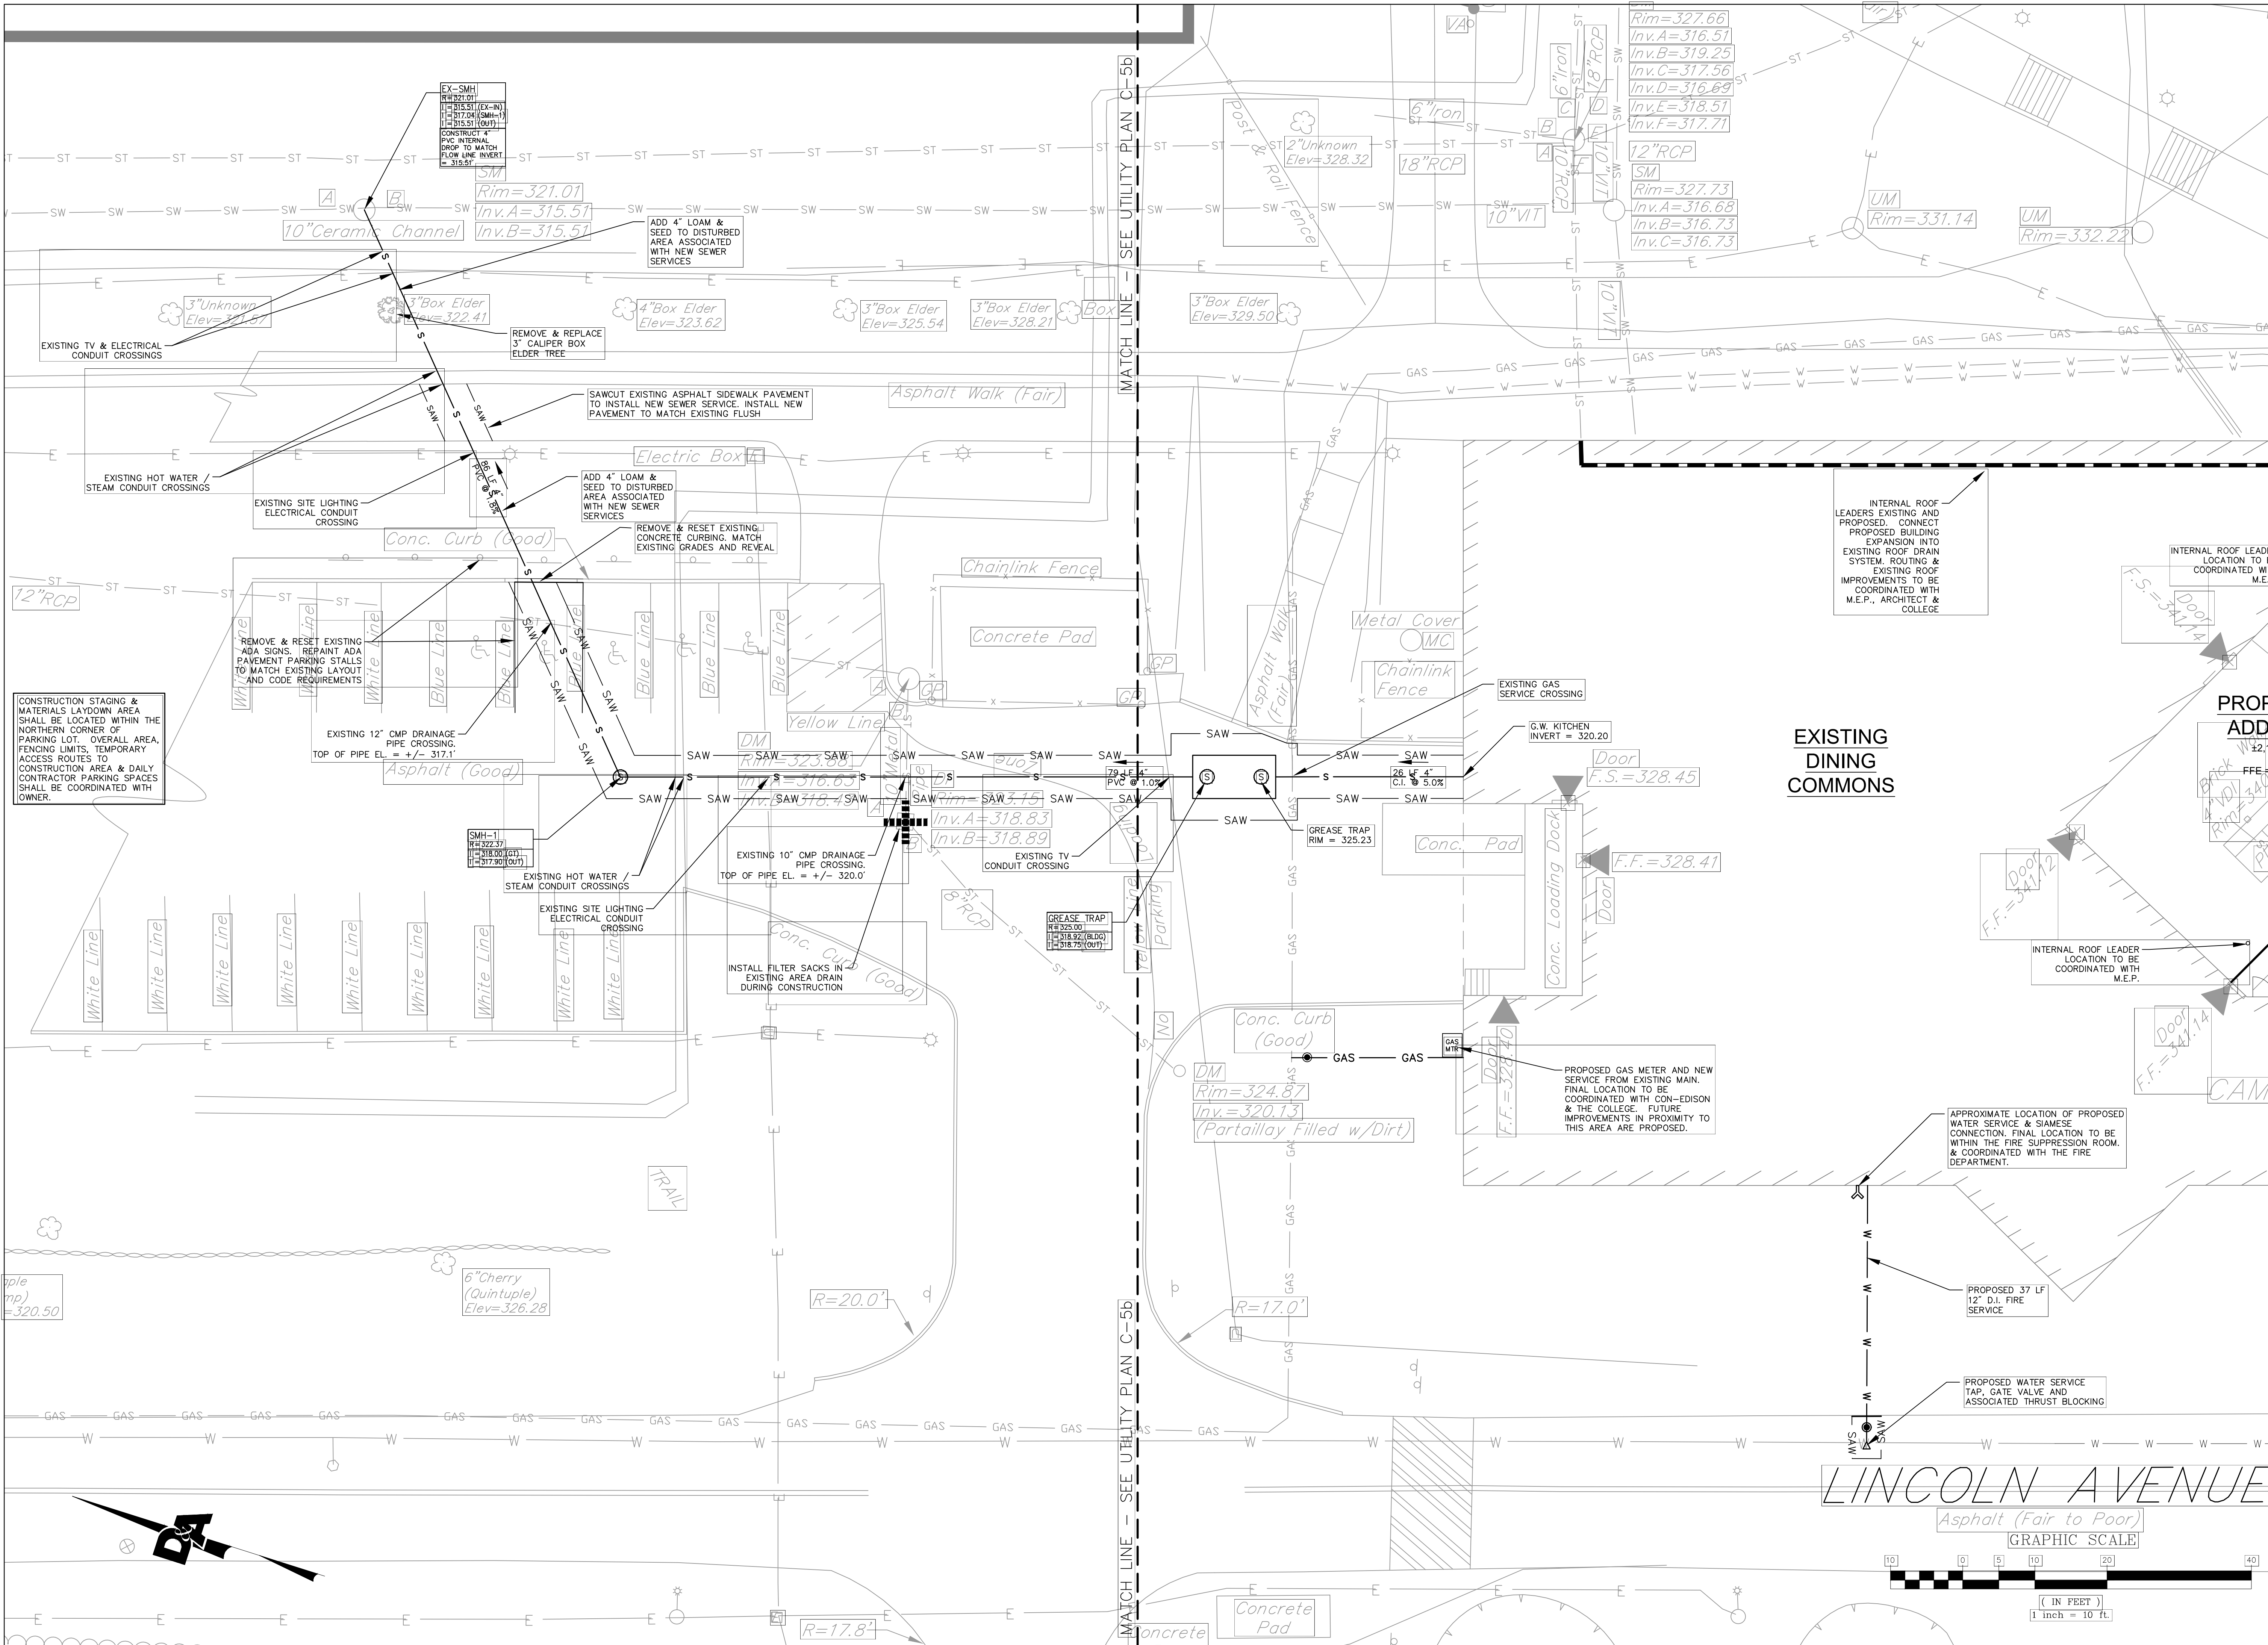
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REVISIONS

REV	DATE	DESCRIPTION / COMMENTS
1	1-26-2018	ADD NEW WATER & GAS SERVICES TO DC

ISSUED FOR: OUT-TO-BID  
ISSUED DATE: 2.16.2018


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CHECKED BY: LAR  
PROJECT NUMBER:  
DRAWING NAME

**SITE UTILITY PLAN**


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**C-5b**



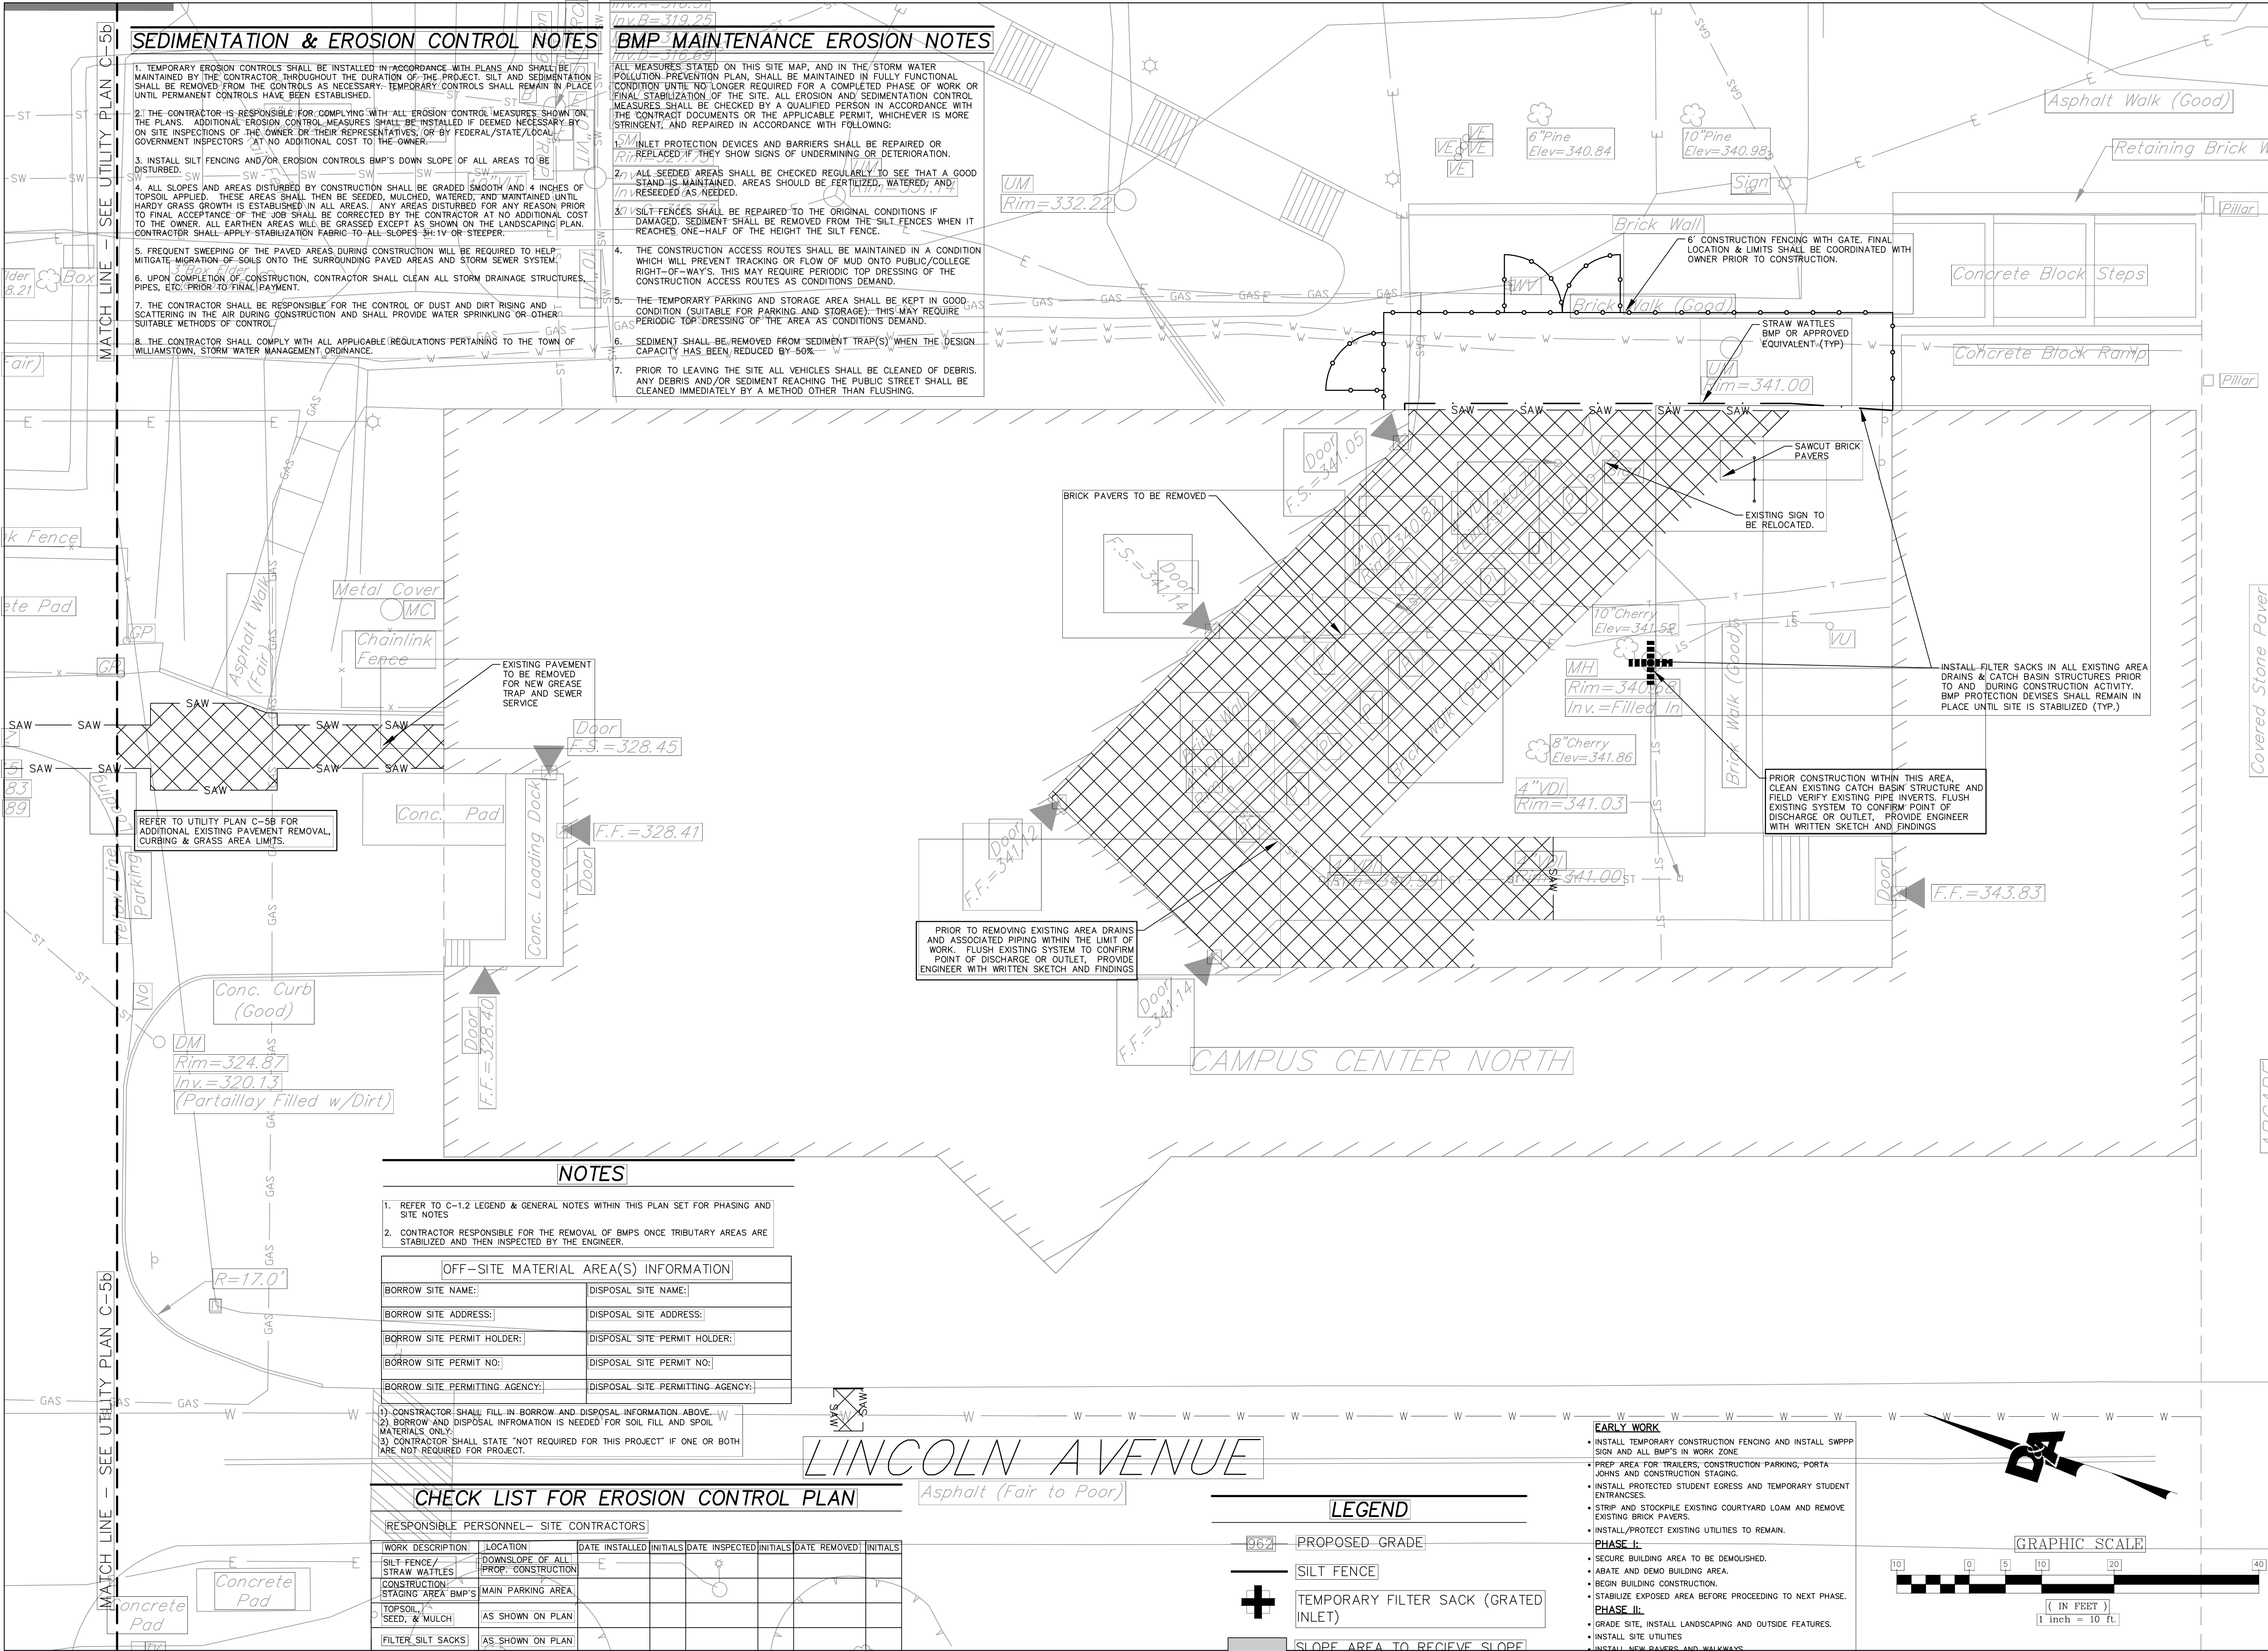


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
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REV	DATE	DESCRIPTION / COMMENTS
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DRAWING NAME

SITE  
DEMOLITION &  
EROSION  
CONTROL

DRAWING NO.

C-6













REHABILITATE  
PLAZA EXTERIOR  
PATHWAYS

State University of  
New York at  
Purchase College

PRIME CONSULTANT:

**abb**  
**Abel Bainnson Butz, LLP**  
LANDSCAPE ARCHITECTS/SITE PLANNERS  
80 8th Avenue, Suite 1105  
New York, NY 10011  
p 212.206.0630 f 212.645.0048 www.abbnyc.com


**CIVIL MEP ENGINEER:**  
CHU AND GASSMAN CONSULTING  
ENGINEERS  
559 Union Avenue  
Middlesex, NJ 08846

**BUILDING ENVELOPE CONSULTANT:**  
ERWIN LOBO BIELINSKI, PLLC  
37 West 39th Street, Suite 1201  
New York, NY 10018

**ENVIRONMENTAL ENGINEER:**  
WARREN & PANZER ENGINEERS, P.C.  
228 East 45th Street, 10th Floor  
New York, NY 10017

**COST CONSULTANT:**  
TOSCANO CLEMENTS TAYLOR  
227 Main Street  
Huntington, NY 11743


**PREPARED BY:**  
BADEY & WATSON  
3043 Route 9  
Cold Spring, NY 10516

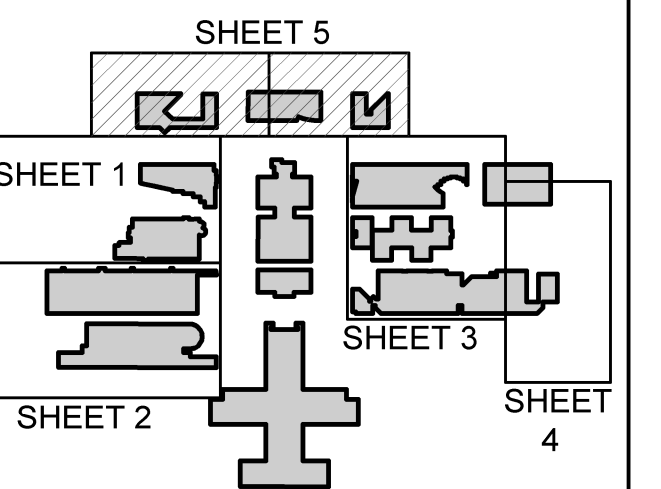

Key Plan

FOR ALL NOTES SEE SHEET 5  
FOR LEGEND SEE SHEET 5

No. 8	1/18/12	Edited Frame
No. 7	1/13/12	Additional Topography
No. 6	1/04/12	Additional Topography
No. 5	12/20/11	Additional Topography
No. 4	8/4/11	Additional Topography
No. 3	6/24/11	Additional Topography
No. 2	6/2/11	Sheet Set Reformatted
No. 1	5/11/11	Original Issue


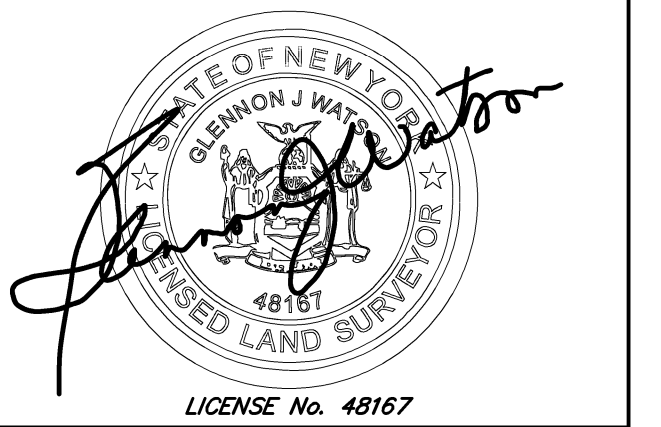


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Drawing Title:

TOPOGRAPHIC SURVEY 5

Contract No.	SUCF 29435
Drawn by:	DAP
Approved by:	GJW
Scale:	1"=20'
Date:	APRIL 28, 2011
Sheet No.	9 of 58



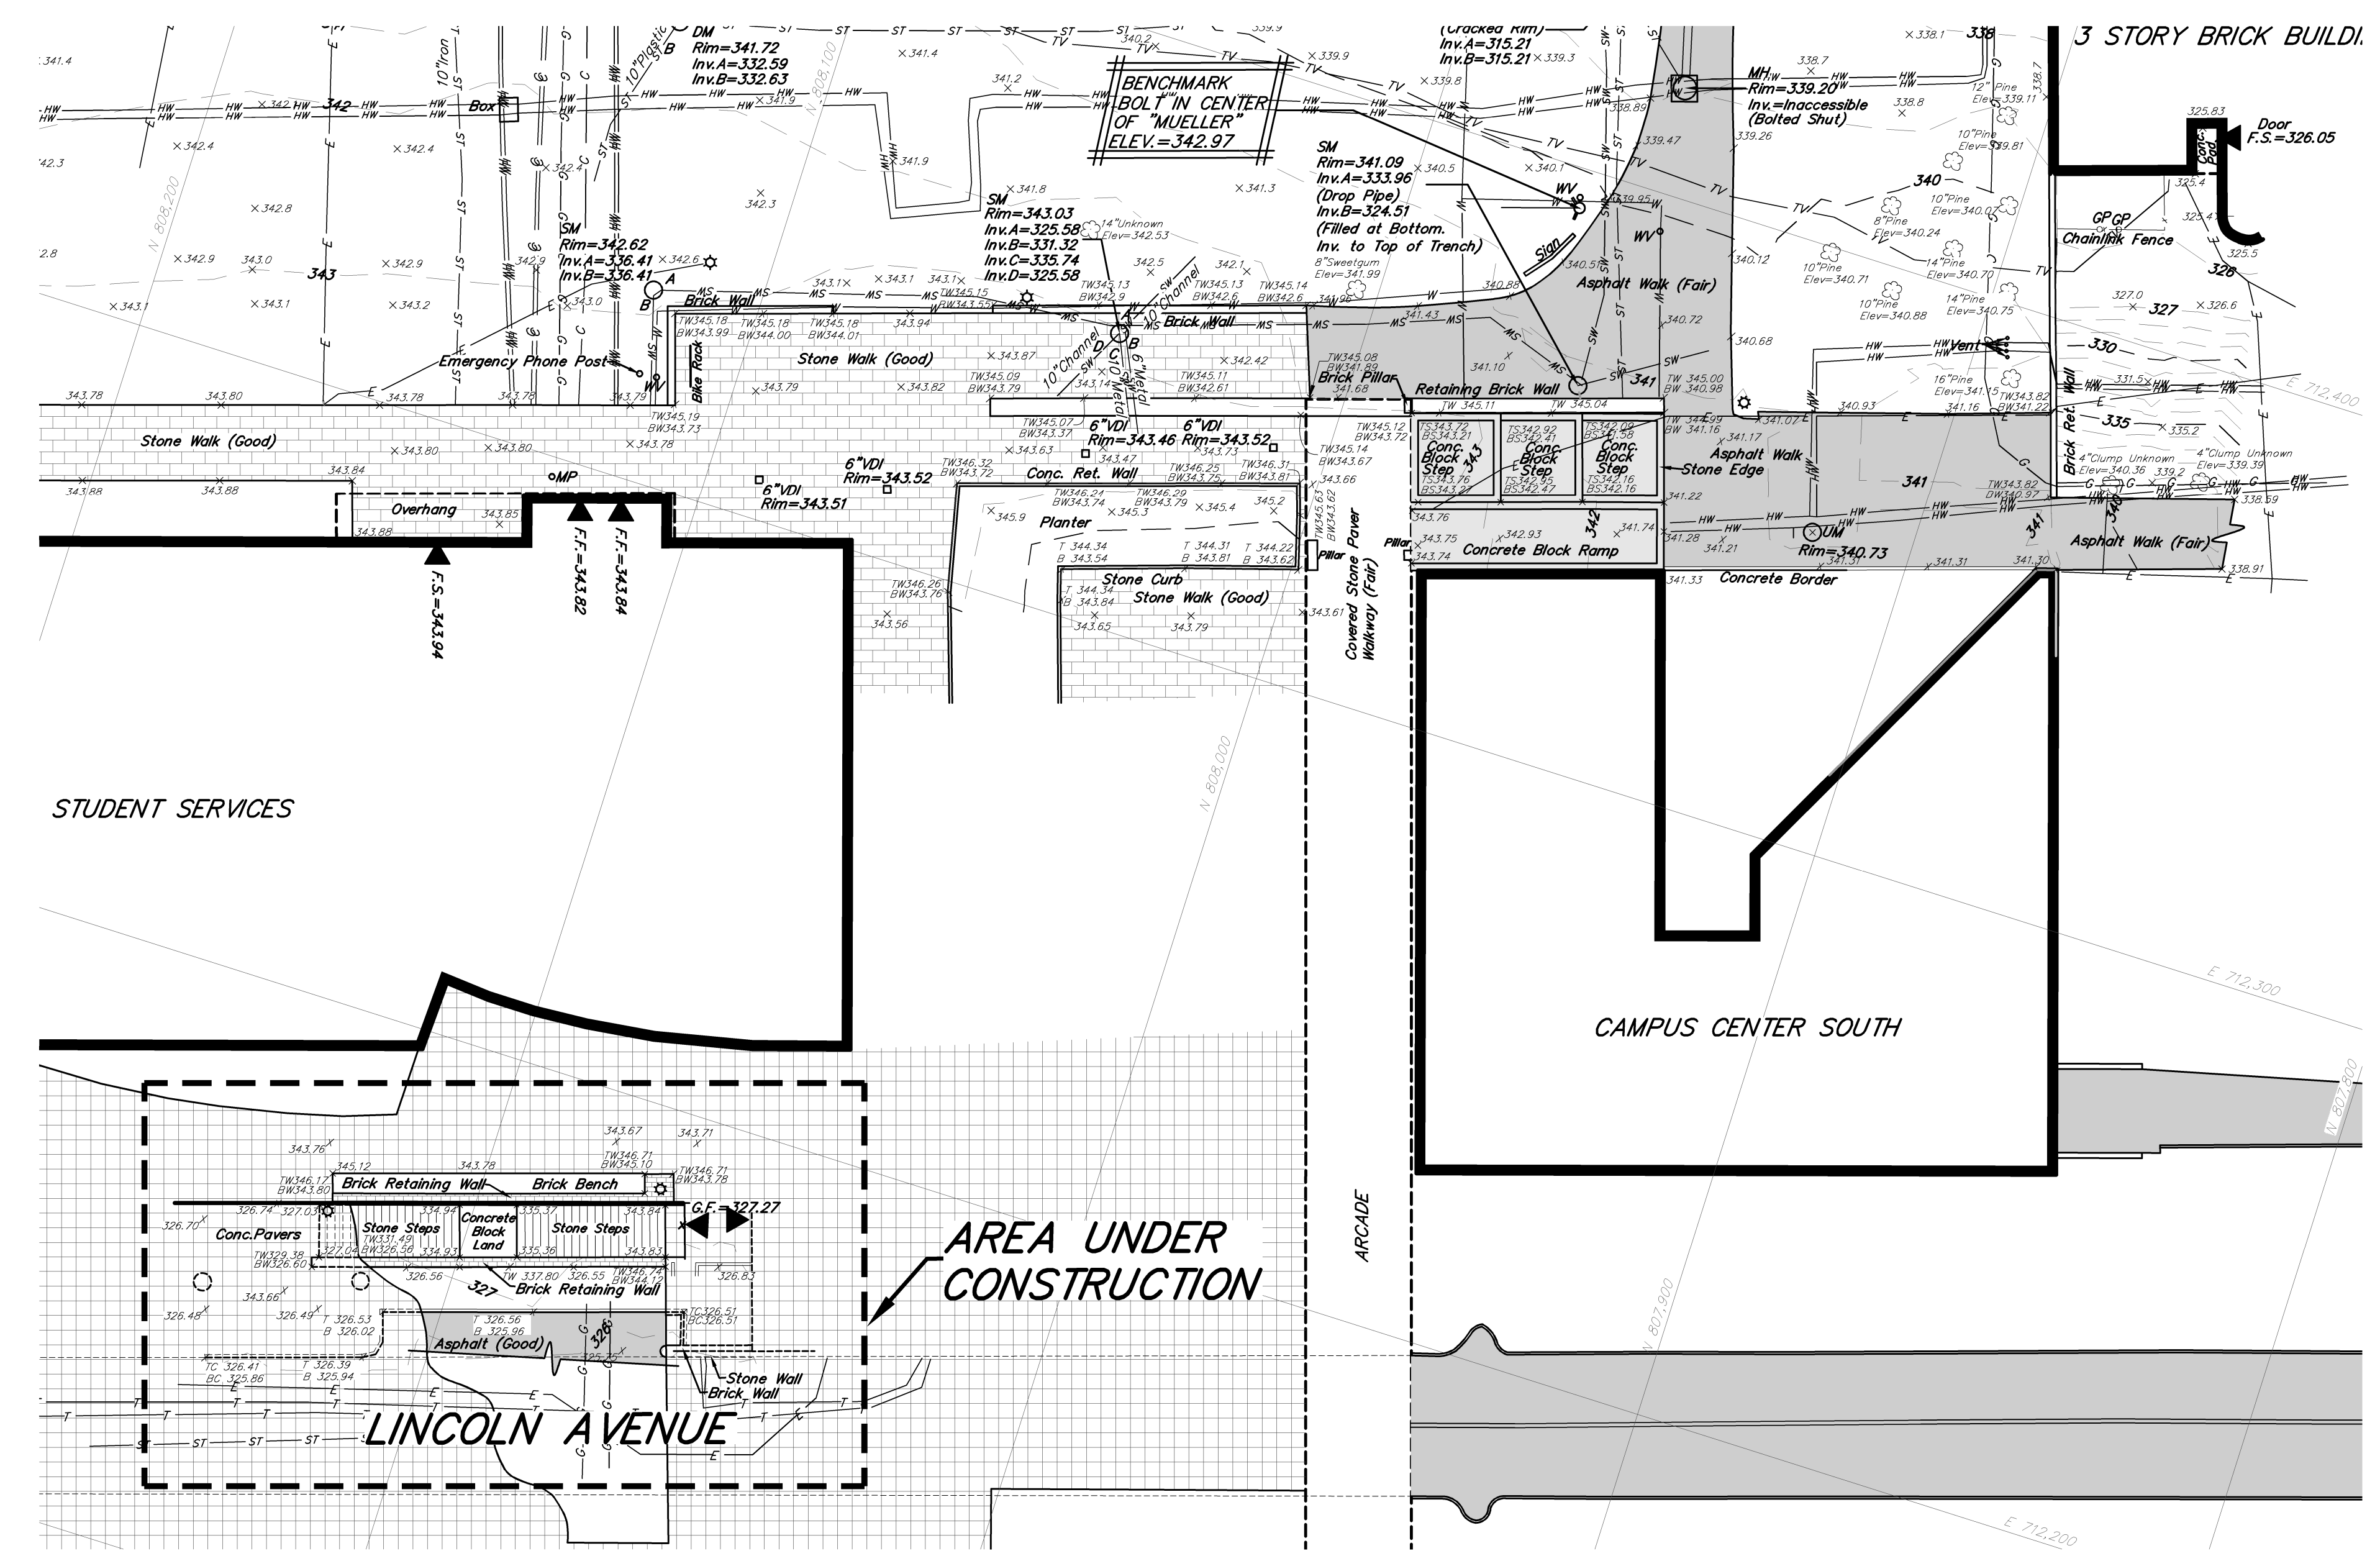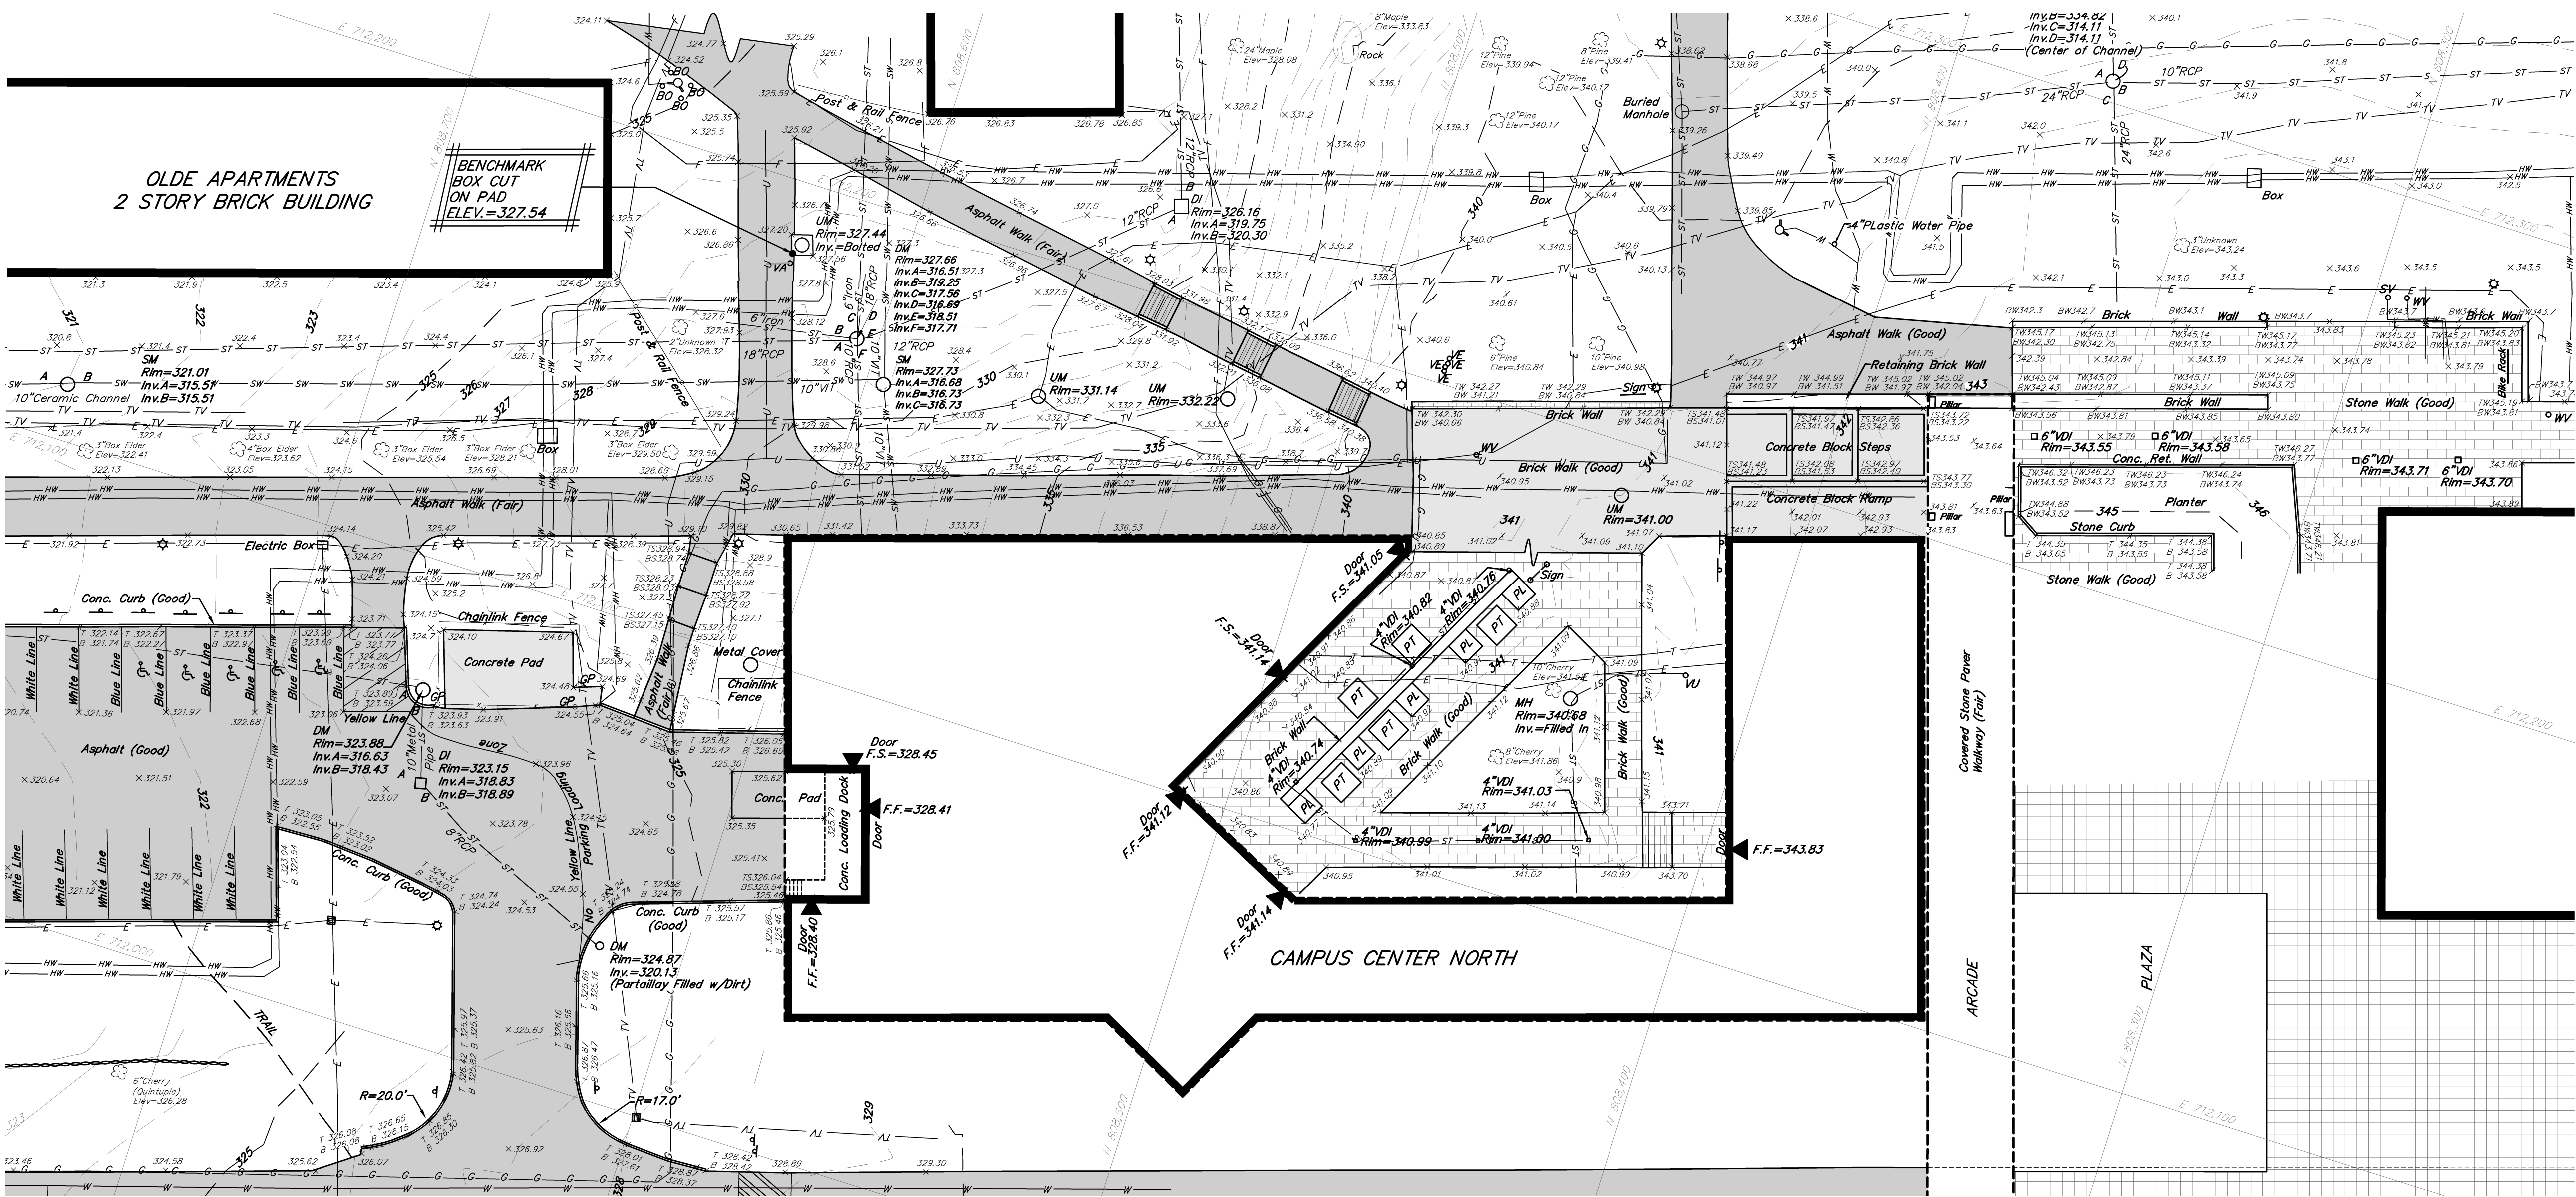










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DEMO CEILING	
1	REMOVE EXISTING GYPSUM CEILING/SOFFIT IN IT'S ENTIRETY.
2	REMOVE EXISTING ACT TILE CEILING IN IT'S ENTIRETY.
3	REMOVE EXISTING SPLINE CEILING IN IT'S ENTIRETY.
4	GC IS TO REMOVE PORTION OF EXISTING TILE CEILING.
5	REMOVE ALL EXISTING LIGHT FIXTURES IN THIS AREA UNLESS OTHERWISE NOTED.

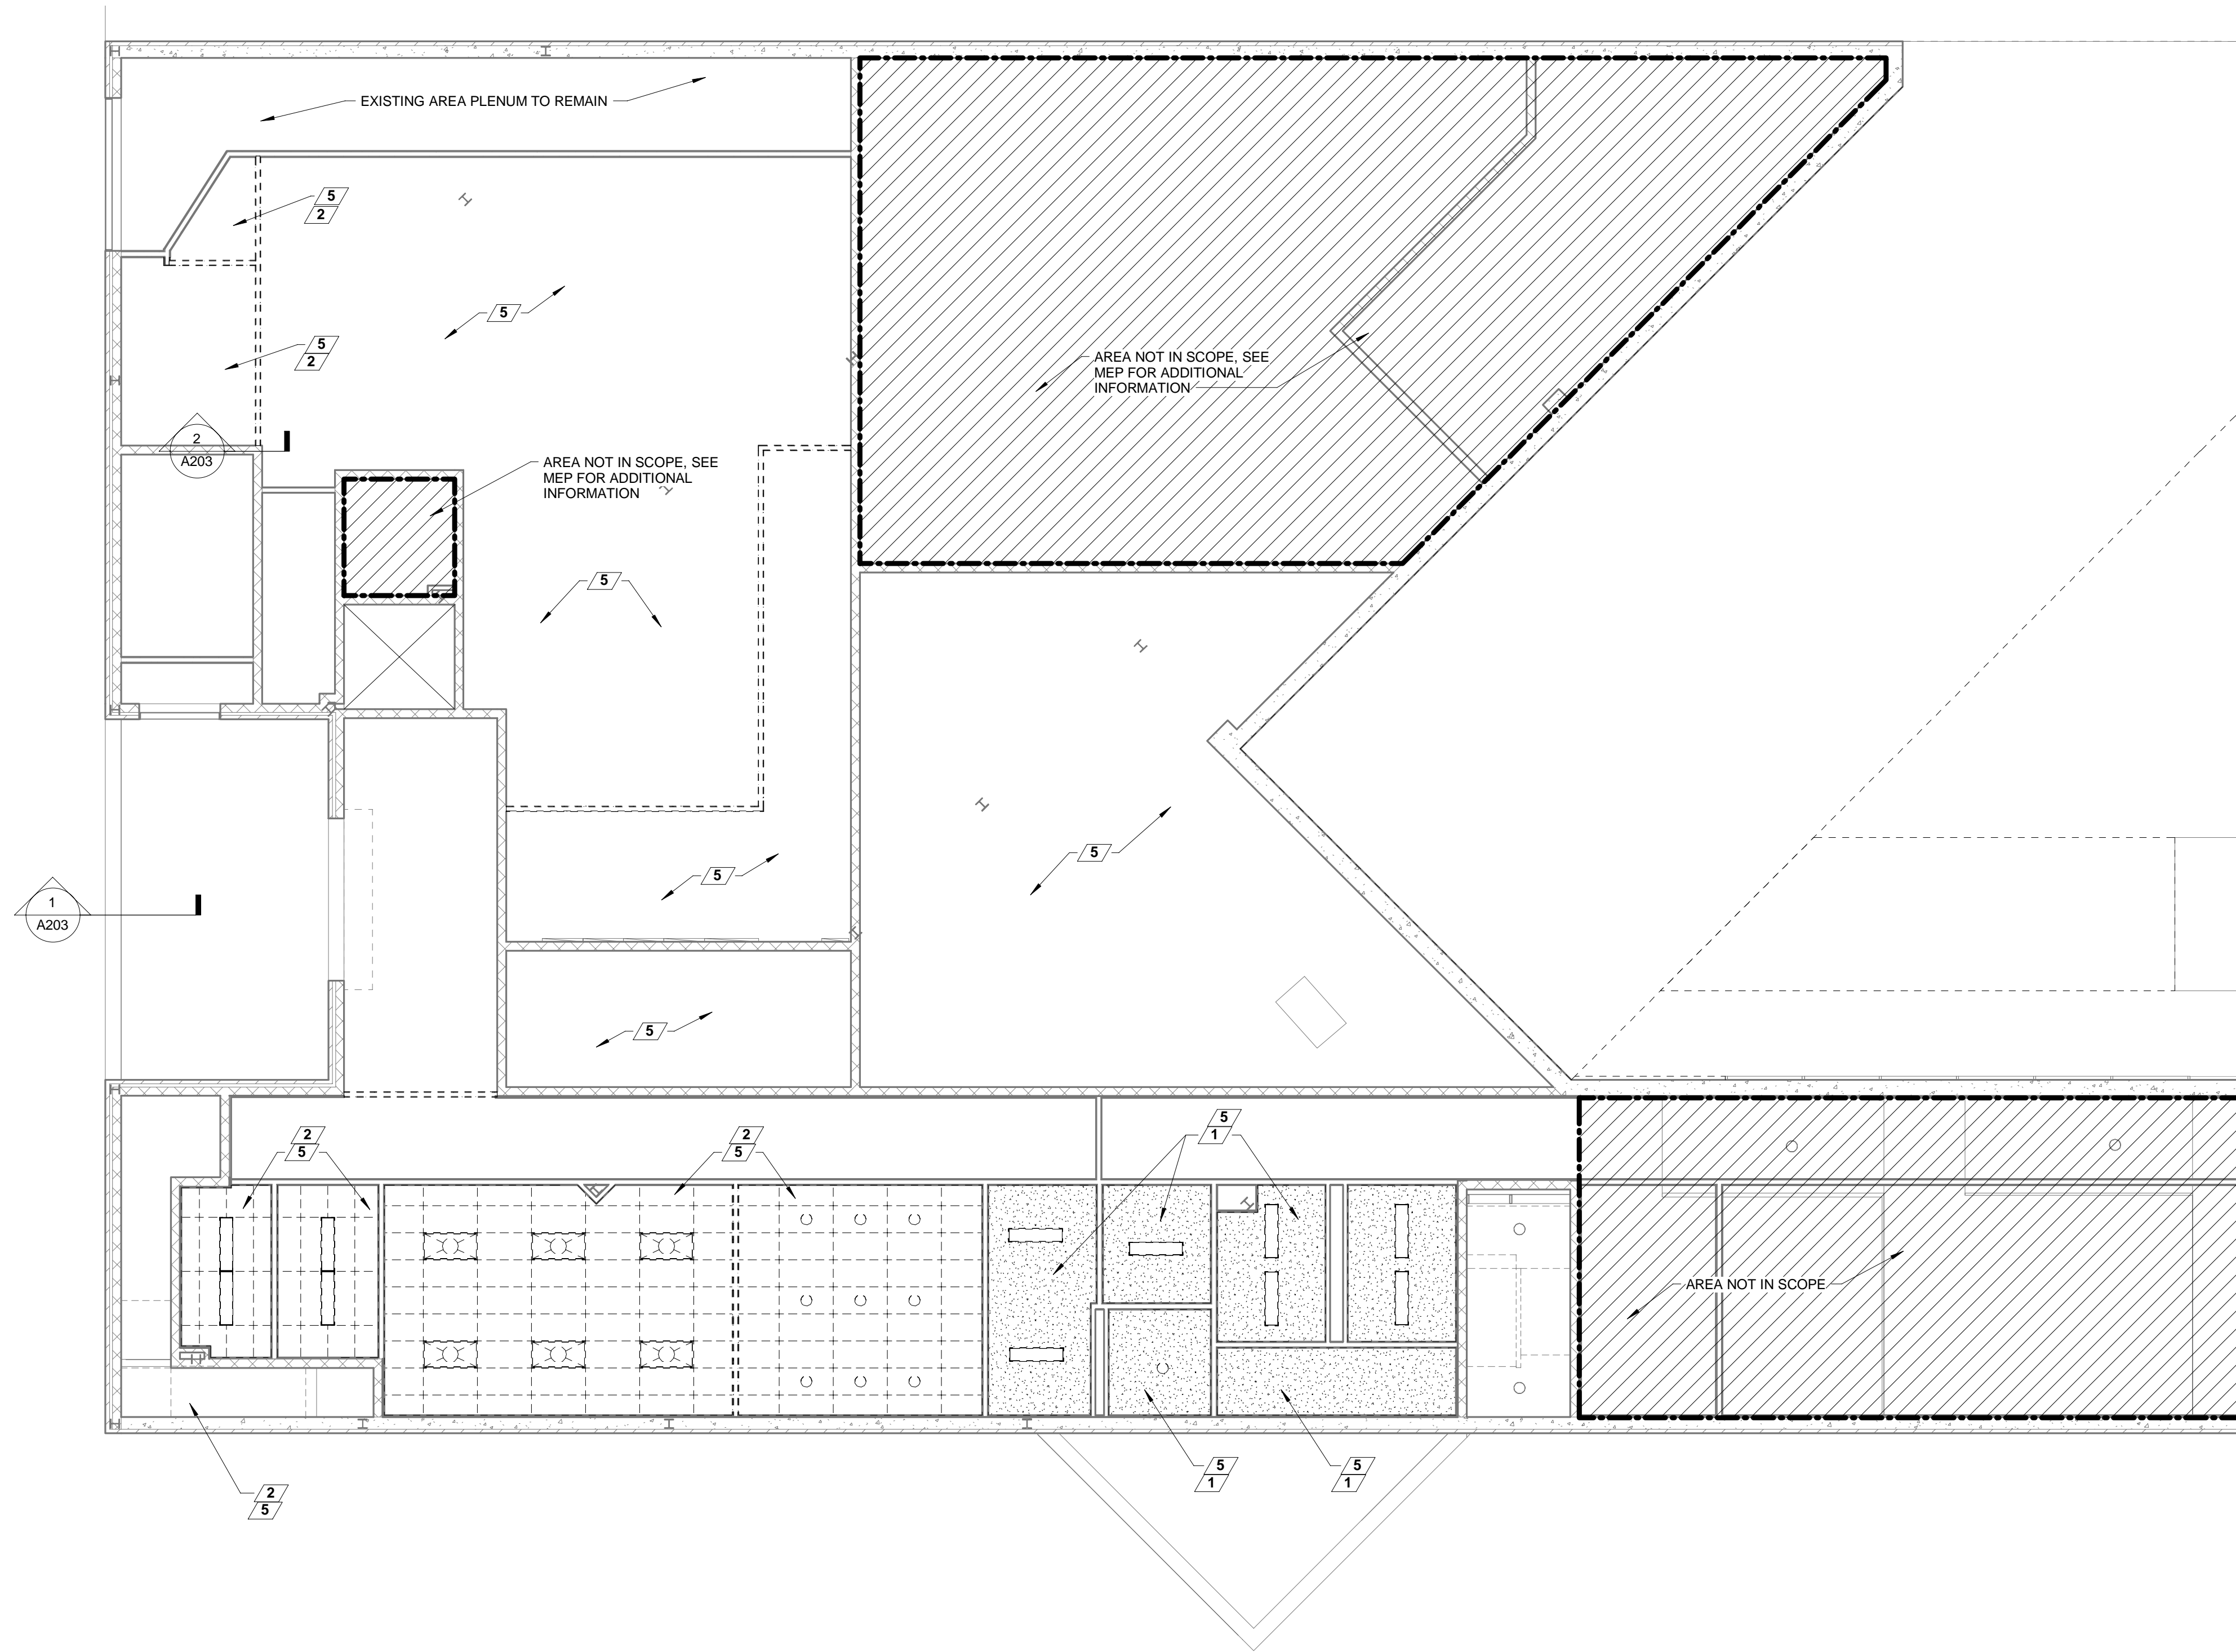DEMOLITION GENERAL NOTES	
1.	GC IS TO REFER TO EQUIPMENT DRAWINGS FOR ADDITIONAL DEMOLITION NOTES.
2.	REFER TO MEP AND STRUCTURAL DRAWINGS FOR ADDITIONAL DEMOLITION NOTES.

1 BASEMENT LEVEL - DEMO CEILING PLAN  
1/8" = 1'-0"

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CONSULTANT:

PROJECT:  
**SUNY PURCHASE COLLEGE**  
CAFE ADDITION AND RENOVATION  
735 ANDERSON HILL RD  
PURCHASE, NY 10577

REVISIONS  
NO. DATE DESCRIPTION

SEAL:

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ISSUED DATE: 02.16.2018  
DRAWN BY: JW  
CHECKED BY: CM  
PROJECT NUMBER: 1517347  
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DRAWING NAME:  
**BASEMENT CELING  
DEMOLITION PLAN**  
DRAWING NO:  
**AD200**





① DINING LEV  
1/8" = 1'-0"

1	REMOVE EXISTING GYPSUM CEILING/SOFFIT IN IT'S ENTIRETY.
2	REMOVE EXISTING ACT TILE CEILING IN IT'S ENTIRETY.
3	REMOVE EXISTING SPLINE CEILING IN IT'S ENTIRETY.
4	GC IS TO REMOVE PORTION OF EXISTING TILE CEILING.
5	REMOVE ALL EXISTING LIGHT FIXTURES IN THIS AREA UNLESS OTHERWISE NOTED.

### DEMOLITION GENERAL NOTES

1. GC IS TO REFER TO EQUIPMENT DRAWINGS FOR ADDITIONAL DEMOLITION NOTES.  
2. REFER TO MEP AND STRUCTURAL DRAWINGS FOR ADDITIONAL DEMOLITION NOTES

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## CAFE ADDITION AND RENOVATION

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PURCHASE NY 10577

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ISSUED DATE: 02.16.2018

DRAWN BY: JW

CHECKED BY: CM

PROJECT NUMBER: 1517347

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DRAWING NAME:

# FIRST FLOOR CEILING DEMOLITION PLAN


DRAWING NO.

# AD201







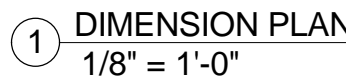

1 IN FILL EXISTING MASONRY WALL WITH NEW MASONRY WALL CONSTRUCTION TO MATCH EXISTING  
2 OPENING  
3 NEW COOLERS FREEZER, SEE EQUIPMENT DRAWINGS FOR ADDITIONAL INFORMATION.  
4 NEW WALL CONSTRUCTION IS TO ALIGN WITH EXISTING.  
5 NEW MILLWORK BY OTHERS.  
6 CORNER GUARDS, SEE FINISH SCHEDULE FOR ADDITIONAL INFORMATION.  
7 NEW STRUCTURAL COLUMN, SEE STRUCTURAL DRAWINGS FOR ADDITIONAL INFORMATION.  
8 DASHED LINE REPRESENTS SOFFIT ABOVE, SEE A201 FOR ADDITIONAL INFORMATION.  
9 AREA NOT IN SCOPE.  
10 PROVIDE 1/2" FIRE RETARDANT PLYWOOD SHEATHING, 4'-0" A.F.F. SCREW TO FINISH FACE OF WALL  
11 CONSTRUCTION.  
12 INFILL FLOOR OPENING WITH NEW CONSTRUCTION TO MATCH EXISTING, SEE STRUCTURAL  
13 DRAWINGS FOR ADDITIONAL INFORMATION.  
14 EXISTING COLUMN TO REMAIN.  
15 GC TO SAW CUT FLOOR AS NEEDED TO ALLOW FOR NEW DUCT WORK, SEE MEP AND STRUCTURAL  
16 DRAWINGS FOR ADDITIONAL INFORMATION.  
17 NEW ROOF DRAIN, SEE ROOF PLAN AND MEP DRAWINGS FOR ADDITIONAL INFORMATION.

1. PROVIDE MOISTURE RESISTANT GYPSED BOARD AT ALL NEW WET WALLS LOCATIONS, UNLESS OTHERWISE NOTED.
2. ALL NEW WALLS THAT ARE TO RECEIVE FRP OR CERAMIC TILE SHALL HAVE GYPSED BOARD IN ALL AREAS. SEE FINISH LEGEND FOR DRAWINGS FOR LOCATIONS. SEE FINISH LEGEND & INTERIOR ELEVATIONS FOR WALL FINISHES.
3. REFERENCE CEILING PLAN, INTERIOR ELEVATIONS AND EQUIPMENT DRAWINGS FOR ADDITIONAL INFORMATION.
4. GC TO PATCH AND REPAIR MASONRY WALLS AS NEEDED WHERE DEMOLITION HAS OCCURRED.
5. SEE V100 AND V110 FOR INTERIOR GENERAL ARRANGEMENT PLANS.
6. SEE EQUIPMENT DRAWING FOR ADDITIONAL COOLER OR KITCHEN EQUIPMENT INFORMATION.
7. SEE V100 AND V110 FOR INTERIOR FINISH TAGS.

**SUNY PURCHASE COLLEGE**

CAFE ADDITION AND RENOVATION

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SEARCH


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PROJECT NUMBER: 1517347
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FIRST FLOOR  
CONSTRUCTION  
PLAN

DRAWING NO.

# A101





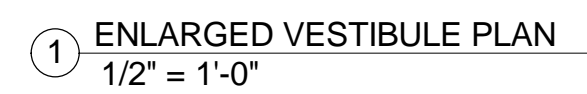

GENERAL NOTES:

1. ALL ROOF CRICKETS SHALL BE CONSTRUCTED WITH 1/2" TAPERED INSULATION.
2. PROVIDE TAPERED INSULATION CRICKETS AT UPSLOPE SIDE OF ALL ROOF CURBS PER ROOFING MFG'S RECOMMENDATIONS.
3. FLASH ALL ROOF CURBS, PENETRATIONS, ETC. PER ROOFING MANUFACTURER RECOMMENDATIONS - REFER TO COORDINATE WITH MECHANICAL AND PLUMBING PLANS AND FLASH ALL PENETRATIONS AS REQUIRED.
4. SEE MECHANICAL DRAWINGS AND EQUIPMENT DRAWINGS FOR ADDITIONAL INFORMATION.
5. GC TO COORDINATE NEW ROOF PENETRATIONS, EQUIPMENT, ETC., WITH COLLEGE EXISTING ROOF TO BE REPLACED DURING CONSTRUCTION BY SEPARATE CONTRACTOR.

**SUNY PURCHASE COLLEGE**

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CAFE ADDITION AND RENOVATION

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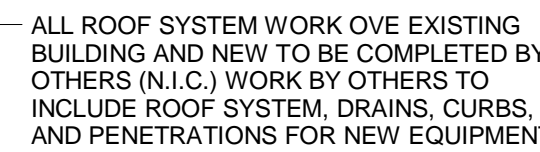
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ROOF PLAN


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DRAWING NO.

A103




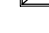





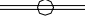


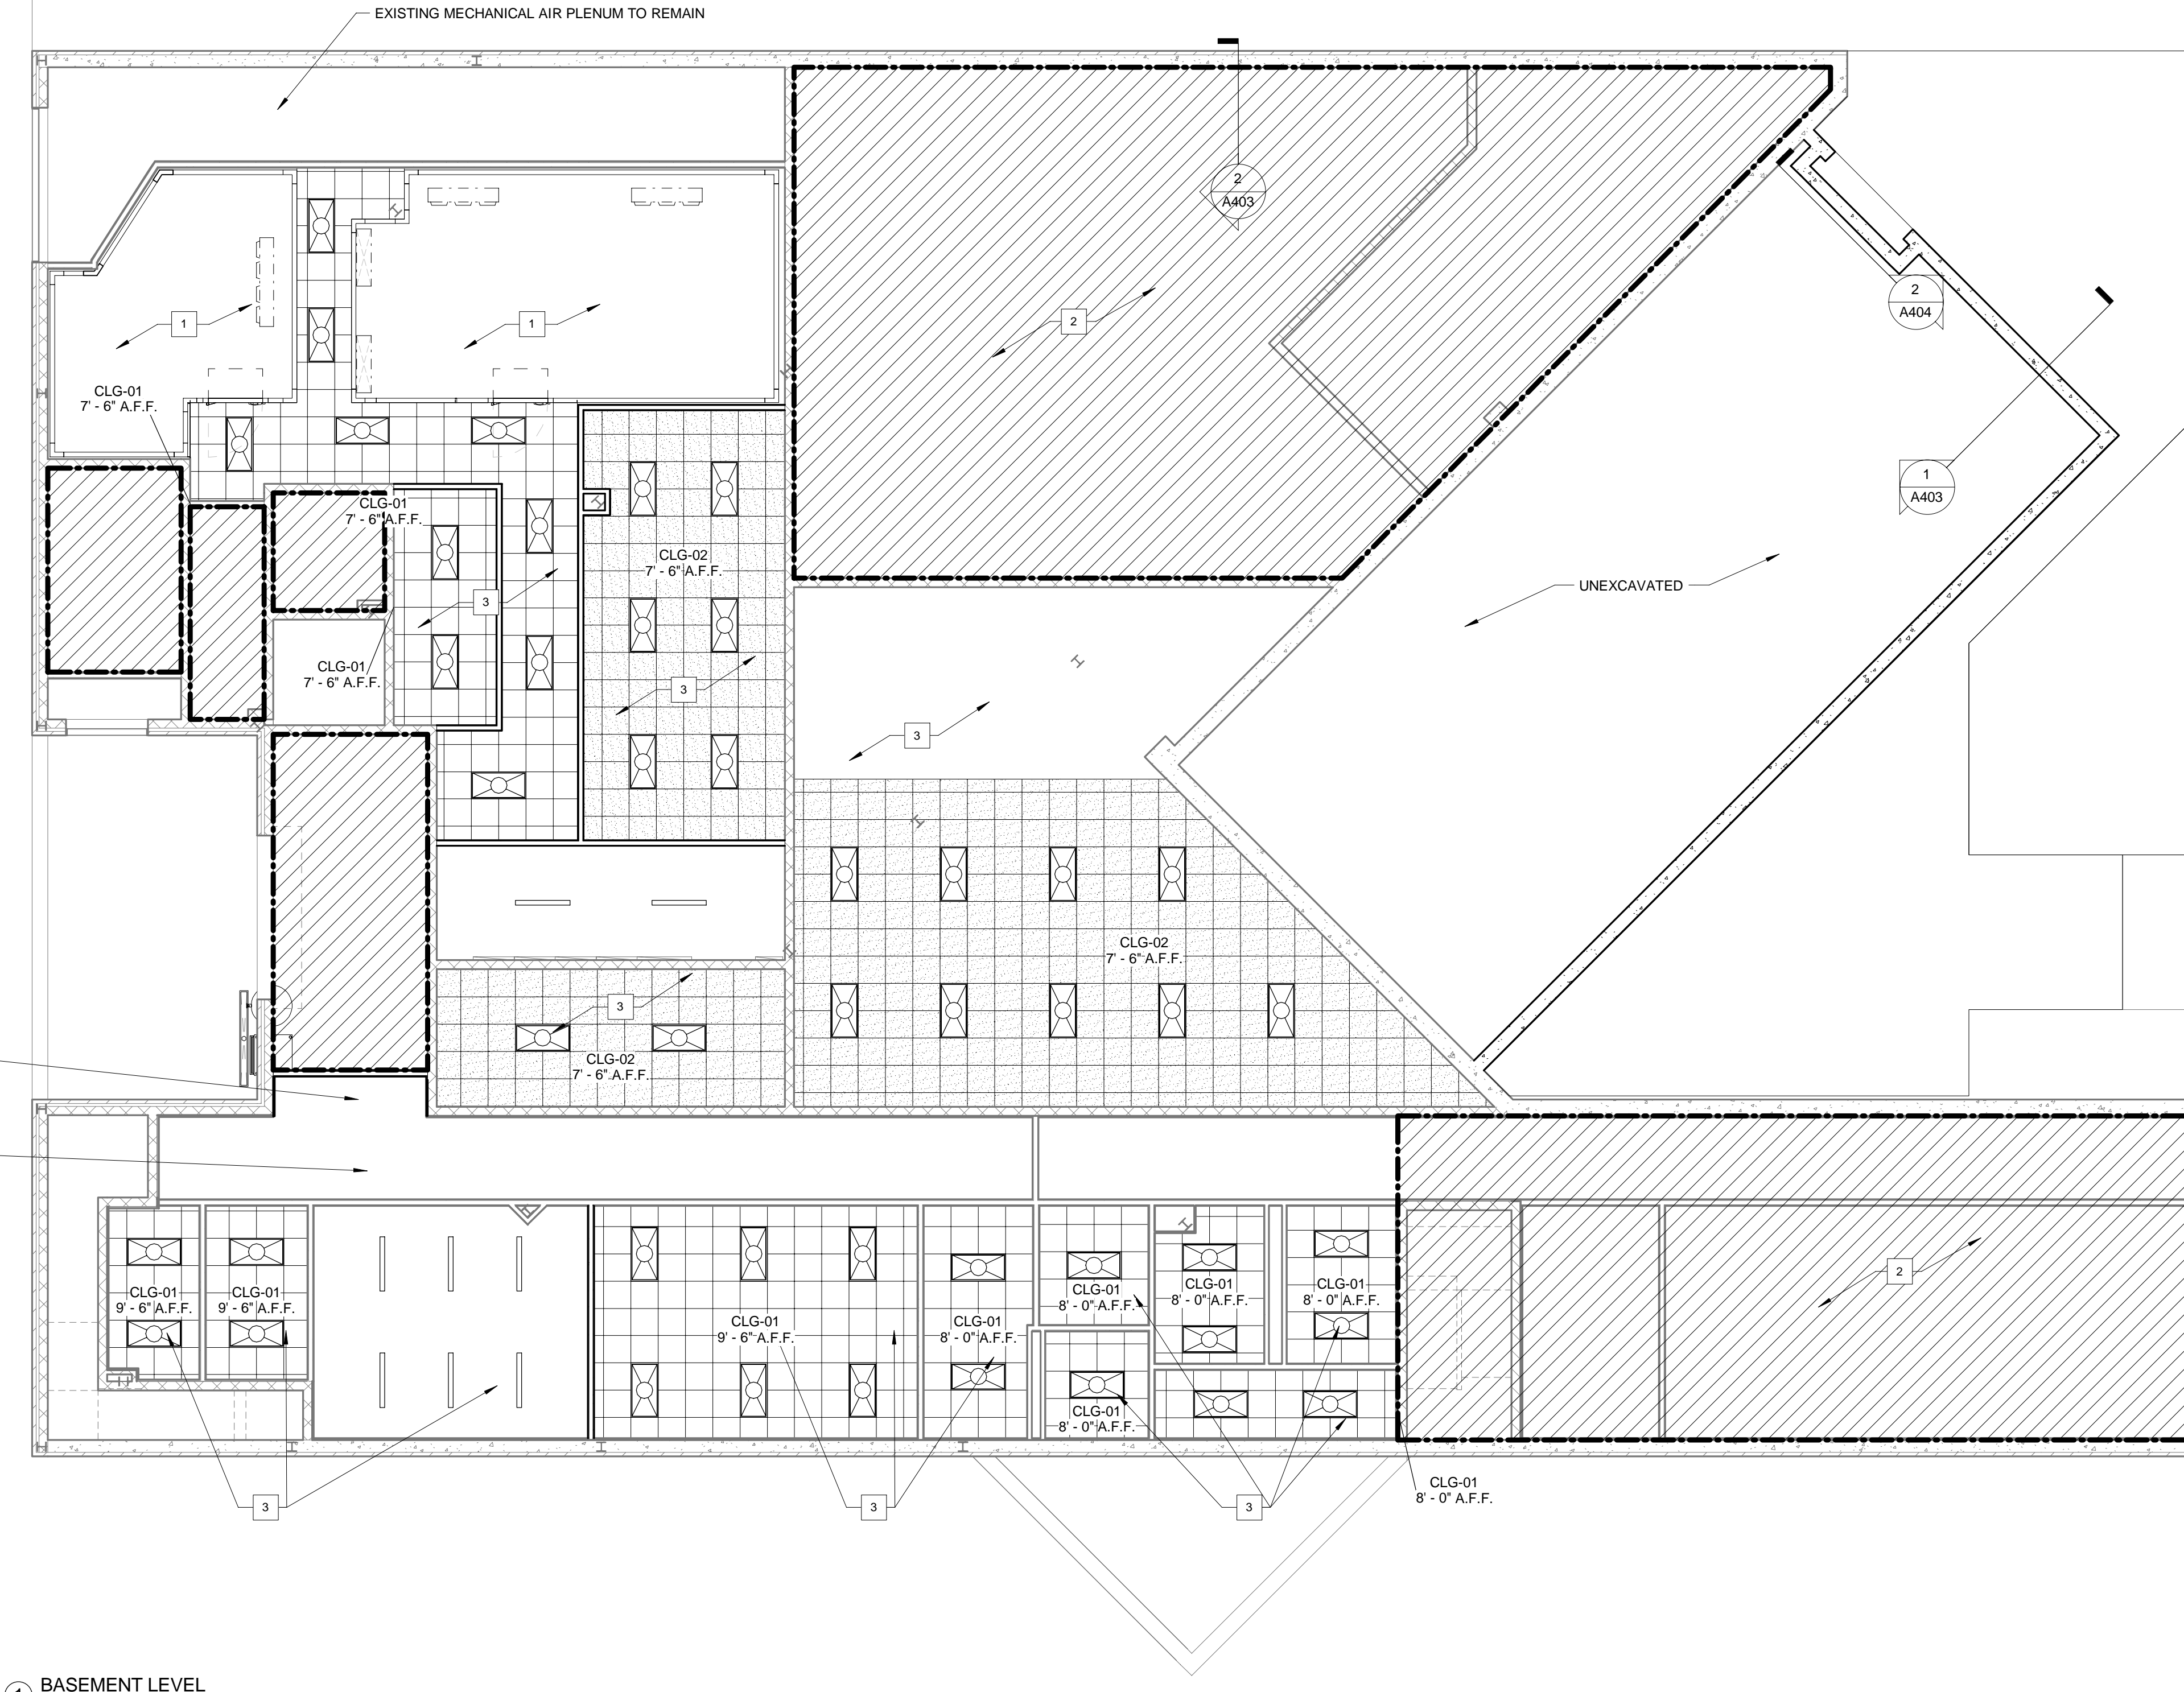


1. ALL CEILING MOUNTED WIRING WITHIN THE EXPOSED CEILING AREAS OF THE HUB SHALL BE RUN WITHIN A RACEWAY, AND THE RACEWAY AND ALL ASSOCIATED ATTACHMENTS, ETC., WILL BE PAINTED BLACK TO MATCH THE CEILING FINISHES.
2. ALL CEILING GRIDS TO BE CENTERED IN ROOM, UNLESS NOTED OTHERWISE.
3. SEE EQUIPMENT DRAWINGS AND ELECTRICAL DRAWINGS FOR ADDITIONAL LIGHTING INFORMATION.
4. SEE ELECTRICAL DRAWINGS FOR ADDITIONAL SYMBOLS.
5. REFER TO V102 AND V112 FOR ALL CEILING HEIGHTS, FINISHES AND LIGHTING LOCATIONS.
6. GC IS TO V.I.F. THE HEIGHTS OF DUCTS IN BASEMENT PRIOR TO CEILING INSTALLATION, ANY CONFLICTS, CONTACT ARCHITECT.
7. SEE MEP DRAWINGS FOR SUPPLY AND RETURN GRILL LOCATIONS

PLAN NOTES - RCP	
1	SEE EQUIPMENT DRAWINGS FOR LIGHT INFORMATION IN COOLERS
2	AREA NOT IN SCOPE.
3	NEW ACT LITE CEILING, SEE V102 AND V112 FOR ADDITIONAL INFORMATION
4	EXP. BD. SOFFIT CEILING, SEE V102 AND V112 FOR ADDITIONAL INFORMATION
5	DECORATIVE CEILING TRELLIS, SEE 4/A203 FOR ADDITIONAL INFORMATION. SEE V112 FOR FINISH INFORMATION.
6	
7	TVS TO BE PROVIDED BY OTHERS.
8	DECORATIVE TRELLIS, SEE V112 FOR ADDITIONAL INFORMATION.

## SYMBOL LEGEND

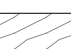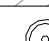	2X4 LED FIXTURE
	2X2 LED FIXTURE
	RECESSED CAN FIXTURE
	DECORATIVE PENDANT LIGHT
	LAMINATE CEILING
	HIGH BAY LIGHT FIXTURE
	DECORATIVE LINEAR LIGHT FIXTURE
	INDUSTRIAL STRIPE LIGHTING
	MONITOR



PHASE ZERO  
DESIGN

8 WILCOX STREET  
SIMSBURY, CONNECTICUT 06070  
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**Purchase College**

STATE UNIVERSITY OF NEW YORK  
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**SUNY PURCHASE COLLEGE**

CAFE ADDITION AND RENOVATION

735 ANDERSON HILL RD  
PURCHASE, NY 10577

[illegible]

ISSUED FOR: BID  
ISSUED DATE: 02.16.2018

PROJECT NUMBER: 1517347


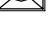







BASEMENT  
REFLECTED  
CEILING PLAN

# A200



1. ALL CEILING MOUNTED WIRING WITHIN THE EXPOSED CEILING AREAS OF THE HUB SHALL BE RUN WITHIN A RACEWAY, AND THE RACEWAY AND ALL ASSOCIATED ATTACHMENTS, ETC. WILL BE PAINTED BLACK TO MATCH THE CEILING FINISHES.
2. ALL CEILING GRIDS TO BE CENTERED IN ROOM, UNLESS NOTED OTHERWISE.
3. SEE EQUIPMENT DRAWINGS AND ELECTRICAL DRAWINGS FOR ADDITIONAL LIGHTING INFORMATION.
4. SEE ELECTRICAL DRAWINGS FOR ADDITIONAL SYMBOLS.
5. REFER TO VIOF AND V112 FOR ALL CEILING HEIGHTS, FINISHES AND LIGHTING LOCATIONS.
6. GO SEE V.12 THE HEIGHTS OF DUCTS IN BASEMENT PRIOR TO CEILING INSTALLATION ANY CONFLICTS, CONTACT ARCHITECT.
7. SEE MEP DRAWINGS FOR SUPPLY AND RETURN GRILL LOCATIONS

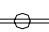1	SEE EQUIPMENT DRAWINGS FOR LIGHT INFORMATION IN COOLERS
2	AREA NOT IN SCOPE.
3	NEW ACT TILE CEILING, SEE V102 AND V112 FOR ADDITIONAL INFORMATION
4	NEW GYP. BD. SOFFIT CEILING, SEE V102 AND V112FOR ADDITIONAL INFORMATION
5	DECORATIVE CEILING TRELLIS, SEE 4/A203 FOR ADDITIONAL INFORMATION. SEE V112 FOR FINISH INFORMATION.
6	
7	TVS TO BE PROVIDED BY OTHERS.
8	DECORATIVE TRELLIS, SEE V112 FOR ADDITIONAL INFORMATION.

	2X4 LED FIXTURE
	2X2 LED FIXTURE
	RECESSED CAN FIXTURE
	DECORATIVE PENDANT LIGHT
	LAMINATE CEILING
	HIGH BAY LIGHT FIXTURE
	DECORATIVE LINEAR LIGHT FIXTURE
	INDUSTRIAL STRIPE LIGHTING
	MONITOR



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**Purchase College**

CONSULTANT:

## CAFE ADDITION AND RENOVATION

35 ANDERSON HILL RD  
PURCHASE, NY 10577

PROJECT:

[illegible]

SEAR

ISSUED FOR: BID

ISSUED DATE: 02.16.2018

DRAWN BY: JM

CHECKED BY: CM






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FIRST FLOOR  
REFLECTED  
CEILING PLAN

DRAWING NO.

# A201





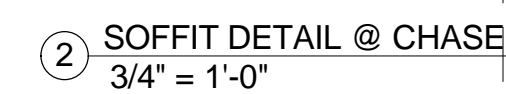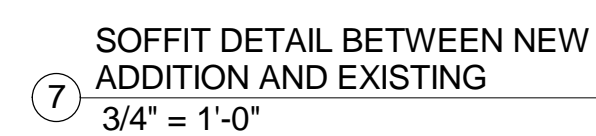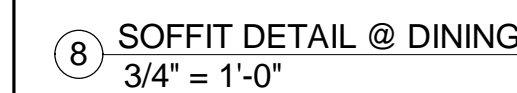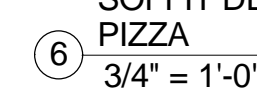
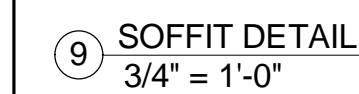







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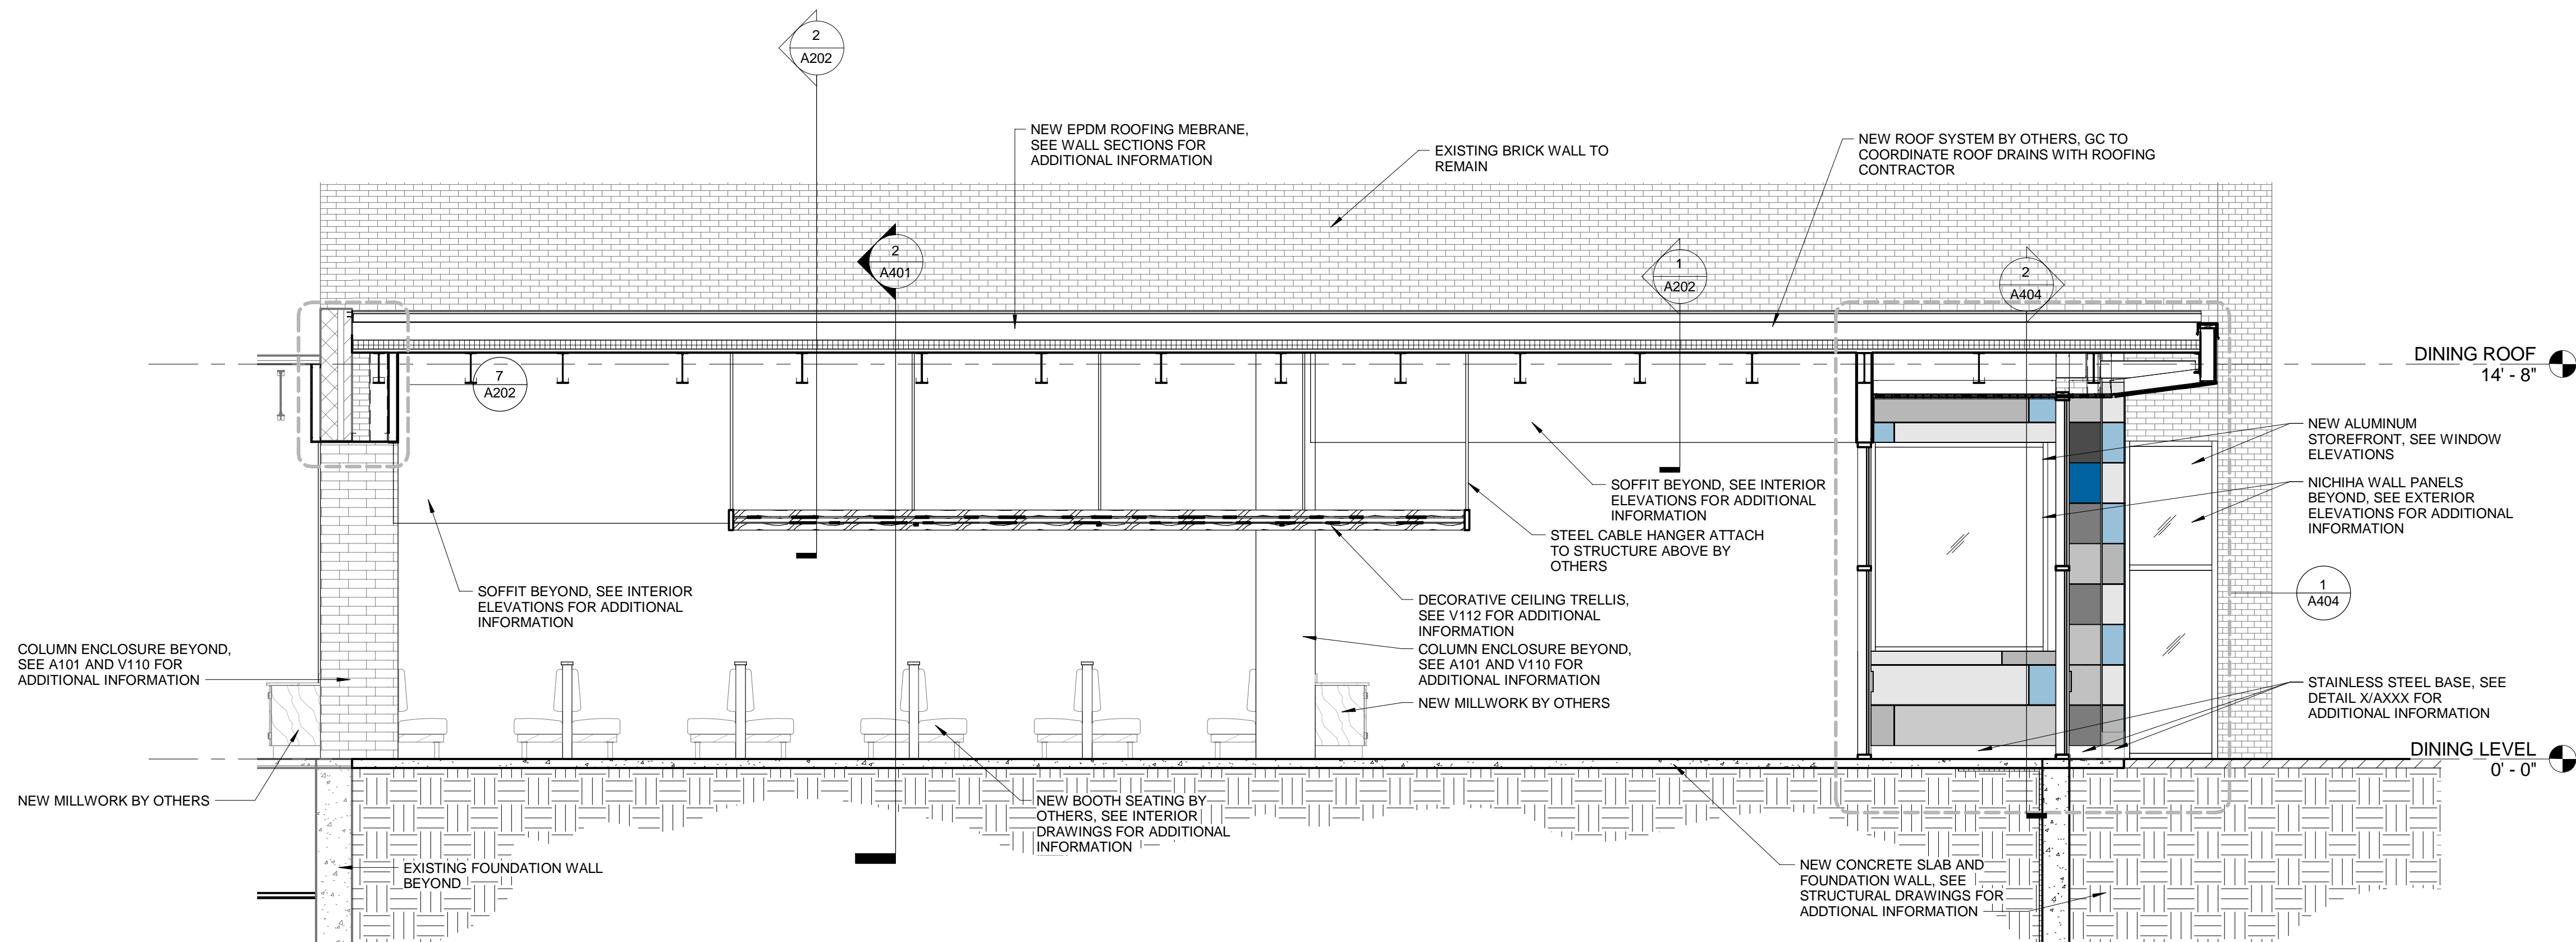


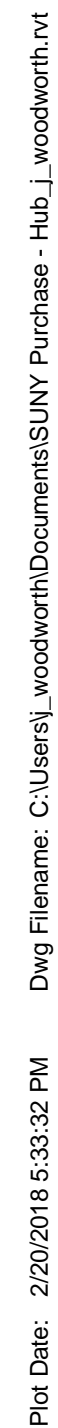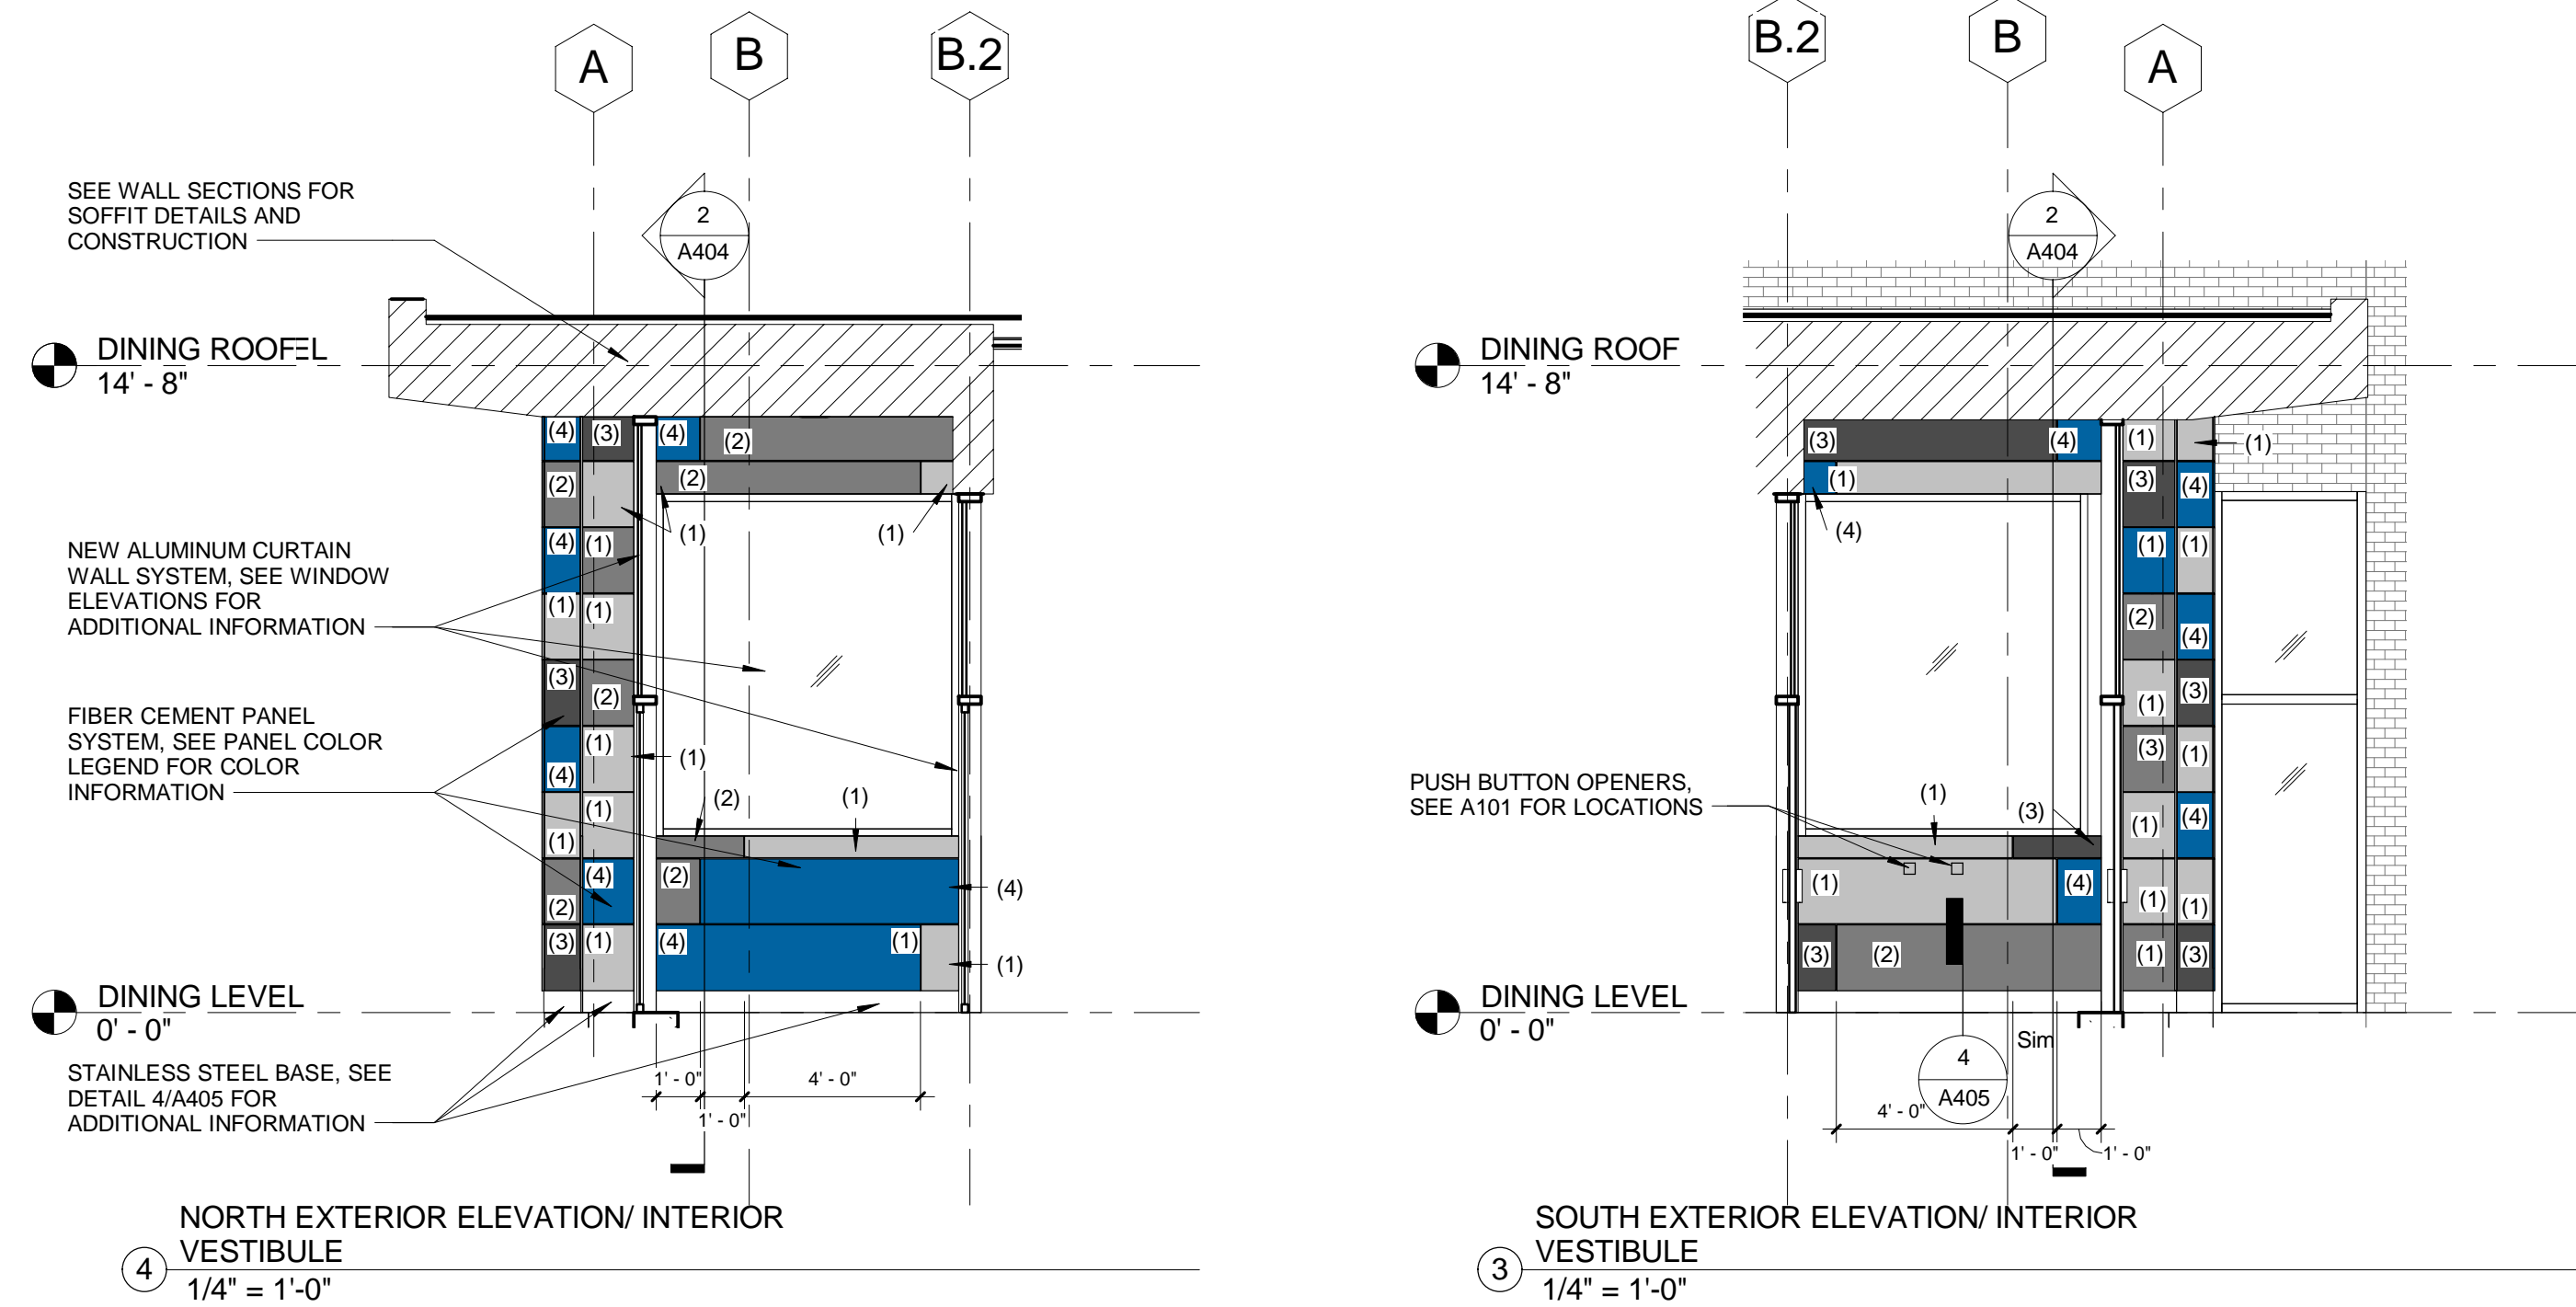

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2 BUILDING SECTION  
1/4" = 1'-0"



1 BUILDING SECTION  
1/4" = 1'-0"

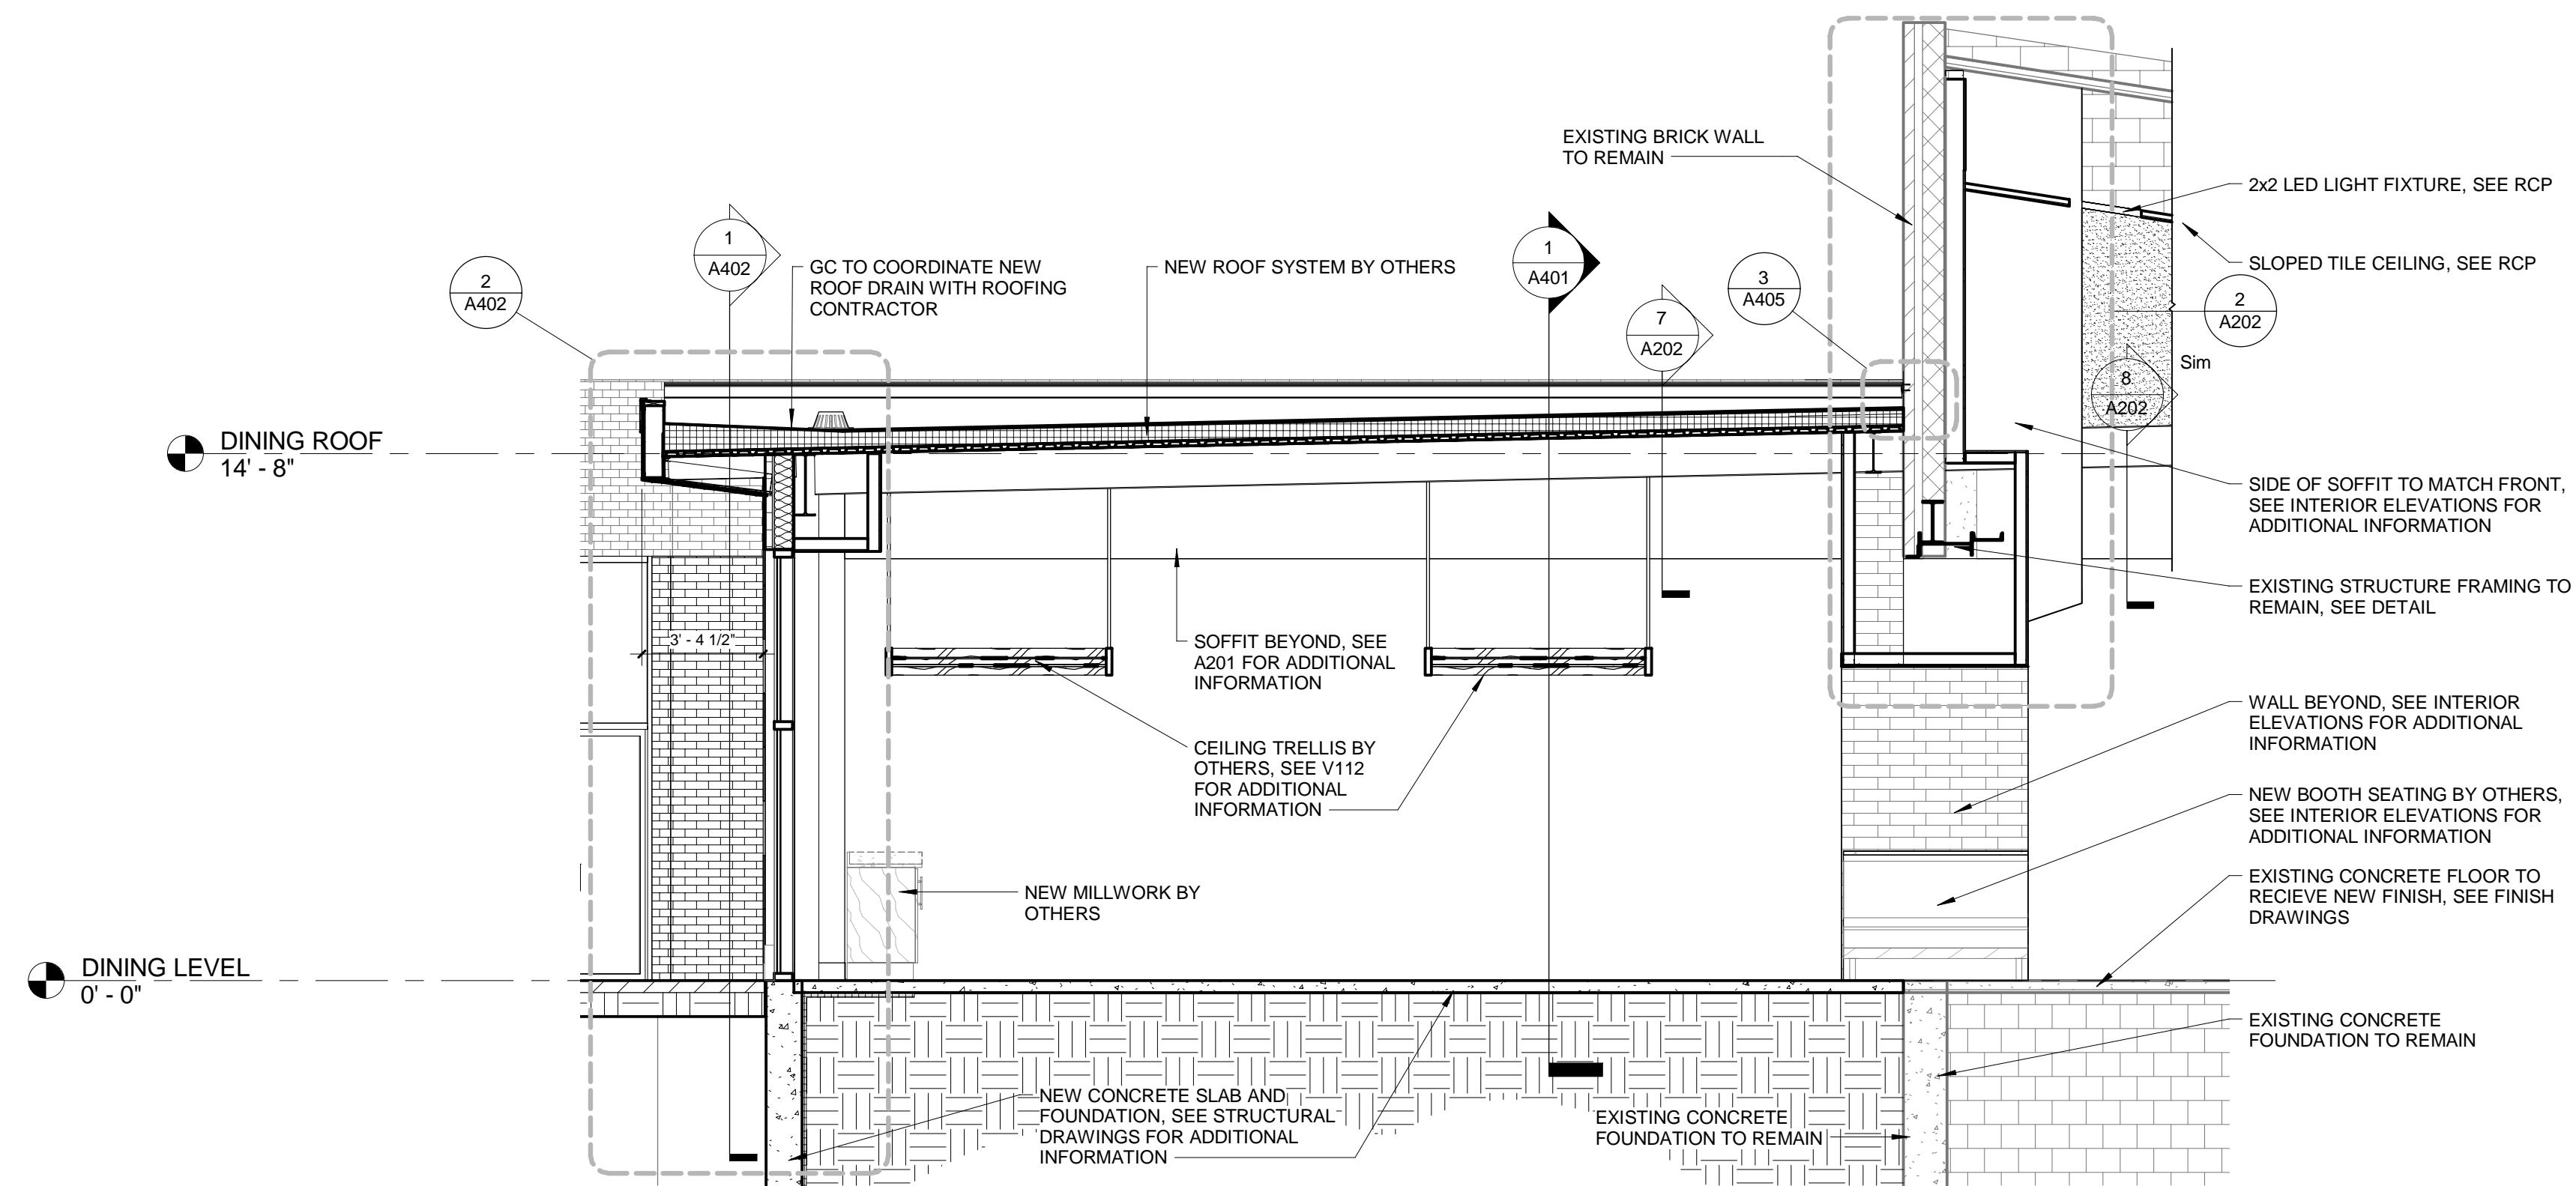ARCHITECT:  
**PHASE ZERO DESIGN**  
8 WILCOX STREET  
SIMSBURY, CONNECTICUT 06070  
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CONSULTANT:

**SUNY PURCHASE COLLEGE**  
**CAFE ADDITION AND RENOVATION**  
735 ANDERSON HILL RD  
PURCHASE, NY 10577

REVISIONS	
NO.	DESCRIPTION

SEAL:

ISSUED FOR: BID
ISSUED DATE: 02.16.2018
DRAWN BY: JW
CHECKED BY: CM
PROJECT NUMBER: 1517347
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DRAWING NAME:

**BUILDING SECTIONS**



DRAWING NO.  
**A401**



[illegible]

TABLE 1

A402

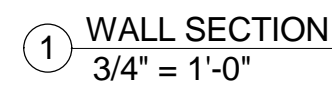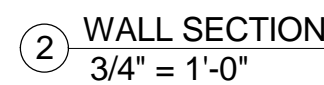



**SUNY PURCHASE COLLEGE**

CAFE ADDITION AND RENOVATION

735 ANDERSON HILL RD  
PURCHASE NY 10577

[illegible]

OE 41

ISSUED FOR: BID

ISSUED DATE: 02.16.2018

DRAWN BY: JW


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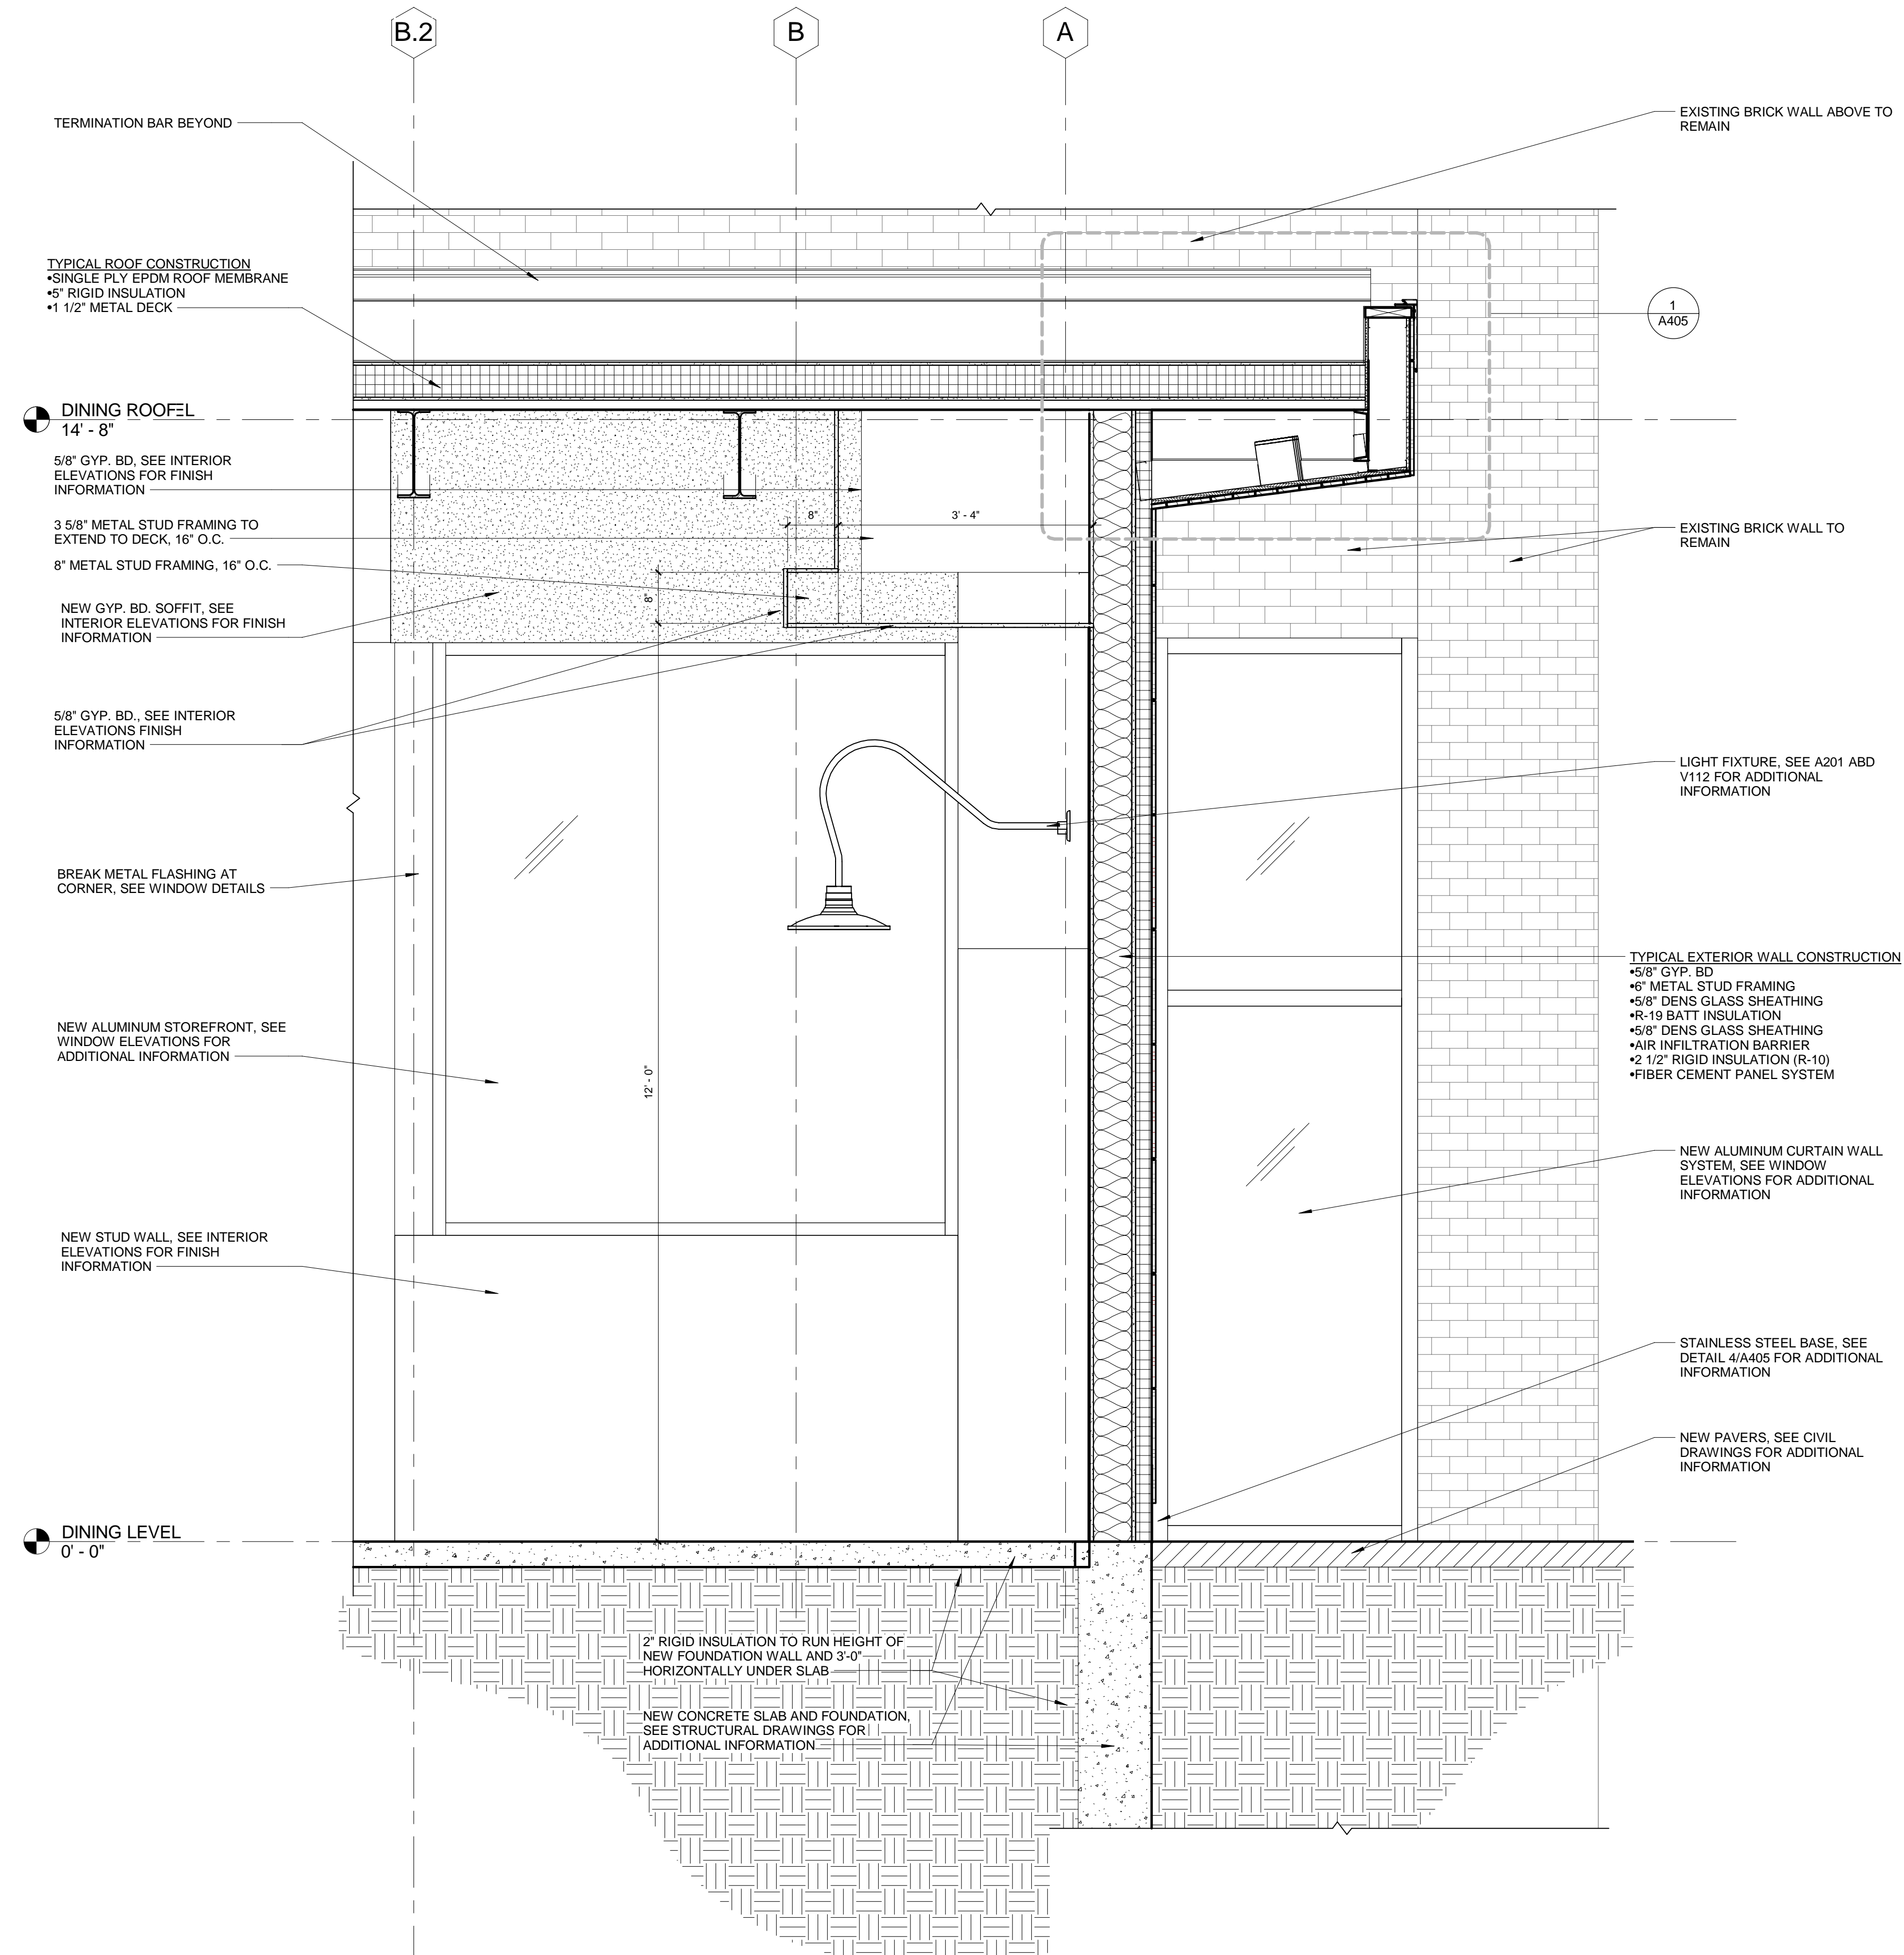
DRAWING NAME:

WALL SECTIONS

DRAWING NO.



② Section 4  
3/4" = 1'-0"

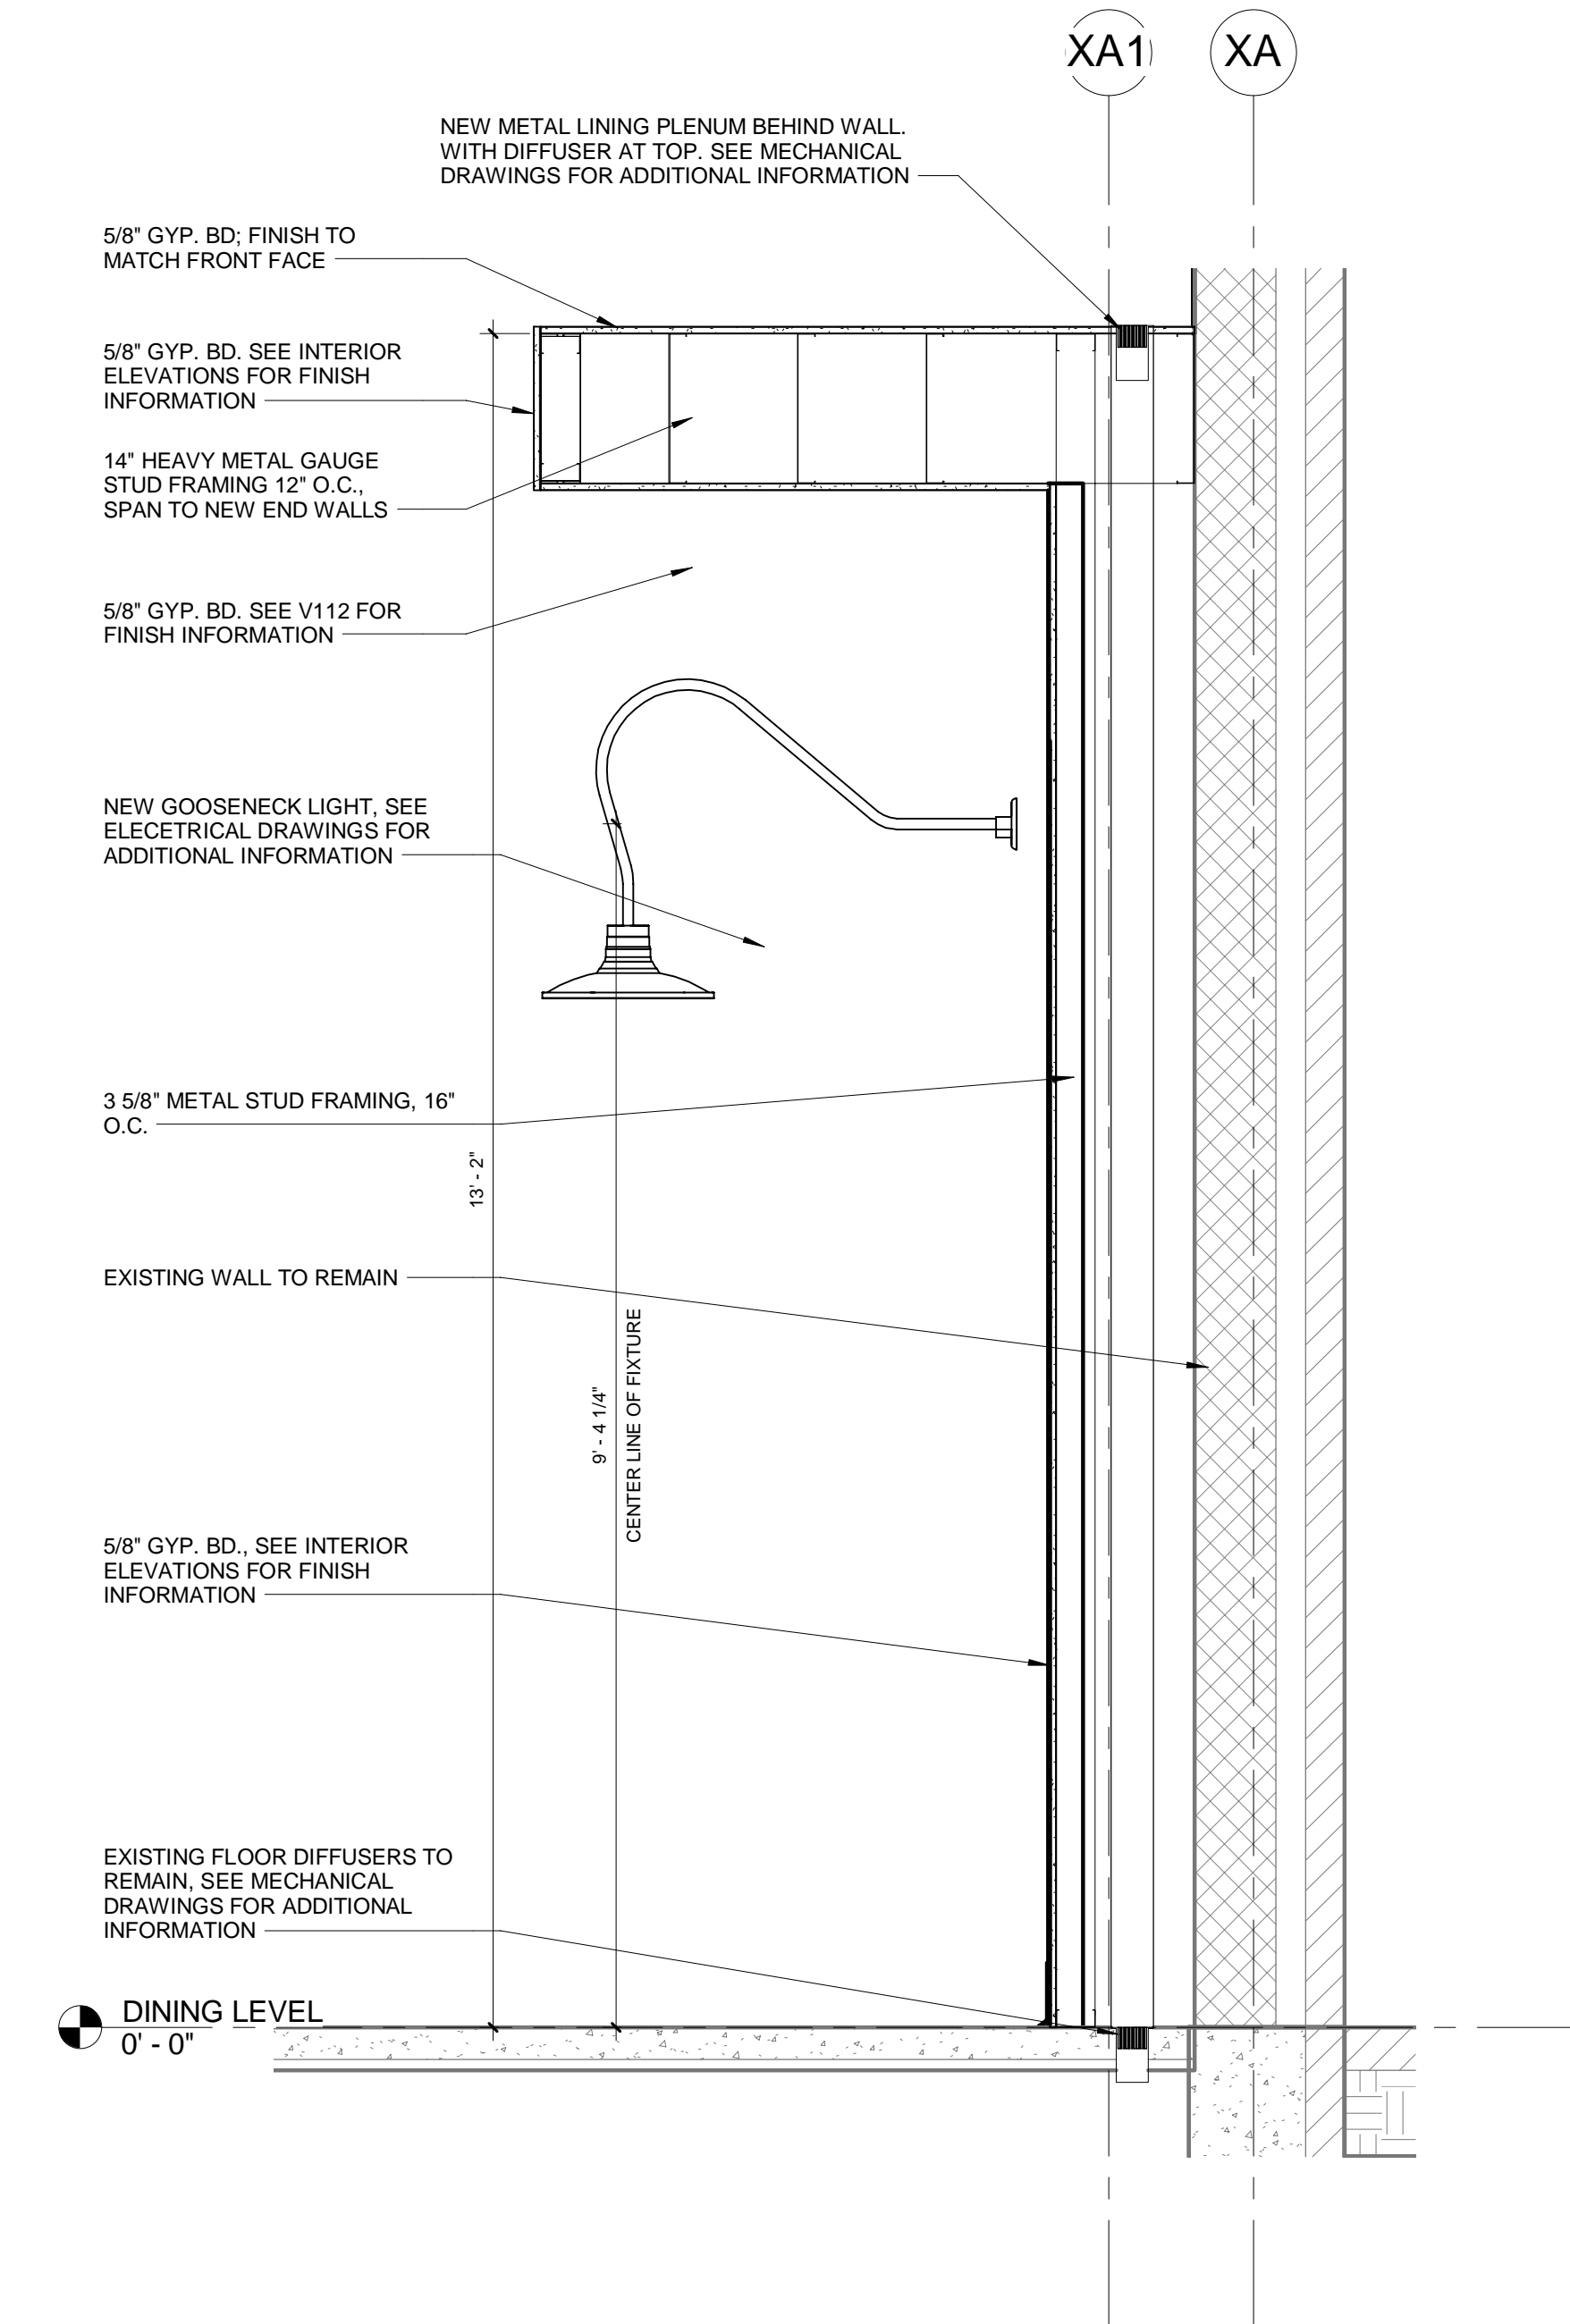


① Wall Section 4  
3/4" = 1'-0"



## AL:

DRAWING NAME:

DRAWING NO.

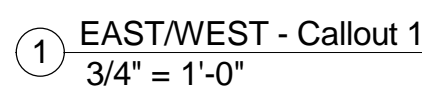



\_\_\_\_\_

[illegible]

10. *Journal of the American Medical Association*, 2000; 284: 1039-1044.

10. *Journal of the American Medical Association*, 2000; 284: 1039-1044.

10. *Journal of the American Medical Association*, 2000; 284: 1039-1044.

ISSUED FOR: BID

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CHECKED BY: CM

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10. *Journal of the American Medical Association*, 2000; 284: 1039-1044.

## SECTION DETAILS

10. *Journal of the American Medical Association*, 2000; 283: 2689-2693.

DRAWING NO.

A405

10. *Journal of the American Medical Association*, 2000; 284: 1039-1044.

② TERMINATION BAR

SECTION DETAIL

WALL SCUPPER

EXTERIOR WALL BASE



DOOR SCHEDULE																																														
ROOM NAME	DOOR NO.	DOOR			FRAME			FRAME DETAILS			FIRE RATING	FIRE CODE REQ.		ADA REQ.	LOCKSET			MISC. HARDWARE										REMARKS																		
		SIZE	TYPE	MATL	GLASS	TYPE	MATL	GLASS	HEAD	JAMB		THRESHOLD	AUTOMATIC CLOSER		PANIC RELEASE OPERATOR	POSITIVE LATCHING	ADA LEVER HANDLES	ADA PUSH BUTTON OP.	ADA TACTILE WARN.	PASSAGE	ENTRY	CLASSROOM	OFFICE	STORE ROOM	BUTTS (PAIRS)	ELECTRIC STRIKE	MAGNETIC HOLD OPEN		KICK PLATES	PULL HANDLES	PUSH PLATES	SILENCERS	STRIKE	VERTICAL RODS	WALL STOP	WEATHER STRIP	LATCH SECURITY PLATE	TOP & BOTTOM BOLTS	CARD ACCESS CONTROL							
BASEMENT LEVEL																																														
SOUTH WEST STAIR	001A	3'-0" x 7'-0" x 1 3/4"	EX	--	--	EX	--	--	EX	EX	EX	2	EX	EX	EX	EX	--	--	--	--	--	--	EX	EX	--	--	--	--	EX	EX	--	--	--	EX	--	--	--	--								
SOUTH WEST STAIR	001B	3'-0" x 7'-0" x 1 3/4"	EX	--	--	EX	--	--	EX	EX	EX	--	EX	EX	EX	EX	--	--	--	--	--	--	EX	EX	--	--	--	--	EX	EX	--	--	--	EX	--	--	--	--								
CORRIDOR	002A	3'-0" x 7'-0" x 1 3/4" PR	1	HM	--	A	HM	--	H1/A501	J1/A501	--	--	X	X	X	X	--	--	--	--	--	X	3	X	EX	--	--	--	2	--	--	X	X	--	--	--	--	--								
CORRIDOR	002B	3'-0" x 7'-0" x 1 3/4"	EX	--	--	EX	--	--	EX	EX	--	2	EX	--	EX	EX	--	--	--	--	--	--	EX	X	EX	EX	--	--	EX	--	--	--	--	--	--	--	--	--								
RECEIVING	003A	12'-0" x 8'-0" UNIT	EX	--	--	EX	--	--	--	--	--	--	--	--	--	--	--	--	--	--	--	--	--	--	--	--	--	--	--	--	--	--	--	--	--	--	--									
RECEIVING	003B	3'-0" x 7'-0" x 1 3/4" PR	1	HM	--	A	HM	--	H2/A501	J2/A501	--	--	X	X	X	X	--	--	--	--	--	X	--	--	--	--	--	--	--	--	--	--	--	--	--	--	--									
PAPER STORAGE	004	3'-0" x 7'-0" x 1 3/4"	1	HM	--	A	HM	--	H2/A501	J2/A501	--	--	X	X	X	X	--	--	--	--	--	X	1.5	--	--	X	--	--	2	--	--	X	--	--	X	--	--	--								
ELECTRICAL ROOM	005	3'-0" x 7'-0" x 1 3/4"	1	HM	--	A	HM	--	H2/A501	J2/A501	--	--	X	--	X	X	--	--	--	--	--	X	1.5	X	--	X	--	--	3	--	--	X	--	--	--	--	X									
HALLWAY	006	3'-0" x 7'-0" x 1 3/4"	EX	--	--	EX	--	--	EX	EX	--	--	--	--	EX	EX	--	--	X	--	--	--	EX	--	--	--	--	EX	EX	--	--	--	--	--	--	--	--									
DRY STORAGE	007	3'-0" x 7'-0" x 1 3/4" PR	1	HM	--	A	HM	--	H1/A501	J1/A501	--	--	--	--	X	X	--	--	--	--	--	X	--	--	3	--	--	--	2	X	--	--	--	--	X	--	--									
OFFICE	008	3'-0" x 7'-0" x 1 3/4"	3	HM	T	A	HM	--	H1/A501	J1/A501	--	--	--	--	X	X	--	--	--	--	--	--	1.5	--	--	--	--	--	3	X	--	--	--	--	--	--	--									
STORAGE	009A	3'-0" x 7'-0" x 1 3/4"	1	HM	--	A	HM	--	H2/A501	J1/A501	--	--	X	--	X	X	--	--	--	--	--	X	1.5	X	--	--	--	--	3	--	--	--	--	--	--	--	X									
STORAGE	009B	3'-0" x 7'-0" x 1 3/4"	EX	--	--	EX	--	--	EX	EX	--	--	EX	--	EX	EX	--	--	--	--	--	X	EX	X	--	--	--	EX	--	--	--	--	--	--	--	--	X									
ELEVATOR MACHINE ROOM	011	3'-0" x 7'-0" x 1 3/4"	EX	--	--	EX	--	--	EX	EX	--	2	EX	--	EX	EX	--	--	--	--	--	X	EX	X	--	--	--	EX	--	--	--	--	--	--	--	--	X									
MISC STORAGE	012	3'-0" x 7'-0" x 1 3/4"	EX	--	--	EX	--	--	EX	EX	--	--	--	--	--	--	--	--	--	--	--	X	EX	X	--	--	--	EX	--	--	--	--	--	--	--	--	X									
HALLWAY	013	3'-0" x 7'-0" x 1 3/4"	EX	--	--	EX	--	--	EX	EX	EX	--	EX	--	EX	EX	--	--	--	--	--	X	EX	X	--	--	--	EX	--	--	EX	EX	--	--	--	--	X									
SPRINKLER ROOM	014	3'-0" x 7'-0" x 1 3/4"	1	HM	--	A	HM	--	H1/A501	J1/A501	--	2	X	--	X	X	--	--	--	--	--	--	--	--	--	--	--	--	3	X	--	--	--	--	--	--	--									
DINING LEVEL																																														
VESTIBULE	100A	3'-0" x 7'-0" x 1 3/4" PR	4	AL	TI	F	AL	TI	H3/A503	J3/A503	S1/A501	--	X	X	X	X	X	--	--	--	--	--	--	COMT. CONT.	X	--	--	--	2	--	X	--	--	X	--	--	X									
VESTIBULE	100B	3'-0" x 7'-0" x 1 3/4" PR	4	AL	TI	F	AL	TI	H3/A503	J3/A503	--	--	X	--	--	--	--	--	--	--	--	--	--	--	--	--	X	X	X	--	--	--	--	--	--	--	X									
CORRIDOR	101	3'-0" x 7'-0" x 1 3/4" PR	2	HM	S	A	HM	--	H1/A501	J1/A501	--	2	X	X	X	X	--	--	--	--	--	--	X	3	X	X	X	--	2	--	X	X	--	--	--	--	X									
SOUTH WEST STAIR	105A	3'-0" x 7'-0" x 1 3/4"	2	HM	S	A	HM	--	H1/A501	J1/A501	--	--	X	X	X	X	--	--	--	--	--	--	X	1.5	X	--	X	--	3	--	--	X	--	--	--	--	X									
SOUTH WEST STAIR	105B	3'-0" x 7'-0" x 1 3/4"	2	HM	S	A	HM	--	H1/A501	J1/A501	--	--	X	X	X	X	--	--	--	--	--	--	X	1.5	X	--	X	--	3	--	--	X	--	--	--	--	X									
OFFICE	106A	3'-0" x 7'-0" x 1 3/4"	3	HM	T	A	HM	--	H1/A501	J1/A501	--	--	--	--	X	X	--	--	--	--	--	--	X	1.5	X	--	--	--	3	X	--	--	--	--	--	--	X									
OFFICE	106B	3'-0" x 7'-0" x 1 3/4"	3	HM	T	A	HM	--	H1/A501	J1/A501	--	--	--	--	X	X	--	--	--	--	--	--	X	1.5	X	--	--	--	3	--	--	--	--	--	--	--	X									
ELECTRICAL ROOM	112	3'-0" x 7'-0" x 1 3/4"	1	HM	--	A	HM	--	H1/A501	J1/A501	--	--	X	--	X	X	--	X	--	--	--	--	X	1.5	--	--	--	--	3	X	--	--	--	--	--	--	--									
HALLWAY	113	3'-0" x 7'-0" x 1 3/4"	2	HM	T	A	HM	--	H1/A501	J1/A501	--	--	X	--	X	X	--	X	--	--	--	--	1.5	--	--	X	--	3	X	--	--	X	--	--	--	--	--									
JANITORS CLOSET	114	3'-0" x 7'-0" x 1 3/4"	1	HM	--	A	HM	--	H1/A501	J1/A501	--	--	--	--	X	X	--	--	--	--	--	--	1.5	--	--	--	--	3	X	--	--	X	--	--	--	--	--									
STORAGE	115	4'-0" x 7'-0" x 1 3/4"	2	HM	T	A	HM	--	H1/A501	J1/A501	--	--	X	--	X	X	--	--	--	--	--	X	--	1.5	--	X	--	--	3	X	--	--	X	--	--	--	--									
CORRIDOR	118	3'-0" x 7'-0" x 1 3/4" PR	4	AL	TI	F	AL	TI	H3/A503	J3/A503	S1/A501	--	X	X	X	X	--	--	--	--	--	X	--	--	CONT.	--	--	--	2	X	X	--	X	--	--	--	--	--								

X = NEW ITEM, REPLACE EXISTING ITEMS WHERE NOTED AT EXISTING CONDITIONS  
EX = EXISTING ITEM TO REMAIN. GC SHALL VERIFY ALL EXISTING CONDITIONS AND  
CONFIRM WORKING ORDER

WHERE NOTED WITH TOP & BOTTOM BOLTS, BOLTS SHALL BE PROVIDED ON INACTIVE LEAF WITH DUMMY LEVER AND ACTIVE LEAF LATCHING INTO INACTIVE DOOR.



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DESIGN

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---------	--

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CONSULTANT:


PROJECT:

SEAL

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DRAWING NO.



# A501



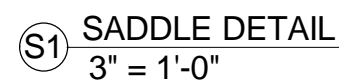





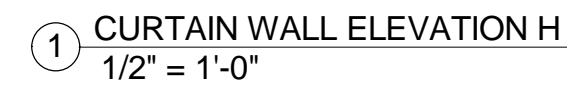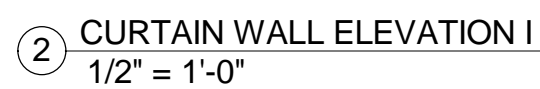



[illegible]


The first step in the process is to identify the problem. This involves gathering information about the situation and the people involved. Once the problem is identified, the next step is to analyze it. This involves breaking the problem down into its component parts and determining the causes of the problem. The third step is to develop a plan of action. This involves determining the steps that need to be taken to solve the problem. The fourth step is to implement the plan. This involves putting the plan into action and monitoring the progress. The fifth step is to evaluate the results. This involves determining whether the problem has been solved and whether the plan was effective.

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1998, 1999, 2000, 2001, 2679, 26


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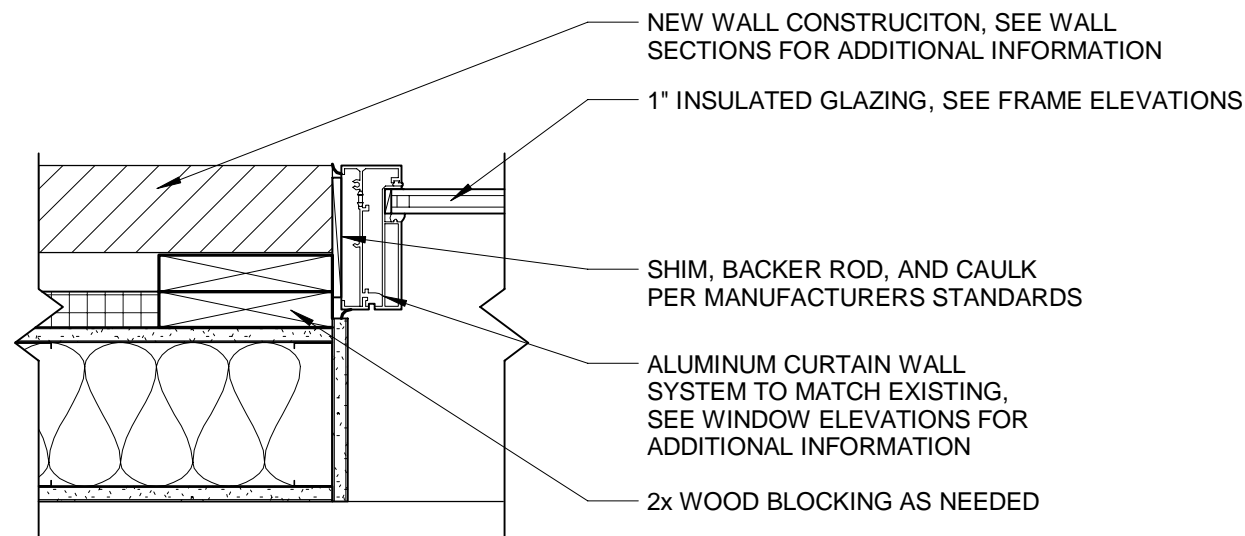





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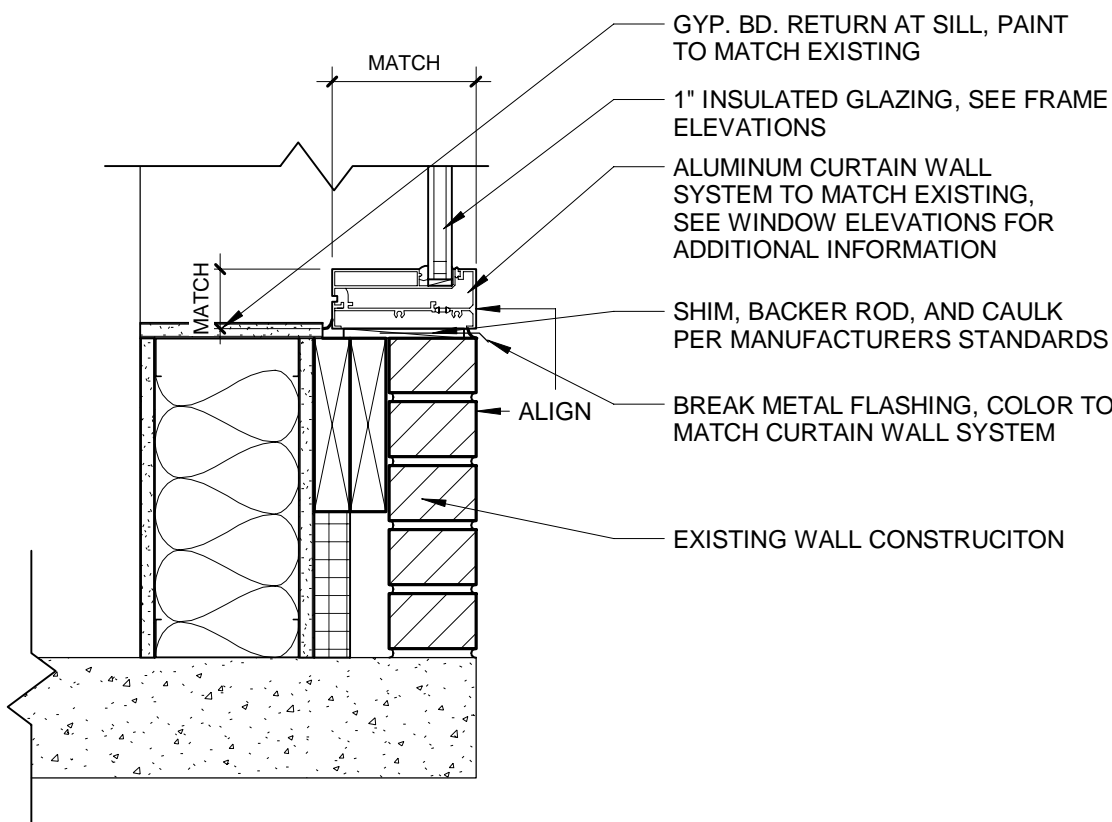
H6 ALUMINUM WINDOW HEAD DETAIL  
1 1/2" = 1'-0"

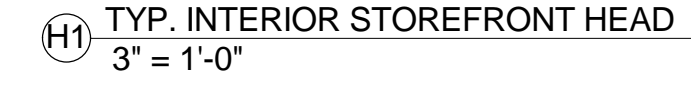


J6 ALUMINUM WINDOW JAMB DETAIL  
1 1/2" = 1'-0"

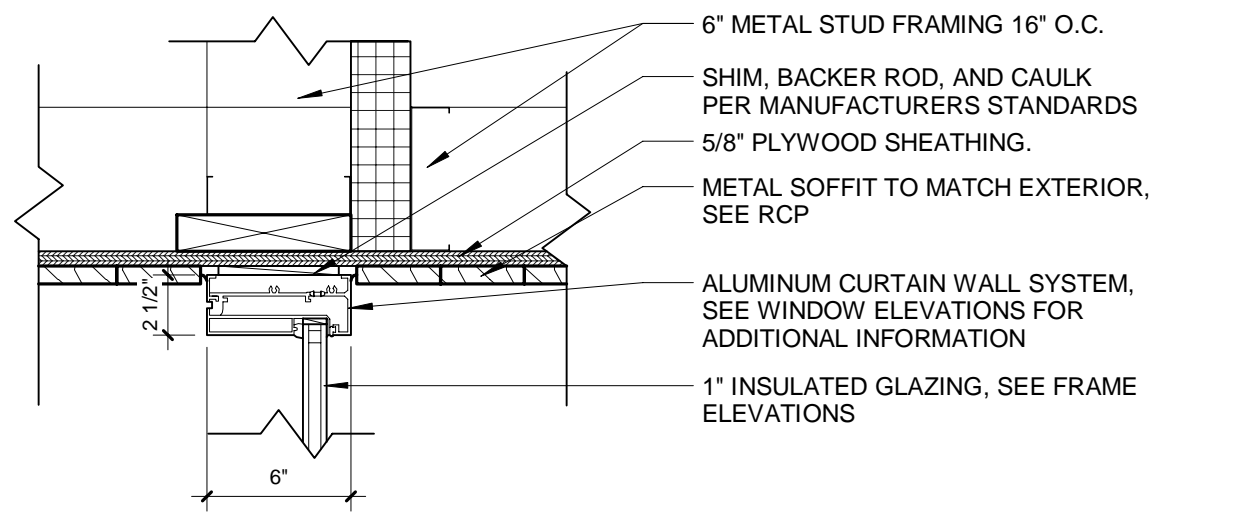


H5 ALUMINUM WINDOW HEAD DETAIL  
1 1/2" = 1'-0"

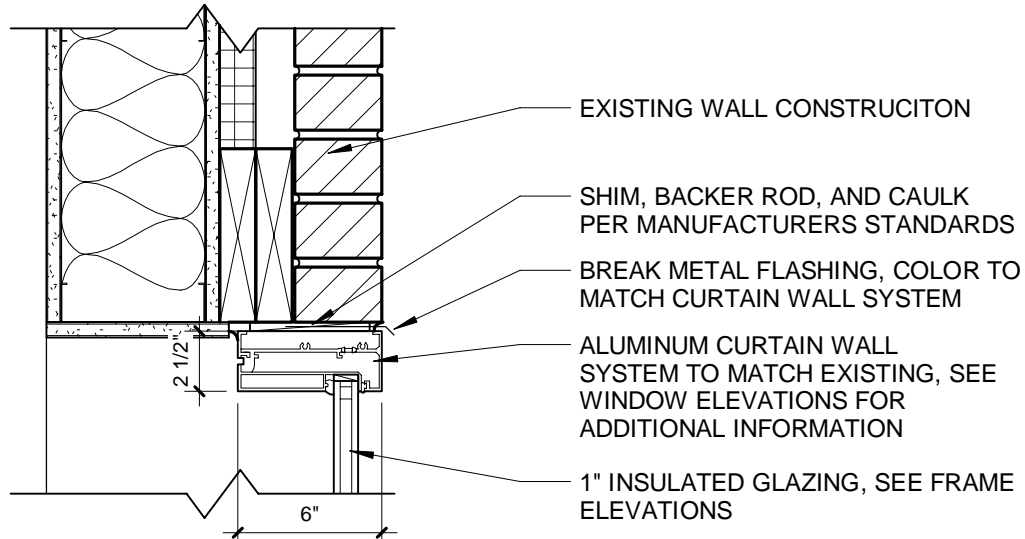


1 ALUMINUM WINDOW SILL DETAIL  
1 1/2" = 1'-0"

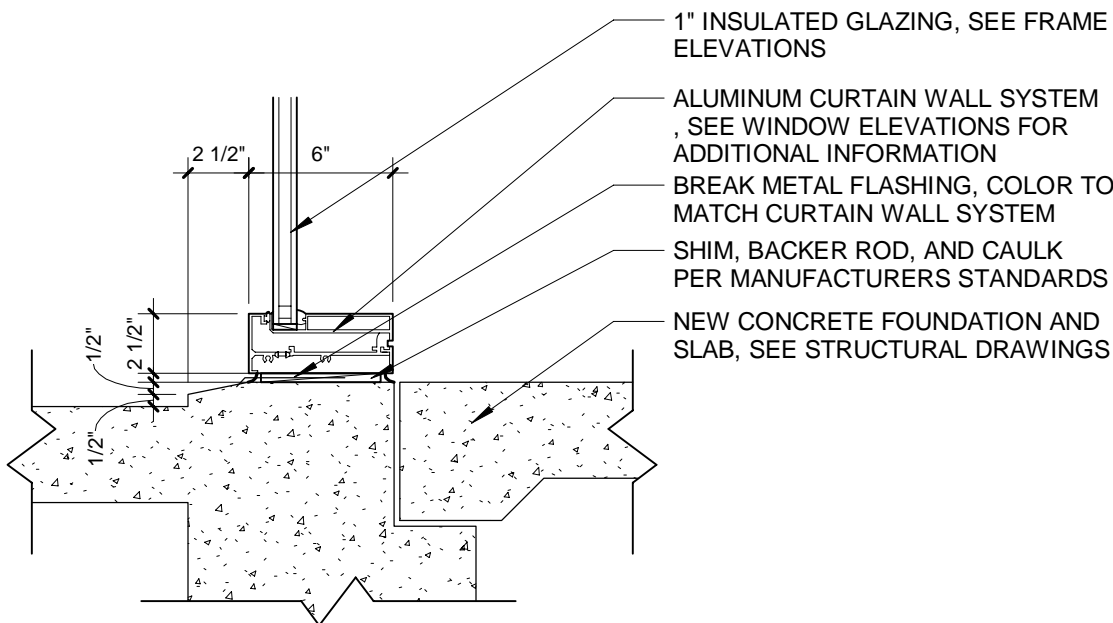

2 ALUMINUM WINDOW SILL DETAIL  
1 1/2" = 1'-0"

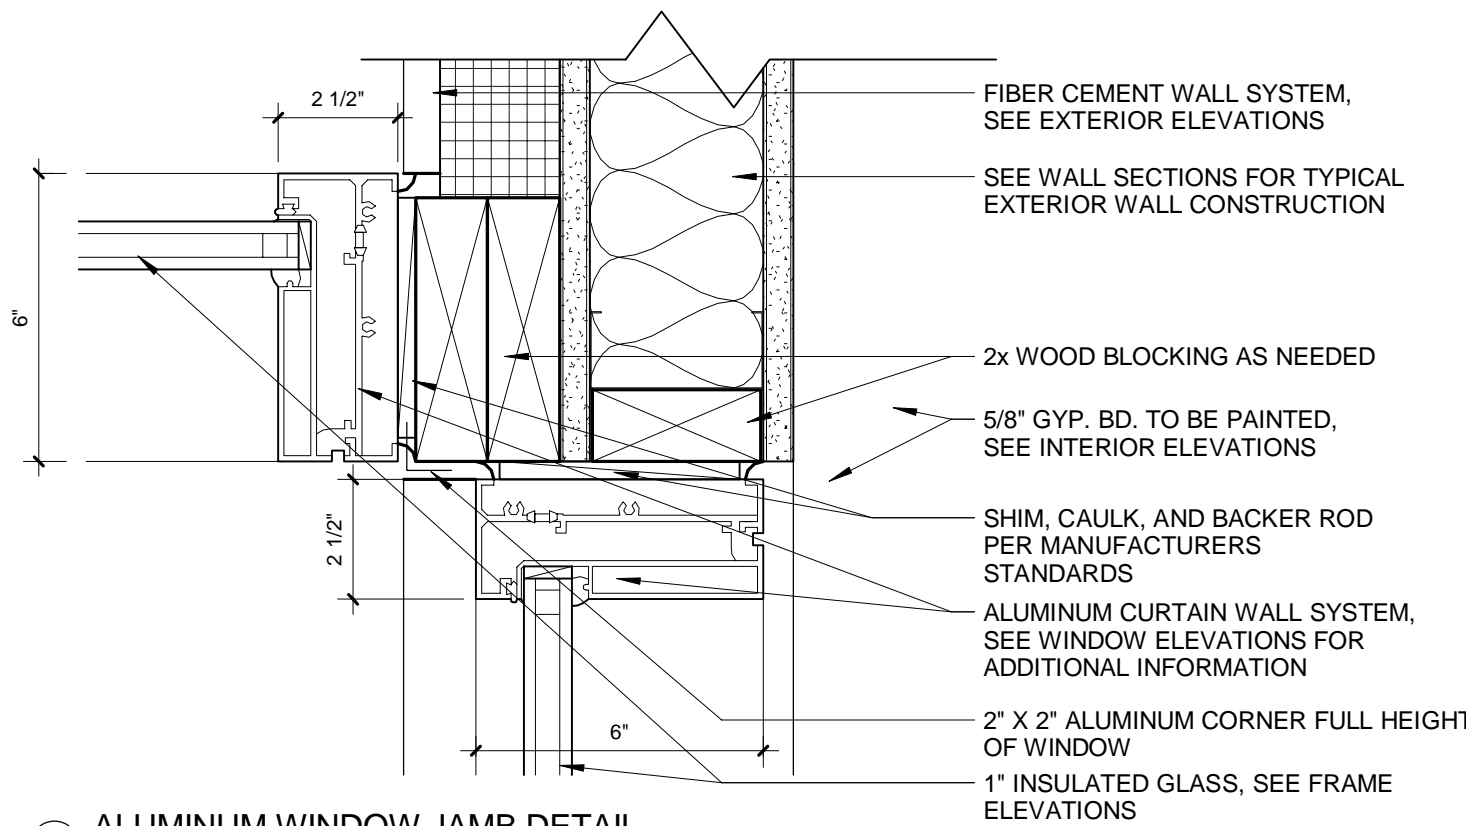

J6 ALUMINUM WINDOW JAMB DETAIL  
3" = 1'-0"

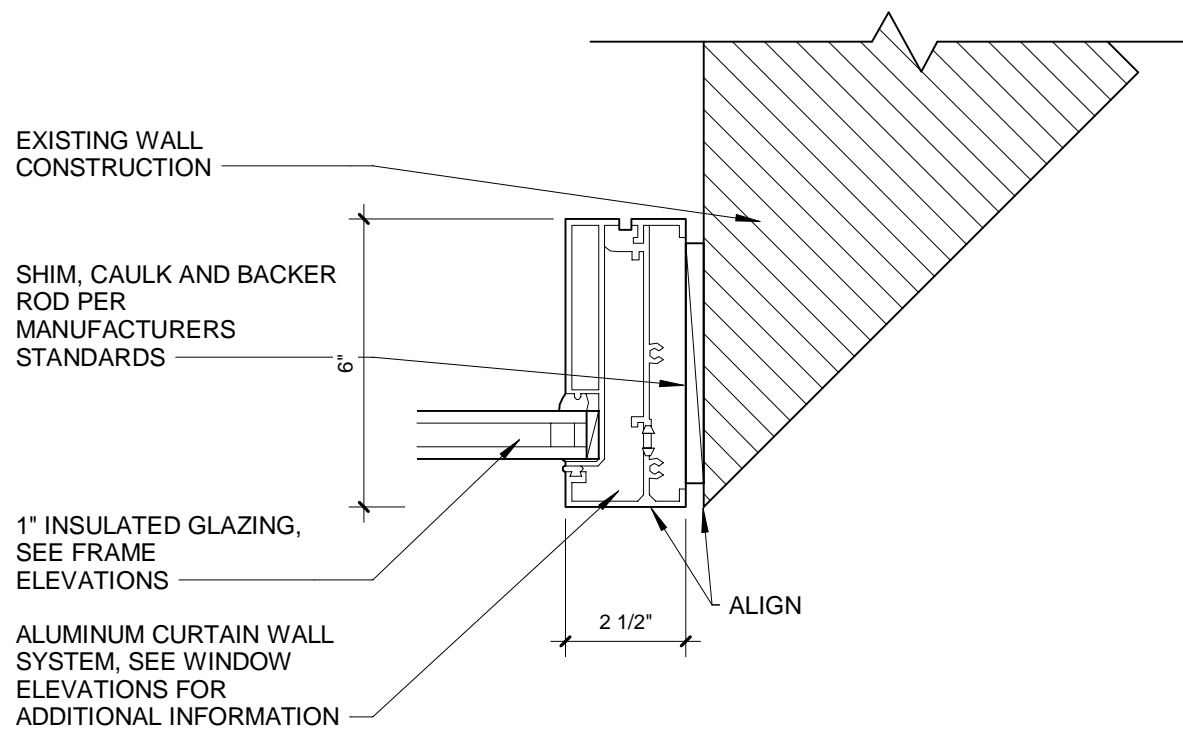

J5 ALUMINUM WINDOW JAMB DETAIL  
3" = 1'-0"

ARCHITECT:  
**PHASE ZERO DESIGN**  
8 WILCOX STREET  
SIMSBURY, CONNECTICUT 06070  
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FAX: (860) 264-1628  
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CONSULTANT:

**SUNY PURCHASE COLLEGE**  
CAFE ADDITION AND RENOVATION  
735 ANDERSON HILL RD  
PURCHASE, NY 10577

NO.		REVISIONS	
		DATE	DESCRIPTION



SEAL:

ISSUED FOR: BID  
ISSUED DATE: 02.16.2018  
DRAWN BY: JW  
CHECKED BY: CM  
PROJECT NUMBER: 1517347  
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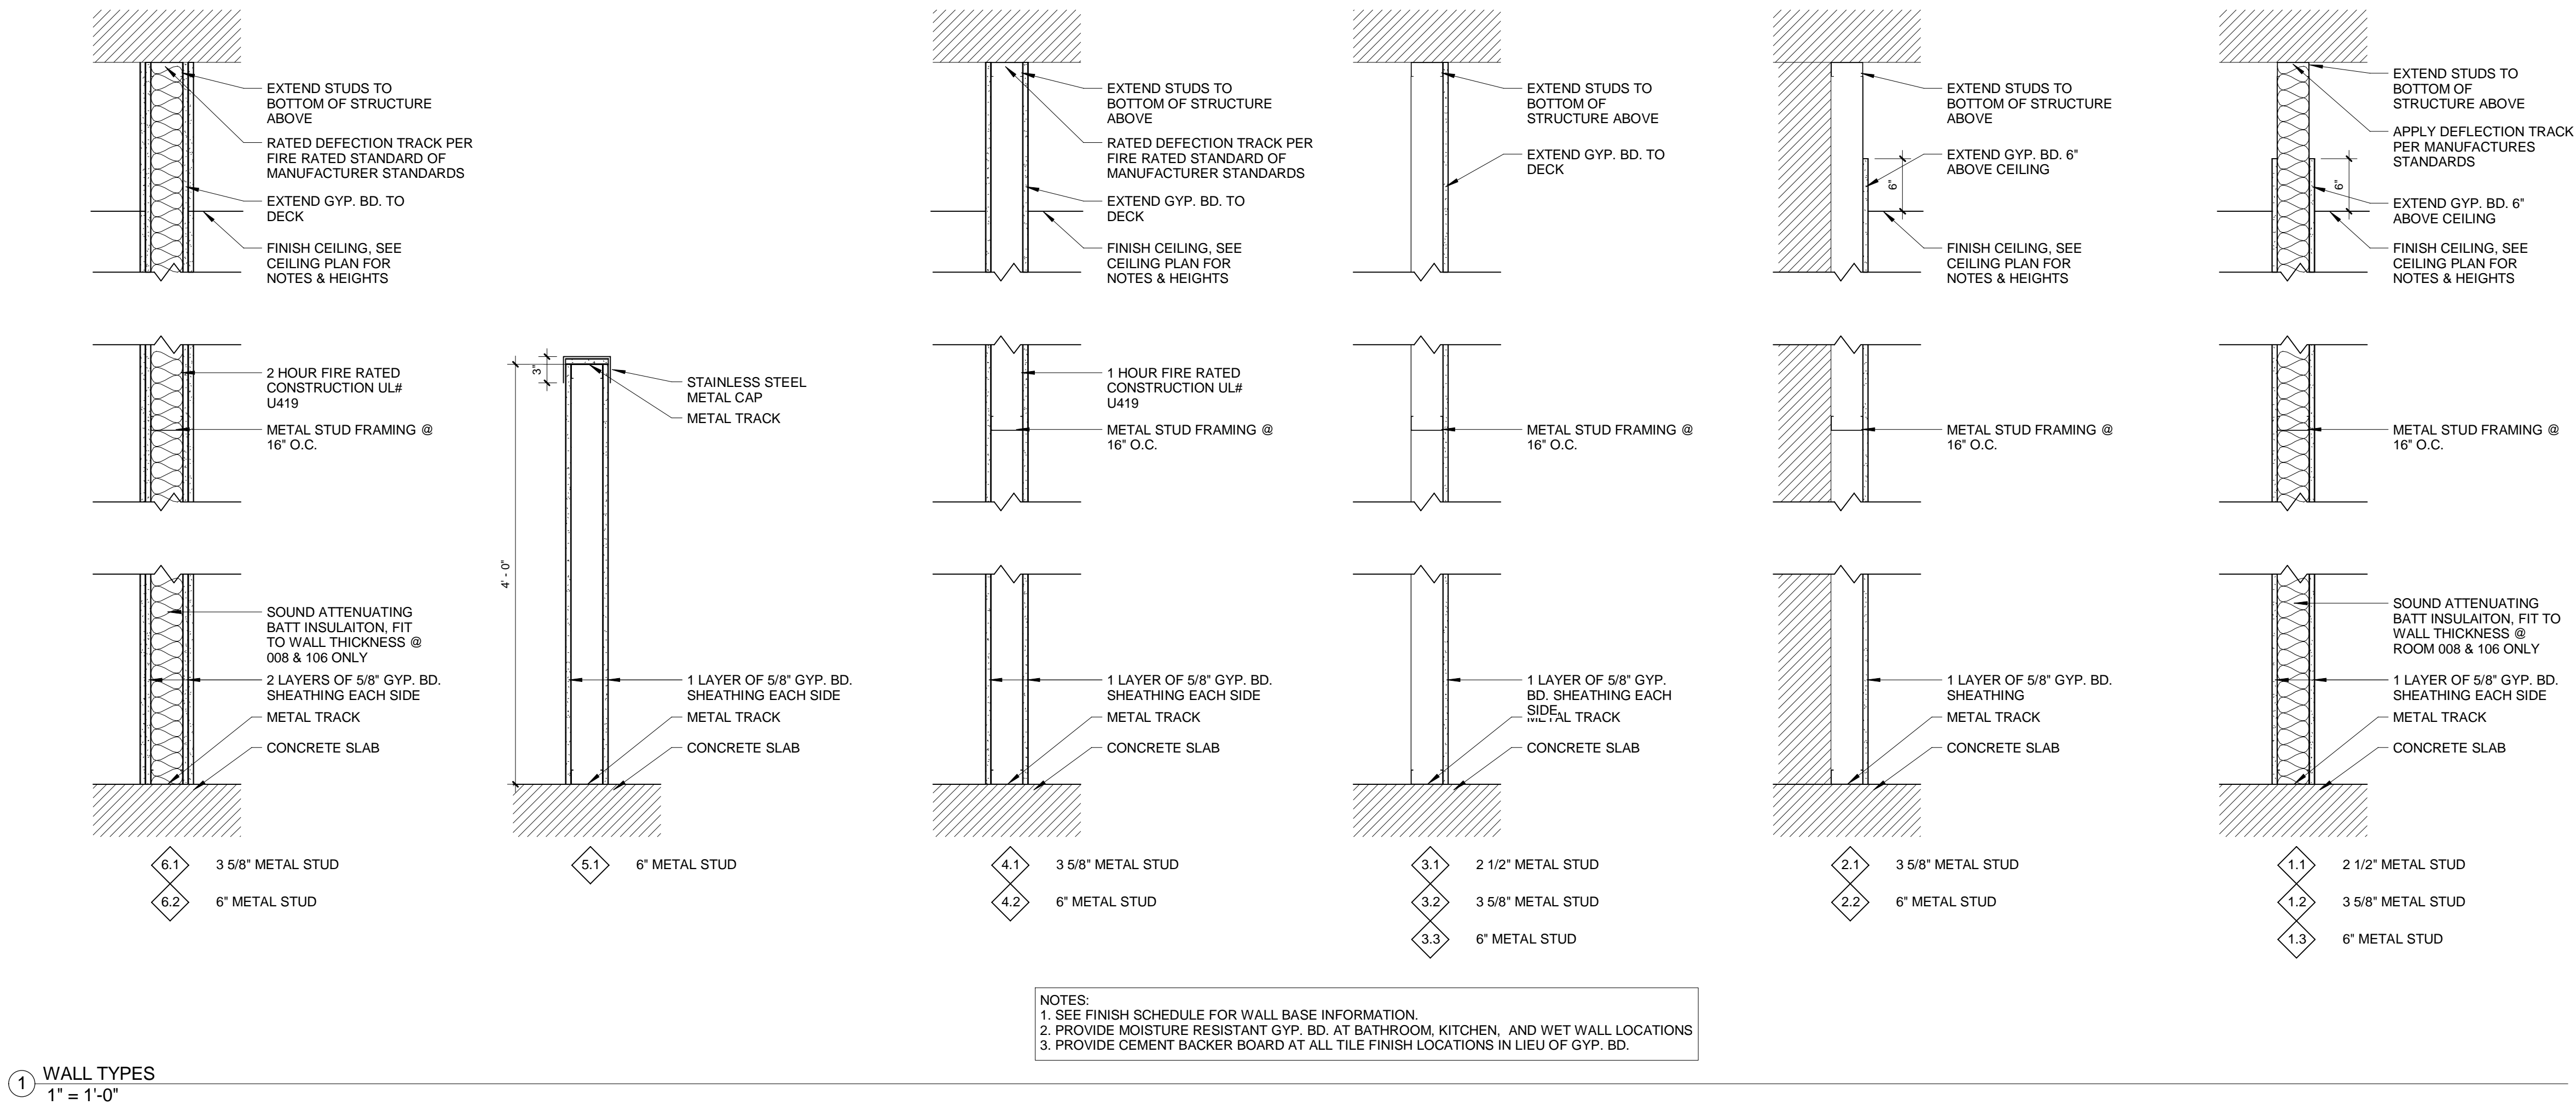
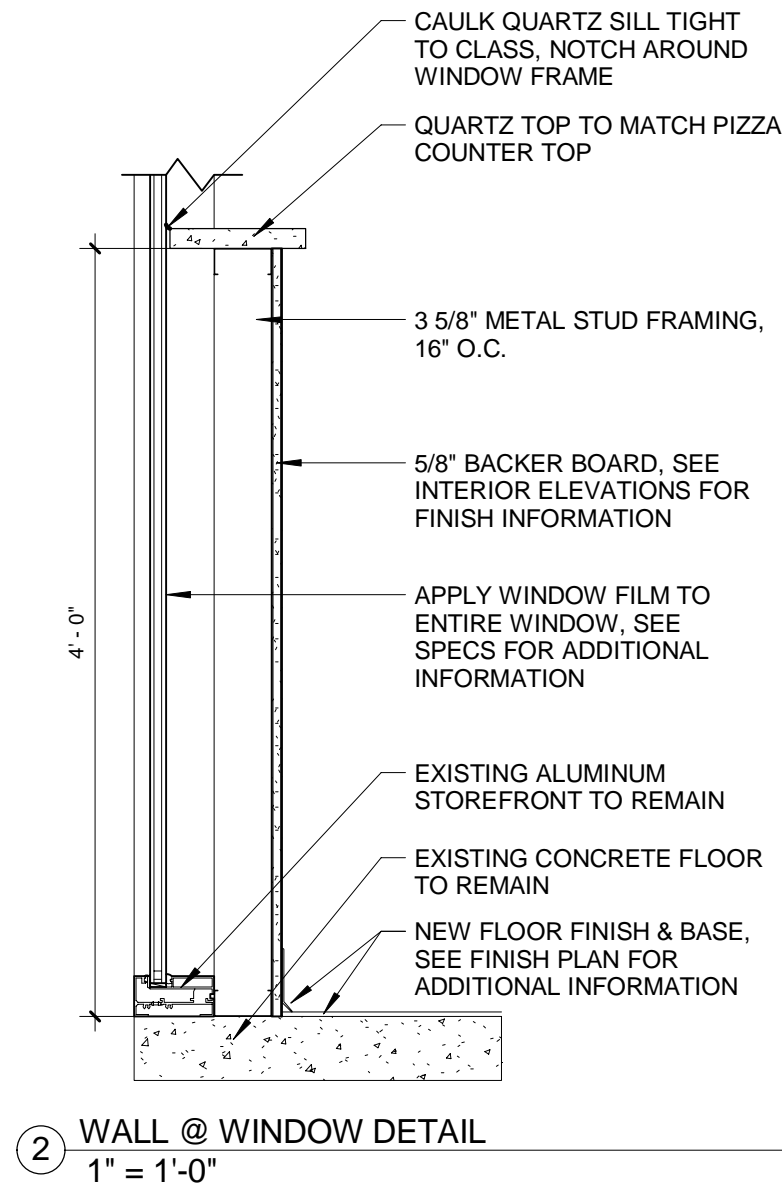
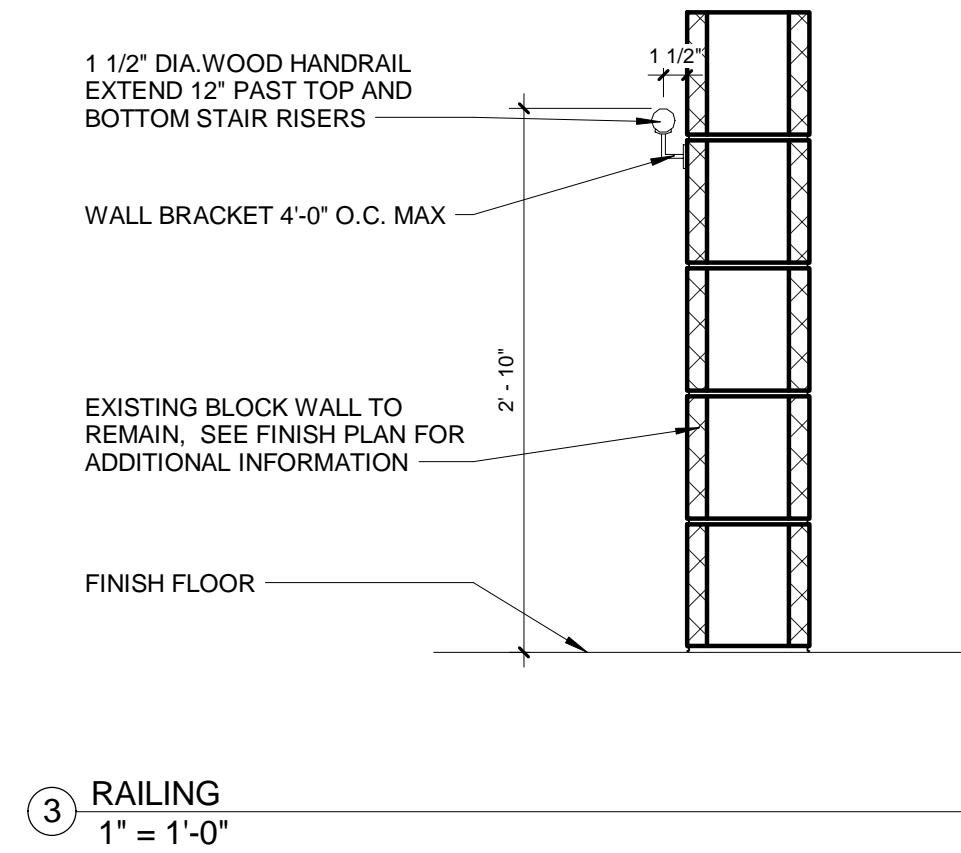
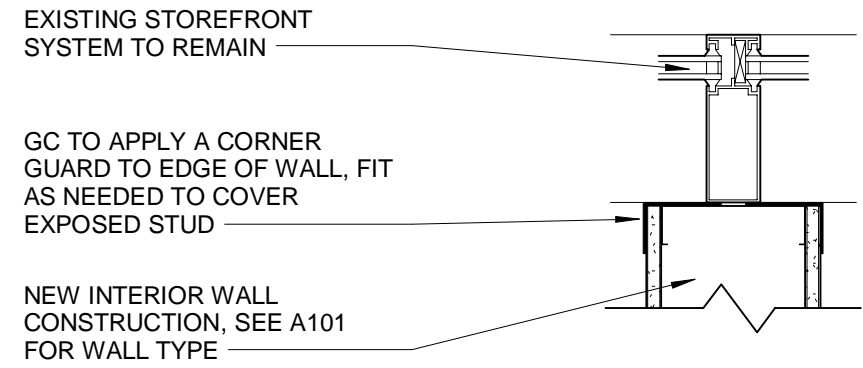
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**ALUMINUM FRAME DETAILS II**  
DRAWING NO.  
**A505**



Plot Date: 2/20/2018 5:33:57 PM Dwg Filename: C:\Users\l\_woodworth\Documents\SUNY Purchase - Hub\_L\_woodworth.rvt

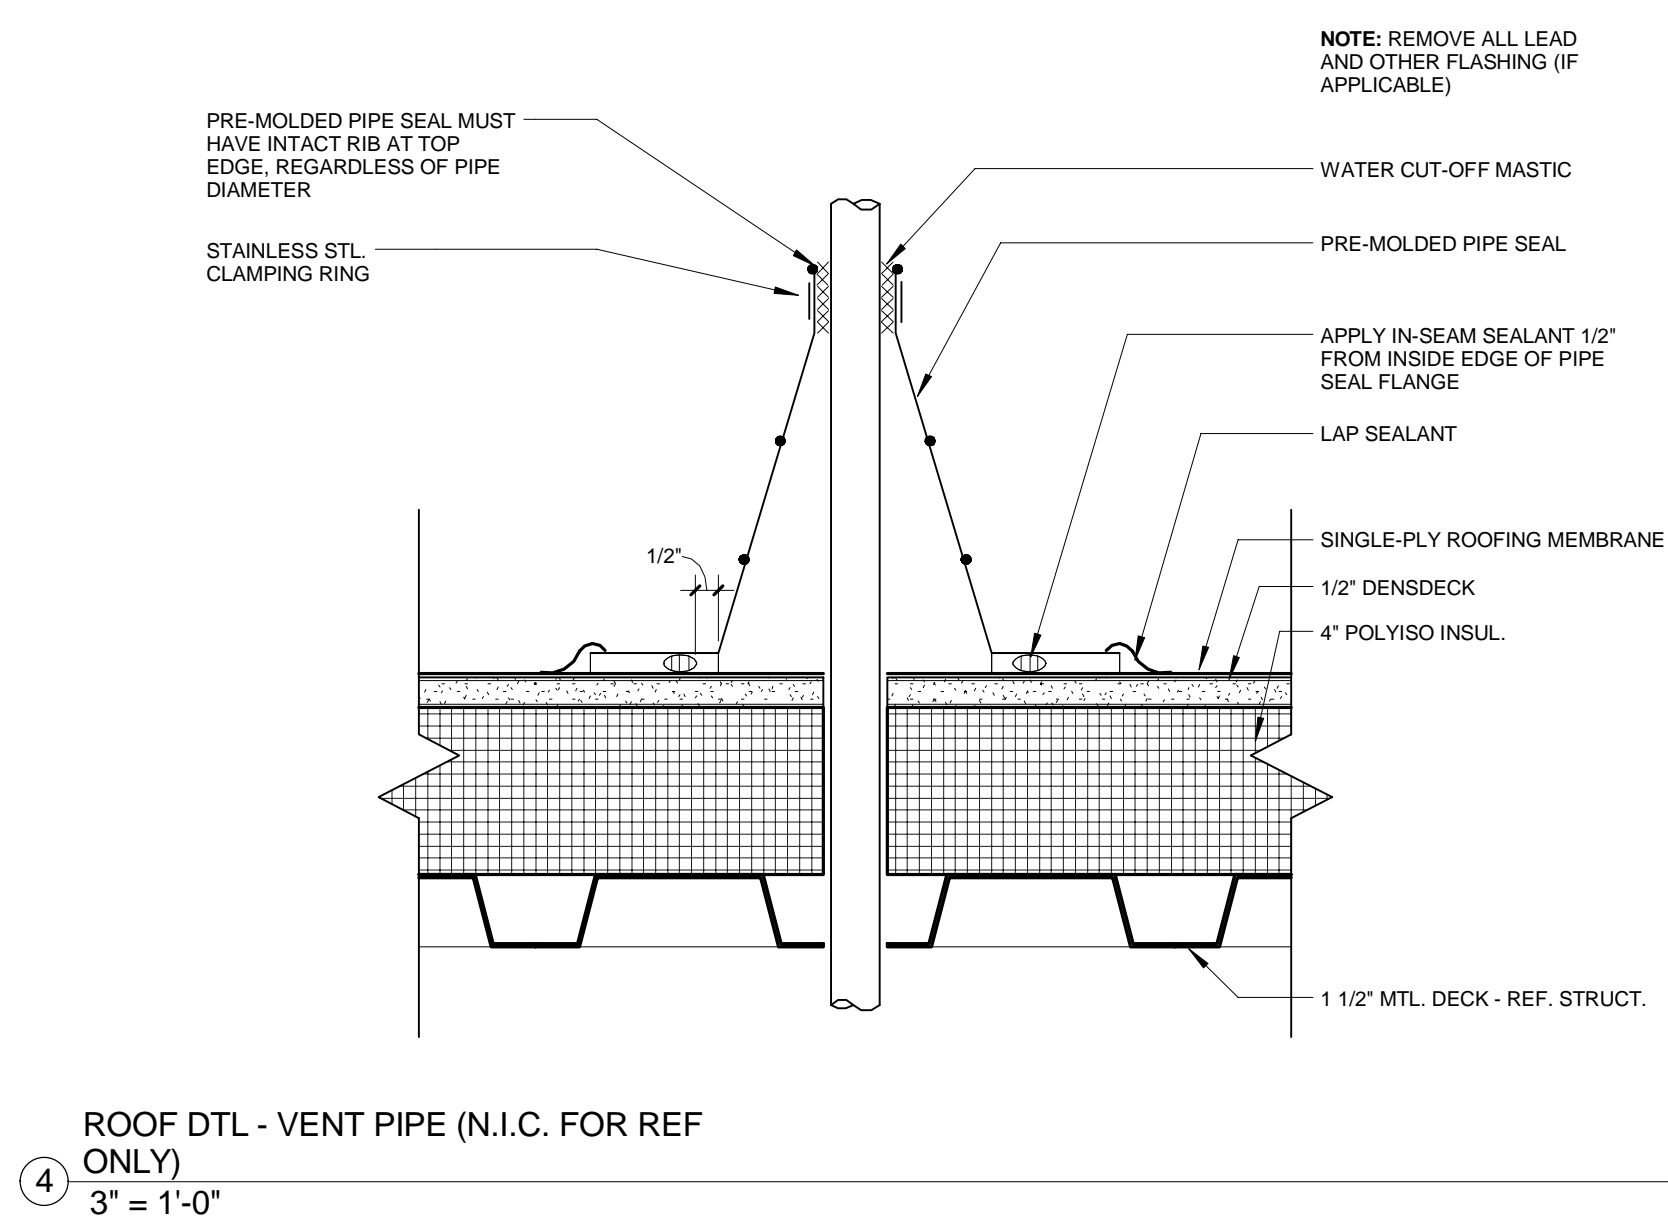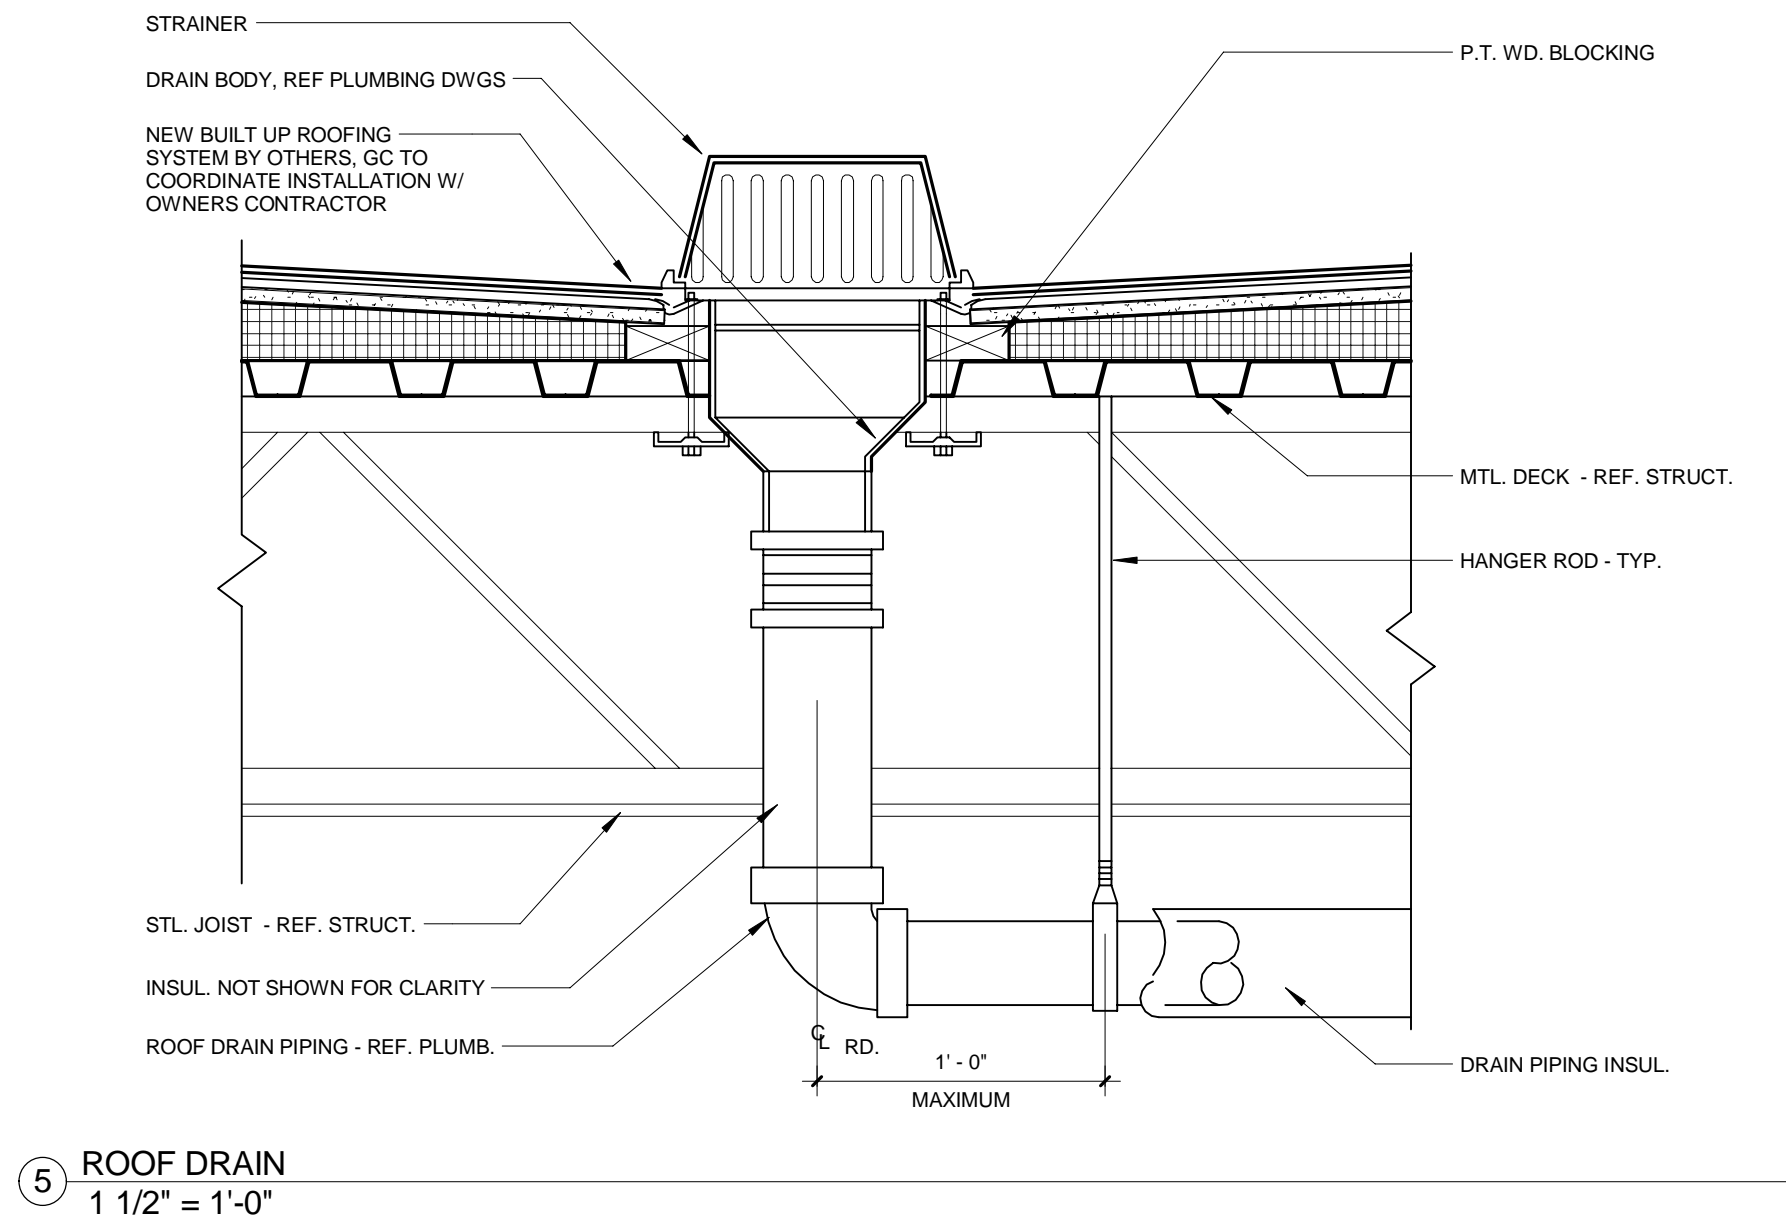

6 WALL @ WINDOW MULLION  
1 1/2" = 1'-0"



NOTES:  
1. SEE FINISH SCHEDULE FOR WALL BASE INFORMATION.  
2. PROVIDE MOISTURE RESISTANT GYP. BD. AT BATHROOM, KITCHEN, AND WET WALL LOCATIONS  
3. PROVIDE CEMENT BACKER BOARD AT ALL TILE FINISH LOCATIONS IN LIEU OF GYP. BD.

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PURCHASE, NY 10577

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		DESCRIPTION	

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ISSUED DATE: 02.16.2018  
DRAWN BY: JW  
CHECKED BY: CM  
PROJECT NUMBER: 1517347  
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MISCELLANEOUS  
DETAILS I

DRAWING NO.  
**A601**



1. REFERENCE ARCHITECTURAL DRAWINGS FOR CONSTRUCTION LAYOUT PLANS.
2. SEE EQUIPMENT DRAWINGS FOR ADDITIONAL EQUIPMENT DRAWINGS (EQUIPMENT TO BE PROVIDED BY OTHERS).
3. SEE MEP DRAWINGS FOR ADDITIONAL INFORMATION.
4. MILLWORK TO BE PROVIDED BY OTHERS.

8 WILCOX STREET  
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## CAFE ADDITION AND RENOVATION

PURCHASE, NY 10577

[illegible]

REAL:

ISSUED FOR: BID

ISSUED DATE: 02/16/2018

DRAWN BY: JW

CHECKED BY: CM

PROJECT NUMBER: CW-0205.4


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PRINTING NAME.

GENERAL  
ARRANGEMENT  
PLAN - BASEMENT

DRAWING NO.

V100

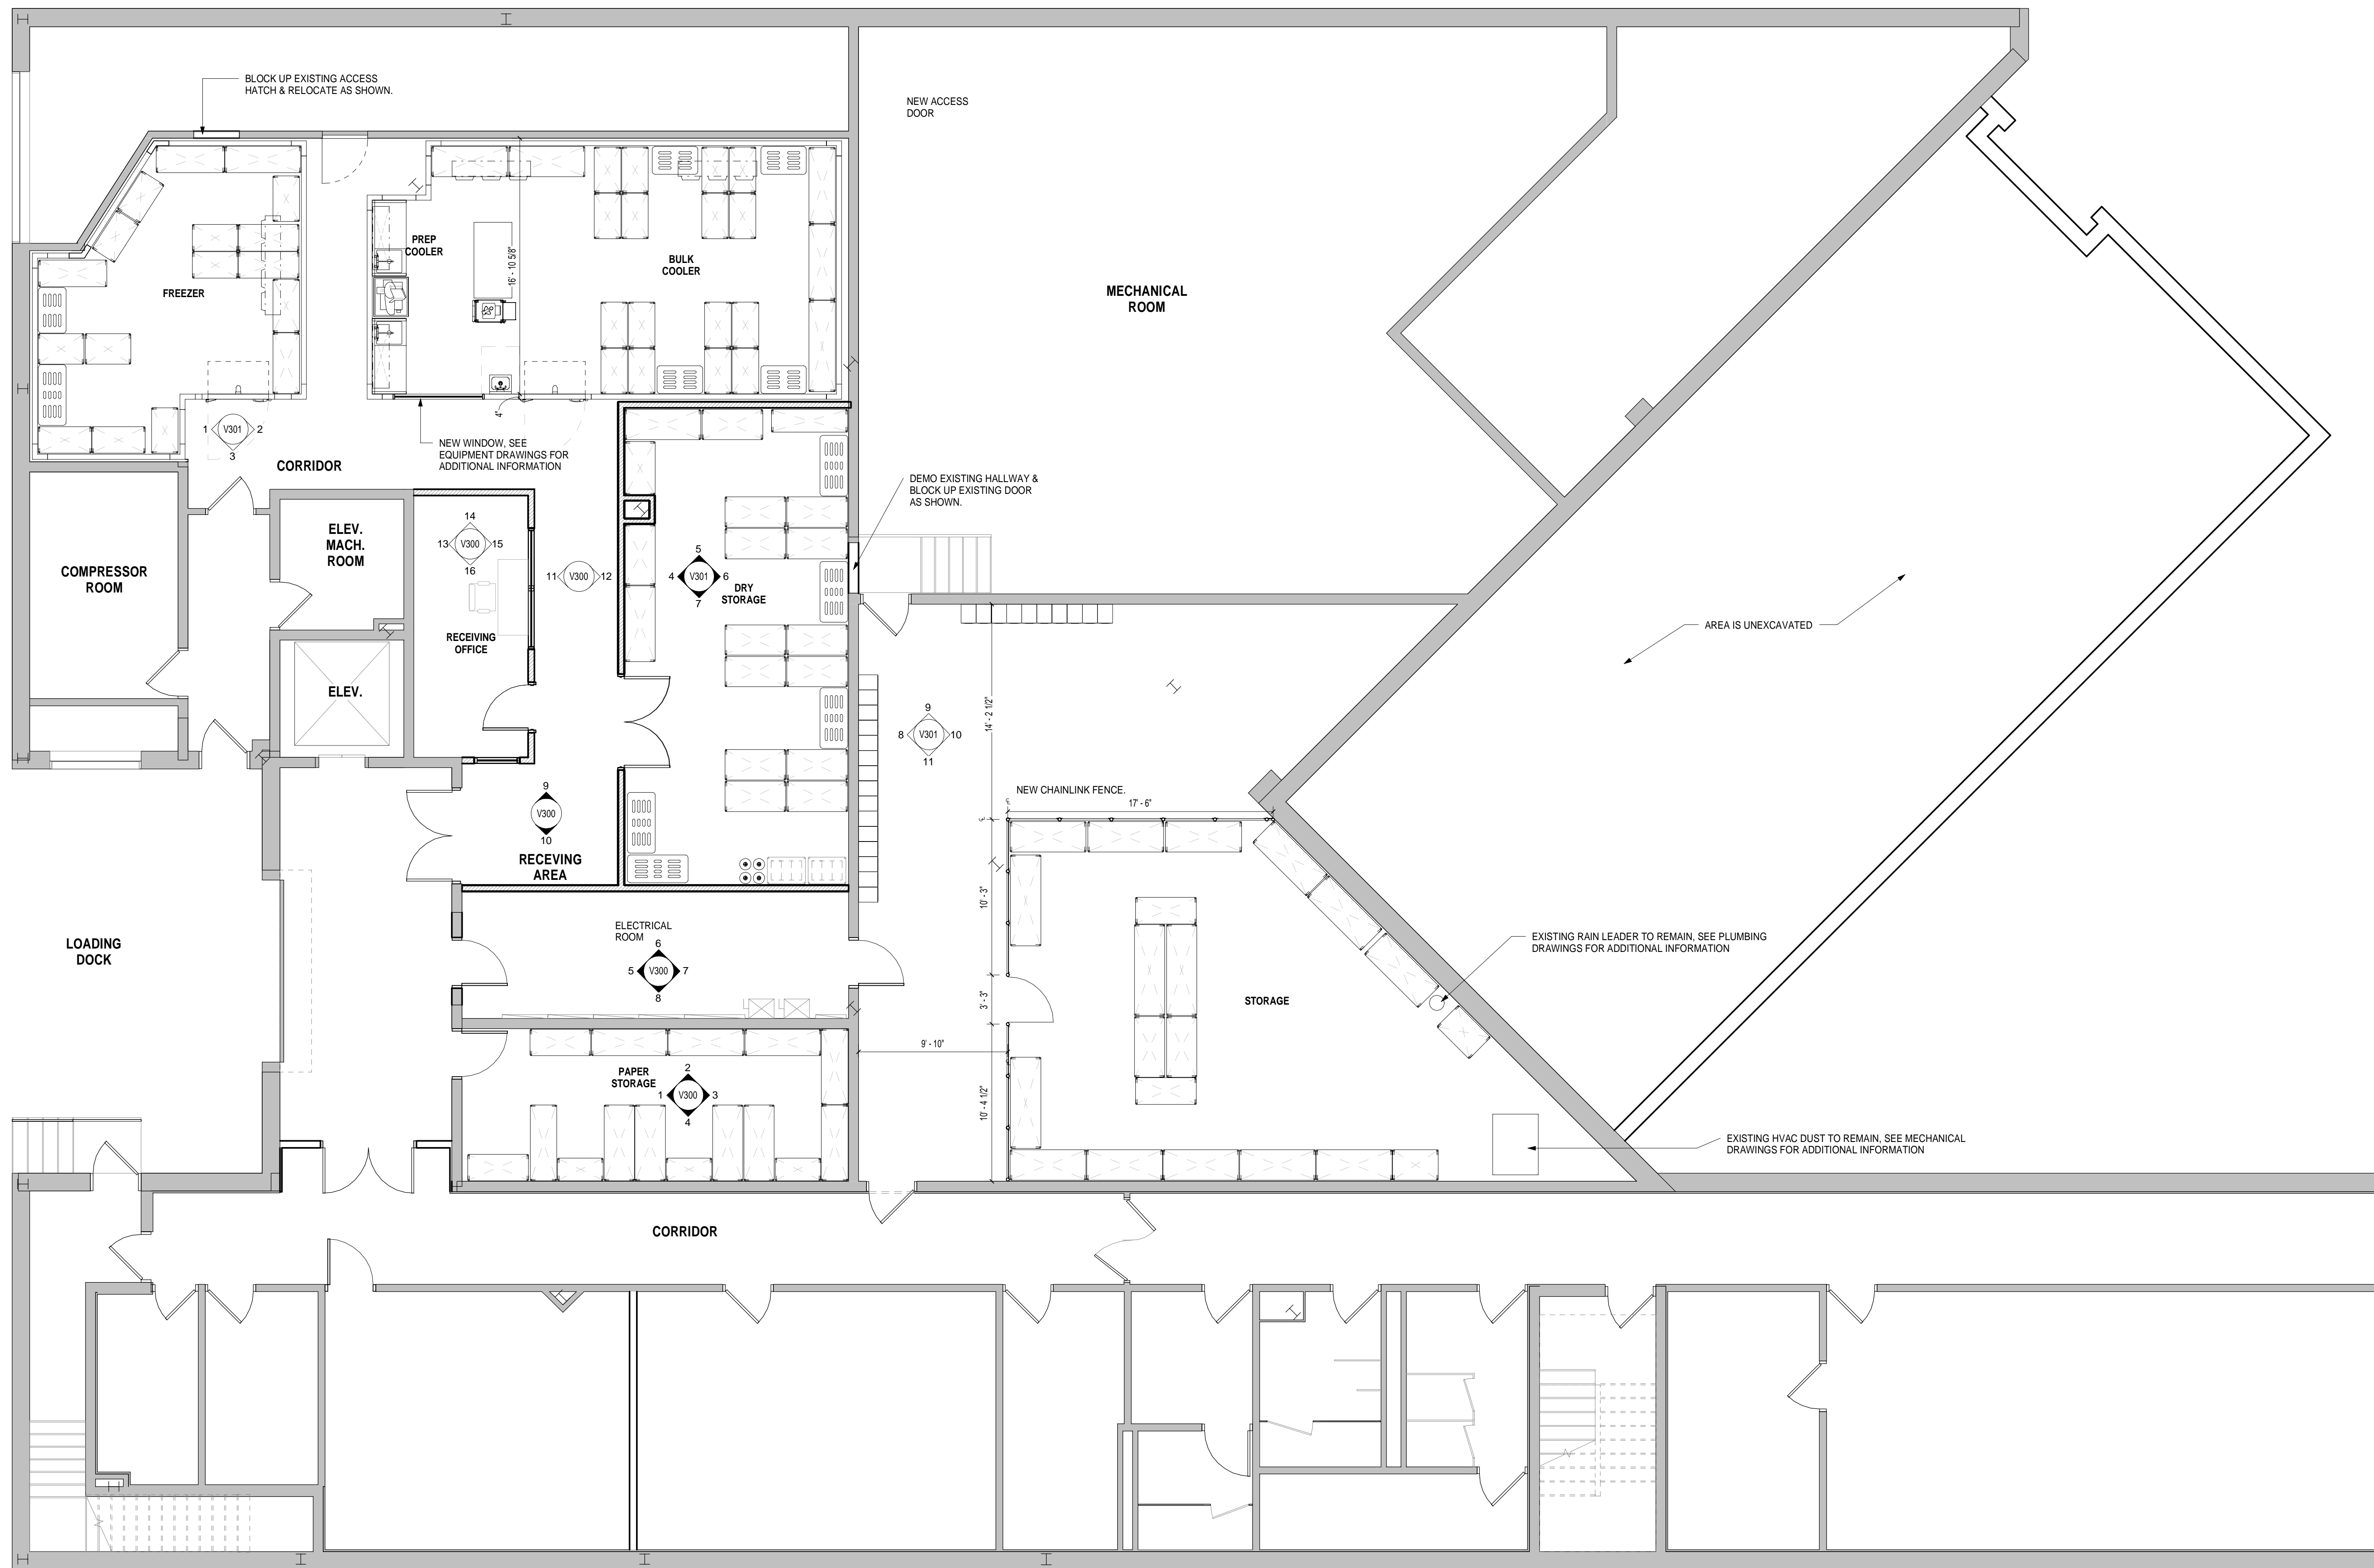

## GENERAL ARRANGEMENT PLAN - BASEMENT

Plot Date: 2/20/2018 5:18:03 PM Dwg Filename: C:\Users\j\_woodworth\Documents\CW-0205-4-NORTH CAMPUS\_v2016CD\_j\_woodworth.rvt

Plot Date: 2/20/2018 5:18:03 PM








$$\frac{3}{16}'' = 1'-0''$$
$$3/16'' = 1'-0''$$

1. REFERENCE ARCHITECTURAL REFLECTED CEILING DRAWINGS FOR CONSTRUCTION LAYOUT OF SOFFITS AND TILE CEILINGS.
2. SEE EQUIPMENT DRAWINGS FOR ADDITIONAL EQUIPMENT DRAWINGS. (EQUIPMENT TO BE PROVIDED BY OTHERS).
3. SEE MEP DRAWINGS FOR ADDITIONAL INFORMATION.
4. DRAWINGS V102 AND V112 ARE TO BE REFERENCED FOR CEILING FINISH AND LIGHT FIXTURES.
5. ALL AC TYLE CEILINGS ARE TO BE CENTERED WITH IN ROOM UNLESS OTHERWISE NOTED. SEE A200 AND A201 FOR ADDITIONAL INFORMATION.
6. 3/V112 AND 5/V112 DETAILS ON V112 ARE FOR FINISH AND INTERMEDIATE MEMBER LOCATIONS ONLY. SEE A203 FOR CONSTRUCTION DETAILS.

— AREA UNEXCAVATED

— GC TO SUPPLEMENT REMAINING AREA WITH EXISTING LIGHT TO BE RELOCATED AS NEEDED.

CLIENT:

OWNER:

CONSUL

1

PROJECT:

SEAL

DRAWING NAME:




DRAWING NO.

V102





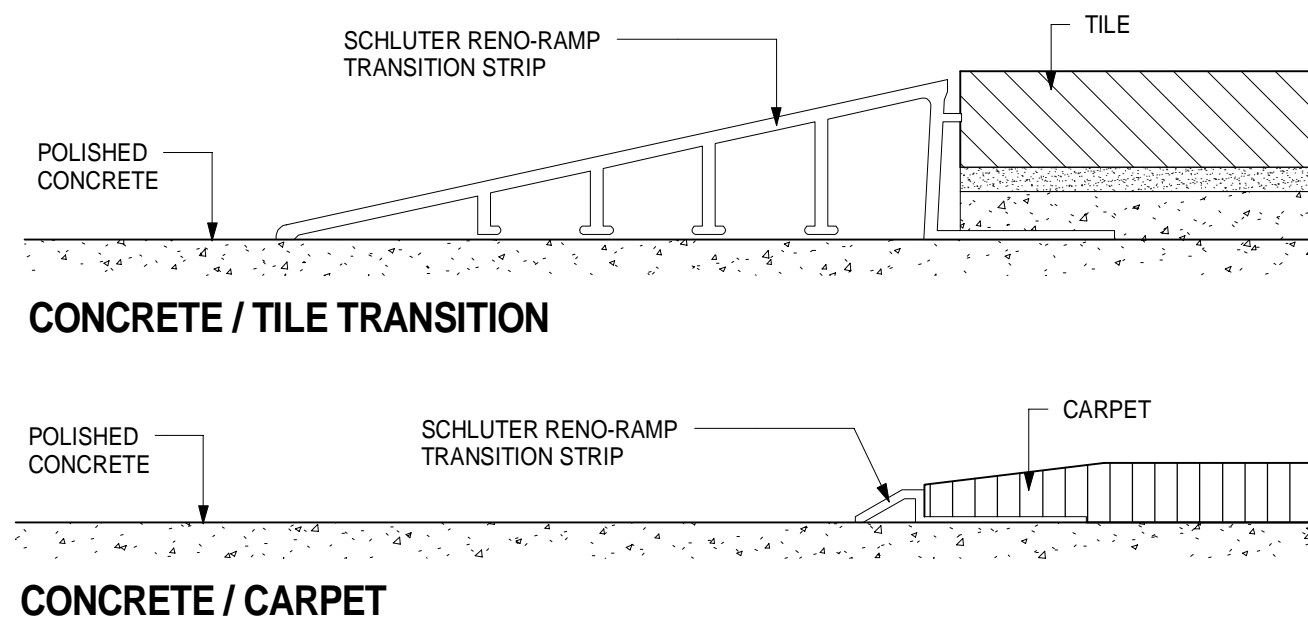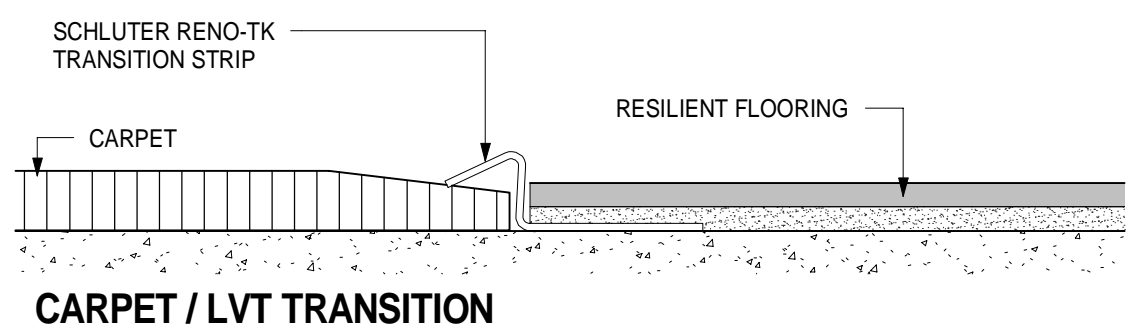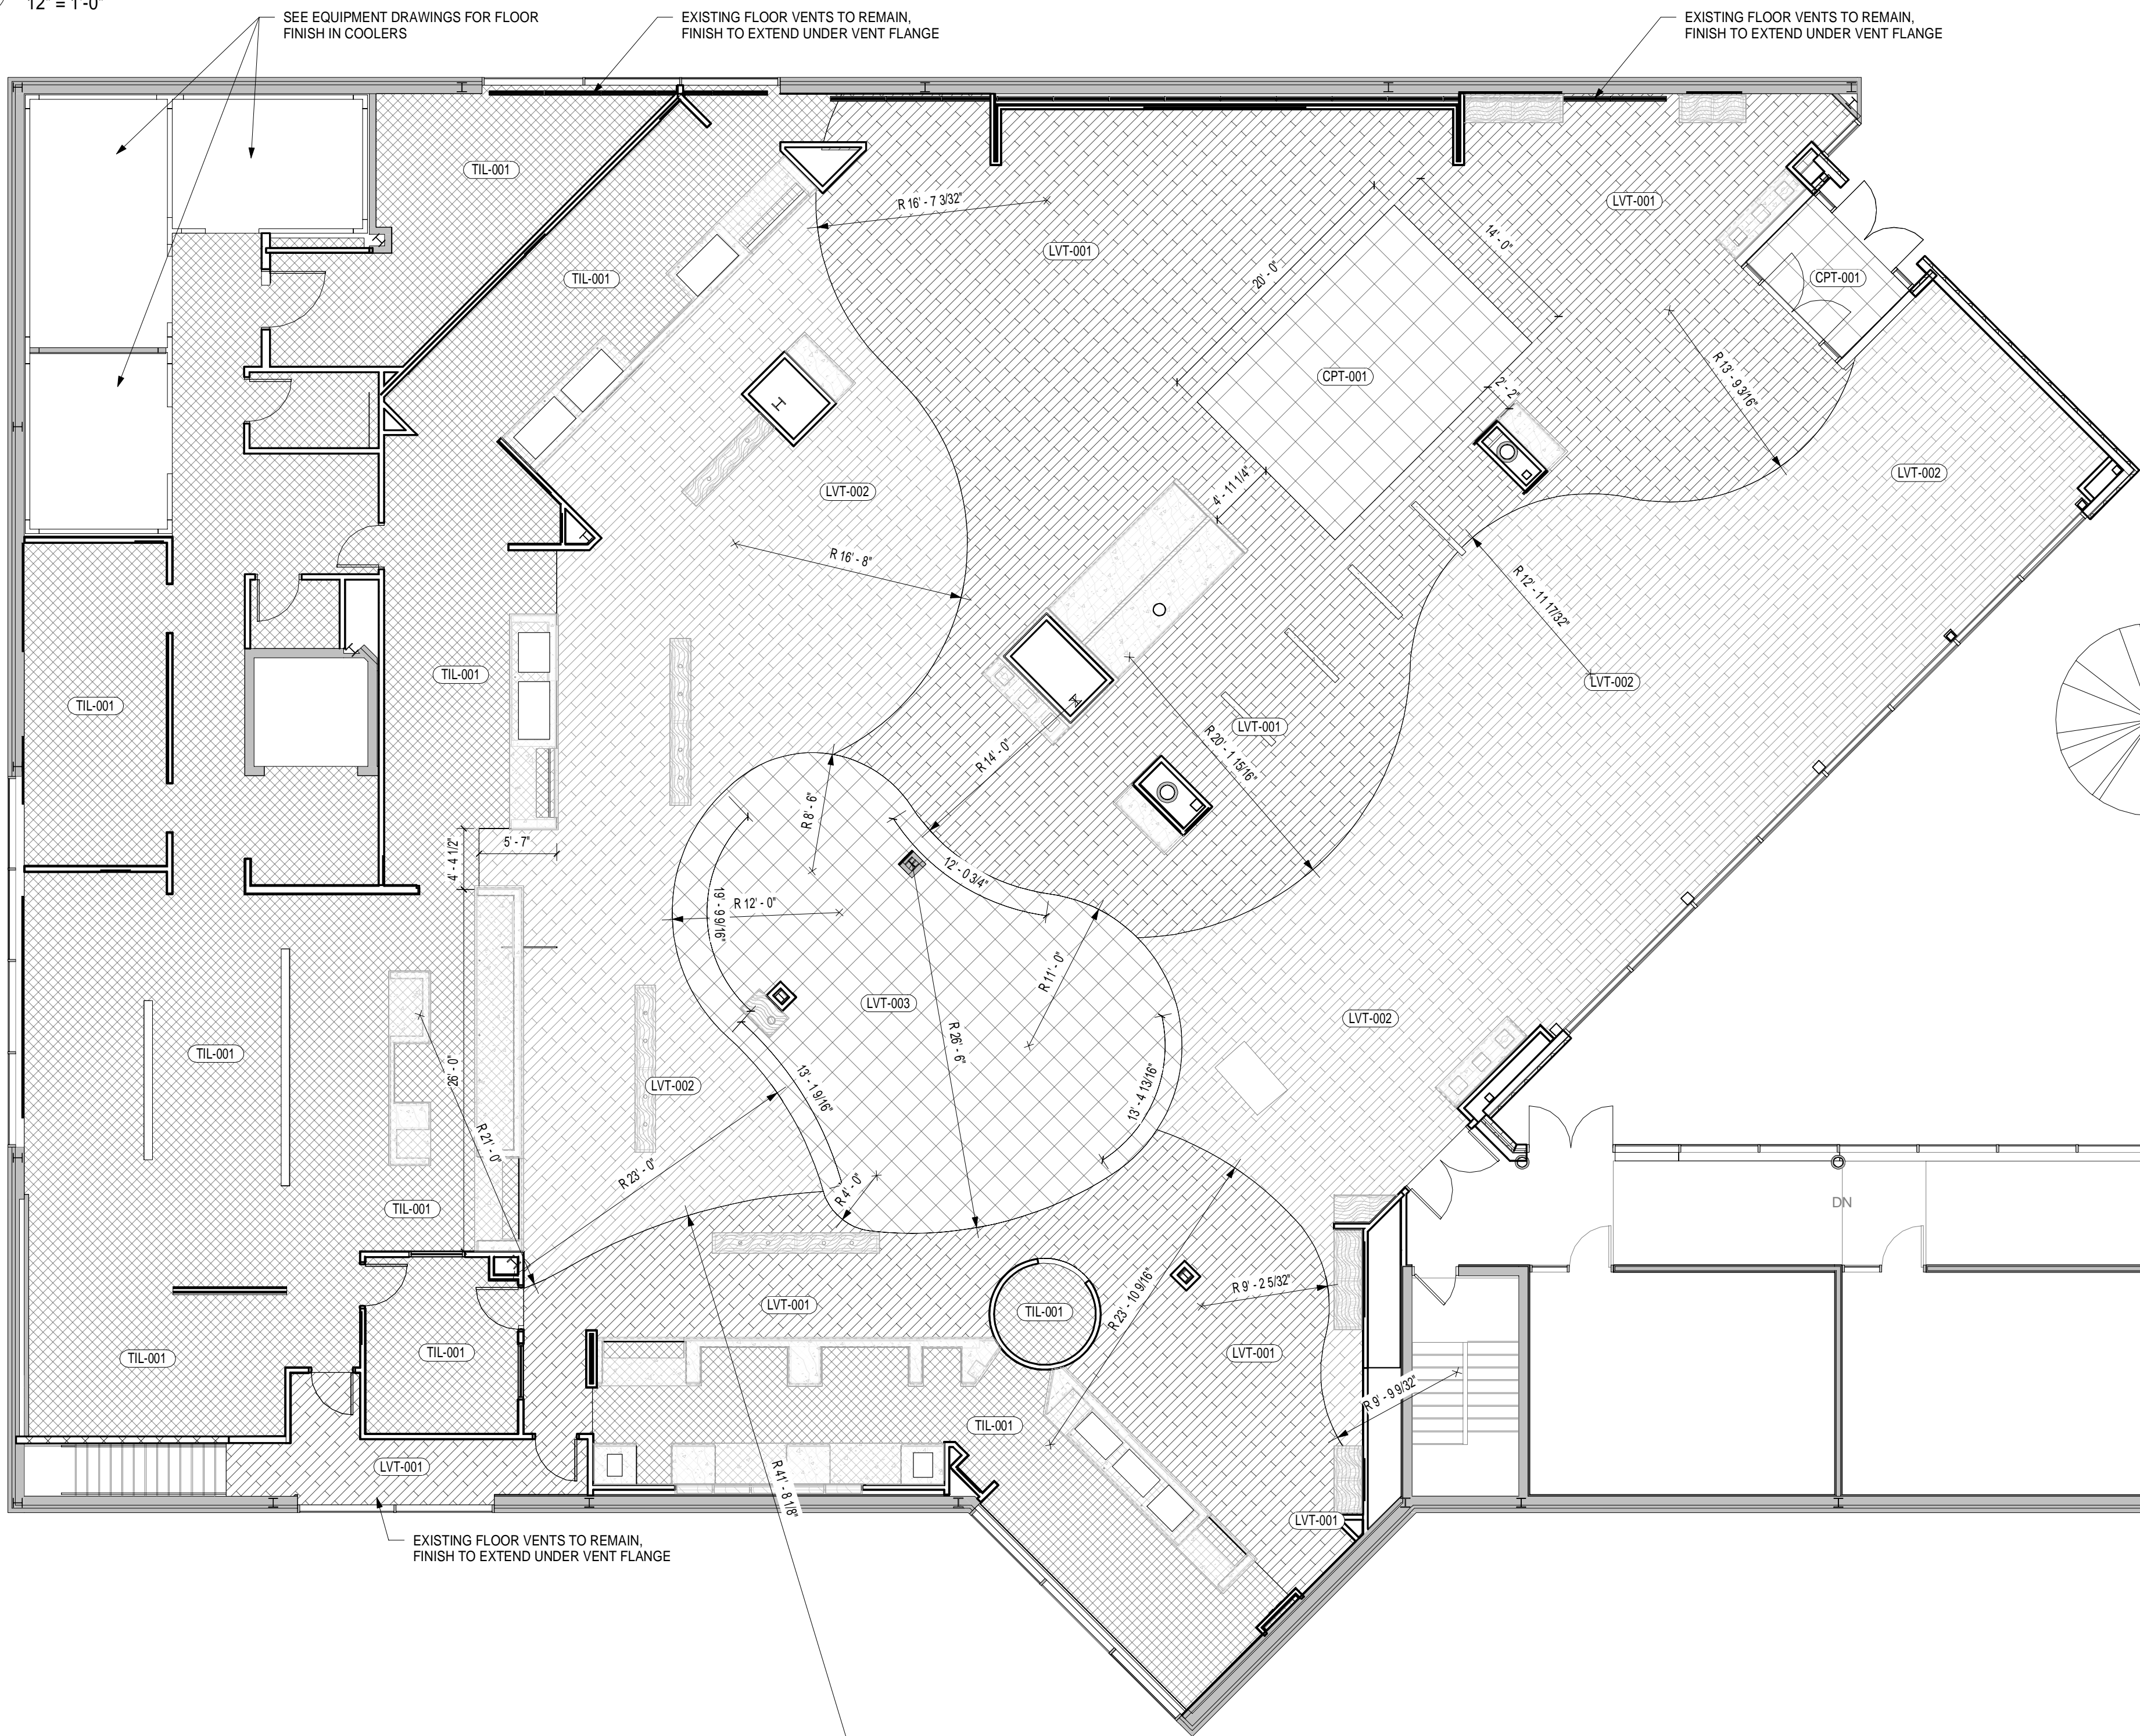


$$12'' = 1'-0''$$

$$1/8'' = 1'-0''$$

ARCHITECT.

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CAFE ADDITION AND RENOVATION

735 ANDERSON HILL RD  
PURCHASE, NY 10577

PROJECT:

[illegible]

SEARCH

ISSUED FOR: BID
ISSUED DATE: 02/16/2018
DRAWN BY: JW
CHECKED BY: CM
PROJECT NUMBER: CW-0205.4
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DRAWING NAME:

FLOOR FINISHES  
PLAN - FIRST  
FLOOR

DRAWING NO.

V111




LIGHT FIXTURE SCHEDULE			
SYMBOL	TYPE	MANUFACTURER	MODEL
	PENDANT LIGHT	PABLO STUDIO	PBL-SWELL-STRING-3-MIXED-SUSP-BLACK
	PENDANT LIGHT	LIGHTYEAR	LTY-CARAVAGGIO-CAR300-BLACK WITH RED CORD
	PENDANT LIGHT	TECHLIGHTING	POWELL PENDANT: TD-SO-S-CF, SATIN NICKLE/WHITE INTERIOR
	WALL LIGHT	BARN LIGHT ELECTRIC	THE DISTRICT GOOSENECK LIGHT, BLACK 16"D
	PENDANT LIGHT	TECHLIGHTING	THE DISTRICT GOOSENECK LIGHT, WHITE 14"D
	DOWNLIGHT	NORA LIGHTING	NTS-733CL / NHR-150
	2' x 4' LAY-IN FLUORESCENT LIGHT FIXTURE	SEE SPEC	
	2' x 2' LAY-IN FLUORESCENT LIGHT FIXTURE	SEE SPEC	
	4' LINEAR LIGHT FIXTURE	SEE SPEC	
	4' LINEAR INDUSTRIAL LIGHT FIXTURE	SEE SPEC	
	6' EXTERIOR GRADE CAN LIGHT	SEE SPEC	

CEILING SCHEDULE	
TYPE	DESCRIPTION
CLG-01	ARMSTRONG FINE FISSURED SQUARE LAY-IN MEDIUM TEXTURE TILES W/ GRID, SYSTEM, COLOR - WHITE (WH)
CLG-02	ARMSTRONG HEALTHZONE ULTIMA SQUARE LAY-IN FINE TEXTURE TILES W/ GRID, SYSTEM, COLOR - WHITE (WH)
CLG-03	NEW GYP. BD. SOFFIT, FINISH AS SPECIFIED.
CLG-04	NEW CEMENT BD. SOFFIT, FINISH AS SPECIFIED.

NOTE:  
FIELD LIGHTING QUANTITY AND SPACING SHOULD BE DETERMINED BY A/E OF RECORD.


## REFLECTED CEILING PLAN - GENERAL NOTES

- REFERENCE ARCHITECTURAL REFLECTED CEILING DRAWINGS FOR CONSTRUCTION LAYOUT OF SOFFITS AND TILE CEILINGS.
- SEE EQUIPMENT DRAWINGS FOR ADDITIONAL EQUIPMENT DRAWINGS (EQUIPMENT TO BE PROVIDED BY OTHERS).
- SEE MEP DRAWINGS FOR ADDITIONAL INFORMATION.
- DRAWINGS V102 AND V112 ARE TO BE REFERENCED FOR CEILING FINISH AND LIGHT FIXTURES ONLY.
- ALL ACT TILE CEILINGS ARE TO BE CENTERED WITH IN ROOM UNLESS OTHERWISE NOTED. SEE A200 AND A201 FOR ADDITIONAL INFORMATION.
- 3/V112 AND 5/V112 DETAILS ON V112 ARE FOR FINISH AND INTERMEDIATE MEMBER LOCATIONS ONLY. SEE A203 FOR CONSTRUCTION DETAILS.

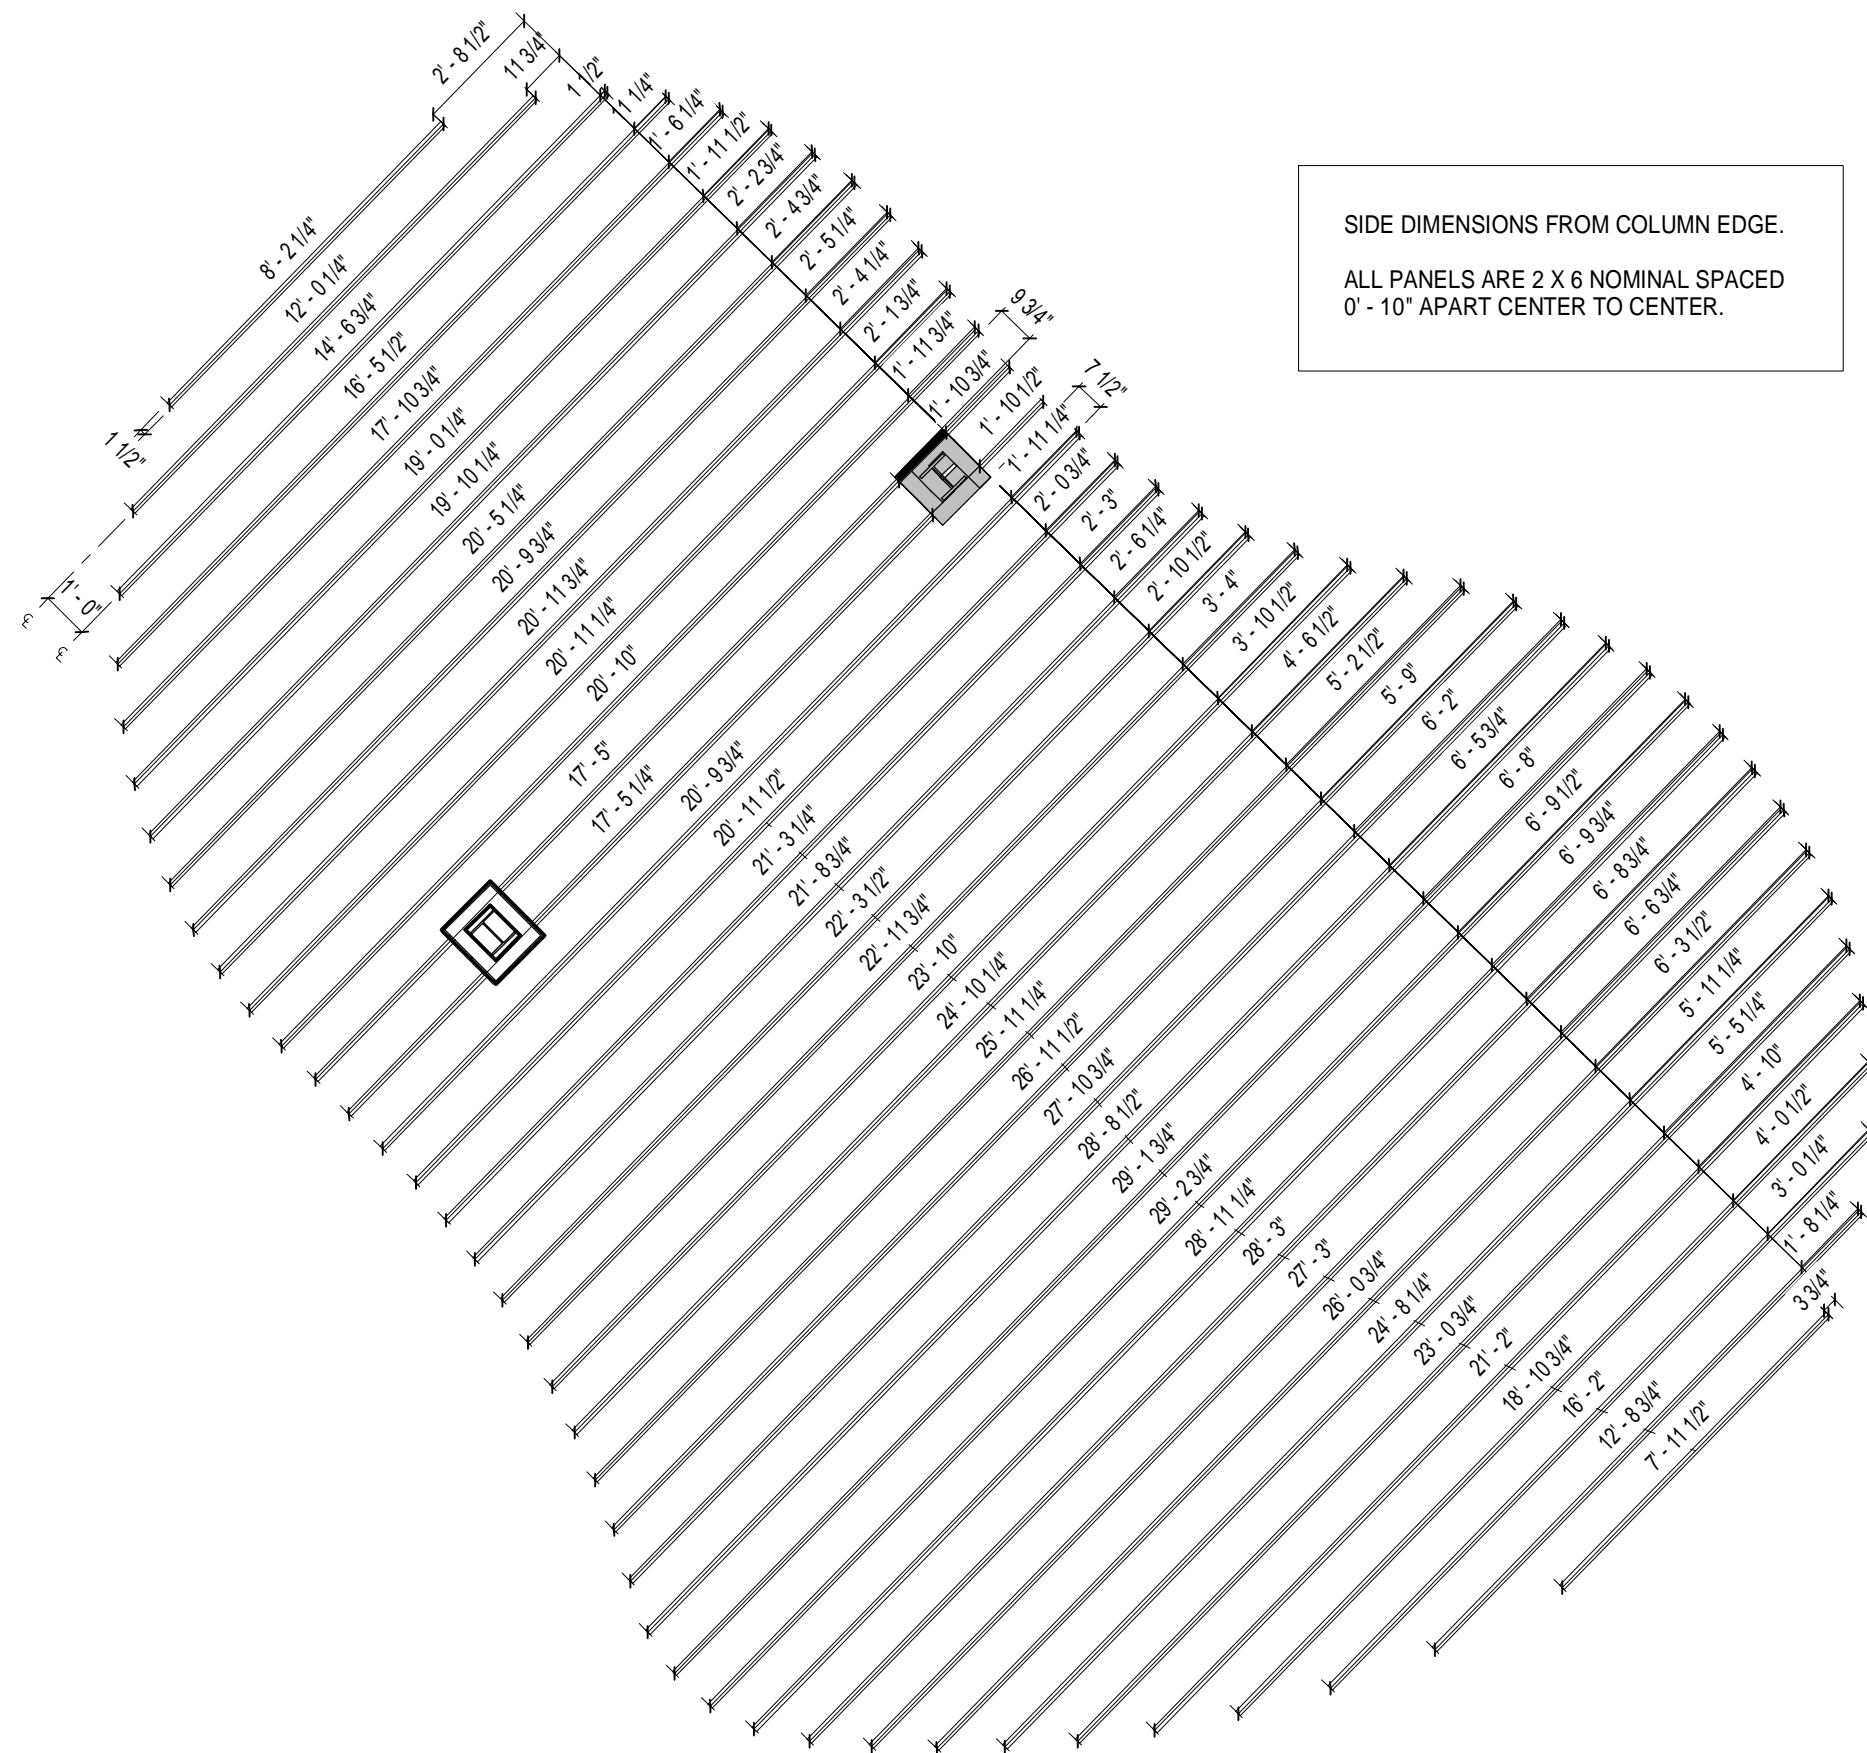


## 2 CEILING FEATURE DETAIL

1/4" = 1'-0"

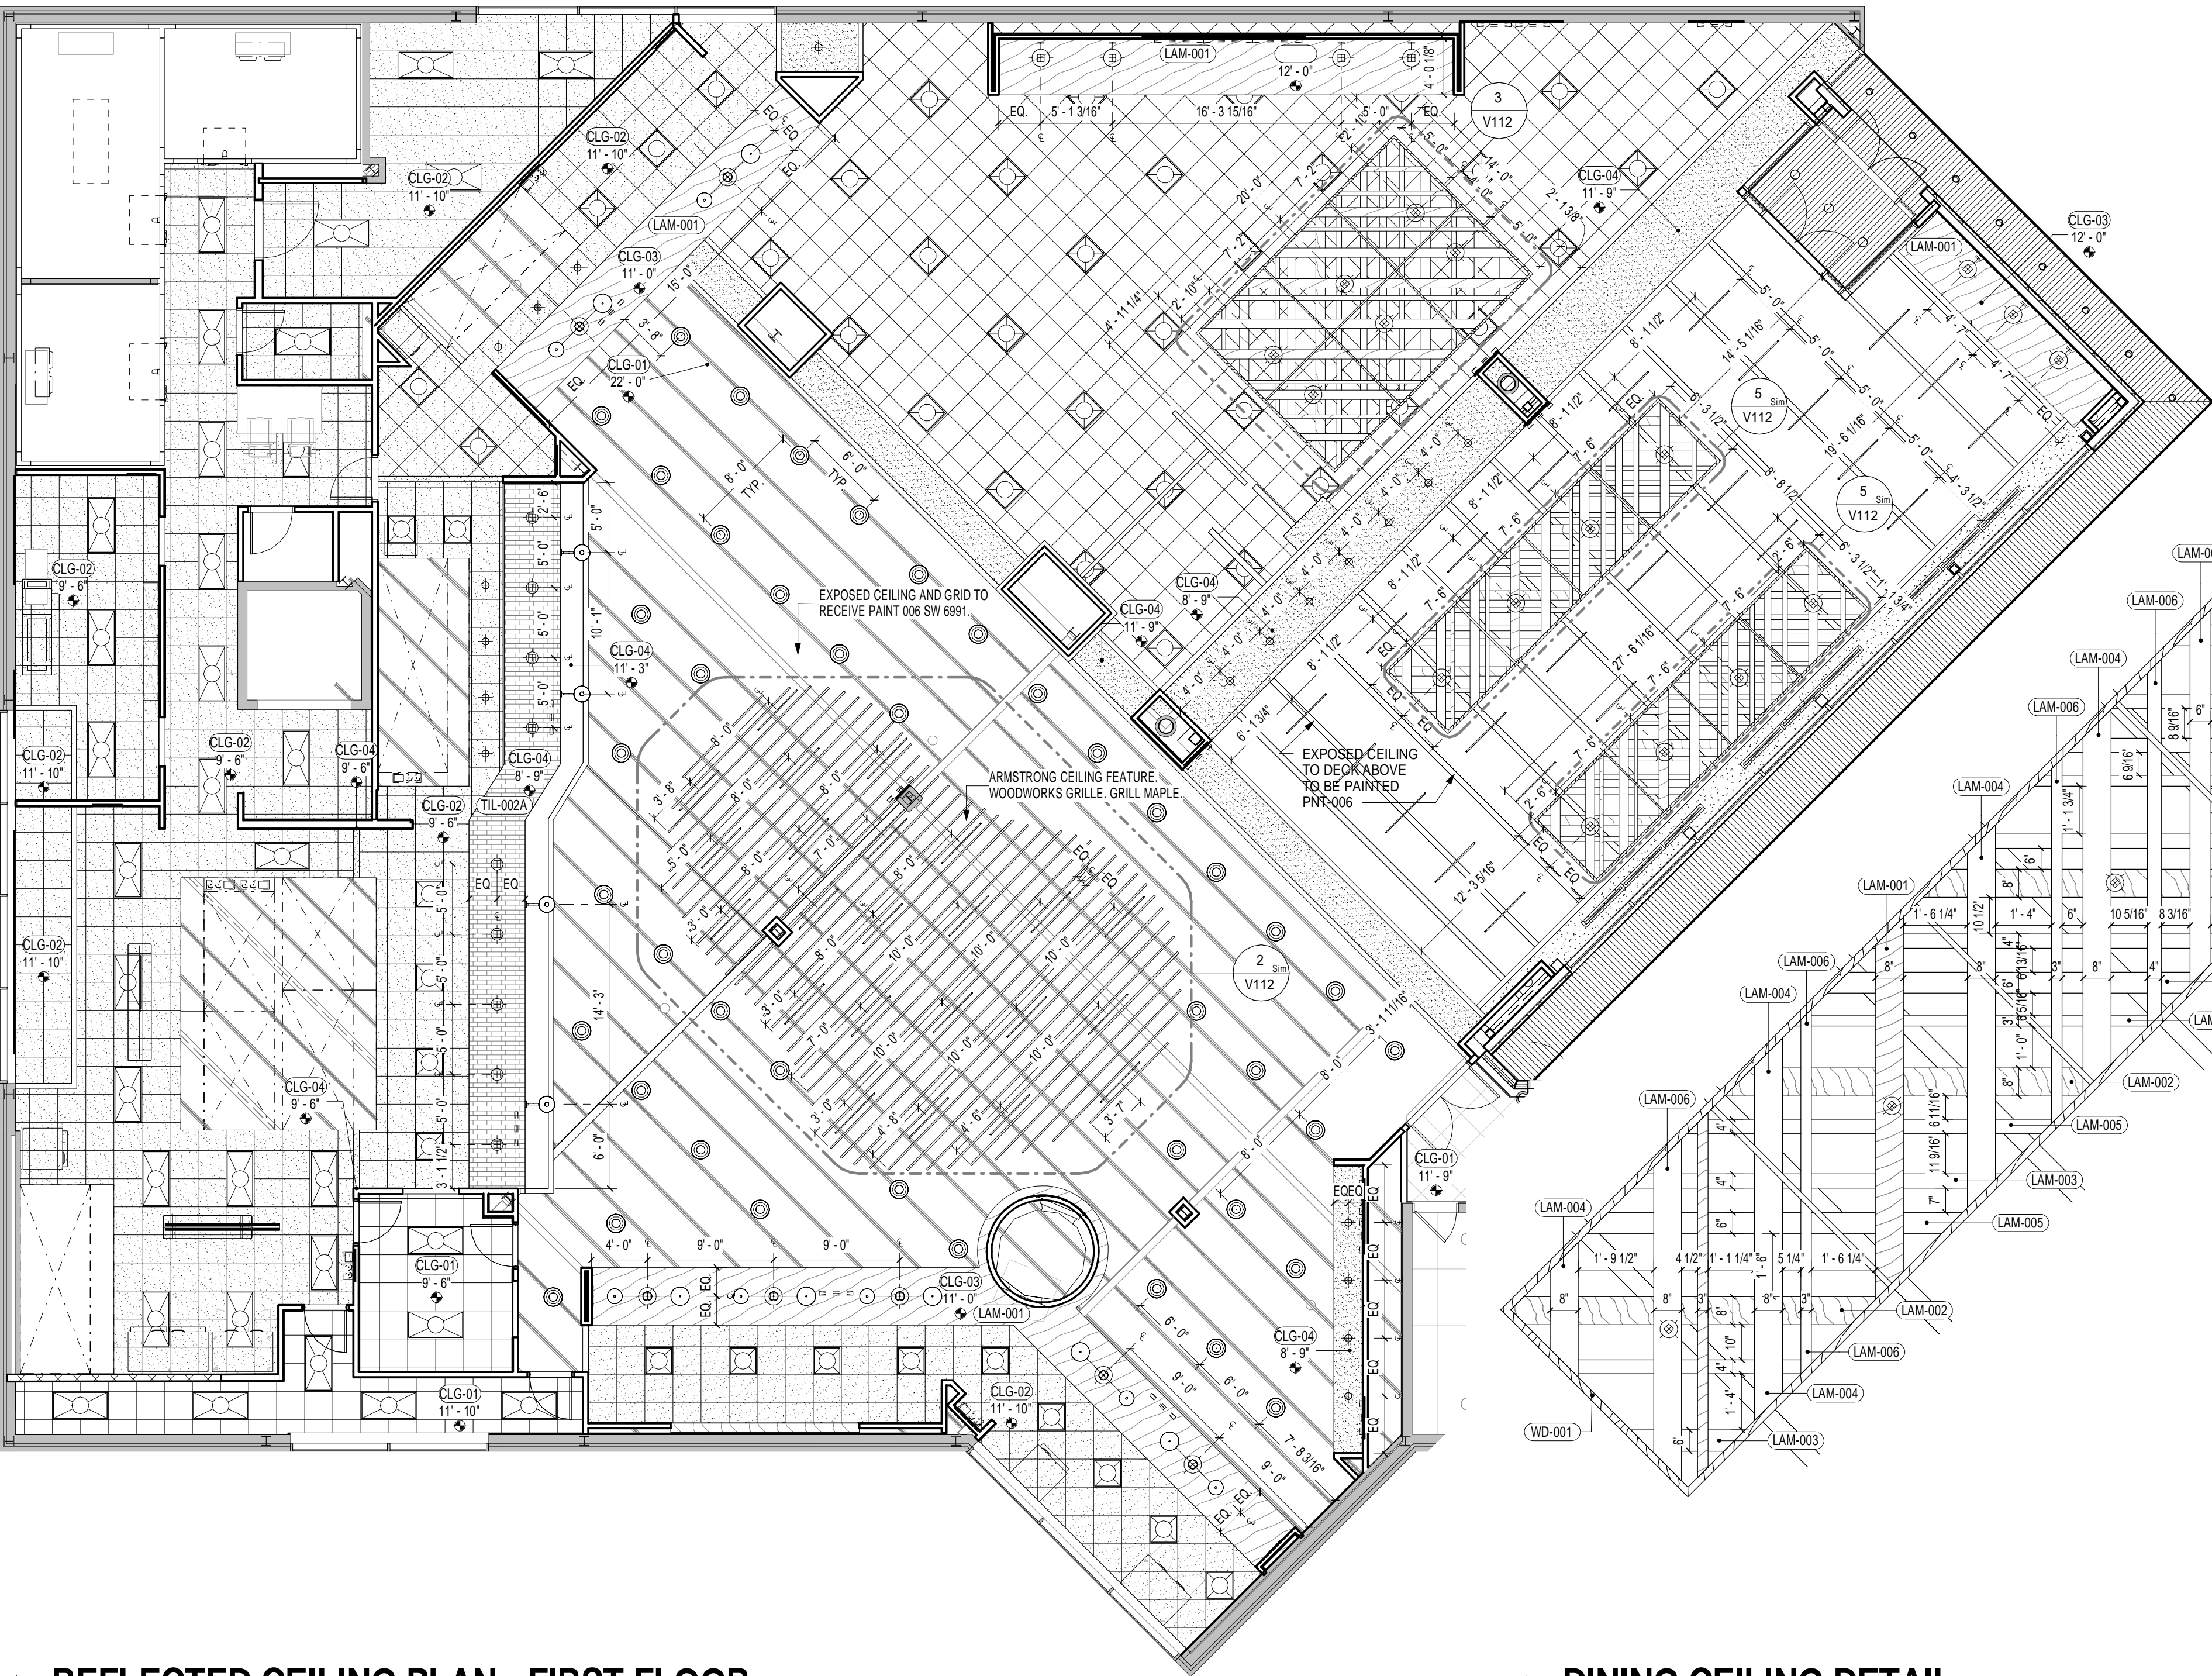


## 1 REFLECTED CEILING PLAN - FIRST FLOOR

1/8" = 1'-0"

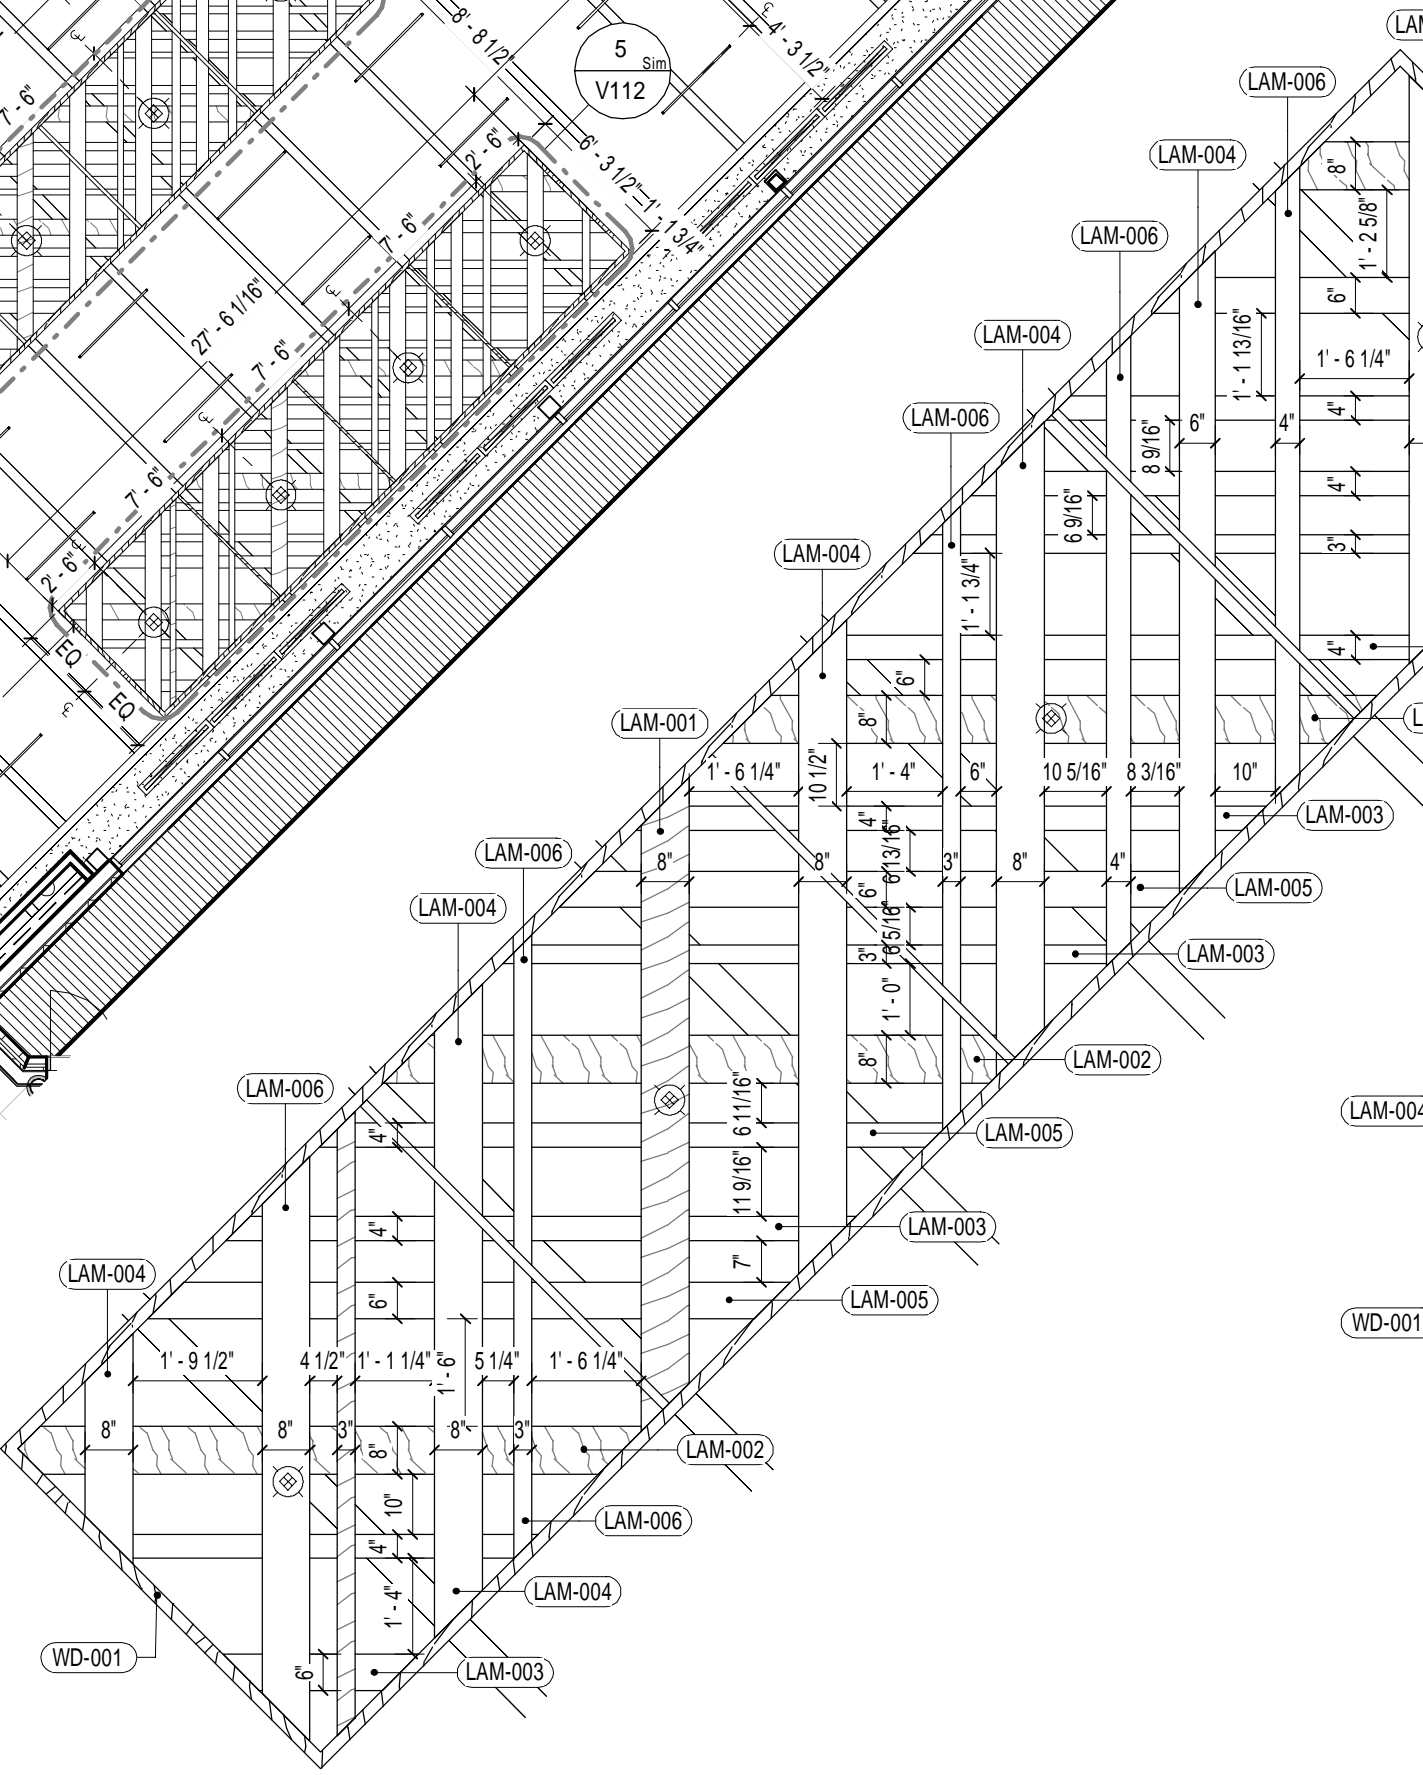

## 5 DINING CEILING DETAIL

3/8" = 1'-0"

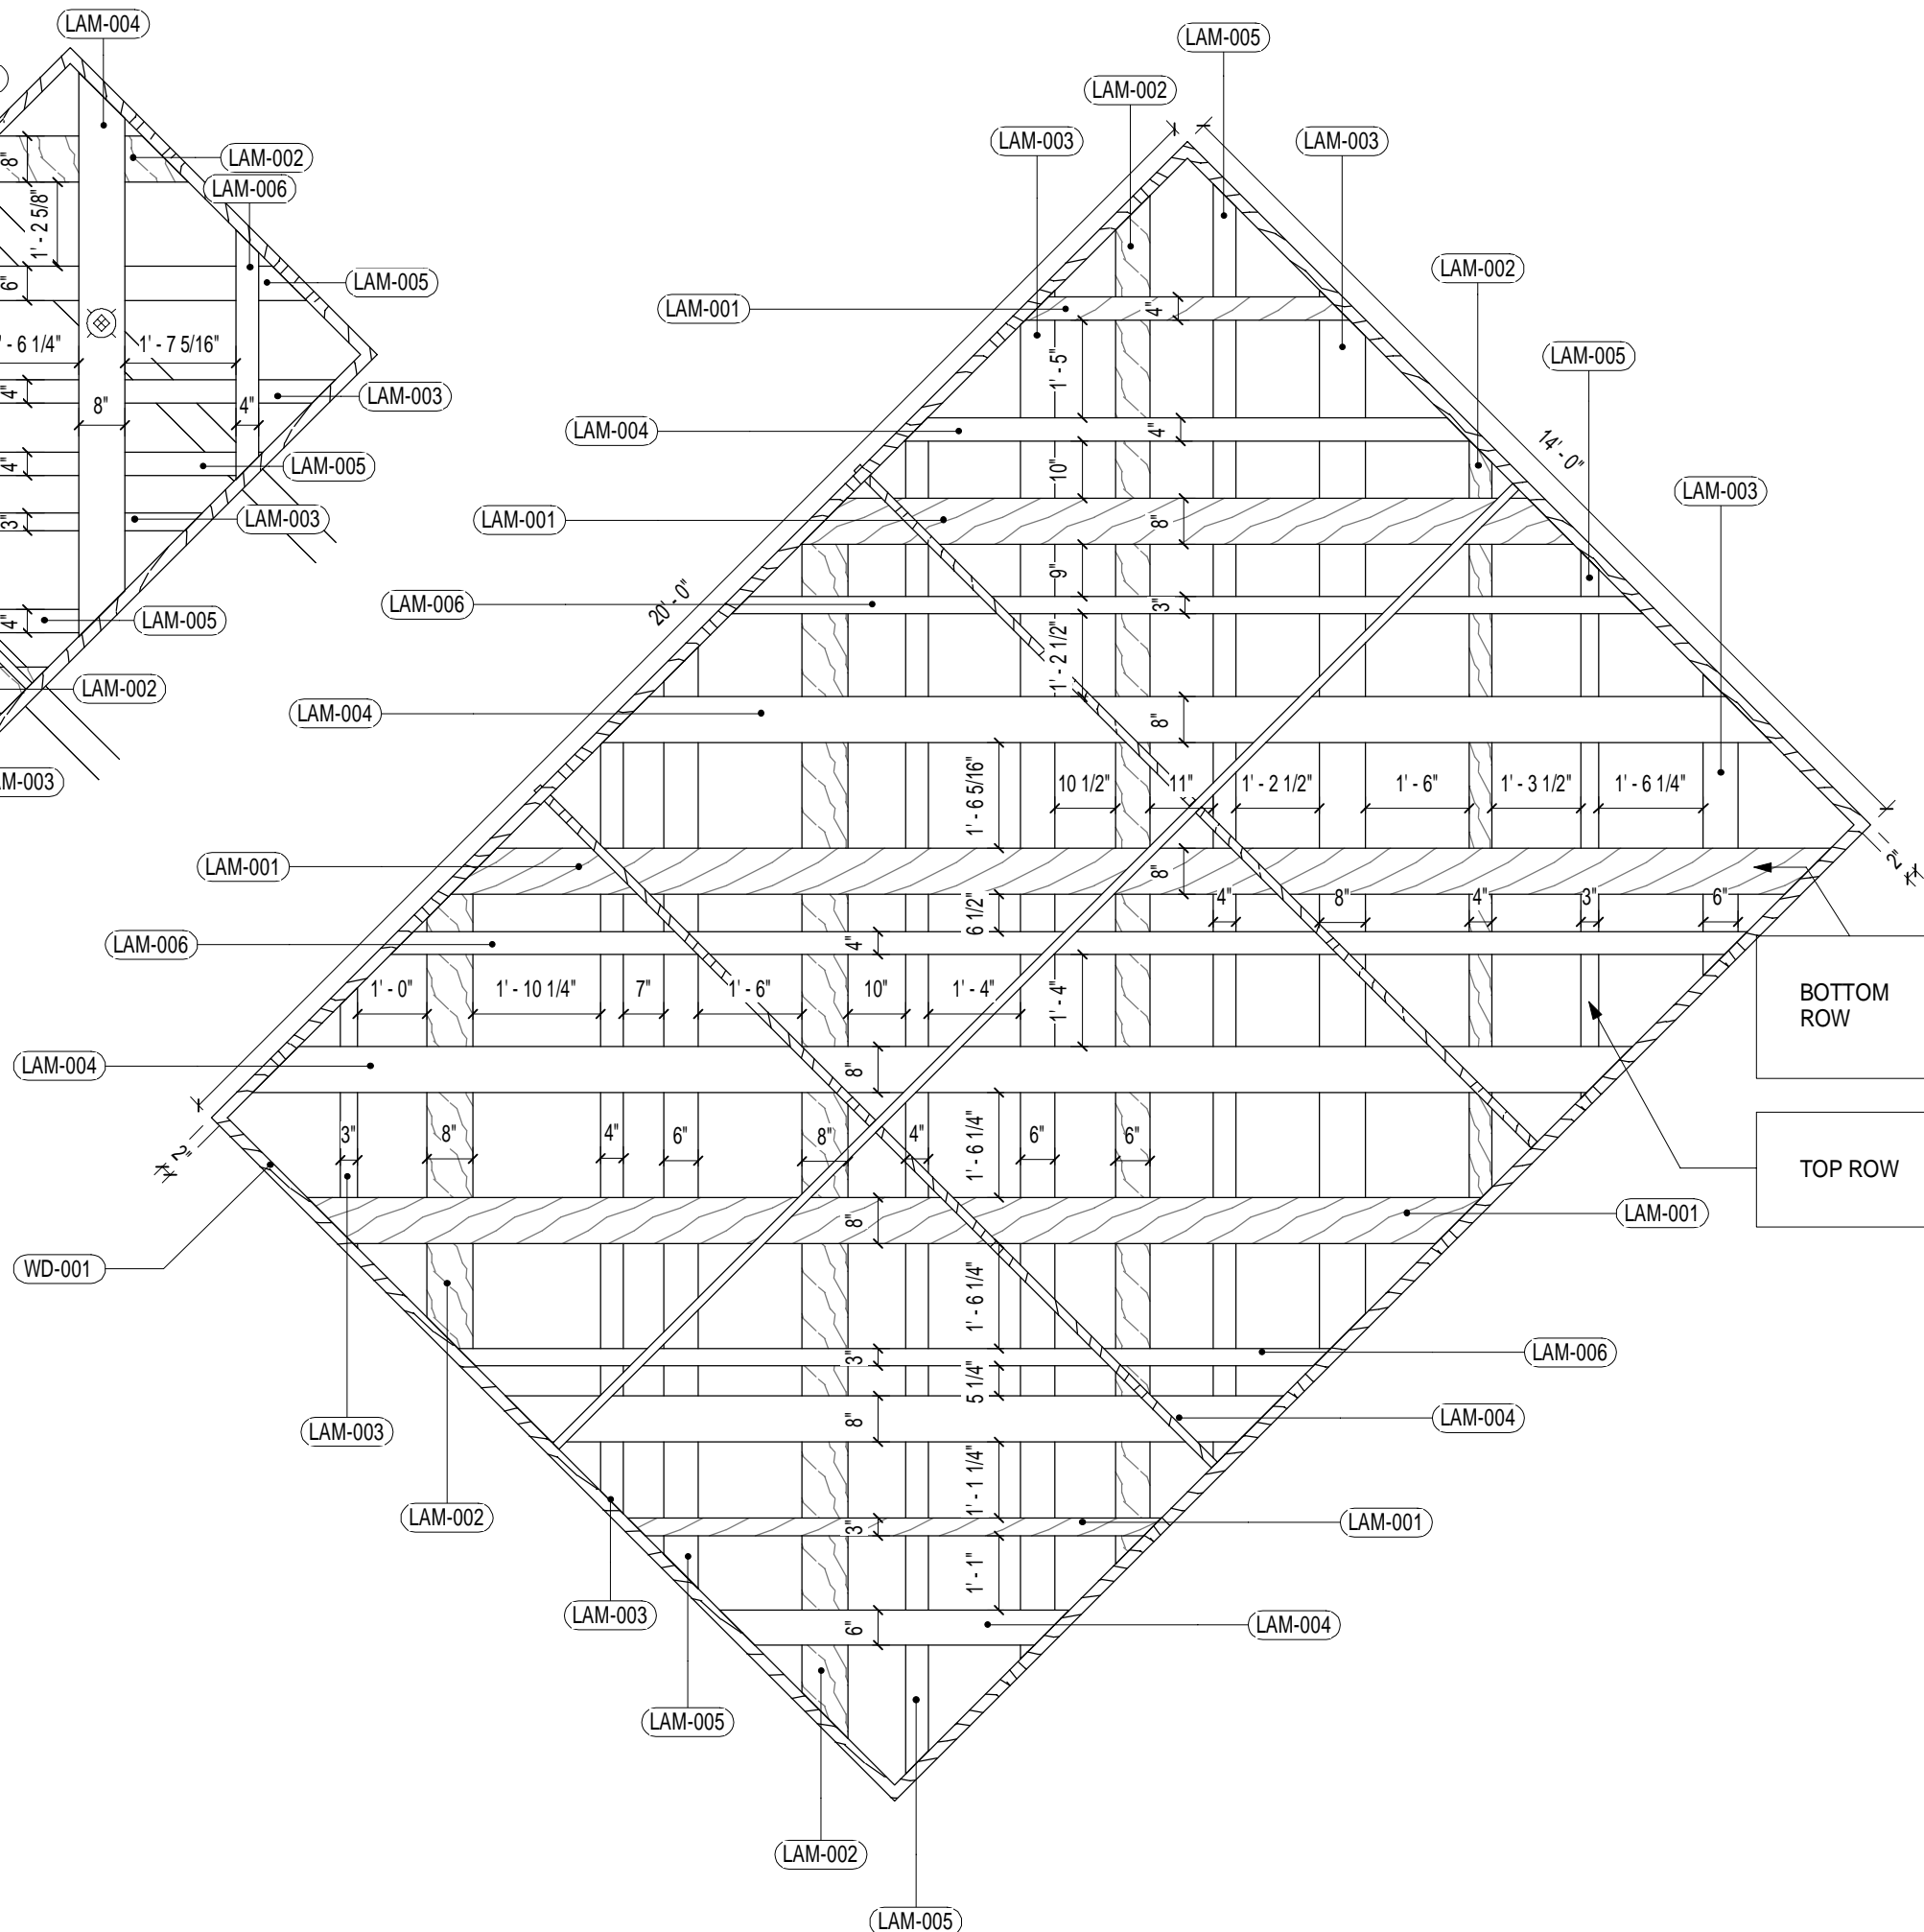

## 3 LOUNGE CEILING DETAIL

3/8" = 1'-0"

REVISIONS	
NO.	DATE
DESCRIPTION	

SEAL:

BOTTOM ROW  
TOP ROW

ISSUED FOR: BID  
ISSUED DATE: 02/16/2018  
DRAWN BY: JW  
CHECKED BY: CM  
PROJECT NUMBER: CW-0205.4


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DRAWING NAME:

REFLECTED  
CEILING PLAN -  
FIRST FLOOR

DRAWING NO.

V112



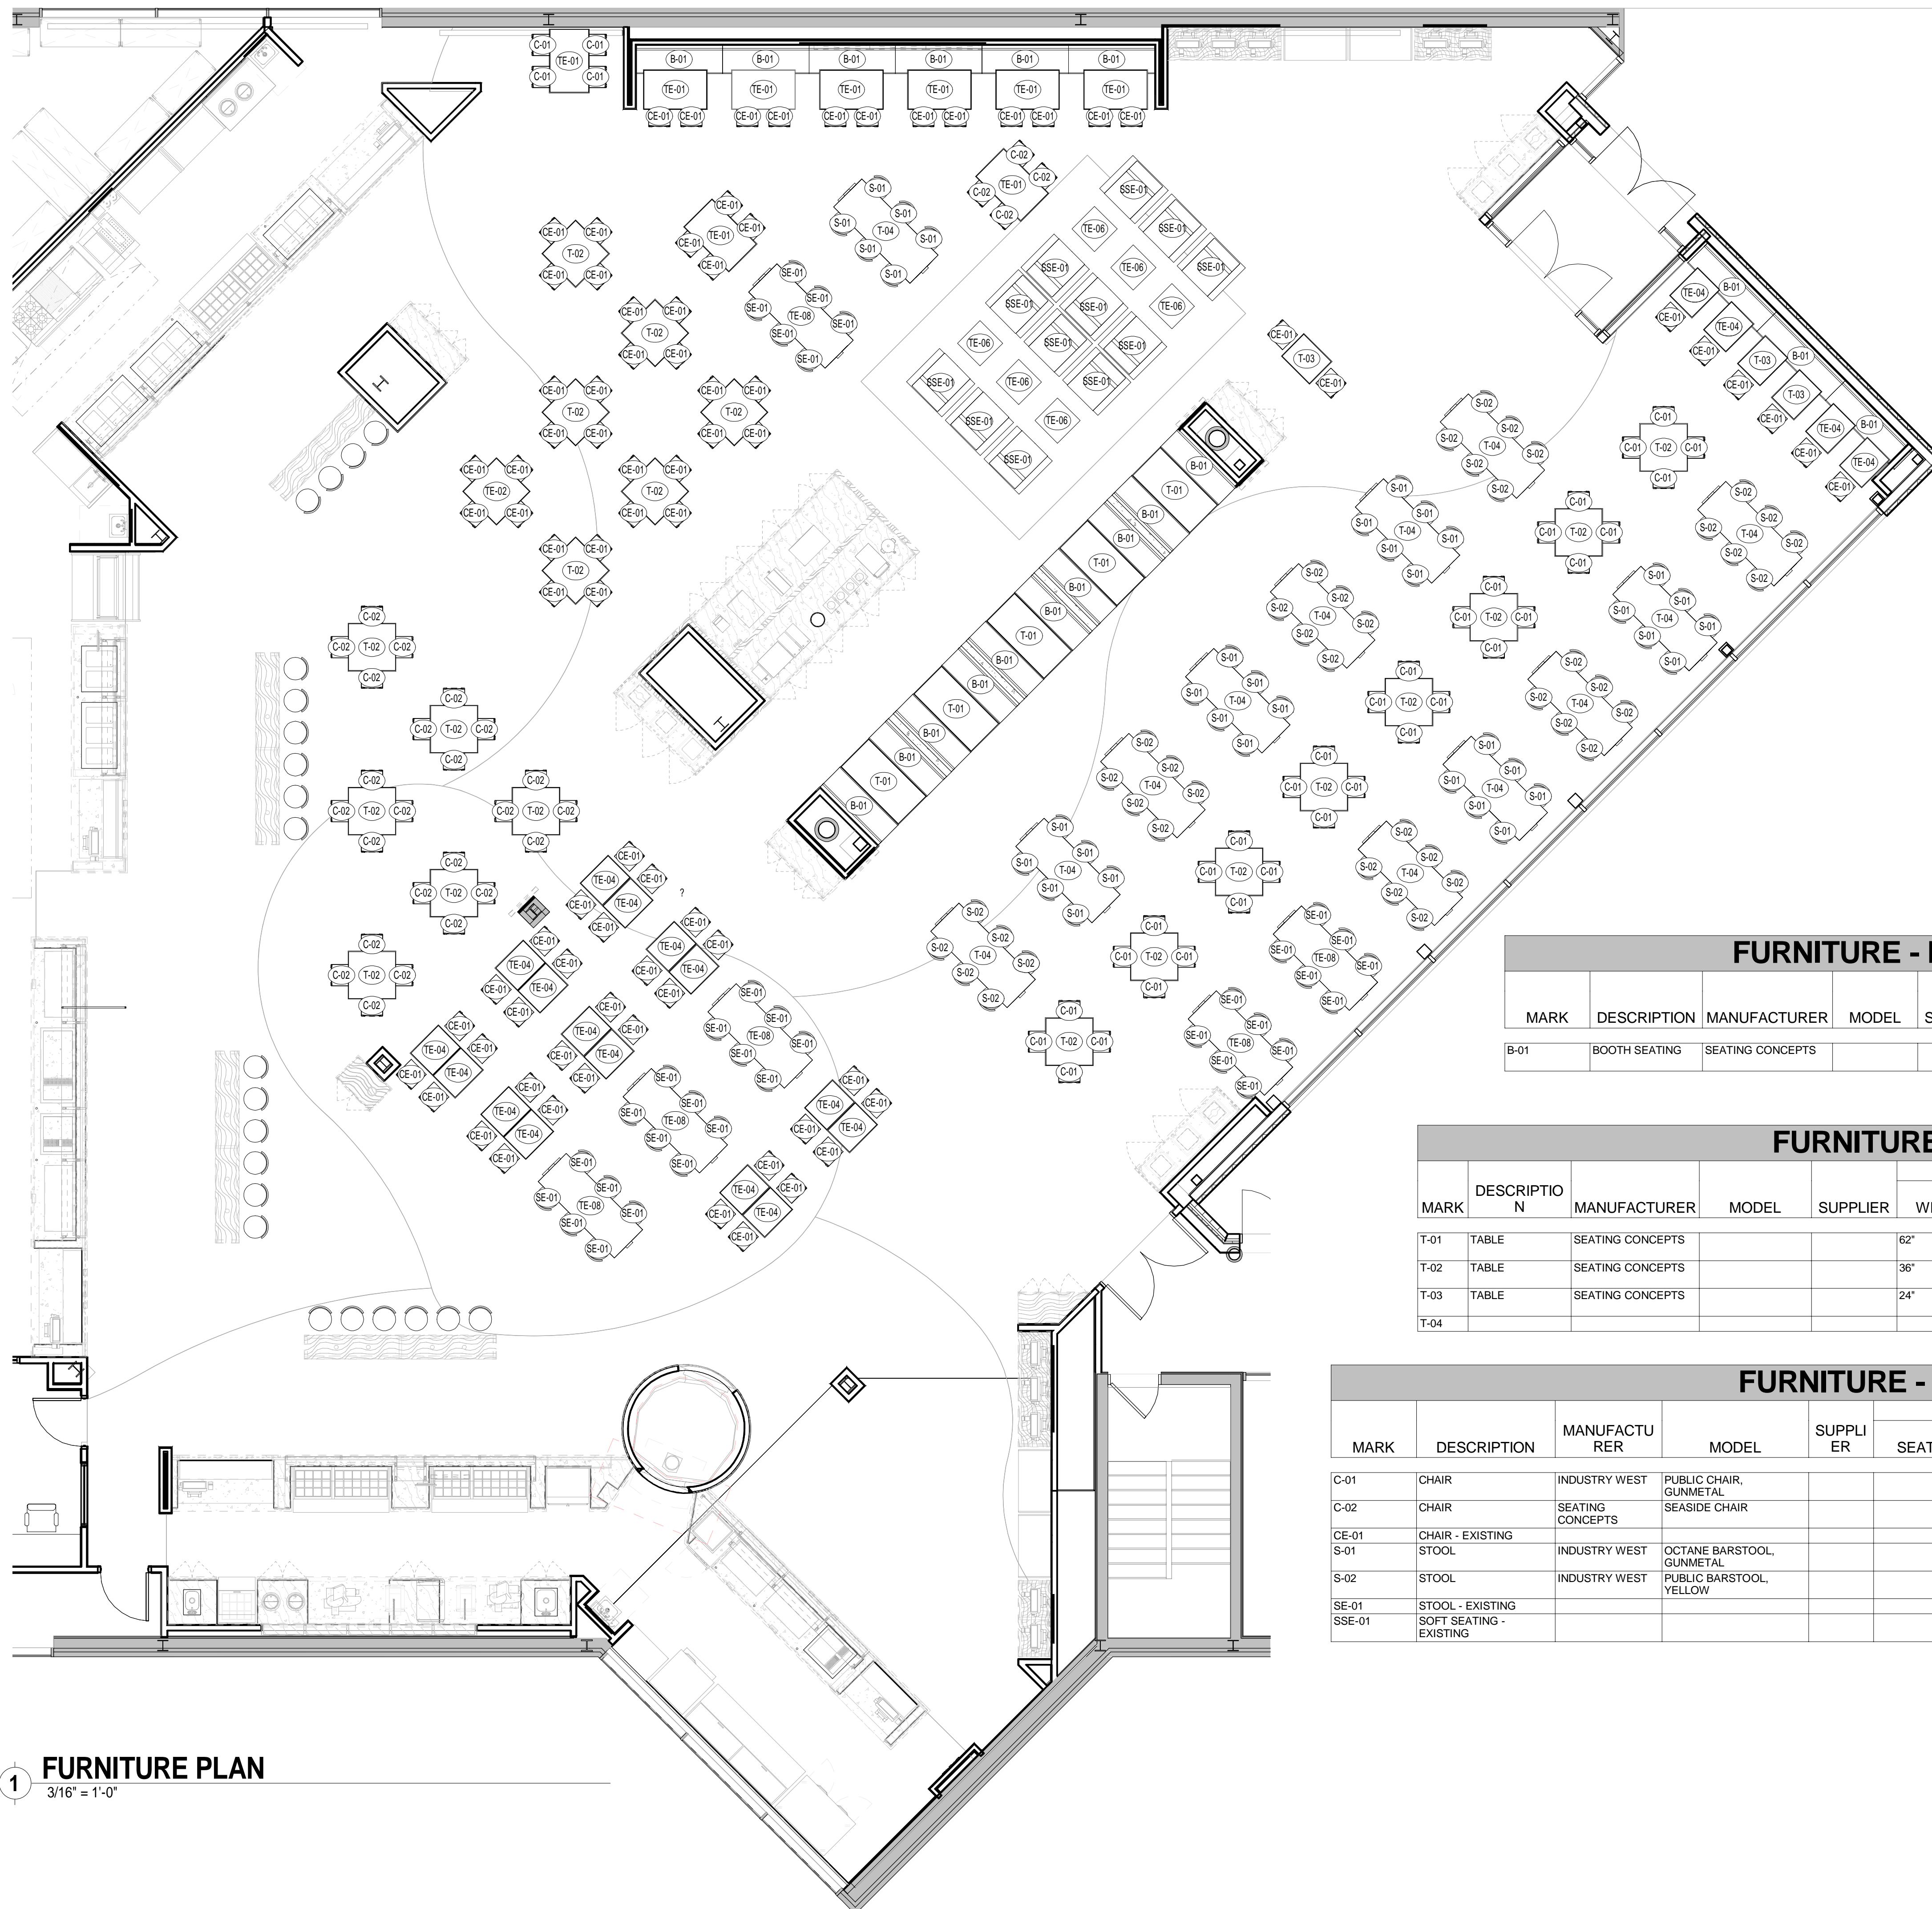






XX ◀ ITEM NUMBER  
0' 0" x 0' 0" ◀ CUTOUT SIZE









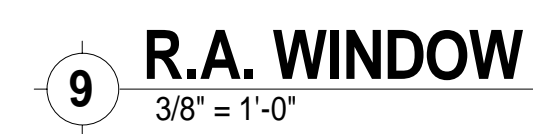




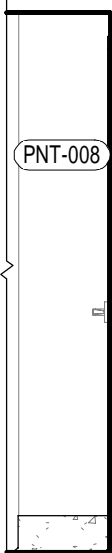


**2 CORRIDOR B**  
3/8" = 1'-0"

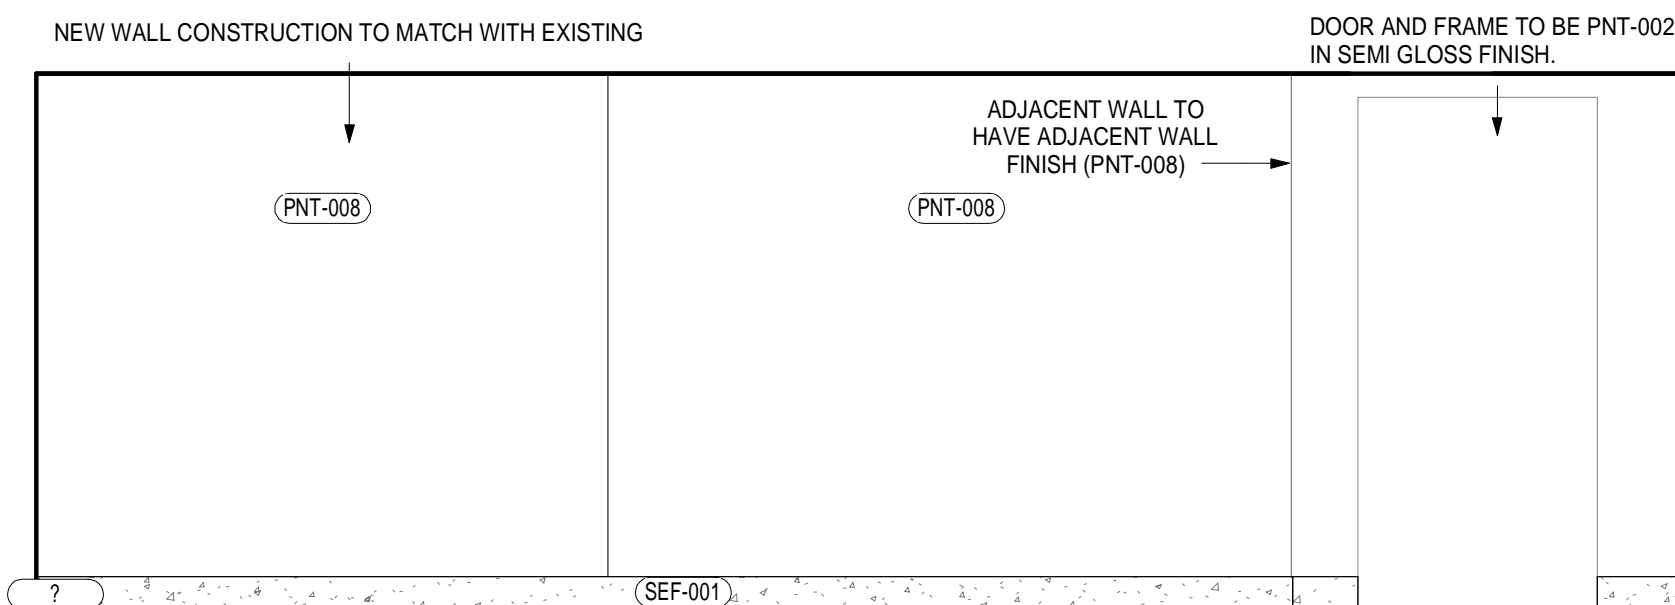


**3 CORRIDOR C**  
3/8" = 1'-0"

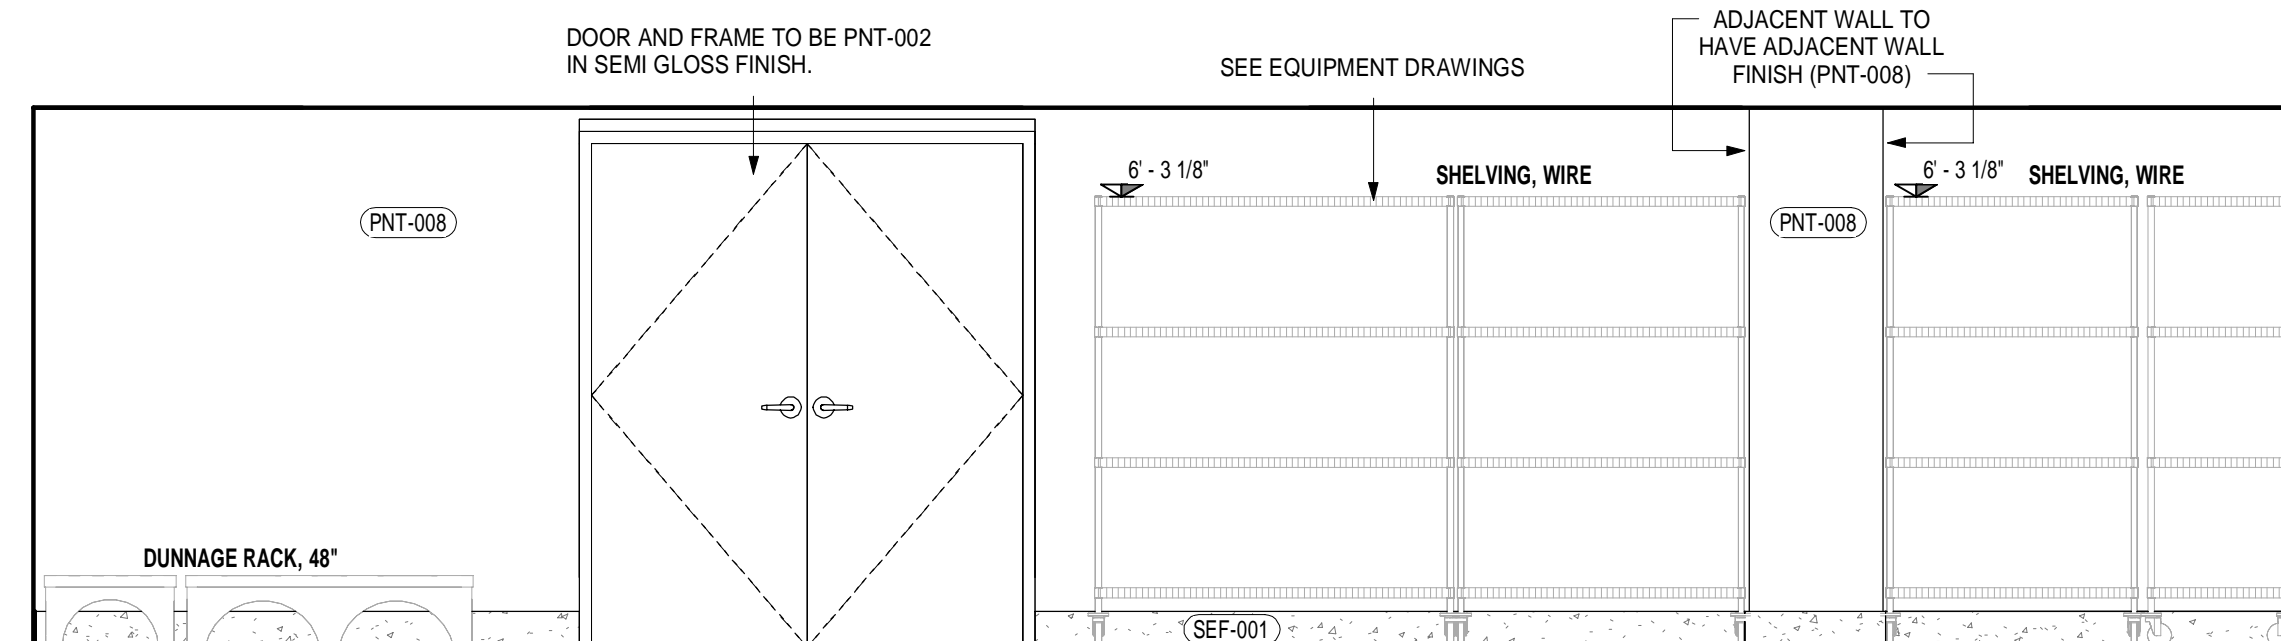


**4 DRY STORAGE B A**  
3/8" = 1'-0"

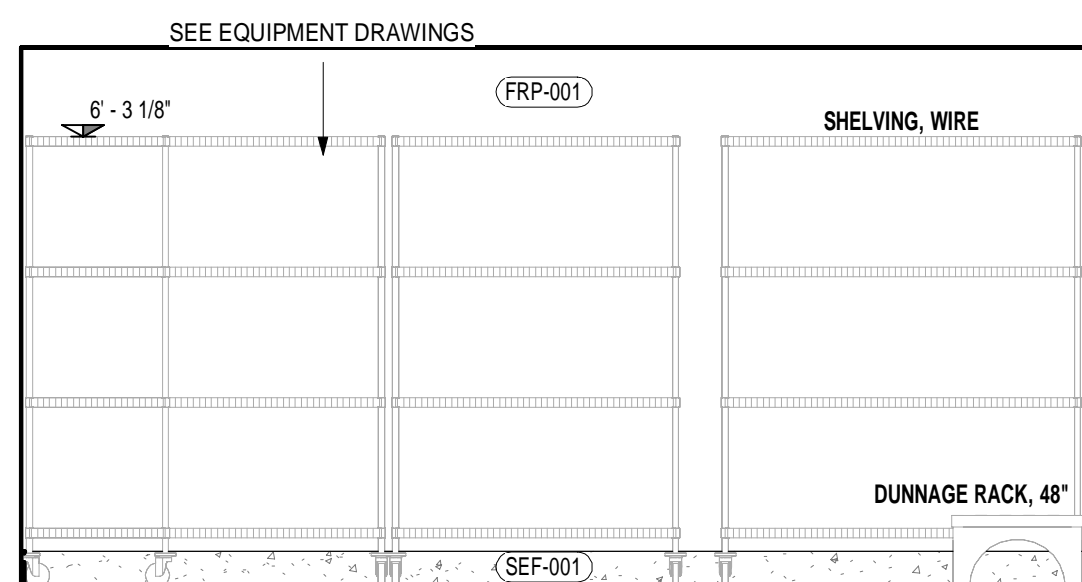


**5 DRY STORAGE B B**  
3/8" = 1'-0"

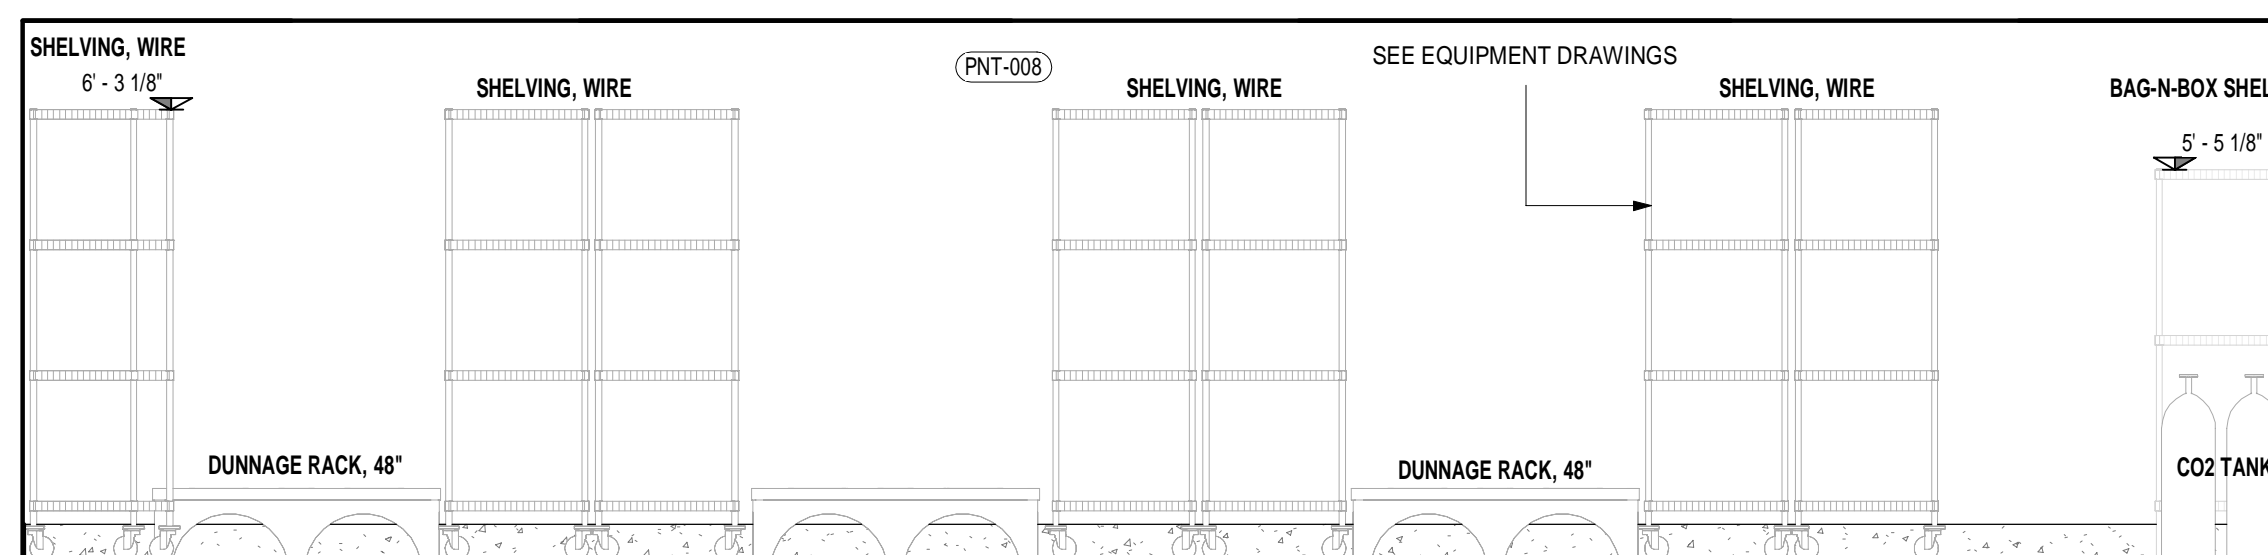


**6 DRY STORAGE B C**  
3/8" = 1'-0"

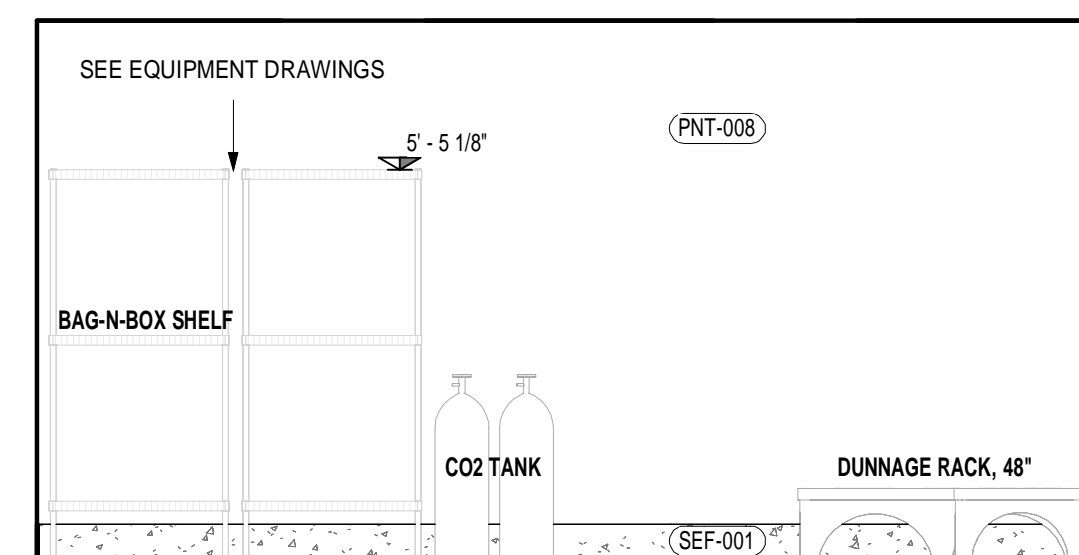


**7 DRY STORAGE B D**  
3/8" = 1'-0"

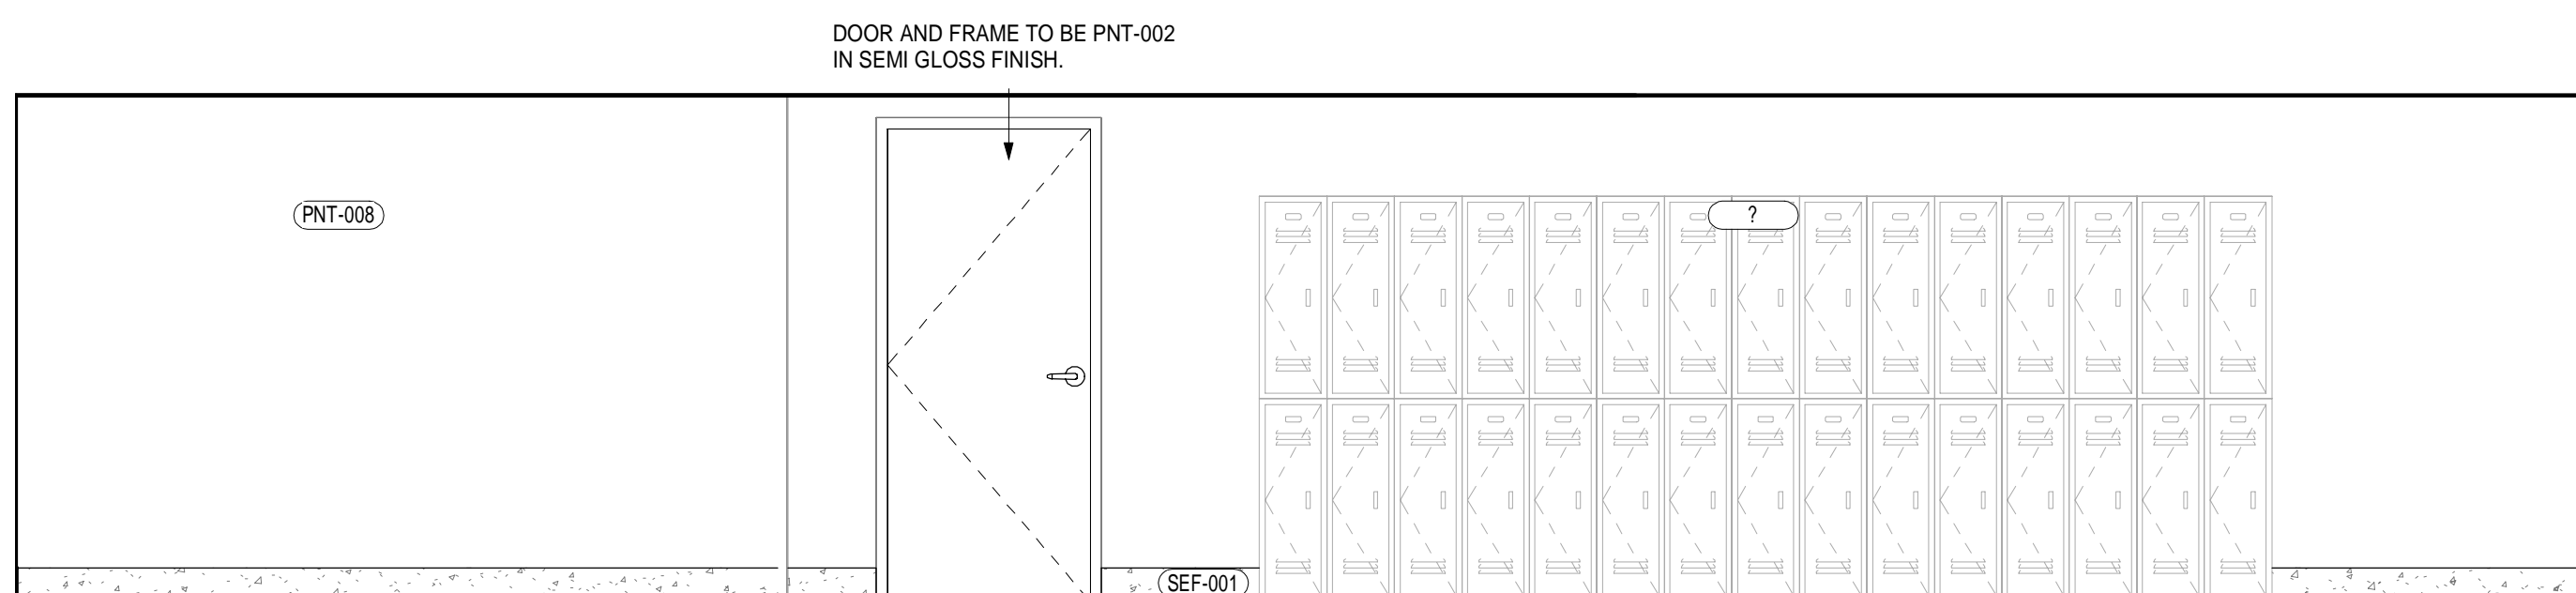


**8 BASEMENT STORAGE A**  
3/8" = 1'-0"

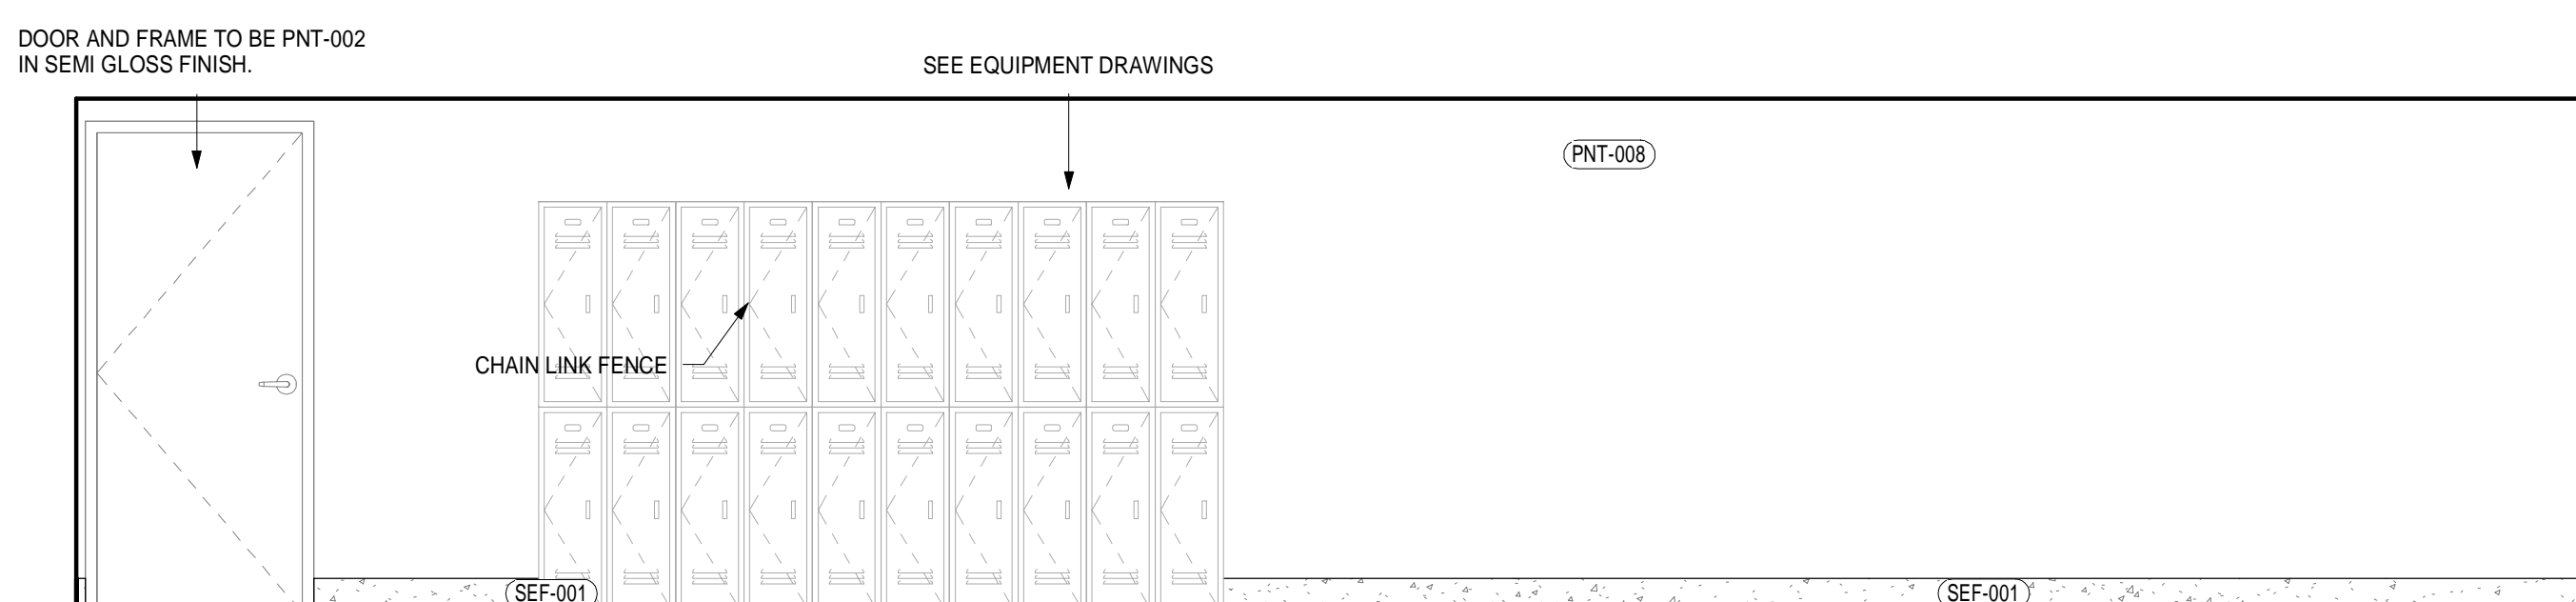

**9 BASEMENT STORAGE B**  
3/8" = 1'-0"


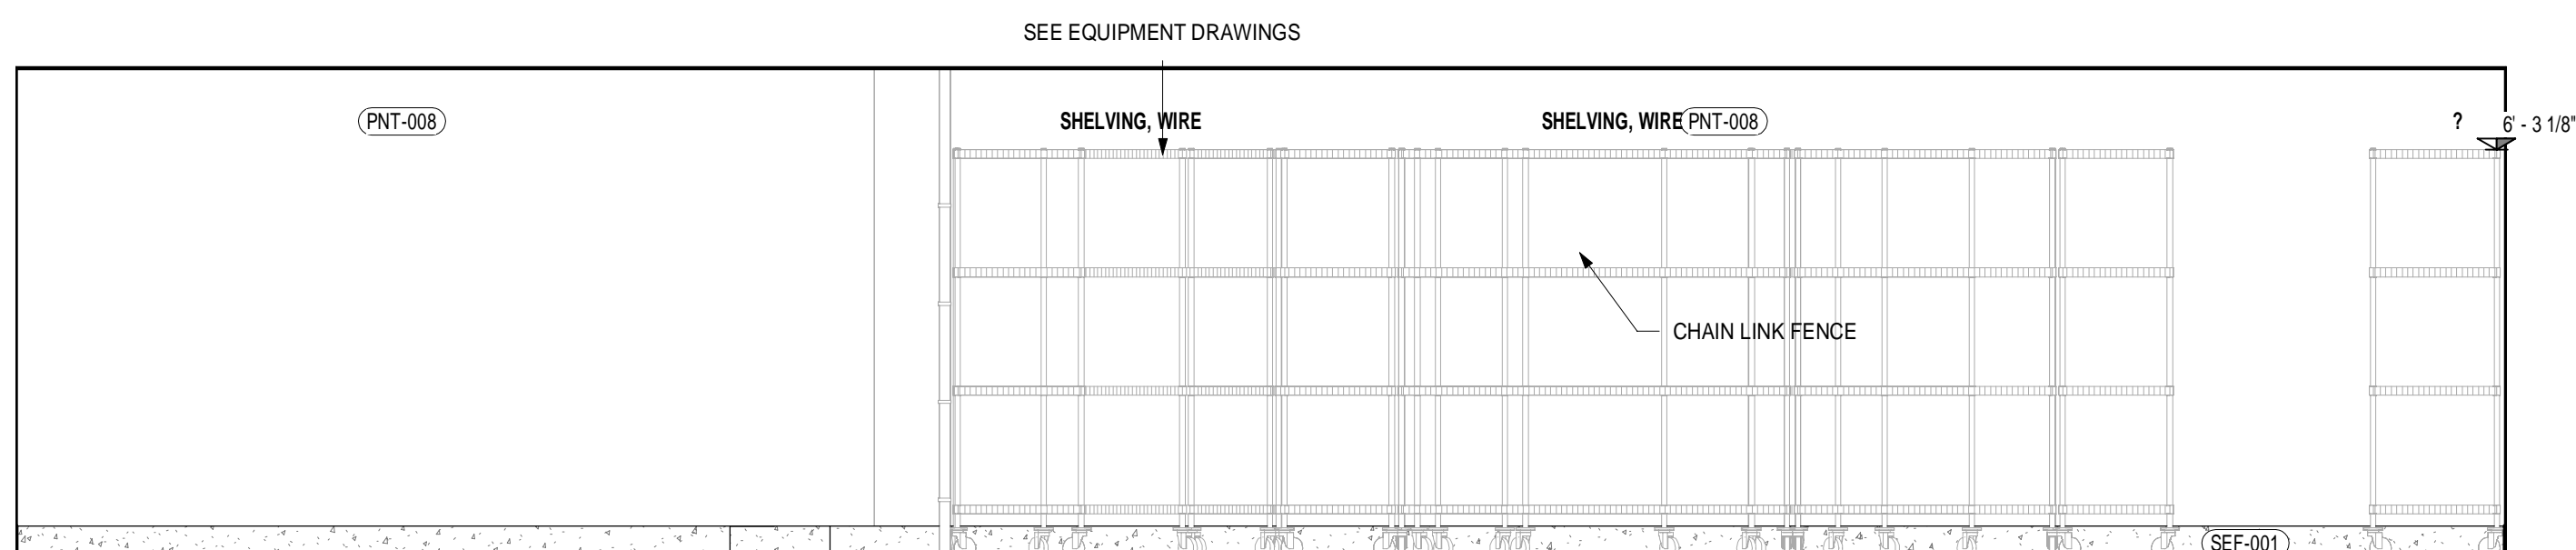


**10 BASEMENT STORAGE C**  
3/8" = 1'-0"




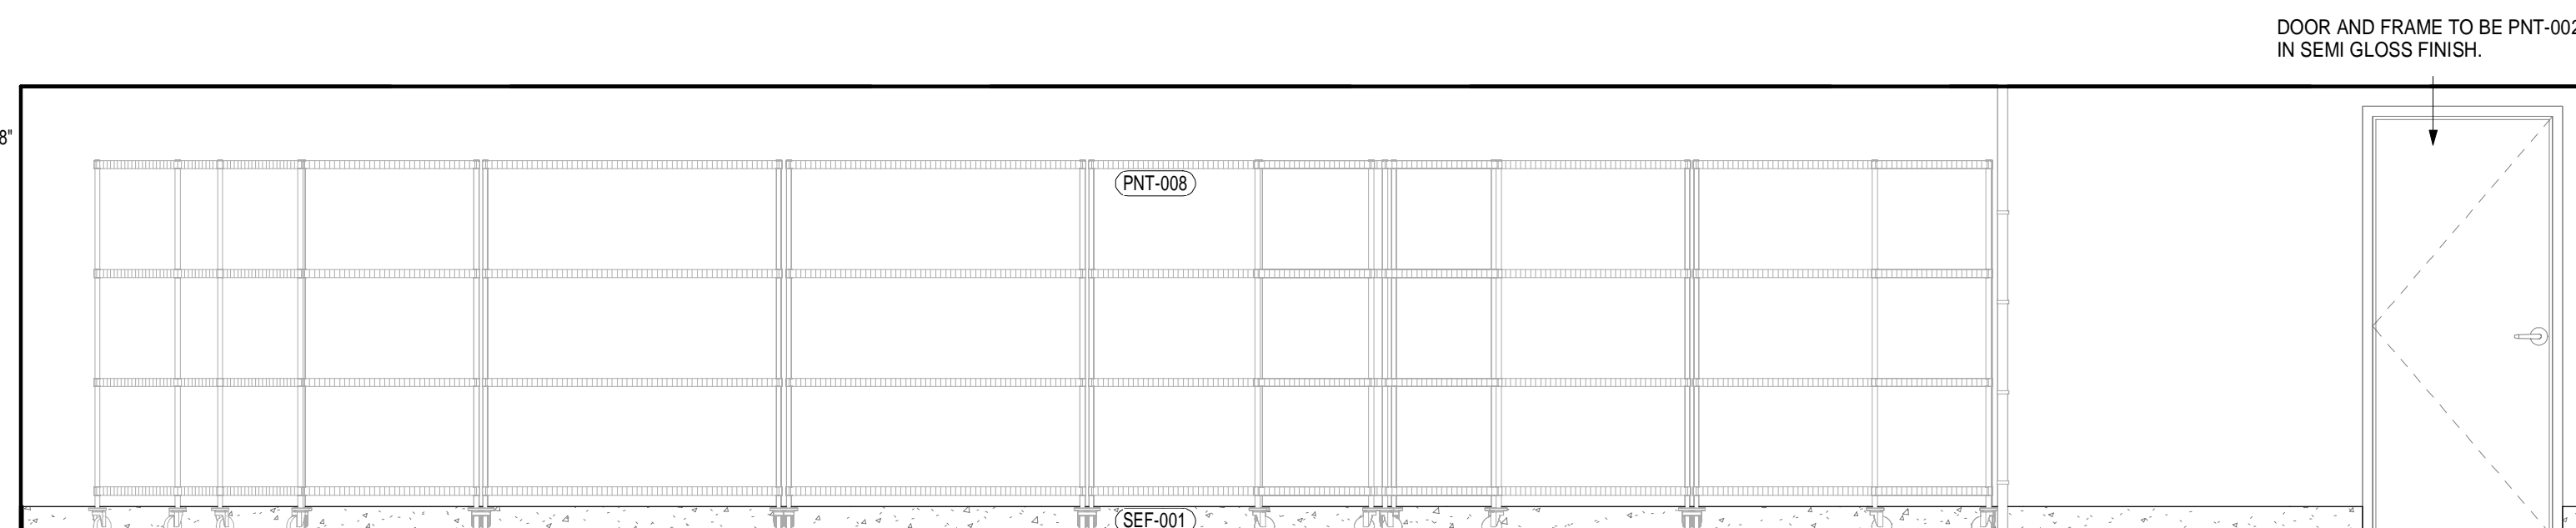


**11 BASEMENT STORAGE D**  
3/8" = 1'-0"






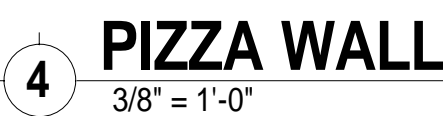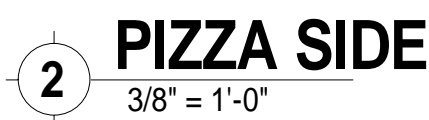






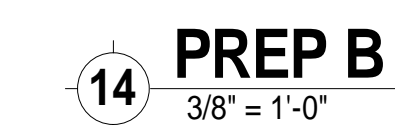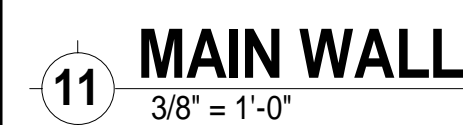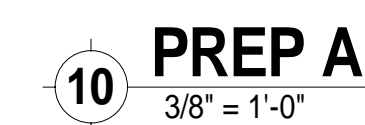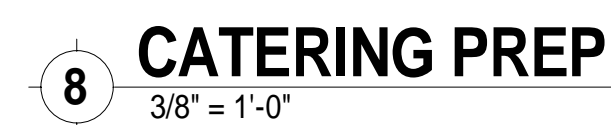



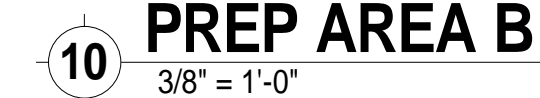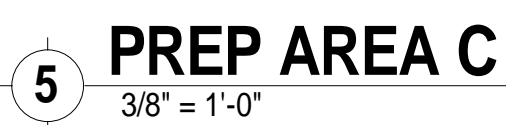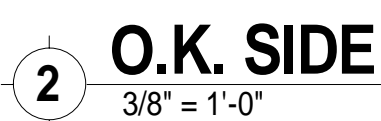





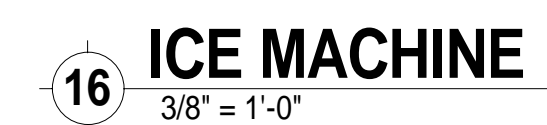
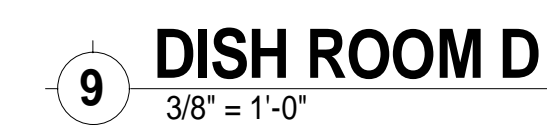
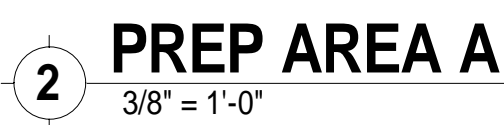


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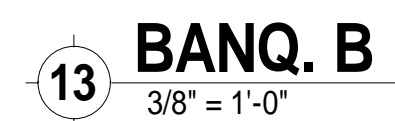
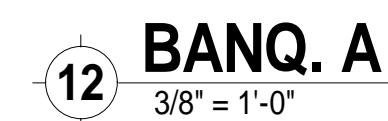
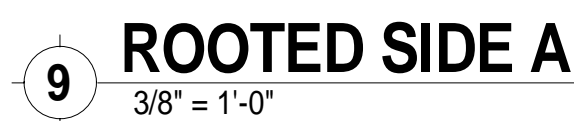
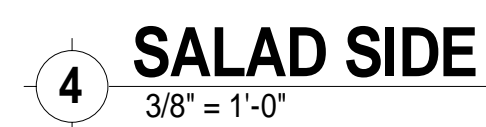
## INTERIOR ELEVATIONS VI

V313





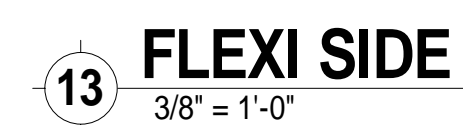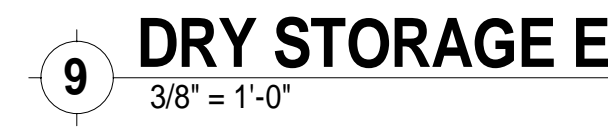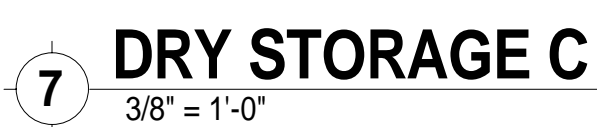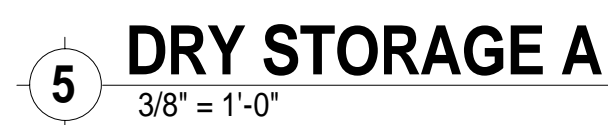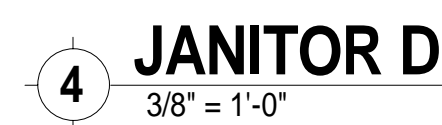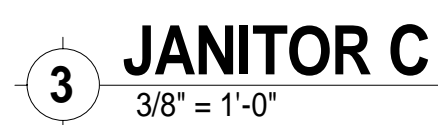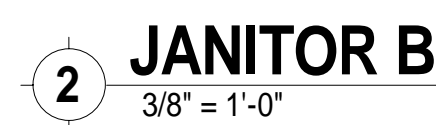











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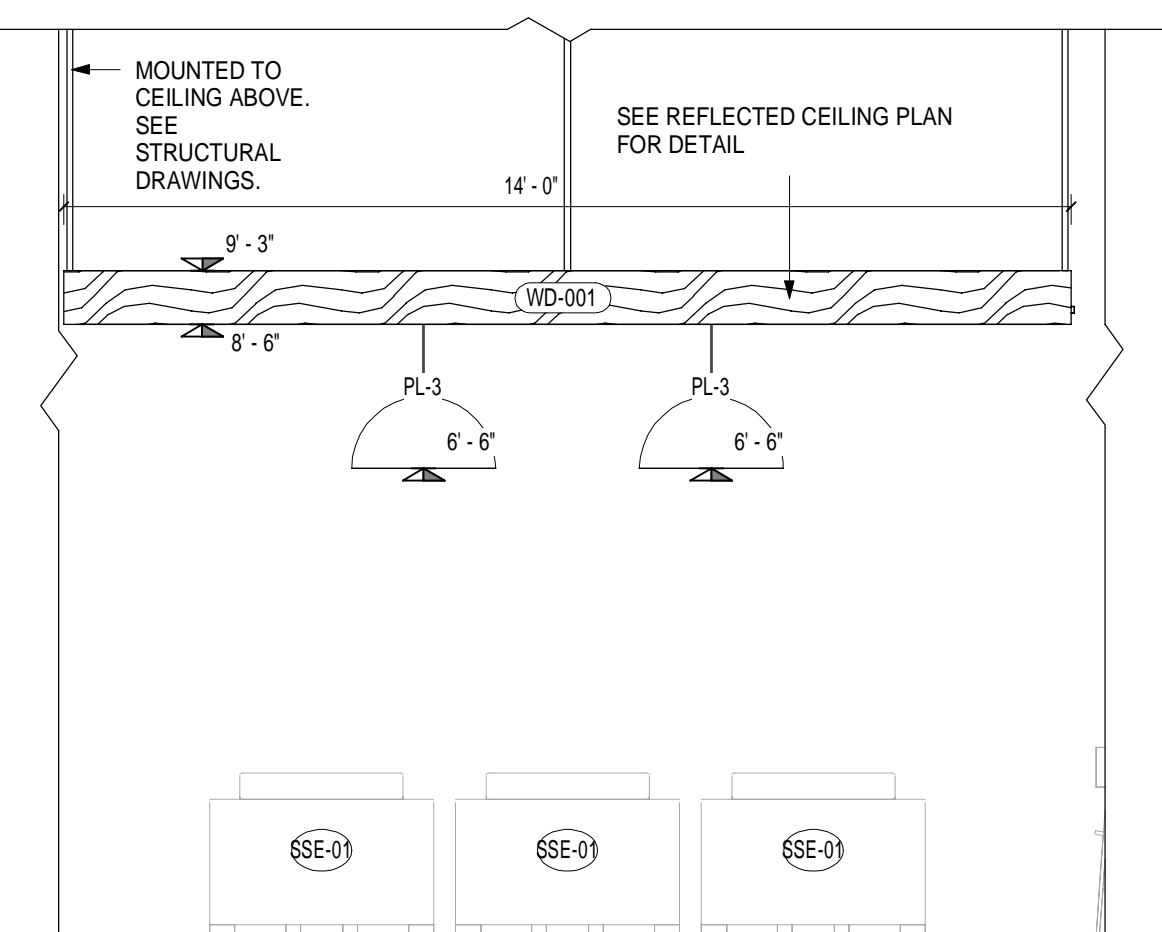


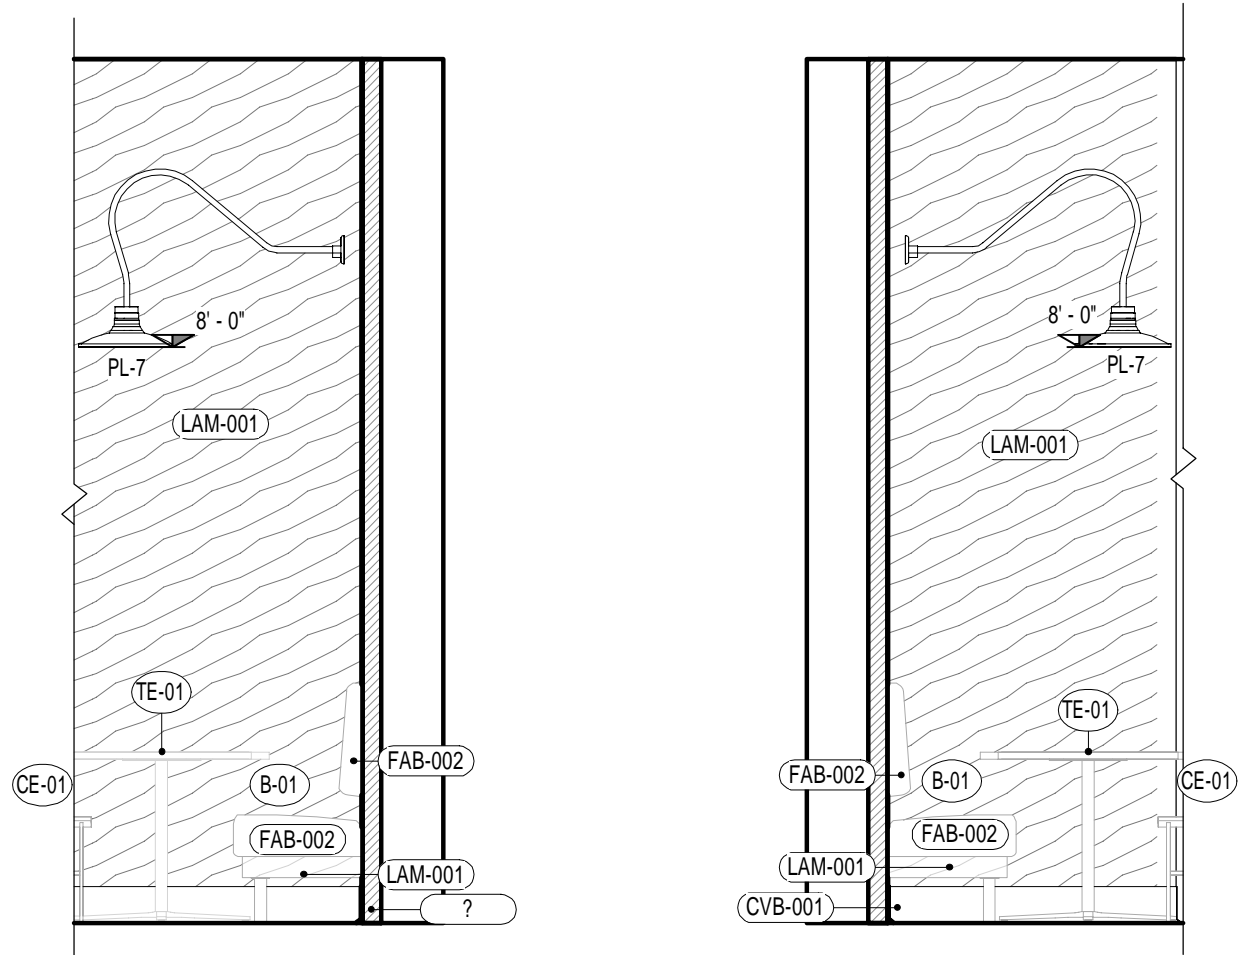1 **BANQUETTE A**  
3/8" = 1'-0"


2 **BANQUETTE B**  
3/8" = 1'-0"

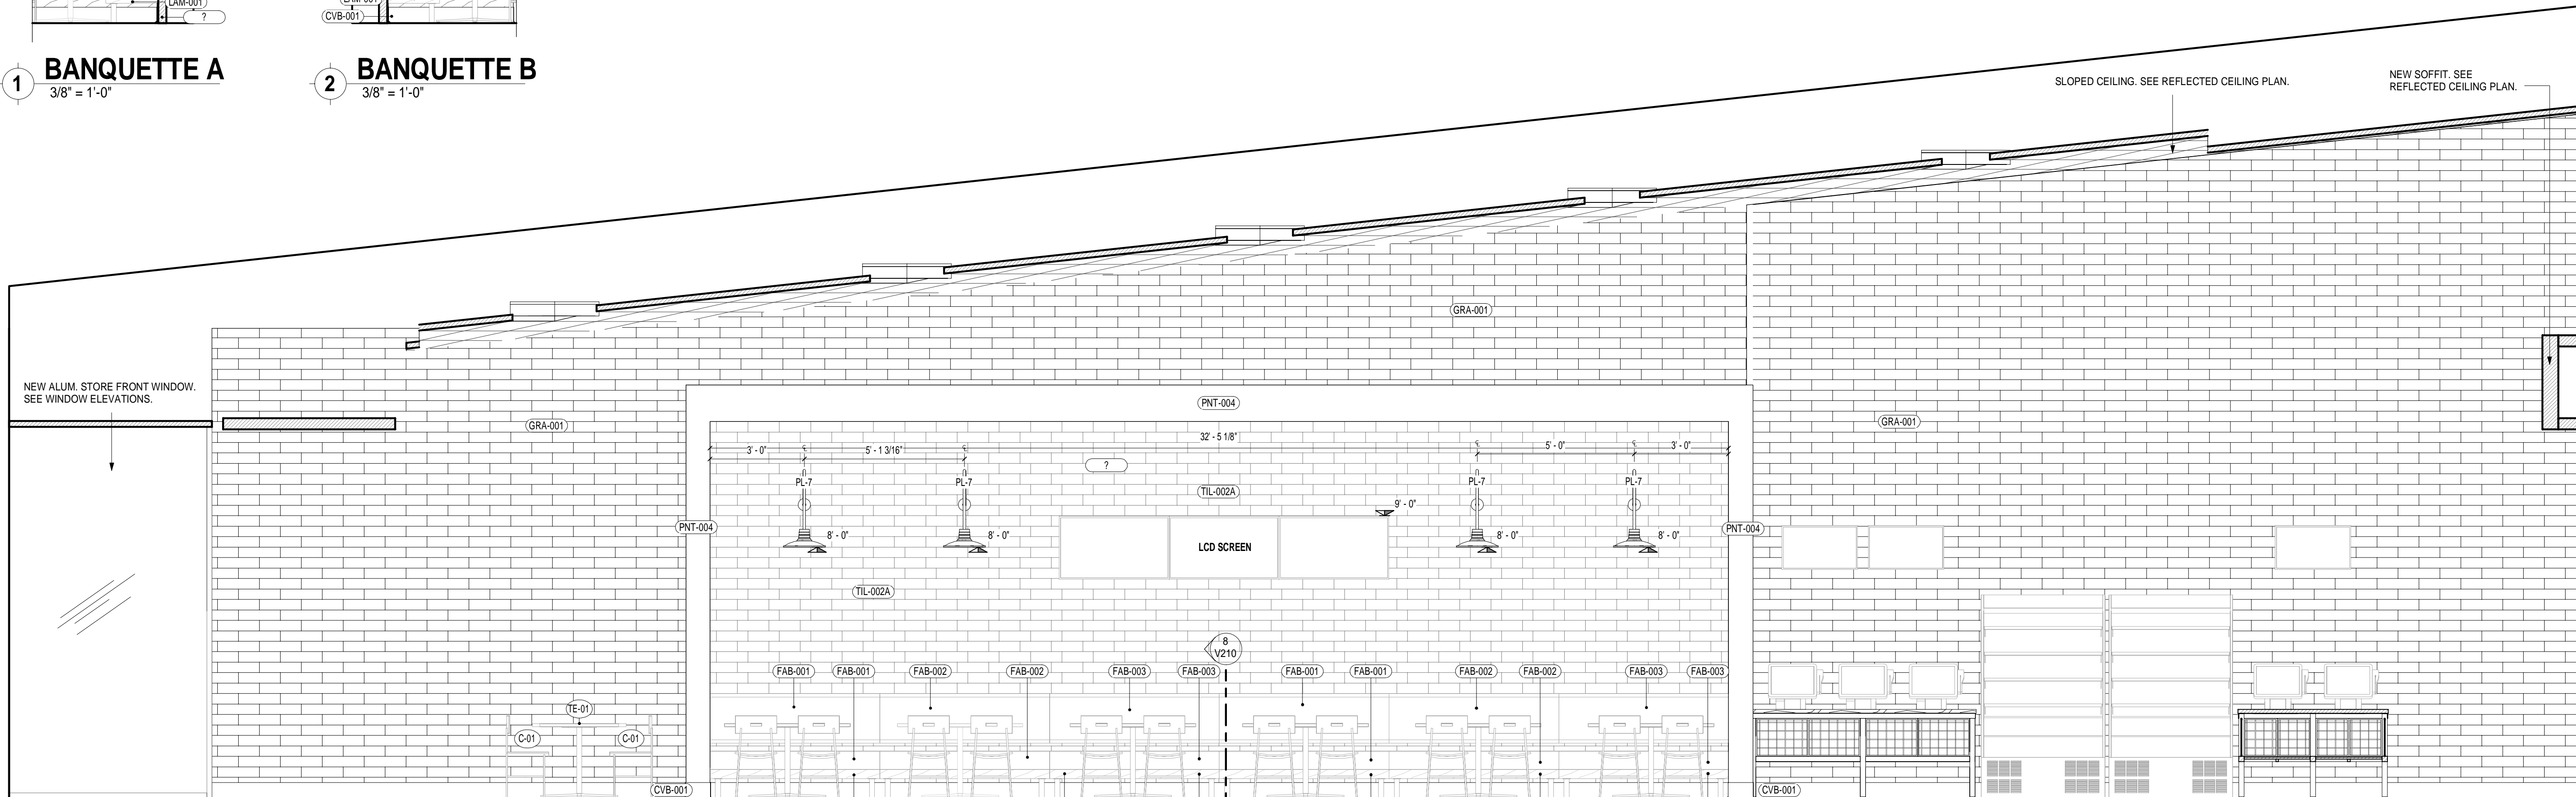


3 **BANQUETTE SEATING A**  
3/8" = 1'-0"




4 **LOUNGE AREA B**  
3/8" = 1'-0"

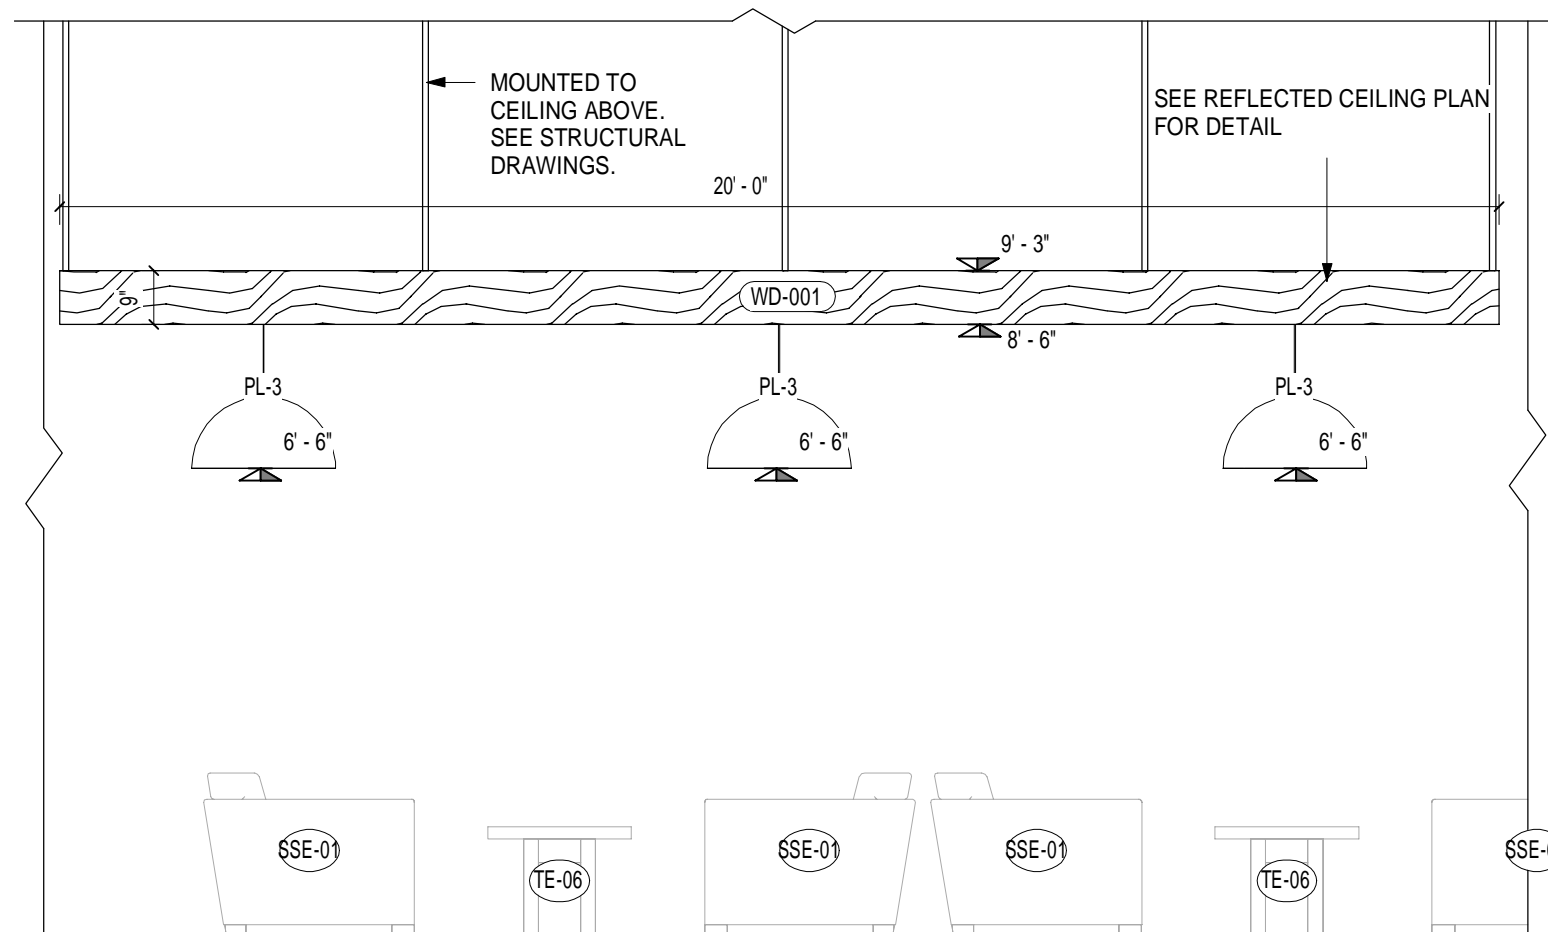

5 **LOUNGE AREA C**  
3/8" = 1'-0"

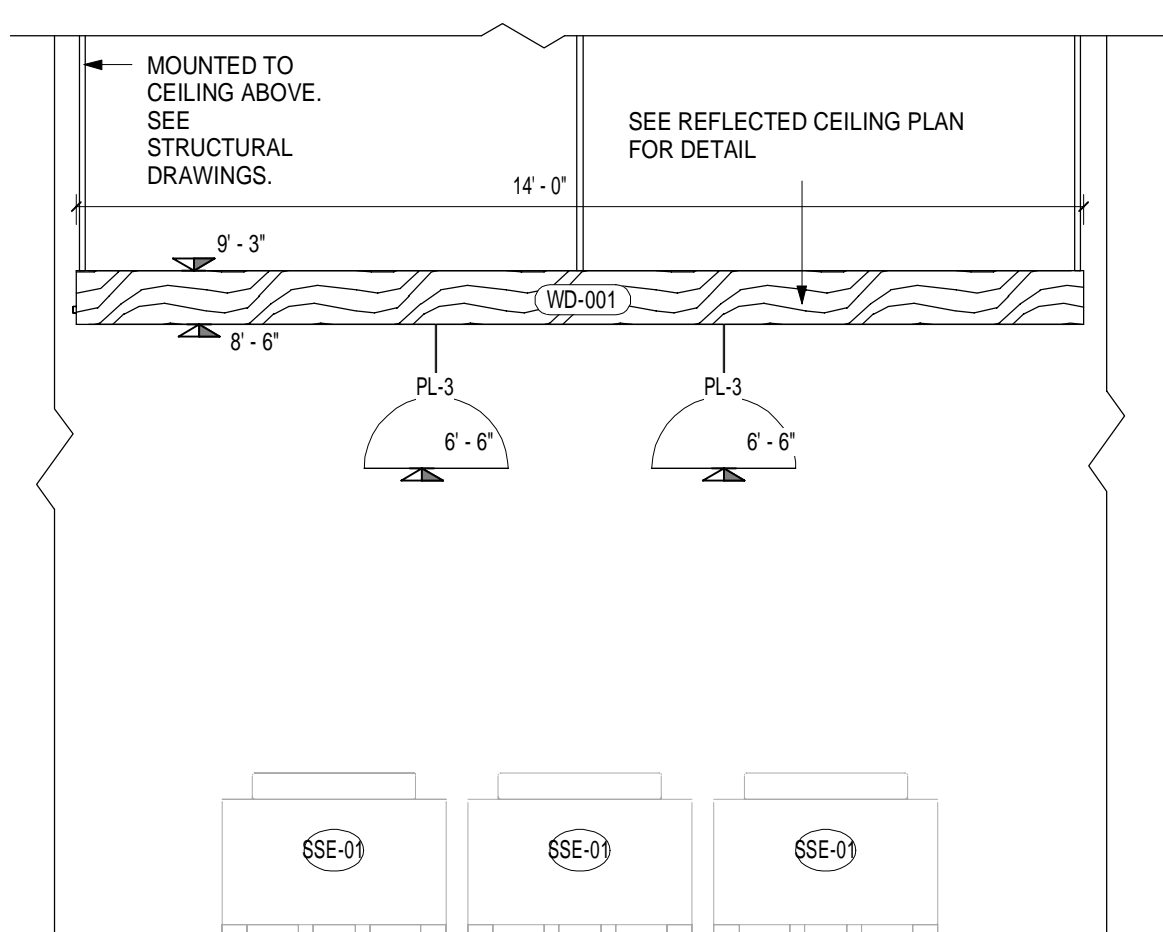

6 **LOUNGE AREA D**  
3/8" = 1'-0"

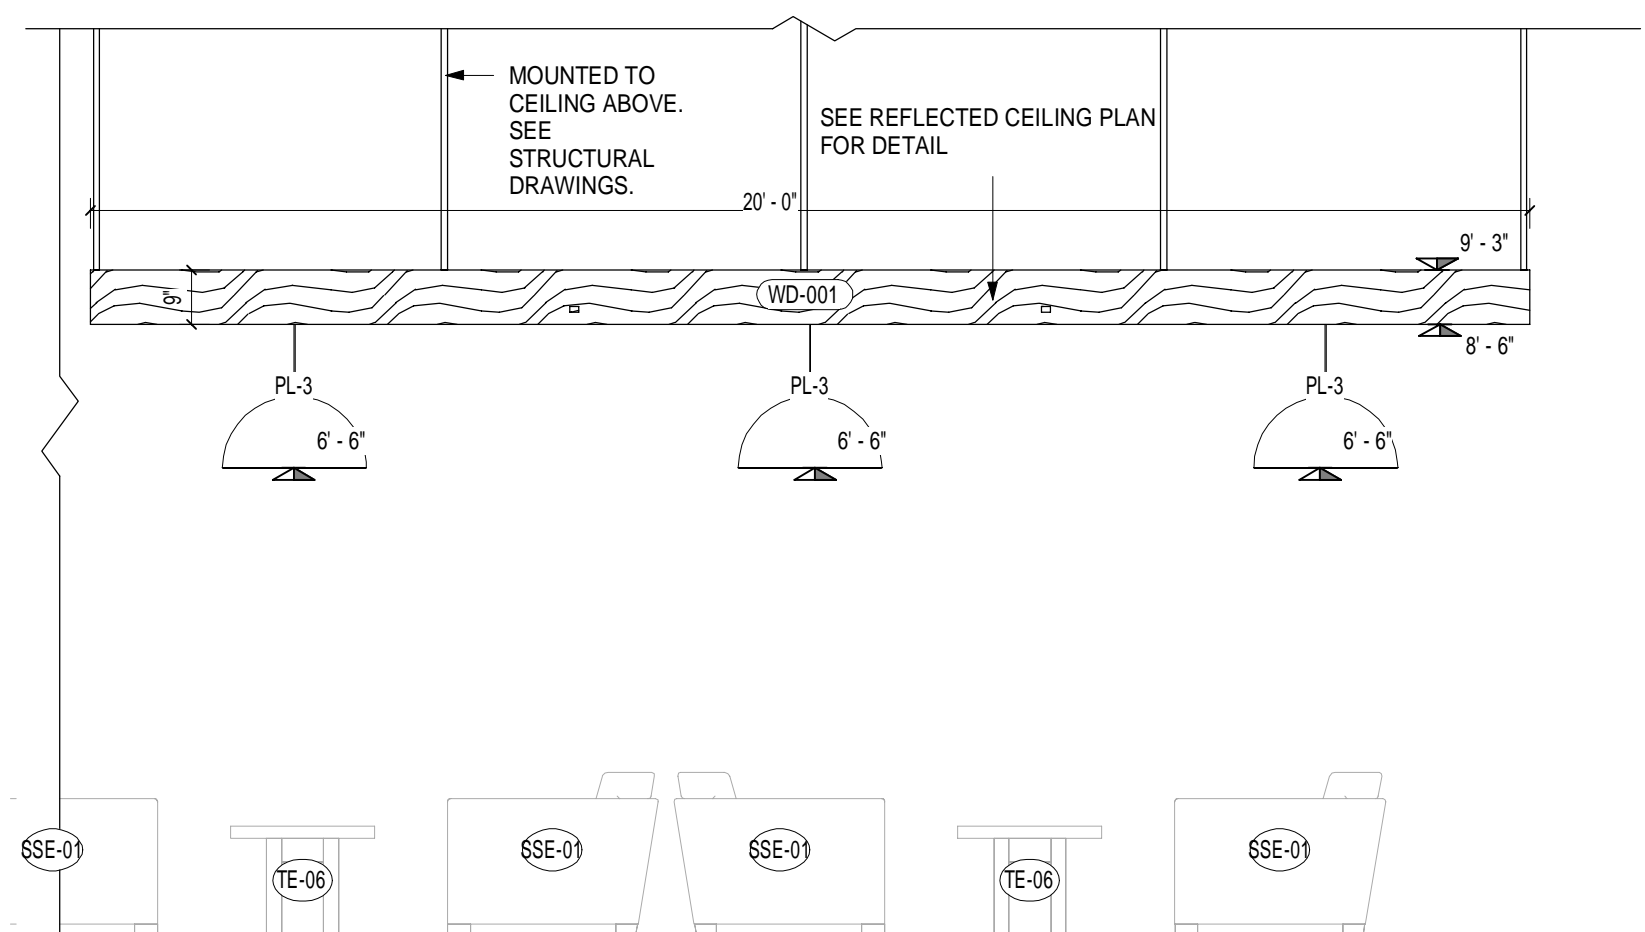

7 **LOUNGE AREA A**  
3/8" = 1'-0"

**SUNY PURCHASE COLLEGE**  
CAFE ADDITION AND RENOVATION  
735 ANDERSON HILL RD  
PURCHASE, NY 10577

NO.	DATE	REVISIONS	
		DESCRIPTION	

SEAL:


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ISSUED DATE: 02/16/2018  
DRAWN BY: JW  
CHECKED BY: CM  
PROJECT NUMBER: CW-0205.4  
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DRAWING NAME:

INTERIOR  
ELEVATIONS X

DRAWING NO.  
**V317**




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1 BOOTH SIDE  
3/8" = 1'-0"

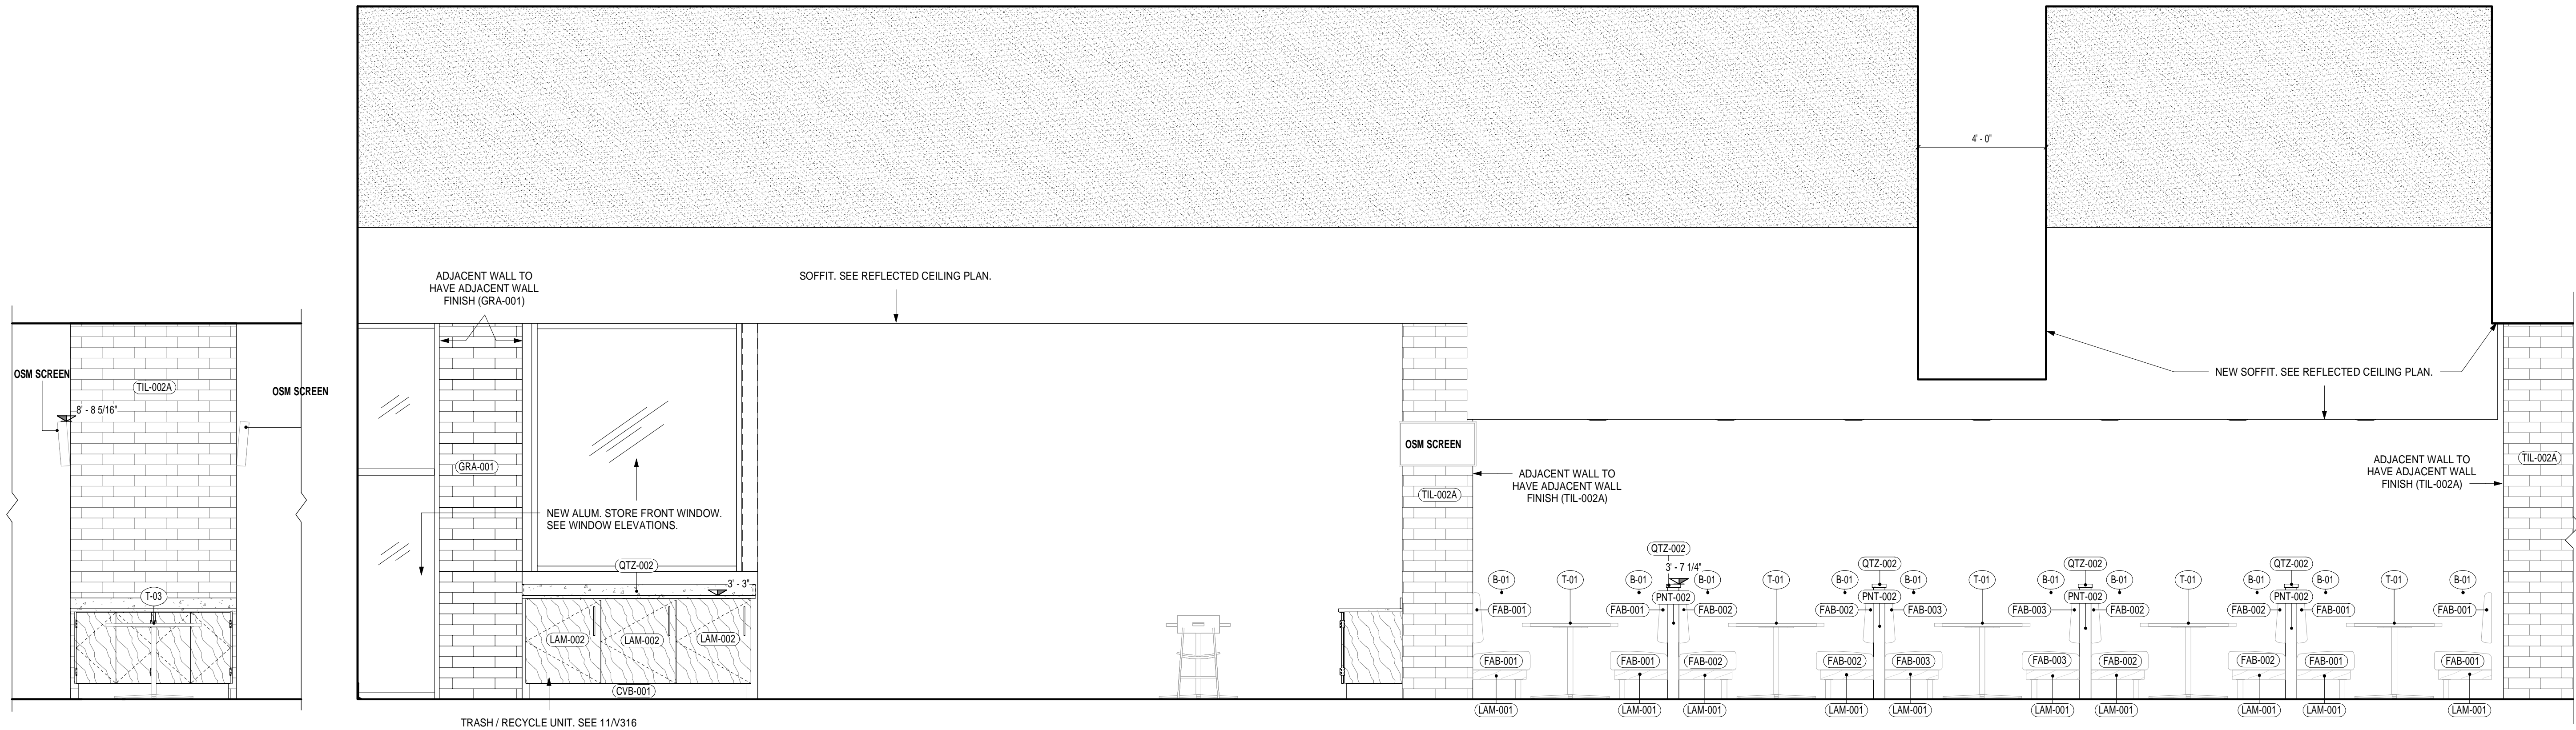2 BOOTH SEATING  
3/8" = 1'-0"



3 TRASH RECYCLING UNIT  
3/8" = 1'-0"

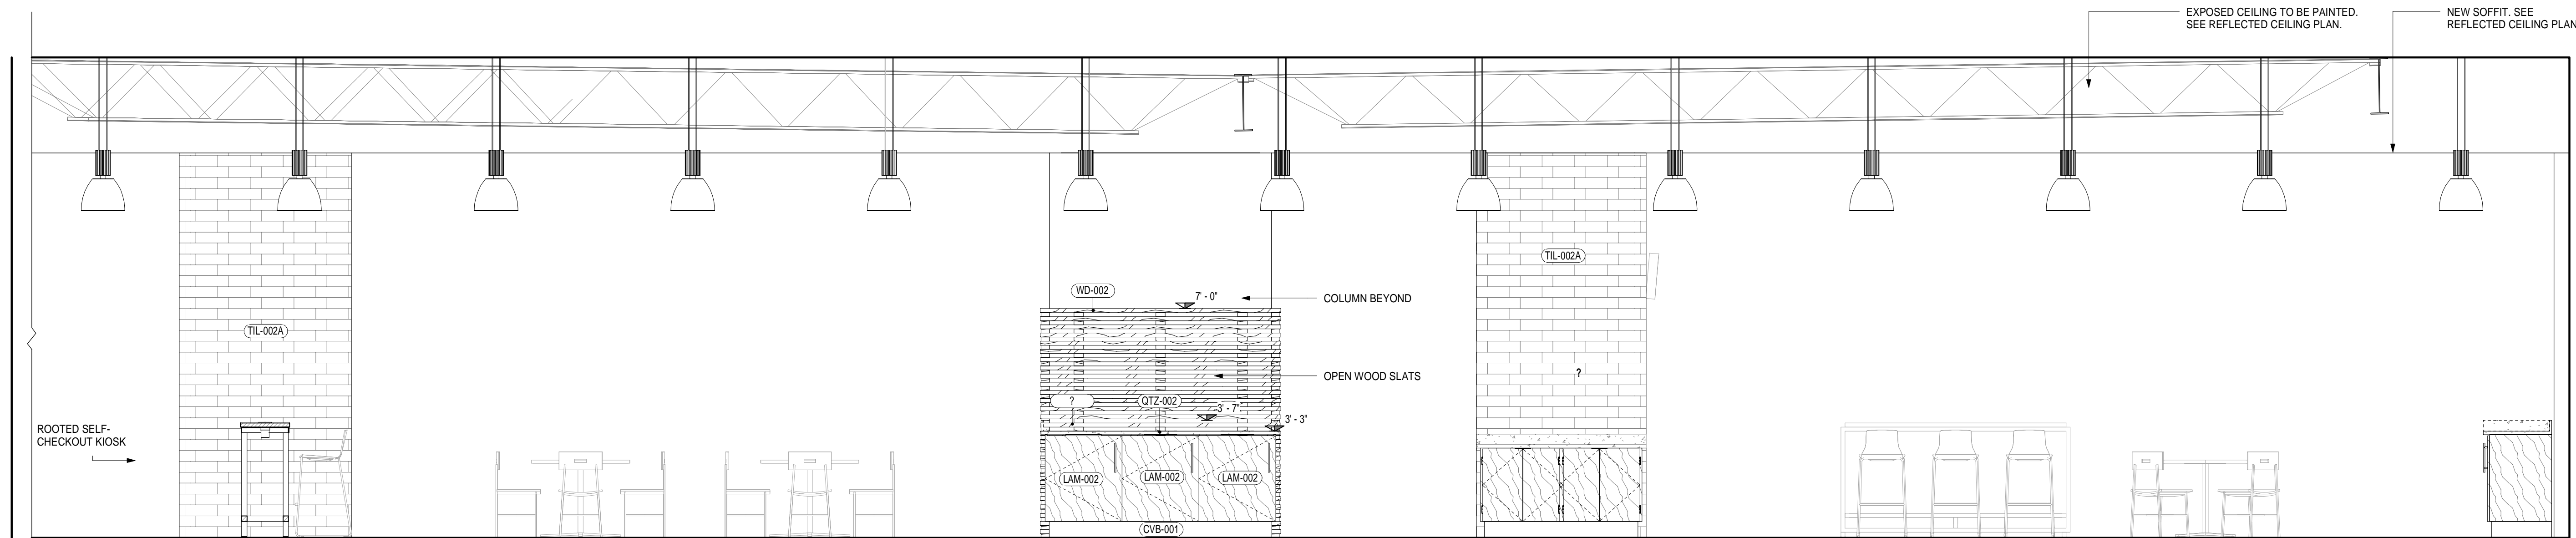ARCHITECT:  
**PHASE ZERO DESIGN**  
8 WILCOX STREET  
SIMSBURY, CONNECTICUT 06070  
PHONE: (860) 264-1624  
FAX: (860) 264-1628  
www.phasezerodesign.com

CLIENT:  
**chartwells**  
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OWNER:  
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www.purchase.edu

CONSULTANT:  
**VISIONBUILDERS**  
ARCHITECT  
100 BENTLEY ROAD, SUITE 100, CHRYSTERS, NC 28028  
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**SUNY PURCHASE COLLEGE**  
CAFE ADDITION AND RENOVATION  
735 ANDERSON HILL RD  
PURCHASE, NY 10577

NO.	DATE	REVISIONS	
		DESCRIPTION	



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ISSUED FOR: BID  
ISSUED DATE: 02/16/2018  
DRAWN BY: JW  
CHECKED BY: CM  
PROJECT NUMBER: CW-0205.4  
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DRAWING NAME:  
**INTERIOR ELEVATIONS XI**

DRAWING NO.  
**V318**







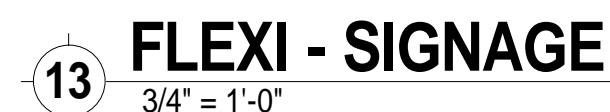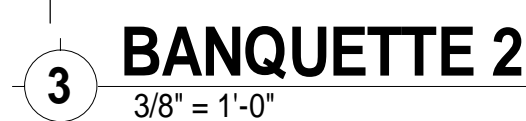

ARCHITECT:

 **PHASE ZERO  
DESIGN**

8 WILCOX STREET  
SIMSBURY, CONNECTICUT 06070  
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[www.phasezerodesign.com](http://www.phasezerodesign.com)

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[www.chartwellsighighered.com](http://www.chartwellsighighered.com)

OWNER:

 **Purchase College**  
STATE UNIVERSITY OF NEW YORK  
[www.purchase.edu](http://www.purchase.edu)

CONSULTANT:



100 Gates Ave., Suite 100, Charlotte, NC 28220  
704.375.4400 or 704.375.4401  
[www.visionbuilders.com](http://www.visionbuilders.com)

**SUNY PURCHASE COLLEGE**

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CAFE ADDITION AND RENOVATION

735 ANDERSON HILL RD  
PURCHASE, NY 10577

[illegible]

SEAL:

ISSUED FOR: BID  
ISSUED DATE: 02/16/2018

DRAWN BY: Author  
CHECKED BY: Checker  
PROJECT NUMBER: CW-0205.4

DRAWING NAME:

## INTERIOR ELEVATIONS XIII

DRAWING NO.

V320








1

## 010-EQUIPMENT DEMO PLAN

3/16" = 1'-0"

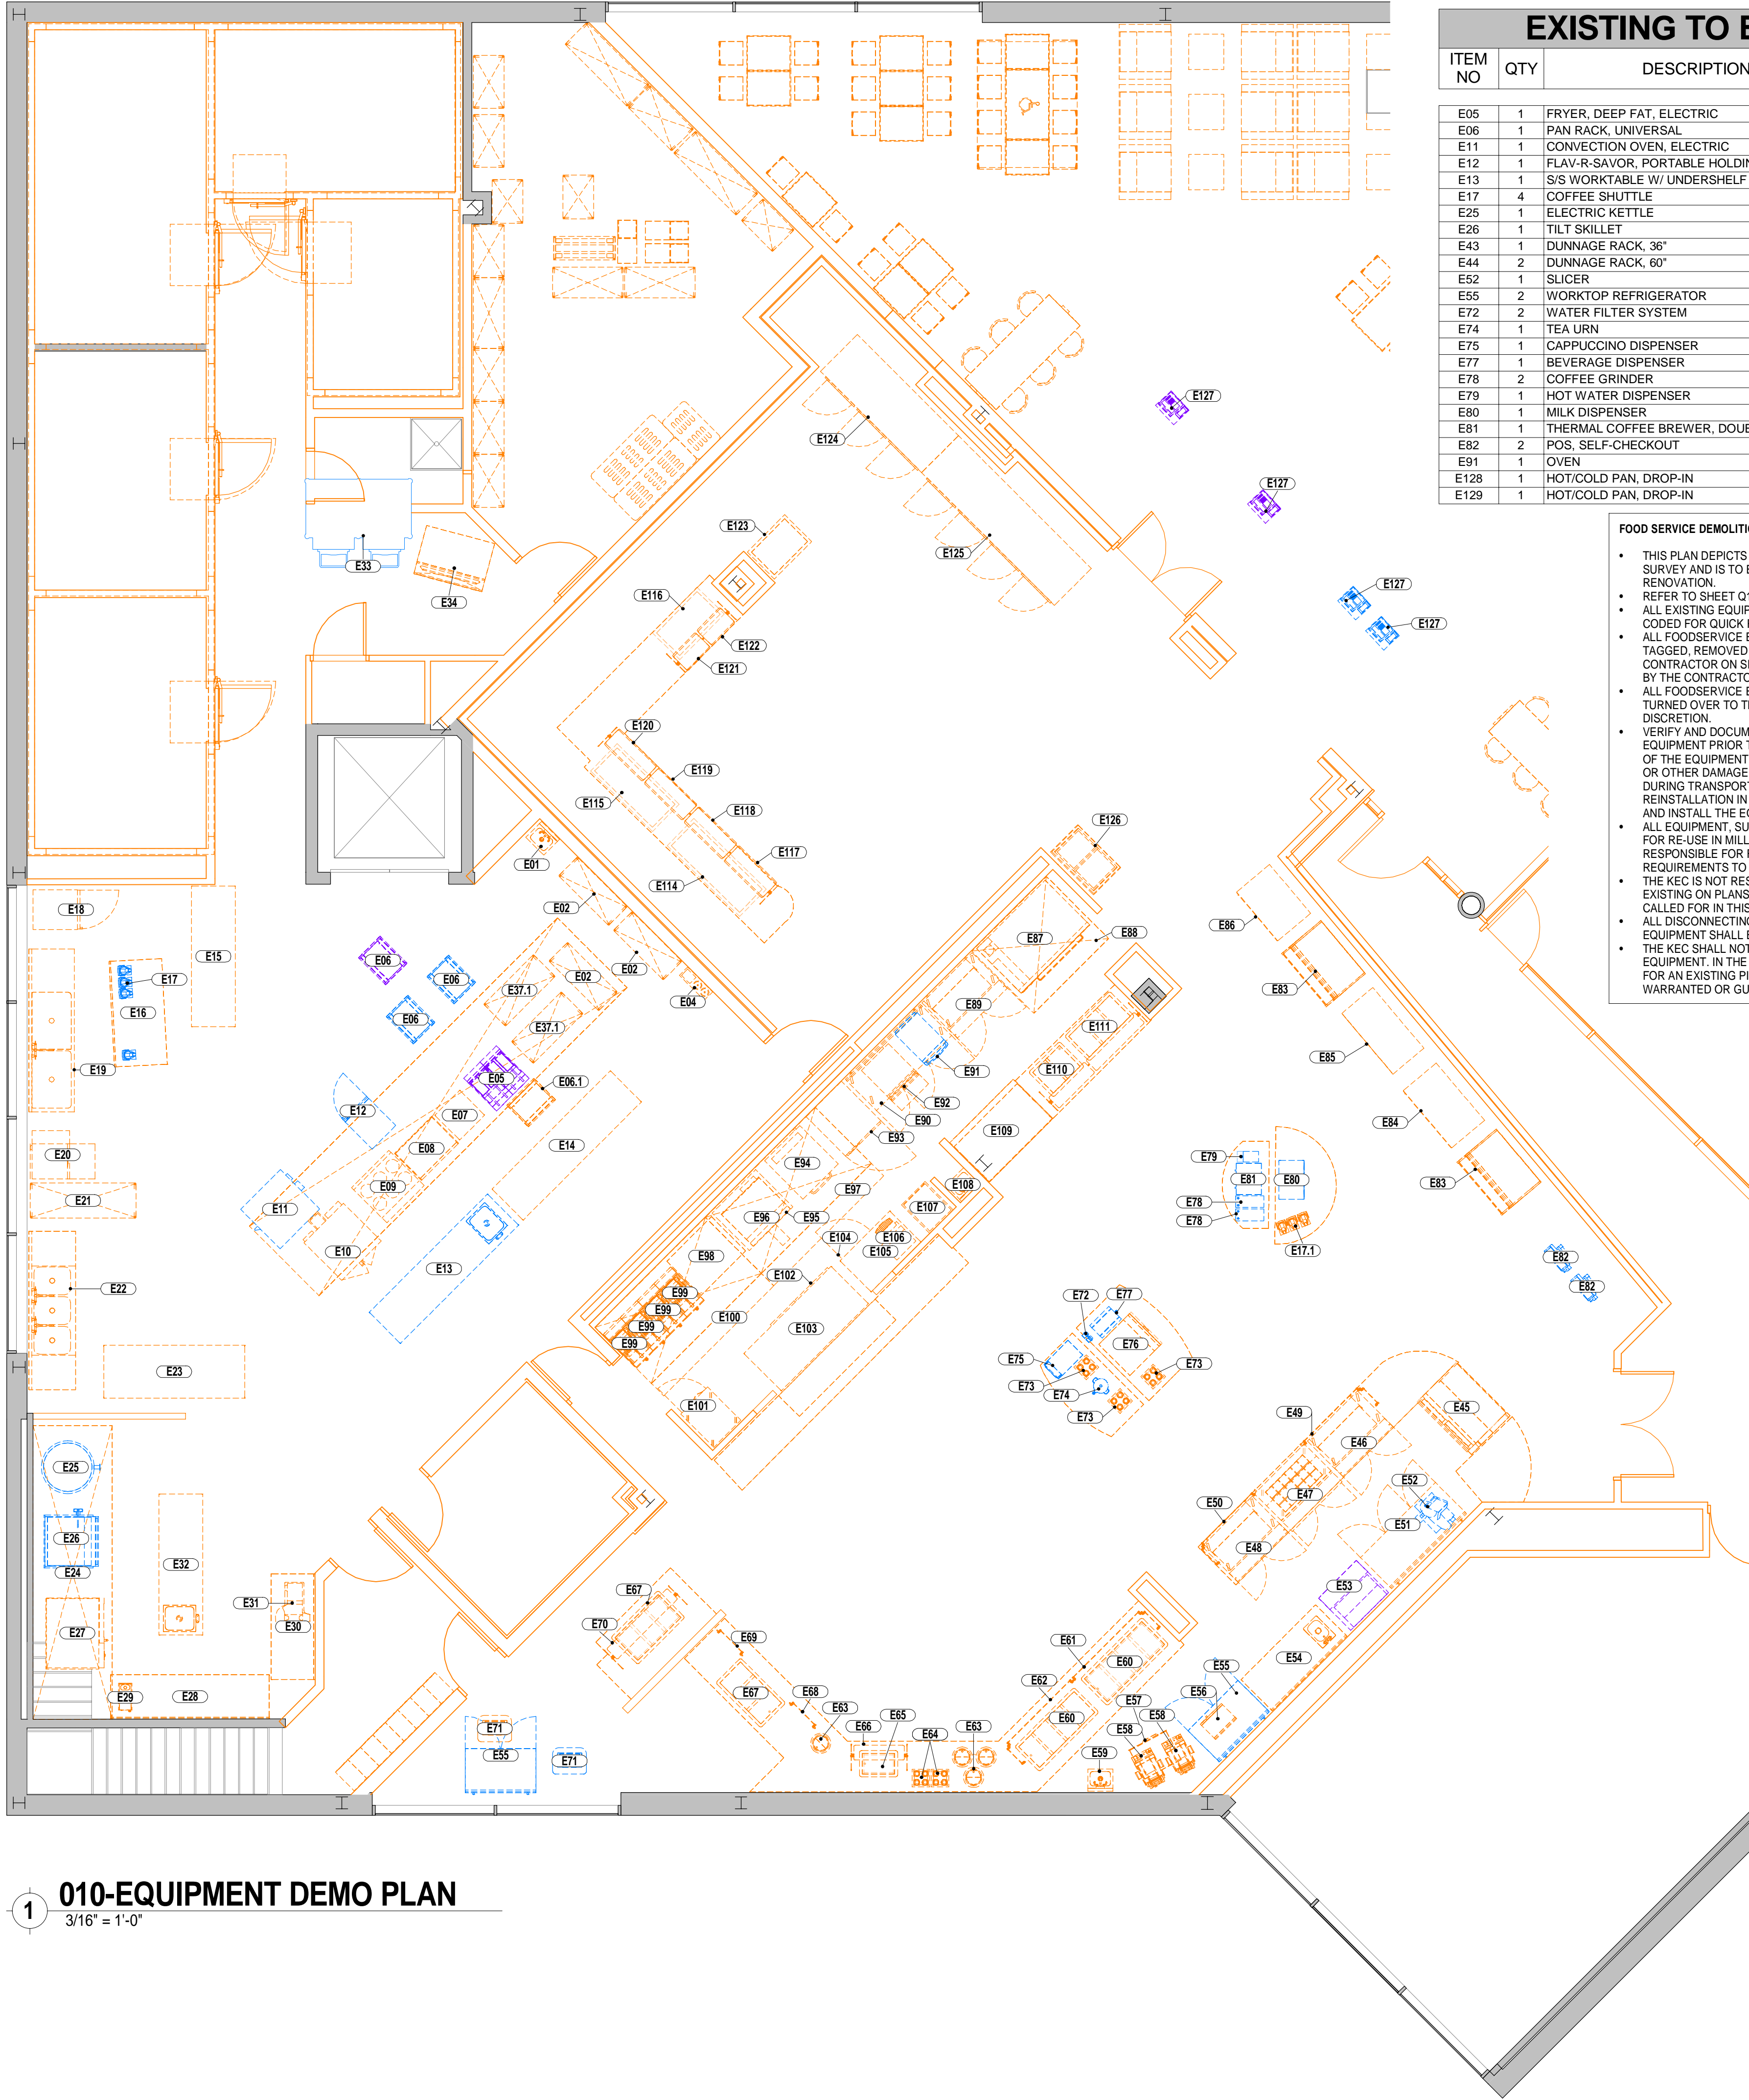

### EXISTING TO BE RELOCATED

ITEM NO	QTY	DESCRIPTION	EQUIPMENT REMARKS
E05	1	FRYER, DEEP FAT, ELECTRIC	EXISTING TO BE RELOCATED
E06	1	PAN RACK, UNIVERSAL	EXISTING TO BE RELOCATED
E11	1	CONVECTION OVEN, ELECTRIC	EXISTING TO BE RELOCATED
E12	1	FLAV-R-SAVOR, PORTABLE HOLDING CABINET	EXISTING TO BE RELOCATED
E13	1	S/S WORKTABLE W/ UNDERSHELF & SINK	EXISTING TO BE RELOCATED
E17	4	COFFEE SHUTTLE	EXISTING TO BE RELOCATED
E25	1	ELECTRIC KETTLE	EXISTING TO BE RELOCATED
E26	1	TILT SKILLET	EXISTING TO BE RELOCATED
E43	1	DUNNAGE RACK, 36"	EXISTING TO BE RELOCATED
E44	2	DUNNAGE RACK, 60"	EXISTING TO BE RELOCATED
E52	1	SLICER	EXISTING TO BE RELOCATED
E55	2	WORKTOP REFRIGERATOR	EXISTING TO BE RELOCATED
E72	2	WATER FILTER SYSTEM	EXISTING TO BE RELOCATED
E74	1	TEA URN	EXISTING TO BE RELOCATED
E75	1	CAPPUCCINO DISPENSER	EXISTING TO BE RELOCATED
E77	1	BEVERAGE DISPENSER	EXISTING TO BE RELOCATED
E78	2	COFFEE GRINDER	EXISTING TO BE RELOCATED
E79	1	HOT WATER DISPENSER	EXISTING TO BE RELOCATED
E80	1	MILK DISPENSER	EXISTING TO BE RELOCATED
E81	1	THERMAL COFFEE BREWER, DOUBLE	EXISTING TO BE RELOCATED
E82	2	POS, SELF-CHECKOUT	EXISTING TO BE RELOCATED
E91	1	OVEN	EXISTING TO BE RELOCATED
E128	1	HOT/COLD PAN, DROP-IN	EXISTING TO BE RELOCATED
E129	1	HOT/COLD PAN, DROP-IN	EXISTING TO BE RELOCATED

#### FOOD SERVICE DEMOLITION NOTES:

- THIS PLAN DEPICTS LOCATIONS OF FOODSERVICE EQUIPMENT AT THE TIME OF SURVEY AND IS TO BE USED AS A REFERENCE AND GUIDE TO THE MAIN KITCHEN RENOVATION.
- ALL EXISTING EQUIPMENT SCHEDULED FOR REUSE IN THE FACILITY IS COLOR-CODED FOR QUICK REFERENCE.
- ALL FOODSERVICE EQUIPMENT THAT IS SCHEDULED FOR REUSE SHALL BE TAGGED, REMOVED AND STORED IN A LOCATION PROVIDED BY THE GENERAL CONTRACTOR ON SITE. TRANSPORTATION OF EQUIPMENT SHALL BE PROVIDED BY THE CONTRACTOR.
- ALL FOODSERVICE EQUIPMENT THAT IS SCHEDULED FOR REMOVAL SHALL BE TURNED OVER TO THE OWNER FOR DISPOSAL OR STORAGE AT THEIR DISCRETION.
- VERIFY AND DOCUMENT THE OPERATING CONDITION OF ALL RELOCATED EQUIPMENT PRIOR TO ITS BEING DISCONNECTED. DOCUMENT THE CONDITION OF THE EQUIPMENT TO NOTE ANY DENTS, SCRATCHES, BROKEN COMPONENTS OR OTHER DAMAGE PRIOR TO PLACING IT IN STORAGE. PROTECT EQUIPMENT DURING TRANSPORT AND STORAGE, AND ASSUME RESPONSIBILITY FOR ITS REINSTALLATION IN THE CONDITION VIEWED PRIOR TO REMOVAL. TRANSPORT AND INSTALL THE EQUIPMENT IN ACCORDANCE WITH ITEM SPECIFICATIONS.
- ALL EQUIPMENT, SUCH AS DROP-IN UNITS AND SNEEZE GUARDS, SCHEDULED FOR RE-USE IN MILLWORK COUNTERS SHALL BE FIELD VERIFIED BY KEC. KEC IS RESPONSIBLE FOR FURNISHING THE CORRECT PLACEMENT AND CUTOUT REQUIREMENTS TO MILLWORK CONTRACTOR FOR COMPLETE COORDINATION. THE KEC IS NOT RESPONSIBLE FOR REFURBISHING EQUIPMENT NOTED AS EXISTING ON PLANS OR SPECIFICATIONS UNLESS WORK IS SPECIFICALLY CALLED FOR IN THIS SECTION.
- ALL DISCONNECTING AND RECONNECTING OF SERVICES TO EXISTING EQUIPMENT SHALL BE PERFORMED BY RELATED TRADES.
- THE KEC SHALL NOT PROVIDE A WARRANTY OR GUARANTEE ON EXISTING EQUIPMENT. IN THE CASE OF A NEW COMPONENT BEING PROVIDED BY THE KEC FOR AN EXISTING PIECE OF EQUIPMENT, THE COMPONENT SHALL BE WARRANTED OR GUARANTEED AS SPECIFIED HEREIN BEFORE.

#### DEMOLITION EQUIPMENT LEGEND

- EXISTING TO BE DEMOLISHED
- EXISTING TO BE RELOCATED

### EXISTING TO BE DEMOLISHED

ITEM NO	QTY	DESCRIPTION	EQUIPMENT REMARKS
E01	1	HAND SINK	EXISTING TO BE DEMOLISHED
E02	3	SHELVING, WIRE	EXISTING TO BE DEMOLISHED
E03	1	EXHAUST HOOD	EXISTING TO BE DEMOLISHED
E04	1	FIRE SUPPRESSION SYSTEM	EXISTING TO BE DEMOLISHED
E06.1	1	PAN RACK, UNIVERSAL	EXISTING TO BE DEMOLISHED
E07	1	S/S WORKTABLE W/ UNDERSHELF	EXISTING TO BE DEMOLISHED
E08	1	GRIDDLE RANGE	EXISTING TO BE DEMOLISHED
E09	1	36" RANGE - FRENCH PLATE - STANDARD OVEN	EXISTING TO BE DEMOLISHED
E10	1	CONVECTION OVEN - ELECTRIC - SINGLE DECK	EXISTING TO BE DEMOLISHED
E14	1	S/S WORKTABLE W/ UNDERSHELF	EXISTING TO BE DEMOLISHED
E15	1	S/S WORKTABLE W/ UNDERSHELF & SINK	EXISTING TO BE DEMOLISHED
E16	1	S/S WORKTABLE W/ UNDERSHELF & BACKSPLASH	EXISTING TO BE DEMOLISHED
E17.1	3	COFFEE SHUTTLE	EXISTING TO BE DEMOLISHED
E18	1	MERCHANDISER, REFRIGERATOR	EXISTING TO BE DEMOLISHED
E19	1	FAUCET, WALL MOUNT	EXISTING TO BE DEMOLISHED
E19	1	SINK, 2-COMPARTMENT	EXISTING TO BE DEMOLISHED
E20	1	UNDER COUNTER DISHWASHER	EXISTING TO BE DEMOLISHED
E21	1	SHELVING, WIRE	EXISTING TO BE DEMOLISHED
E22	1	3-COMPARTMENT SINK	EXISTING TO BE DEMOLISHED
E23	1	S/S WORKTABLE W/ UNDERSHELF	EXISTING TO BE DEMOLISHED
E24	1	EXHAUST HOOD	EXISTING TO BE DEMOLISHED
E27	1	ELECTRIC CONVECTION OVEN	EXISTING TO BE DEMOLISHED
E28	1	S/S WORKTABLE W/ UNDERSHELF & BACKSPLASH	EXISTING TO BE DEMOLISHED
E29	1	COFFEE BREWER, AIRPOT	EXISTING TO BE DEMOLISHED
E30	1	S/S WORKTABLE W/ UNDERSHELF & BACKSPLASH	EXISTING TO BE DEMOLISHED
E31	1	FOOD CUTTER	EXISTING TO BE DEMOLISHED
E32	1	S/S WORKTABLE W/ UNDERSHELF & SINK	EXISTING TO BE DEMOLISHED
E34	1	ICE BIN	EXISTING TO BE DEMOLISHED
E36	6	SHELVING, WIRE	EXISTING TO BE DEMOLISHED
E37	3	SHELVING, WIRE	EXISTING TO BE DEMOLISHED
E37.1	2	SHELVING, WIRE	EXISTING TO BE DEMOLISHED
E38	3	SHELVING, WIRE	EXISTING TO BE DEMOLISHED
E39	2	SHELVING, WIRE	EXISTING TO BE DEMOLISHED
E40	1	SHELVING, WIRE	EXISTING TO BE DEMOLISHED
E41	1	TRUCK, PLATFORM	EXISTING TO BE DEMOLISHED
E42	3	BIN, INGREDIENT	EXISTING TO BE DEMOLISHED
E45	1	REFRIGERATED DELI CASE	EXISTING TO BE DEMOLISHED
E46	1	SANDWICH MAKE TABLE	EXISTING TO BE DEMOLISHED
E47	1	PREP TABLE, MEGA TOP	EXISTING TO BE DEMOLISHED
E48	1	SANDWICH MAKE TABLE	EXISTING TO BE DEMOLISHED
E49	1	VERTICAL SNEEZE GUARD	EXISTING TO BE DEMOLISHED
E50	1	VERTICAL SNEEZE GUARD	EXISTING TO BE DEMOLISHED
E51	1	WORKTOP REFRIGERATOR	EXISTING TO BE DEMOLISHED
E54	1	WORKTABLE, CABINET BASE, HINGED DOORS	EXISTING TO BE DEMOLISHED
E56	1	MICROWAVE OVEN	EXISTING TO BE DEMOLISHED
E57	1	BUILT-IN DRAWER WARMER	EXISTING TO BE DEMOLISHED
E58	2	SANDWICH PRESS	EXISTING TO BE DEMOLISHED
E59	1	HAND SINK	EXISTING TO BE DEMOLISHED
E60	1	COLD PAN	EXISTING TO BE DEMOLISHED
E60	1	HOT PAN ELECTRICALLY HEATED-SINGLE CONTROL	EXISTING TO BE DEMOLISHED
E61	1	VERTICAL SNEEZE GUARD	EXISTING TO BE DEMOLISHED
E62	1	VERTICAL SNEEZE GUARD	EXISTING TO BE DEMOLISHED
E63	4	SOUP WELL, DROP-IN, INDUCTION	EXISTING TO BE DEMOLISHED
E64	2	CUP DISPLAY	EXISTING TO BE DEMOLISHED
E65	1	COLD PAN	EXISTING TO BE DEMOLISHED
E66	1	SNEEZE GUARD	EXISTING TO BE DEMOLISHED
E67	1	COLD PAN	EXISTING TO BE DEMOLISHED
E67	1	COLD PAN, REFRIGERATED 9-3/4" FULL DEPTH SELF-CONTAINED	EXISTING TO BE DEMOLISHED
E68	1	VERTICAL SNEEZE GUARD	EXISTING TO BE DEMOLISHED
E69	1	VERTICAL SNEEZE GUARD	EXISTING TO BE DEMOLISHED
E70	1	SNEEZE GUARD	EXISTING TO BE DEMOLISHED
E71	1	IPAD NUTRITION KIOSK	EXISTING TO BE DEMOLISHED
E73	3	CUP DISPLAY	EXISTING TO BE DEMOLISHED
E76	1	PEPSI SODA DISPENSER	EXISTING TO BE DEMOLISHED
E83	2	AIRSCREEN	EXISTING TO BE DEMOLISHED
E84	1	GLASS DOOR MERCHANDISER SLIDE DOOR REFRIGERATOR	EXISTING TO BE DEMOLISHED
E85	1	REACH-IN REFRIGERATOR	EXISTING TO BE DEMOLISHED
E86	1	GLASS DOOR MERCHANDISER SLIDE DOOR REFRIGERATOR	EXISTING TO BE DEMOLISHED
E87	1	DECK OVEN, PIZZA, ELECTRIC	EXISTING TO BE DEMOLISHED
E88	1	EXHAUST HOOD	EXISTING TO BE DEMOLISHED
E89	1	SANDWICH MAKE TABLE	EXISTING TO BE DEMOLISHED
E90	1	WORKTOP SOLID DOOR REFRIGERATOR	EXISTING TO BE DEMOLISHED
E92	1	CONVECTION OVEN, ELECTRIC, COUNTERTOP	EXISTING TO BE DEMOLISHED
E93	1	REFRIGERATOR, ROLL IN	EXISTING TO BE DEMOLISHED
E94	1	INFRARED BROILER - SINGLE DECK WITH WARMER	EXISTING TO BE DEMOLISHED
E95	1	EQUIPMENT STAND	EXISTING TO BE DEMOLISHED
E96	1	ULTRA-MAX ELECTRIC GRIDDLES	EXISTING TO BE DEMOLISHED
E97	1	EXHAUST HOOD	EXISTING TO BE DEMOLISHED
E98	1	DUMP STATION	EXISTING TO BE DEMOLISHED
E99	4	FRYER, 30 LB	EXISTING TO BE DEMOLISHED
E100	1	EXHAUST HOOD	EXISTING TO BE DEMOLISHED
E101	1	FREEZER, REACH-IN	EXISTING TO BE DEMOLISHED
E102	1	GRIDDLE STAND, REFRIGERATOR	EXISTING TO BE DEMOLISHED
E103	1	S/S WORKTABLE	EXISTING TO BE DEMOLISHED
E104	1	UNDERCOUNTER REFRIGERATOR	EXISTING TO BE DEMOLISHED
E105	1	S/S WORKTABLE W/ UNDERSHELF	EXISTING TO BE DEMOLISHED
E106	1	QC33 SERIES HIGH VOLUME CONVEYOR TOASTERS	EXISTING TO BE DEMOLISHED
E107	1	CABINET, MOBILE, WARMING & HOLDING	EXISTING TO BE DEMOLISHED
E108	1	HAND SINK	EXISTING TO BE DEMOLISHED
E109	1	REFRIGERATED DELI CASE	EXISTING TO BE DEMOLISHED
E110	1	DROPIN HOT WELL	EXISTING TO BE DEMOLISHED
E111	1	DROPIN HOT WELL	EXISTING TO BE DEMOLISHED
E112	1	SNEEZE GUARD	EXISTING TO BE DEMOLISHED
E113	1	SNEEZE GUARD	EXISTING TO BE DEMOLISHED
E114	1	HOT/COLD WELL, DROP-IN	EXISTING TO BE DEMOLISHED
E115	1	HOT/COLD WELL, DROP-IN	EXISTING TO BE DEMOLISHED
E116	1	HOT/COLD WELL, DROP-IN	EXISTING TO BE DEMOLISHED
E117	1	SNEEZE GUARD	EXISTING TO BE DEMOLISHED
E118	1	SNEEZE GUARD	EXISTING TO BE DEMOLISHED
E119	1	SNEEZE GUARD	EXISTING TO BE DEMOLISHED
E120	1	SNEEZE GUARD	EXISTING TO BE DEMOLISHED
E121	1	SNEEZE GUARD	EXISTING TO BE DEMOLISHED
E122	1	SNEEZE GUARD	EXISTING TO BE DEMOLISHED

### EXISTING TO BE USED LATER

ITEM NO	QTY	DESCRIPTION	EQUIPMENT REMARKS
E05	1	FRYER, DEEP FAT, ELECTRIC	FUTURE
E06	1	PAN RACK, UNIVERSAL	FUTURE
E53	1	REFRIGERATOR, SANDWICH/SALAD PREP	FUTURE
E127	2	P.O.S.	FUTURE

REVISIONS		
NO.	DATE	DESCRIPTION

SEAL:

ISSUED FOR: DD REVIEW  
ISSUED DATE: 1.19.2017  
DRAWN BY: R.Schneider  
CHECKED BY: KPF  
PROJECT NUMBER: CW-0205-4

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EQUIPMENT DEMO  
LAYOUT

DRAWING NO.

Q010













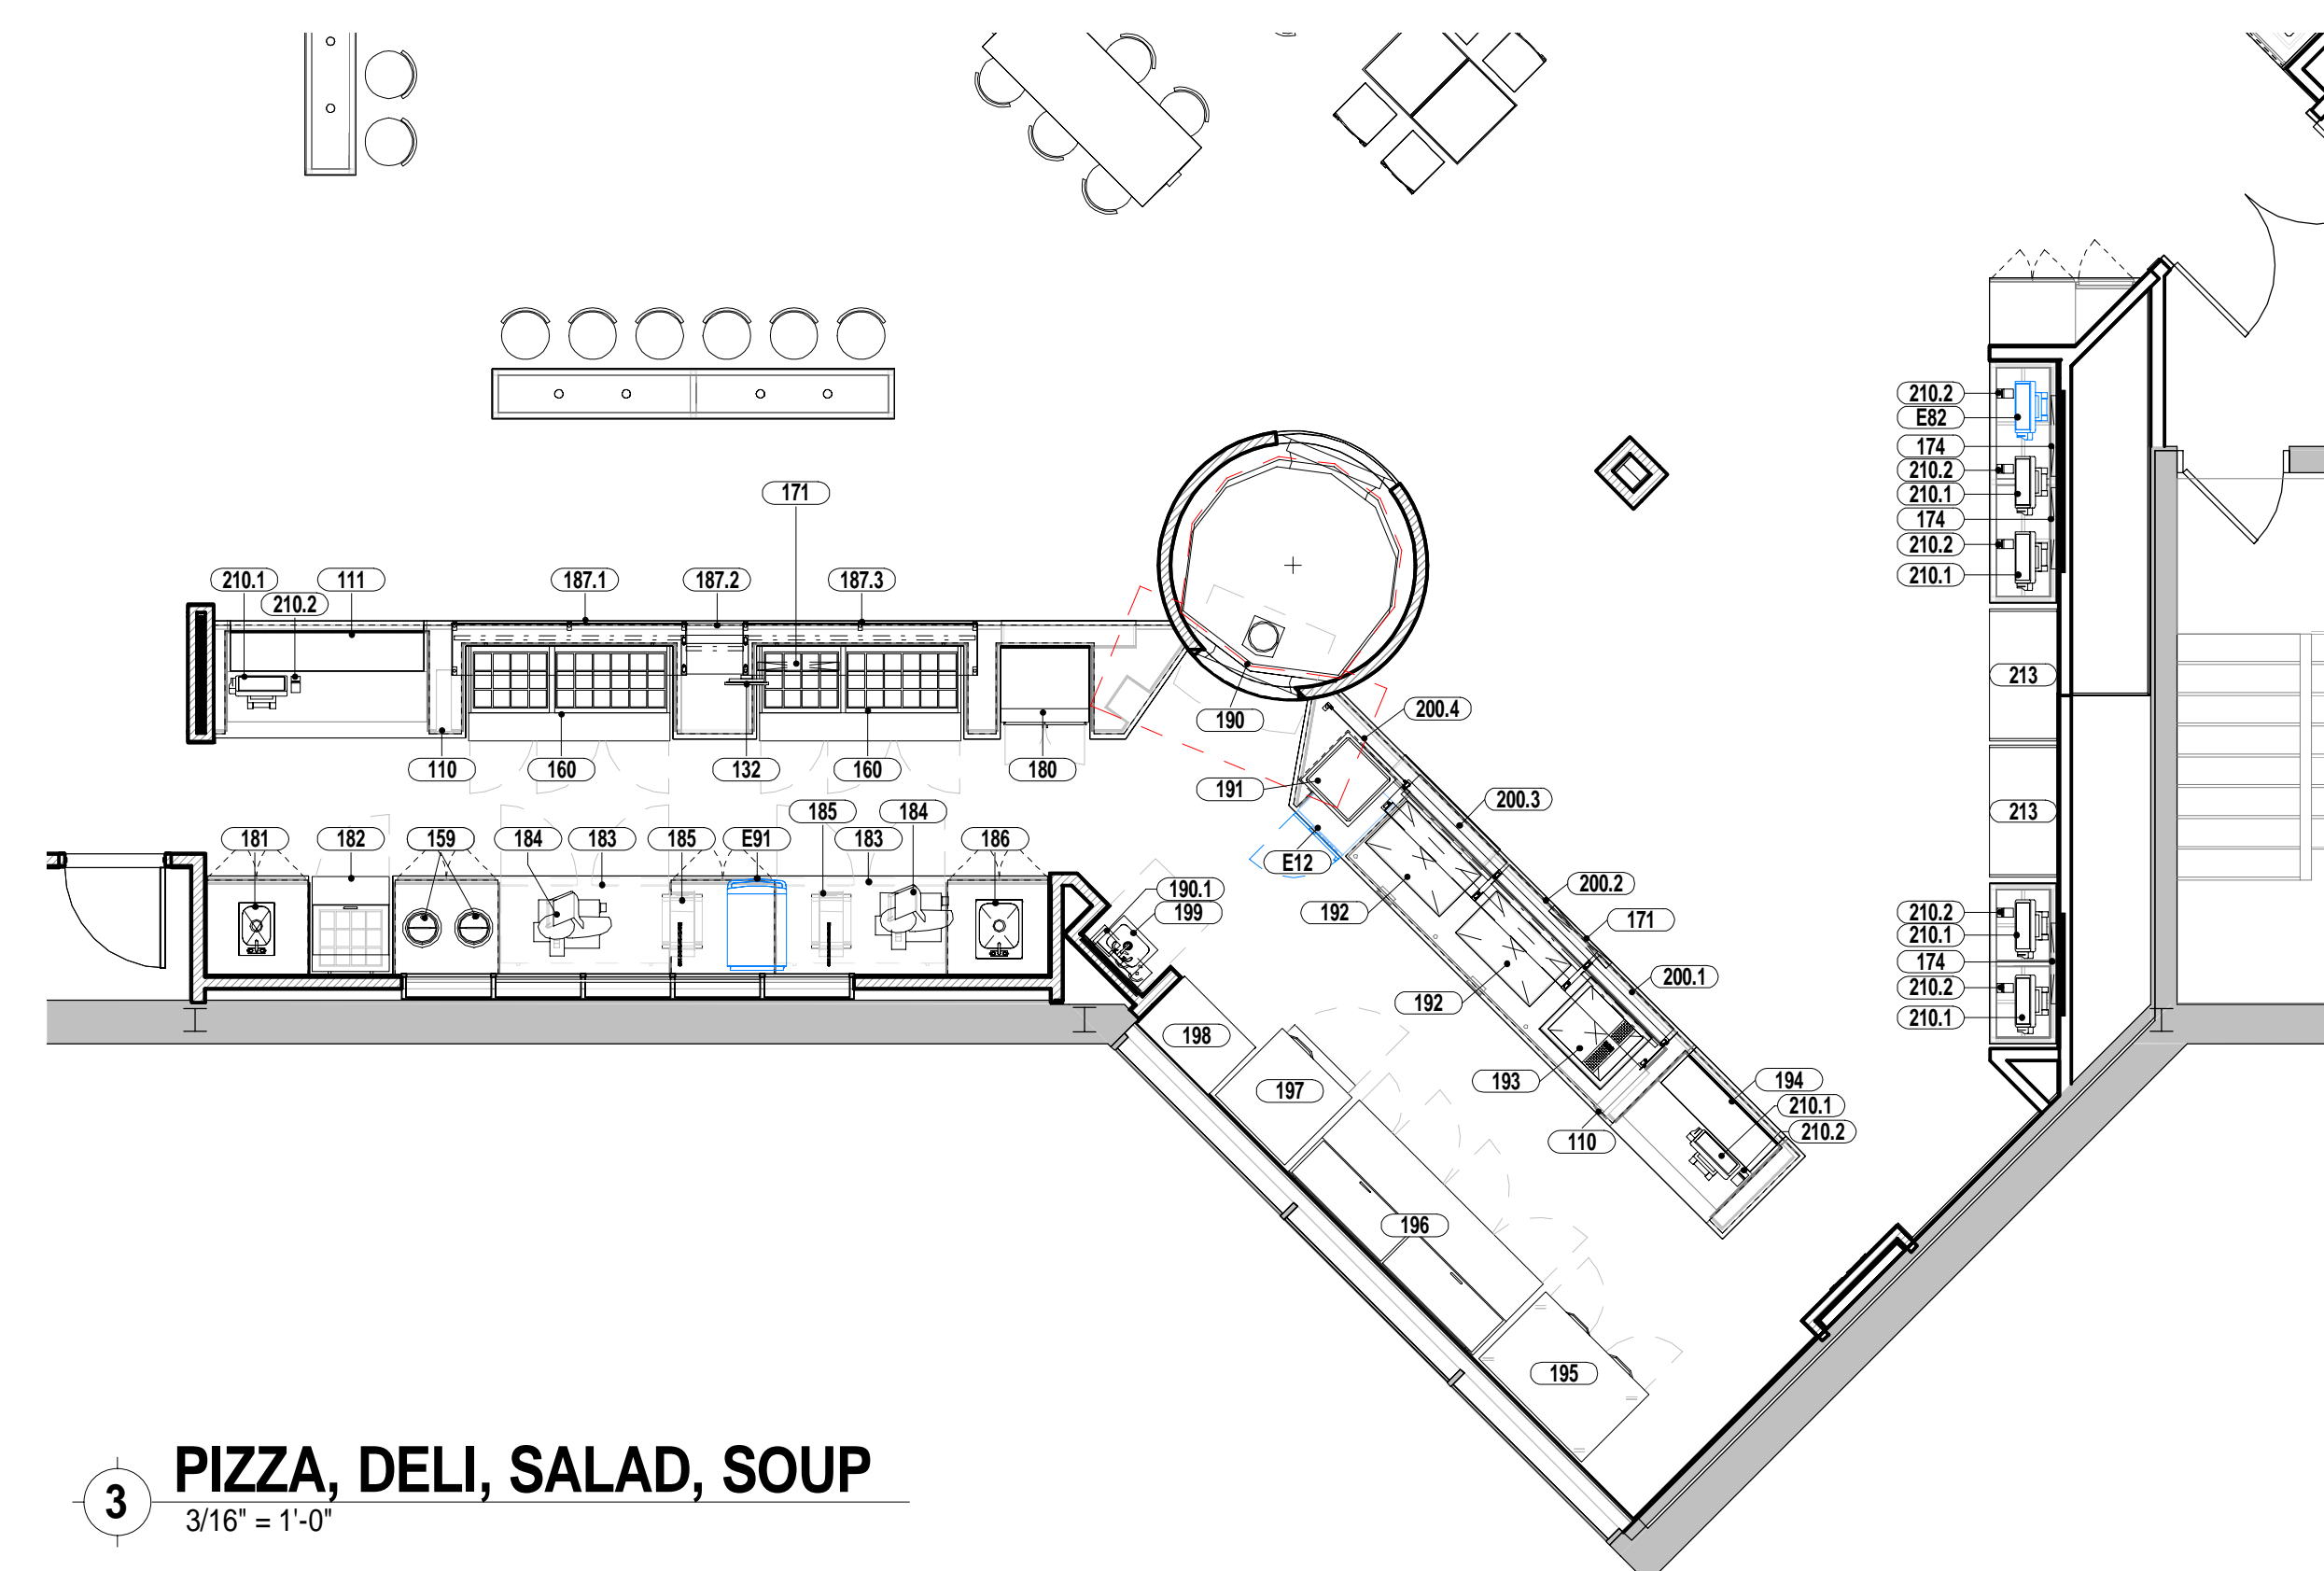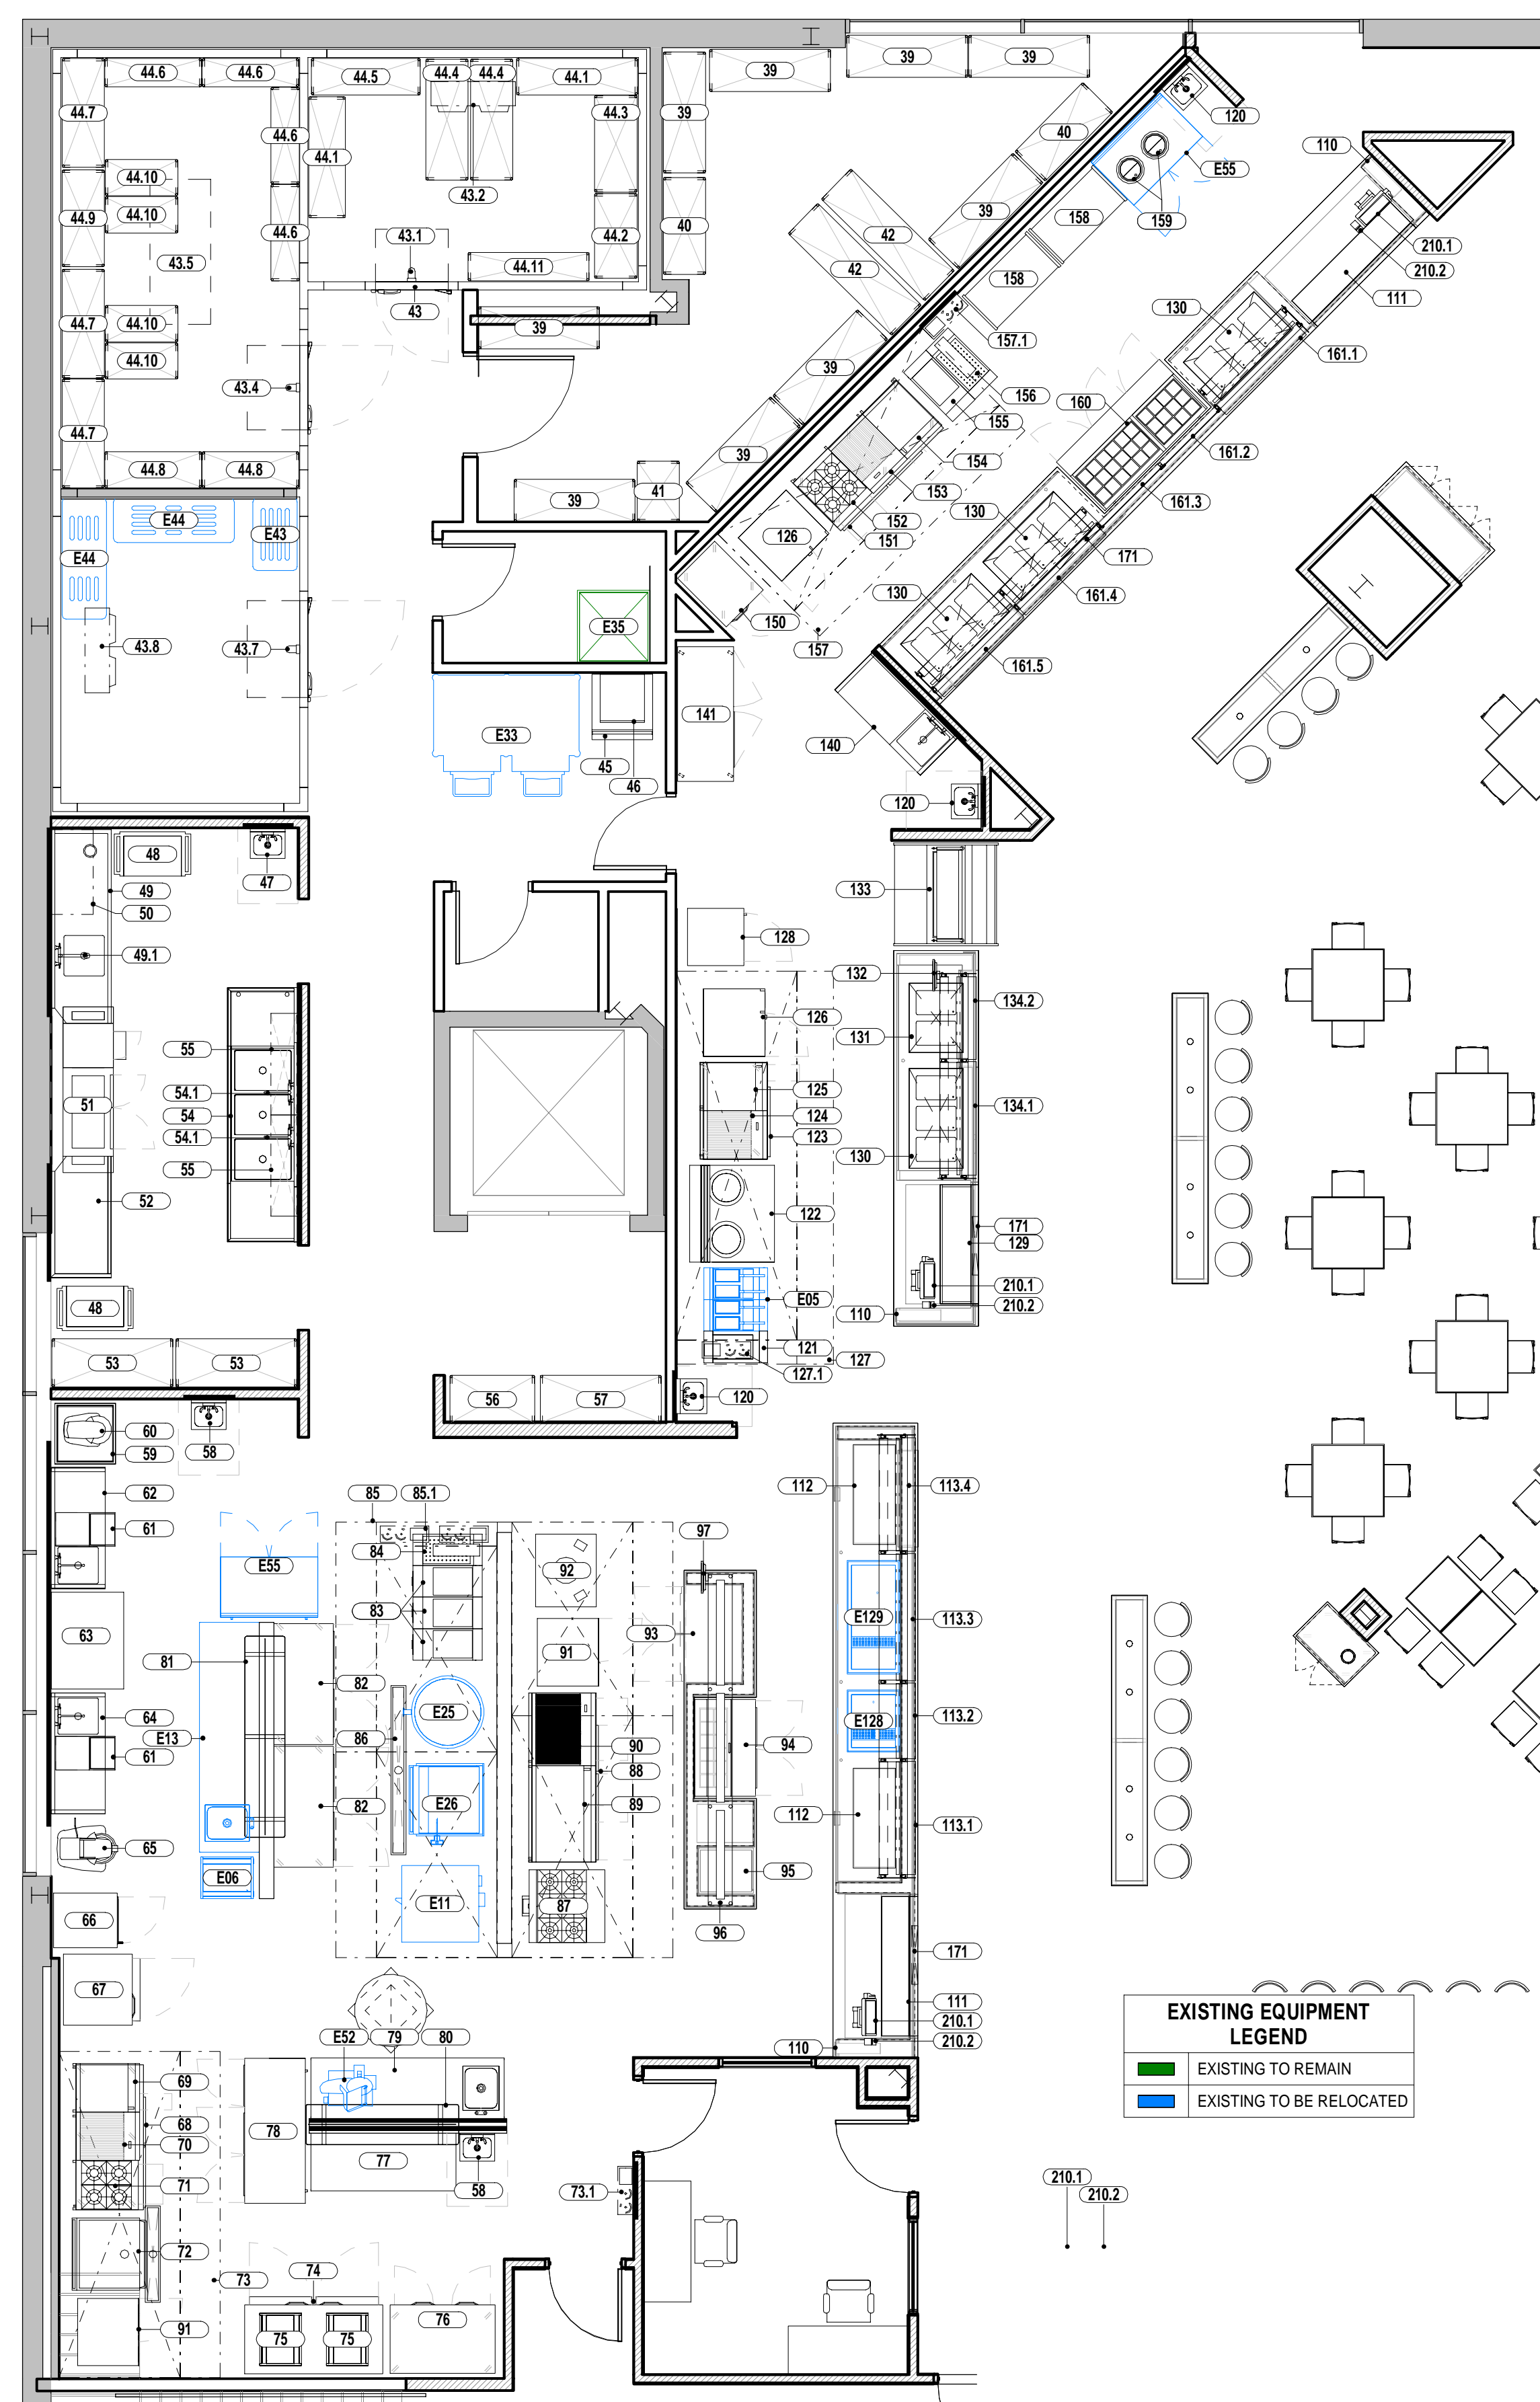

**SUNY PURCHASE COLLEGE**

## CAFE ADDITION AND RENOVATION

735 ANDERSON HILL RD  
PURCHASE, NY 10577

[illegible]

0541		
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ISSUED FOR: DD REVIEW
ISSUED DATE: 1.19.2017
DRAWN BY: R.Schneider
CHECKED BY: KPF
PROJECT NUMBER: CW-0205-4
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FOODSERVICE  
EQUIPMENT -  
ENLARGED AREAS

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Q111