

# SUNY PURCHASE COLLEGE CAFE ADDITION AND RENOVATION

735 ANDERSON HILL RD PURCHASE, NY 10577



ISSUED FOR: BID, 02.16.2018

PROJECT DESCRIPTION:



LOCUS PLAN



ADDITION TO THE STUDENT DINING 735 ANDERSON HILL RD PURCHASE, NY 10577 **ARCHITECT** PHASE ZERO DESIGN 8 WILCOX STREET T: 860.264.1624 PROJECT MANAGER: CHRIS MILLIARD E-MAIL: cmilliard@phasezerodesign.com CIVIL ENGINEER **DOUCET & ASSOCIATES** 136 WEST ST. #103 NORTHAMPTON, MA, 01060 T: 413.208.2349 CONTACT: LARRY RUSIECKI E-MAIL: Irusiecki@doucetengineers.com

**OWNER** 

SUNY PURCHASE COLLEGE

MEP ENGINEER

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ISSUED FOR: BID ISSUED DATE: 02.16.2018

DRAWN BY: JW CHECKED BY: CM

PROJECT NUMBER: 1517347

TITLE SHEET

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33 NORTH PLAINS INDUSTRIAL ROAD T: 732.280.5623 THE PROJECT CONSISTS OF THE CONTACT: PETER PYCELA FOLLOWING WORK: E-MAIL: ppycela@iesllc.biz LIMITED LOCAL DEMOLITION ONLY AS STRUCTURAL ENGINEER NEEDED FOR NEW CONSTRUCTION. SZEWCZAK ASSOCIATES STRUCTURAL EXISTING DINING SPACE (BUILDING **ENGINEERS** •EXISTING/ MODIFIED ROOF PER NEW HVAC 200 FISHER DRIVE AVON, CT, 06001 •EXISTING/ MODIFIED FIRE PROTECTION T: 860.677.4570 •NEW INTERIOR PARTITIONS AND DOORS CONTACT: RICH SZEWCZAK •NEW SPECIALITY EQUIPMENT & CONNECTIONS •NEW PLUMBING AND FLOOR **DESIGN CONSULTANT PENETRATIONS** •NEW AIR HANDLING UNITS AND DISTRIBUTION 305 FOSTER AVE, SUITE 100 •NEW ELECTRICAL DISTRIBUTION T: 704.405.3106 THE HUB AT PURCHASE COLLEGE CONTACT: KEITH FENNELLY E-MAIL: keith@visionbuildersusa.com PROJECT DESCRIPTION PROJECT TEAM **KEY PLAN** 

1. ALL WORK SHALL CONFORM TO FEDERAL, STATE AND MUNICIPAL CODES, LAWS, ORDINANCES, RULES, AND REGULATIONS. THESE SHALL SUPERSEDE DRAWINGS, NOTES AND DIMENSIONS IN ALL CASES. THE ARCHITECT SHALL BE NOTIFIED OF SUCH CHANGES BEFORE WORK IS STARTED. CONTRACTOR SHALL OBTAIN PERMITS BEFORE STARTING WORK, AND OBTAIN APPROVALS OF ALL REGULATORY AGENCIES UPON COMPLETION, AND AS REQUIRED

2. THE CONTRACT DOCUMENTS CONSIST OF THE DRAWINGS, GENERAL CONDITIONS OF THE CONTRACT FOR CONSTRUCTION, OWNER-CONTRACTOR AGREEMENTS AND ALL ADDENDA ISSUED PRIOR TO AND ALL PLAN CHANGES ISSUED AFTER EXECUTION OF THE PROJECT MANUAL.

3. UNLESS OTHERWISE INDICATED IN THE CONSTRUCTION DOCUMENTS AS BEING NOT IN CONTRACT (N.I.C.) OR EXISTING: ALL ITEMS, MATERIALS AND INSTALLATION OF SAME ARE A PART OF THE CONTRACT DEFINED BY THE CONSTRUCTION DOCUMENTS. THE CONTRACTOR SHALL PROVIDE AND INSTALL ALL ACCESSORIES, COMPONENTS AND ASSEMBLIES

4. GENERAL CONTRACTOR SHALL SUBMIT A DETAILED PROJECT SCHEDULE AND IS SOLELY RESPONSIBLE FOR CONSTRUCTION SEQUENCING, METHODS AND TECHNIQUES.

5. THE GENERAL CONTRACTOR IS RESPONSIBLE FOR PAYING FOR AND OBTAINING ALL PERMITS, INSPECTIONS, REQUIRED OF PERSONS, PROPERTY AND ENVIRONMENTAL PROTECTION. TESTS AND UTILITY CONNECTIONS, TERMINATIONS, AND CAPPING UNLESS OTHERWISE NOTED.

6. ANY WORK INVOLVING ALTERATIONS TO EXISTING BUILDING UTILITIES & WHICH REQUIRE UTILITY SHUT DOWN, SHALL COORDINATED WITH THE OWNER AND SHALL REQUIRE A MIN. OF (5) FIVE DAYS NOTICE.

7. IN THE EVENT OF DISCREPANCIES IN THE DRAWINGS, THE COSTLIER OR MORE RESTRICTIVE CONDITIONS SHALL BE DEEMED THE CONTRACT REQUIREMENT, UNLESS OTHERWISE STATED IN WRITING, FROM THE OWNER OR OWNER'S REPRESENTATIVE. ANY DISCREPANCIES SHOULD IMMEDIATELY BE BROUGHT TO THE ATTENTION OF THE ARCHITECT.

8. GENERAL CONTRACTOR SHALL WARRANT WORK PERFORMED FOR A PERIOD OF ONE YEAR FROM THE DATE OF FINAL

9. IT SHALL BE THE RESPONSIBILITY OF THE GENERAL CONTRACTOR TO KEEP THE PREMISES CLEAN OF DEBRIS, RUBBISH, | 8. REMOVE FROM SITE DAILY AND LEGALLY DISPOSE OF REFUSE, DEBRIS, RUBBISH, AND OTHER MATERIALS EXCESS MATERIALS, ETC. RESULTING FROM THE WORK OF THIS CONTRACT. OFFICE AREAS SHALL BE BROOM CLEAN EACH RESULTING FROM DEMOLITION OPERATIONS. AND LEAVE ALL AREAS BROOM CLEAN DAILY. WORK DAY. AT THE END OF THE JOB THE SPACE SHALL BE BROOM CLEANED ONE LAST TIME WITH ALL LABELS, STICKERS, PAINT AND WRAPPING MATERIALS REMOVED FROM FIXTURES, WINDOWS AND FLOORS AS TO REQUIRE ONLY NORMAL WASHING AND CLEANING PRIOR TO THE TURNOVER OF THE SPACE TO THE TENANT

10. CHARGES FOR EXTRA WORK DONE BY THE CONTRACTOR WILL NOT BE HONORED UNLESS THE WORK AND THE AMOUNT ARE AGREED TO BY THE OWNER, OR THEIR AGENT, IN WRITING BEFORE THE WORK IS DONE, BASED UPON UNIT

11. AS REQUIRED BY CODE, EACH CONTRACTOR AND EACH SUBCONTRACTOR SHALL OBTAIN REQUIRED INSPECTION OF THAT PORTION OF WORK.

12. CONTRACTOR TO COORDINATE WORK WITH THE CITY/OWNER, INCLUDING SCHEDULING TIME AND LOCATIONS FOR DELIVERIES, BUILDING ACCESS, USE OF BUILDING SERVICES AND FACILITIES, AND USE OF ELEVATORS. COORDINATE WORK 15.GC TO VERIFY THE REMOVAL OF ELECTRICAL, MECHANICAL, AND PLUMBING ELEMENTS DO NOT IMPACT THE WITH OTHER CONTRACTS. MINIMIZE DISTURBANCE OF BUILDING FUNCTIONS AOCCUPANTS, INCLUDING TRASH REMOVAL ACCESS.

13. OWNER WILL PROVIDE WORK NOTED "BY OTHERS" OR "NIC" UNDER SEPARATE CONTRACT. CONTRACTOR TO INCLUDE SCHEDULE REQUIREMENTS IN CONSTRUCTION PROGRESS SCHEDULE AND COORDINATE TO ASSURE ORDERLY SEQUENCE 16. COORDINATE REMOVAL AND / OR RELOCATION OF MECHANICAL UNITS IN PLENUM SPACE WITH MEP OF INSTALLATION.

14. CONTRACTOR TO MAINTAIN EXITS, EXIT LIGHTING, FIRE PROTECTIVE DEVICES, AND ALARMS IN CONFORMANCE WITH CODES AND ORDINANCES.

15. CONTRACTOR TO PROTECT AREA OF WORK AND ADJACENT AREAS FROM DAMAGE. CONTRACTOR TO COORDINATE

16. CONTRACTOR TO MAINTAIN WORK AREAS SECURE AND LOCKABLE DURING CONSTRUCTION. COORDINATE WITH COUNTY TO PROVIDE SECURITY.

17. PARTITIONS ARE DIMENSIONED FROM FACE OF FRAMING TO FACE OF FRAMING/MASONRY/ FOUNDATION, UNLESS

OTHERWISE NOTED. MAINTAIN DIMENSIONS MARKED "CLEAR". ALLOW FOR THICKNESS OF FINISHES.

18. WHERE EXISTING ACCESS PANELS CONFLICT WITH CONSTRUCTION. CONTRACTOR TO RELOCATE PANELS TO ALIGN WITH AND FIT WITHIN NEW CONSTRUCTION.

19. CONTRACTOR TO UNDERCUT DOORS TO CLEAR TOP OF FLOOR FINISHES BY 1/4 INCH, U.O.N.

20. CONTRACTOR SHALL PROVIDE CONSTRUCTION BARRICADES OR FENCING AS REQUIRED AND AS APPROVED BY THE CITY FOR PUBLIC SAFETY PRIOR TO COMMENCING THE WORK.

21. CONTRACTOR SHALL PROVIDE TEMPORARY EXIT SIGNS TO ASSURE A MEANS OF EGRESS DURING CONSTRUCTION

22. WHERE A TYPICAL CONDITION IS DETAILED, IT SHALL BE UNDERSTOOD THAT ALL LIKE OR SIMILAR CONDITIONS ARE THE 22.GC TO MAINTAIN CLEAR PATHWAY TO EXISTING ELECTRICAL PANELS. PANELS MAY NEED TO BE ACCESSED BY SAME UNLESS SPECIFICALLY NOTED OR DETAILED OTHERWISE.

23. GENERAL CONTRACTOR SHALL COORDINATE SITE PLUMBING, DRAINAGE, ELECTRICAL, TELEPHONE WORK AND EXISTING UTILITIES TO PROVIDE A COMPLETE OPERATING SYSTEM.

24. CONTRACTOR SHALL PROVIDE AND INSTALL ALL STIFFENERS, BRACING, BLOCKING, BACK-UP PLATES AND SUPPORTING BRACKETS REQUIRED FOR THE INSTALLATION OF ALL CASEWORK, TOILET ROOM ACCESSORIES, FIXTURES AND PARTITIONS AND ALL WALL MOUNTED OR SUSPENDED MECHANICAL, ELECTRICAL OR MISCELLANEOUS EQUIPMENT AND FURNISHINGS.

25. ALL WORK PERFORMED SHALL COMPLY WITH THE CONTRACT DOCUMENTS. DRAWINGS AND SPECIFICATIONS. INCLUDING THESE GENERAL NOTES. THE CONTRACTOR SHALL COORDINATE THE INTENT OF THE GENERAL NOTES WITH AL

26. SPECIFICATIONS, BOUND SEPARATELY, ARE PART OF THE CONTRACT DOCUMENTS.

27. THE ORGANIZATION OF THE DRAWINGS AND SPECIFICATIONS SHALL NOT CONTROL THE CONTRACTOR IN DIVIDING THE SHALL BE ABANDONED. WORK AMONG SUBCONTRACTORS OR IN ESTABLISHING THE EXTENT OF WORK TO BE PERFORMED BY ANY TRADE.

28. ALL MATERIALS AND WORKMANSHIP SHALL CONFORM TO THE DRAWINGS AND SPECIFICATIONS. IF CONFLICT IS FOUND MAIN OR RISER. NO DEAD ENDS SHALL REMAIN LONGER THAN TWO (2) FEET. BETWEEN DRAWINGS, GENERAL NOTES AND SPECIFICATIONS, CONSULT THE ARCHITECT FOR CLARIFICATION BEFORE PROCEEDING WITH THE WORK.

29. THE STRUCTURAL, MECHANICAL AND ELECTRICAL DRAWINGS ARE SUPPLEMENTARY TO THE ARCHITECTURAL DRAWINGS. IT SHALL BE THE RESPONSIBILITY OF THE CONTRACTOR TO CHECK WITH THE ARCHITECTURAL DRAWINGS BEFORE THE INSTALLATION OF STRUCTURAL, MECHANICAL AND ELECTRICAL WORK, SHOULD THERE BE A DISCREPANCY BETWEEN THE ARCHITECTURAL DRAWINGS AND THE CONSULTING ENGINEERS' DRAWINGS THAT WOULD CAUSE AN AWKWARD INSTALLATION, IT SHALL BE BROUGHT TO THE ENGINEER'S ATTENTION FOR CLARIFICATION PRIOR TO INSTALLATION OF SAID WORK. ANY WORK INSTALLED IN CONFLICT WITH THE ARCHITECTURAL DRAWINGS SHALL BE CORRECTED BY THE CONTRACTOR AT NO ADDITIONAL COST.

30. NO DEVIATION FROM CONTRACT DRAWINGS AND SPECIFICATIONS SHALL BE MADE WITHOUT WRITTEN APPROVAL OF THE DESIGN PROFESSIONAL.

31. G.C. TO PROVIDE <u>LEVEL 4</u> DRYWALL FINISH THROUGHOUT SPACE U.O.N.

32. ALL DEMOLITION IS AS REQUIRED FOR NEW CONSTRUCTION.

33. ALL MATERIAL TO BE NEW UNLESS OTHERWISE NOTED "EXISTING".

34. MEANS AND METHODS ARE THE SOLE RESPONSIBILITY OF THE GENERAL CONTRACTOR 35. VERIFY KEYING REQUIREMENTS OF ALL LOCKS, BOTH NEW AND EXISTING, WITH OWNER.

36. IF REQUIRED UPON COMPLETION OF THE PROJECT, CONTRACTOR SHALL OBTAIN A CERTIFICATE OF OCCUPANCY FROM THE BUILDING DEPARTMENT

### **DEMOLITION NOTES**

1. THE TERM "PATCH AND REPAIR" SHALL BE DEFINED AS: THE PROCESS OF REPAIRING FLOOR. WALL. OR CEILING SURFACES THAT HAVE BEEN DAMAGED OR ARE ADJACENT TO DEMOLISHED CONSTRUCTION. THE REPAIR SHALL INCLUDE, BUT NOT BE LIMITED TO: FILLING VOIDS SOLID WITH CONCRETE, PREPARING SURFACES FOR NEW FINISH MATERIAL PER MANUFACTURER'S RECOMMENDATIONS, MATCH EXISTING FINISHES AND MATERIALS WHERE NO NEW FINISHES ARE CALLED FOR, CLOSING WALL, FLOOR OR ROOF PENETRATIONS AS DIRECTED BY ARCHITECT.

2. THE TERM "SALVAGE" SHALL BE DEFINED AS: THE PROCESS OF THE CONTRACTOR CAREFULLY REMOVING THE MENTIONED ITEM, SUCH THAT IT IS IN A USABLE CONDITION, AND STORING IT (IN LOCATION DETERMINED BY OWNER) UNTIL NEEDED FOR THE CONSTRUCTION PHASE. IF THE CLIENT DOES NOT NEED SAID ITEM CONTRACTOR SHALL DISPOSE OF PROPERLY AT NO ADDITIONAL COST.

3. DEMOLITION CONTRACTOR TO COORDINATE ALL PHASES OF DEMOLITION FOR PROJECT AND NOTIFY ARCHITECT AND AT OF ANY DISCREPANCIES OR CONFLICTING CONDITIONS WHICH WOULD INTERFERE WITH THE SATISFACTORY COMPLETION OF THE WORK, PRIOR TO THE START OF CONSTRUCTION.

4. COMPLY WITH APPLICABLE LOCAL, STATE AND FEDERAL CODES AND REGULATIONS PERTAINING TO SAFETY

GC TO VERIFY WITH PROPERTY MANAGER REQUIREMENTS FOR CONSTRUCTION BARRIER. PROVIDE AND MAINTAIN BARRICADES, LIGHTING, AND GUARDRAILS AS REQUIRED BY APPLICABLE CODES AND REGULATIONS TO PROTECT OCCUPANTS OF BUILDING AND WORKERS.

6. ERECT AND MAINTAIN DUSTPROOF PARTITIONS AS REQUIRED TO PREVENT SPREAD OF DUST, FUMES, AND SMOKE, ETC. TO OTHER PARTS OF THE BUILDING. ON COMPLETION, REMOVE PARTITIONS AND REPAIR DAMAGED SURFACES TO MATCH ADJACENT SURFACES.

7. IF DEMOLITION IS PERFORMED IN EXCESS OF THAT REQUIRED, RESTORE EFFECTED AREAS AT NO COST TO

9. REMOVE DESIGNATED PARTITIONS, COMPONENTS, BUILDING EQUIPMENT, AND FIXTURES AS REQUIRED FOR NEW WORK. RETURN ALL F.F.& E. ITERMS TO THE OWNER.

10. REMOVE ABANDONED ELECTRICAL, TELEPHONE AND DATA CABLING AND DEVICES, U.O.N.

12. REF. ARCHITECTURAL AND MEP DRAWINGS. COORDINATE SCOPE OF DEMOLITION WITH ARCH AND MEP. 13. REMOVE ALL CEILING, GRID, LIGHTS FIXTURES, SUPPORTS AND BRACING THROUGHOUT, U.O.N.

14. DEMO ALL EXISTING FINISHES THROUGHOUT. PREP SLAB AS REQUIRED FOR NEW FINISHES.

REMAINING AREAS OUTSIDE OF CONSTRUCTION SCOPE.

DRAWINGS. RELOCATION OF UNITS REQUIRED BY NEW CONSTRUCTION SHALL BE COORDINATED WITH DEMOLITION WORK.

17. REMOVE ABANDONED HVAC EQUIPMENT, INCLUDING DUCT WORK. DEMO EXISTING MECHANICAL DUCTS BACK TO MAIN TRUNK, VERIFY WITH MEP PRIOR TO THE START OF ANY MECHANICAL DEMO WORK.

18. REMOVE ALL ABANDONED SMOKE FIRE DAMPERS AS REQUIRED BY NEW CONSTRUCTION, INCLUDING ALL ELECTRICAL AND CONNECTIONS.

19. CONTRACTOR SHALL MAINTAIN THE INTEGRITY AND CONTINUITY OF THE EXIST. BASE BUILDING SYSTEMS AND SHALL EXERCISE CARE BY NOT DEMOLISHING, OR DISRUPTING ANY BASE BUILDING SYSTEMS. ANY DAMAGED AND/OR DISCONNECTED SERVICE SHALL BE RESTORED AT CONTRACTOR'S COST.

20. REMOVE ALL LIGHT FIXTURES, EXIT SIGNS, LIGHT SWITCHES, POWER AND TELE/DATA OUTLETS, REMOVE ALL BRANCH CIRCUIT FEEDERS, INCLUDING CONDUITS, BOXES AND WIRING BACK TO ELECTRICAL PANELBOARDS. CONTRACTOR SHALL SWITCH ALL SPARE BREAKERS TO OFF POSITION FOR FUTURE REFERENCE. ALL ABANDONED CONDUIT AND CABLING SHALL BE COMPLETELY REMOVED BACK TO ORIGIN.

21. MAINTAIN CIRCUIT CONTINUITY TO AREAS NOT AFFECTED BY WORK. CONTRACTOR SHALL REWORK BRANCH FEEDER HOME-RUNS AS REQUIRED TO KEEP CONTINUITY TO EXISTING LIGHT FIXTURES, EXIT SIGNS AND DEVICES IN AREAS NOT BE DEMOLISHED.

COLLEGE.

23. GC TO GIVE A MINUMUM OF 72 HOUR NOTICE TO COLLEGE PRIOR TO ANY SHUTDOWNS.

24. IN DEMOLITION AREAS. UNUSED PIPING SHALL NOT BE ABANDONED "IN PLACE". PIPING SHALL BE REMOVED BACK TO SOURCE OR POINT OF DISCHARGE, AND THE RESULTING OPENINGS PLUGGED U.N.O.

25. EXISTING PLUMBING FIXTURES AND EQUIPMENT TO BE REMOVED SHALL BE DISPOSED OF BY THIS CONTRACTOR AS DIRECTED BY THE OWNER.

26. DISCONNECT AND REMOVE EXISTING UNUSED PIPING AND FIXTURES WITHOUT INTERRUPTING EXISTING REQUIRED FUNCTIONING SYSTEMS.

27. UNUSED PIPING AND RELATED ITEMS CONCEALED IN WALLS, FLOORS AND CEILING WITHIN THE STRUCTURE

28. WASTE AND SANITARY DRAINAGE PIPING NOT TO BE USED SHALL BE REMOVED AND PLUGGED AT ACTIVE

### FIRE ALARM

29. ALL EXISTING FIRE ALARM EQUIPMENT TO REMAIN. WALL MOUNTED EQUIPMENT (I.E. HORN/STROBE) SHALL BE REMOVED PRIOR TO DEMOLITION OF WALL FINISH MATERIALS AN SALVAGED FOR REINSTALLATION AFTER THE NEW WALL FINISH MATERIAL HAVE BEEN INSTALLED.

### **TURNOVER NOTES**

1. THE CONTRACTOR SHALL ARRANGE FOR ALL INSPECTIONS AND FURNISH OWNER'S REPRESENTATIVE WITH THE CERTIFICATE OF OCCUPANCY. G.C. IS ALSO TO PROVIDE A TYPE-WRITTEN LIST OF NAMES, ADDRESSES AND PHONE NUMBERS OF ALL SUBCONTRACTORS AND MATERIAL SUPPLIERS.

2. THE CONTRACTOR SHALL BE RESPONSIBLE FOR HAVING THE ENTIRE SPACE CLEANED TO THE SATISFACTION OF THE OWNER'S REPRESENTATIVE AT THE TIME OF TURNOVER.

3. PRIOR TO OPENING OF SPACE. CONTRACTOR IS TO ARRANGE FOR A NEBB CERTIFIED INDEPENDENT BALANCING CONTRACTOR TO BALANCE THE HVAC SYSTEM AND PROVIDE A COPY OF THE BALANCING REPORT TO THE OWNER AND LANDLORD'S REPRESENTATIVE IN A FORMAT ACCEPTABLE TO THE LANDLORD.

4. CONTRACTOR TO TURN OVER ALL KEYS TO THE OWNER'S REPRESENTATIVES AND MARK EACH KEY FOR IDENTIFICATION.

5. THE CONTRACTOR SHALL SET ALL THE TIME CLOCKS, THERMOSTATS, ETC. PER THE REQUIREMENTS OF THE OWNER'S REPRESENTATIVE.

6. THE CONTRACTOR SHALL EXPLAIN THE OPERATION OF ALL MECHANICAL SYSTEMS TO THE OWNER'S REPRESENTATIVE AND PROVIDE COPIES OF OPERATION, MAINTENANCE AND WARRANTY MANUALS.

7. GENERAL CONTRACTOR SHALL SUBMIT ONE COMPLETE SET OF REPRODUCIBLE DRAWINGS INDICATING ALL DISCREPANCIES, CHANGES, ETC. AND ACTUAL LOCATIONS OF CONCEALED WORK (I.E., UNDERGROUND CONDUIT) TO THE OWNER'S REPRESENTATIVE. THE GENERAL CONTRACTOR SHALL ALSO SUBMIT A PHOTOCOPY OF THE ACTUAL PANEL DIAGRAM.

8. THE GENERAL CONTRACTOR AND ALL SUBCONTRACTORS SHALL WARRANTY THE WORK FOR A PERIOD OF ONE YEAR FROM THE DATE OF FINAL ACCEPTANCE BY TENANT OF FINISHED WORK.

9. THE GENERAL CONTRACTOR SHALL INSTALL NEW FILTERS IN THE HVAC UNITS ONE WEEK PRIOR TO TURNOVER OF

## **ACCESSIBILITY NOTES**

. IN ALL BUILDINGS, FLOORS OF A GIVEN STORY SHALL BE A COMMON LEVEL THROUGHOUT, OR SHALL BE CONNECTED BY PEDESTRIAN RAMPS, PASSENGER ELEVATORS OR SPECIAL ACCESS LIFTS.

2. FLOOR SURFACES SHALL BE SLIP-RESISTANT.

3. ALL CORRIDORS SERVING AN OCCUPANT LOAD OF 10 OR MORE SHALL BE NOT LESS THAN 44" IN WIDTH.

4. ABRUPT CHANGES IN LEVEL ALONG ANY ACCESSIBLE ROUTE SHALL NOT EXCEED 1/2" IN HEIGHT. LEVEL CHANGES NOT EXCEEDING 1/4" MAY BE VERTICAL. BEVEL OTHERS W/ A SLOPE NO GREATER THAN 1:2

5. LATCHING AND LOCKING DOORS THAT ARE HAND ACTIVATED AND WHICH ARE IN A PATH OF TRAVEL SHALL BE OPERABLE WITH A SINGLE EFFORT BY LEVER TYPE HARDWARE, PANIC BARS, PUSH-PULL ACTIVATING BARS, OR OTHER HARDWARE DESIGNED TO PROVIDE PASSAGE WITHOUT REQUIRING THE ABILITY TO GRASP THE OPENING HARDWARE. MOUNT DOOR OPENING HARDWARE BETWEEN 30" AND 44" ABOVE FLOOR FINISH.

6. CENTER HAND ACTIVATED DOOR OPENING HARDWARE BETWEEN 30" AND 44" ABOVE THE FLOOR

7. MAXIMUM PULL OR PUSH EFFORT TO OPERATE DOORS SHALL NOT EXCEED 5 POUNDS FOR EXTERIOR DOORS AND 5 POUNDS FOR INTERIOR DOORS, MEASURED AT RIGHT ANGLES TO HINGED DOORS AND AT CENTER PLANE OF SLIDING OR FOLDING DOORS. CORRESPONDING DEVICES OR AUTOMATIC DOOR OPERATORS MAY BE UTILIZED TO MEET THE ABOVE STANDARDS. MAXIMUM EFFORT TO OPERATE REQUIRED FIRE DOORS MAY BE INCREASED NOT TO

8. THE BOTTOM 10" OF ALL DOORS (EXCEPT SLIDING AND AUTOMATIC) SHALL HAVE A SMOOTH UNINTERRUPTED SURFACE TO ALLOW THE DOOR TO BE OPENED BY A WHEELCHAIR FOOTREST WITHOUT CREATING A TRAP OR HAZARDOUS CONDITION. PROVIDE A 10" HIGH SMOOTH PANEL ON THE PUSH SIDE OF NARROW FRAME DOORS.

9. EVERY REQUIRED ENTRANCE OR PASSAGE DOORWAY SHALL BE NOT LESS THAN 3' IN WIDTH AND NOT LESS THAN 6'-8" IN HEIGHT. DOORS SHALL BE CAPABLE OF OPENING AT LEAST 90 DEGREES AND SHALL BE SO MOUNTED THAT THE CLEAR WIDTH OF THE DOORWAY IS NOT LESS THAN 32".

11. IDENTIFY ACCESSIBLE ENTRANCES WITH AT LEAST ONE STANDARD SIGN AND WITH ADDITIONAL DIRECTIONAL

LENGTH OPPOSITE THE DIRECTION OF DOOR SWING OF 44" AS MEASURED AT RIGHT ANGLES TO THE PLANE OF

10. WHERE A PAIR OF DOORS IS UTILIZED, AT LEAST ONE OF THE DOORS SHALL PROVIDE A CLEAR, UNOBSTRUCTED OPENING WIDTH OF 32" WITH THE LEAF POSITIONED AT AN ANGLE OF 90 DEGREES FROM ITS CLOSED POSITION.

SIGNS, AS REQUIRED, VISIBLE FROM APPROACHING PEDESTRIAN WAYS. 12. THE FLOOR OR LANDING ON EACH SIDE OF AN ENTRANCE OR PASSAGE DOOR SHALL BE LEVEL AND CLEAR. THE LEVEL AND CLEAR AREA SHALL HAVE A LENGTH IN THE DIRECTION OF DOOR SWING OF AT LEAST 60" AND THE

THE DOOR IN ITS CLOSED POSITION. 13. FLOORS OR LANDINGS SHALL BE NO MORE THAN 1/2" LOWER THAN THE THRESHOLD OF THE DOORWAY. CHANGE IN LEVEL BETWEEN 1/4" AND 1/2" SHALL BE BEVELED WITH A SLOPE NO GREATER THAN 1:2.

14. PROVIDE A CLEAR FLOOR SPACE 30" X 48" IN FRONT OF LAVATORY TO PERMIT A FORWARD APPROACH.

15. MOUNT LAVATORIES WITH A MINIMUM CLEARANCE OF 29" FROM THE FLOOR TO THE BOTTOM OF THE APRON. PROVIDE KNEE CLEARANCE UNDER THE FRONT LIP EXTENDING A MINIMUM OF 30" IN WIDTH WITH 8" MINIMUM WIDTH, AND SHALL BE A MINIMUM OF 9" HIGH FROM THE FLOOR A MINIMUM OF 17" DEEP FROM THE FRONT OF THE LAVATORY.

16. FAUCET CONTROLS AND OPERATING MECHANISMS SHALL BE OPERABLE WITH ONE HAND AND SHALL NOT REQUIRE TIGHT GRASPING, PINCHING OR TWISTING OF THE WRIST. THE FORCE REQUIRED TO ACTIVATE CONTROLS SHALL BE NO GREATER THAN 5 POUNDS. LEVER OPERATED, PUSH TYPE AND ELECTRONICALLY CONTROLLED MECHANISMS ARE EXAMPLES OF ACCEPTABLE DESIGNS. SELF CLOSING ARE ALLOWED IF THE FAUCET REMAINS OPEN FOR AT LEAST 10 SECONDS.

17. INSULATE OR OTHERWISE COVER HOT WATER AND DRAIN PIPES UNDER LAVATORIES.

18. IF APPLICABLE, LOW DRINKING FOUNTAIN BUBBLER SHALL BE ACTIVATED BY ANNUALLY OPERATED SYSTEM NOT REQUIRING A FORCE GREATER THAN 51bf THAT IS LOCATED WITHIN 6 INCHES OF THE FRONT EDGE OF THE FOUNTAIN OR AN ELECTRONICALLY CONTROLLED DEVICE.

19. IF APPLICABLE, THE BUBBLER OUTLET ORIFICE SHALL BE LOCATED WITHIN 6" OF THE FRONT OF THE LOW DRINKING FOUNTAIN AND SHALL BE WITHIN 36" OF THE FLOOR. THE WATER STREAM FROM THE BUBBLER SHALL BE SUBSTANTIALLY PARALLEL TO THE FRONT EDGE OF THE DRINKING FOUNTAIN.

### **QUALITY ASSURANCE/ QUALITY CONTROL NOTES**

. THE G.C. SHALL REVIEW ALL DOCUMENTS AND CONFIRM THAT THE WORK CAN BE BUILT AS SHOWN. IN THE EVENT OF ANY CONFLICTS OR OMISSIONS WITHIN THE DRAWINGS, G.C. TO CONTACT TENANT'S PROJECT MANAGER & ARCHITECT FOR CLARIFICATION PRIOR TO THE PERFORMANCE OF ANY WORK IN QUESTION.

2. UPON POSSESSION OF THE TENANT'S SPACE, THE G.C. IS TO FIELD VERIFY ALL DIMENSIONS USING THE CONSTRUCTION DOCUMENTS. <u>DO NOT SCALE THE DRAWINGS</u>. DIMENSIONS SHALL TAKE PRECEDENCE OVER SCALES SHOWN ON DRAWINGS. IF ANY DISCREPANCIES EXIST, G.C. TO MARK UP THE DRAWINGS TO REFLECT THE ACTUAL CONDITION. FORWARD THEM TO THE ARCHITECT WITHIN (3) DAYS FOR REVIEW & CLARIFICATION AS REQUIRED.

3. UPON POSSESSION OF THE TENANT'S SPACE AND PRIOR TO SUBMITTING BIDS, THE G.C. IS TO VERIFY THE EXISTING CONDITIONS OF THE SPACE INCLUDING BUT NOT LIMITED TO SLAB CONDITION AND ANY ISSUES THAT MAY EFFECT TENANT'S NEW FINISH FLOOR. CONDITION OF LANDLORD'S DEMISING WALL AND ANY OBSTRUCTIONS THAT MAY EXIST AND BE OF ISSUE. IF ANY ISSUES EXIST, CONTACT ARCHITECT AND TENANT'S PROJECT MANAGER.

4. DRAWINGS ARE INTENDED TO CONVEY DESIGN INTENT ONLY. CONTRACTOR AND/OR FABRICATOR SHALL HAVE SOLE RESPONSIBILITY FOR CONSTRUCTION MEANS, METHODS, TECHNIQUES, SEQUENCES AND PROCEDURES AND FOR COORDINATING ALL PORTIONS OF THE WORK TO PRODUCE THE INTENT OF THE DRAWINGS. CONTRACTOR/FABRICATOR IS SOLELY RESPONSIBLE FOR STRUCTURAL INTEGRITY AND PERFORMANCE OF ALL

5. ANY DEVIATION FROM THE INTENT OF THE DRAWINGS MUST BE APPROVED BY ARCHITECT & TENANT'S CONSTRUCTION MANAGER.

6. CONTRACTOR TO CONDUCT SITE MEETINGS AND WRITE MEETING MINUTES AT FREQUENCY AS DIRECTED BY OWNER, UNLESS OTHERWISE DIRECTED BY OWNER OR OWNER'S REPRESENTATIVE. CONTRACTOR AND ALL SUB-CONTRACTORS MUST BE PRESENT, UNLESS WAIVED BY OWNER.

7. CONTRACTOR TO SUBMIT WEEKLY PROGRESS REPORTS THAT INCLUDE A SUMMARY OF THAT WEEK'S WORK, A ONE WEEK LOOK AHEAD FORECAST OF WORK TO BE DONE (INCLUDING INSPECTION IF APPLICABLE), AND GENERAL PHOTOS DEPICTING THE CURRENT STATE OF WORK.

8. EXCEPT AS MORE STRINGENT REQUIREMENTS ARE INDICATED ON THESE DRAWINGS AND IN THESE NOTES. COMPLY WITH GENERALLY ACCEPTED INDUSTRY STANDARDS AND INSTALL PRODUCTS IN STRICT COMPLIANCE WITH MANUFACTURER'S PRINTED INSTRUCTIONS.

9. WHEN EVALUATING APPEARANCE OR CONFORMANCE WITH DESIGN INTENT, THE WORDS "ACCEPTABLE", "VISIBLE" "INVISIBLE", "MATCHING", "ALIGNED", AND SIMILAR TERMS OF JUDGMENT SHALL MEAN "ACCEPTABLE, ETC., IN THE OPINION OF THE ARCHITECT OR OWNER".

10. THE CONTRACTOR SHALL BE RESPONSIBLE FOR REVIEWING AND FAMILIARIZING THEMSELVES WITH ALL DOCUMENTATION RELATED TO OR PERTAINING TO THIS PROJECT INCLUDING BUT NOT LIMITED TO: CONSTRUCTION DRAWINGS (STARTING WITH THE FIRST ISSUE AS WELL AS ALL SUBSEQUENT REVISIONS), SPECIFICATIONS, BULLETINS, ADDENDA AND/OR SKETCHES, SHOP DRAWINGS AND CUT SHEETS. THE CONTRACTOR IS ALSO <u>RESPONSIBLE FOR PROVIDING ALL OF THE BEFORE MENTIONED DOCUMENTATION TO ALL SUB-CONTRACTO</u> TRADES INVOLVED WITH THIS PROJECT AND TO MAKE SURE THEY ARE FAMILIAR WITH ALL CONDITIONS AND SCOPE OF WORK AS THEY RELATE TO THIS JOB. THE BEFORE MENTIONED PROJECT DOCUMENTATION, IN ITS ENTIRETY, REPRESENTS THE FULL SCOPE OF WORK ASSOCIATED WITH THIS PROJECT. AS SUCH, SCOPE OF WORK OR INFORMATION RELATIVE TO A PARTICULAR SUB-CONTRACTOR THAT IS NOT SHOWN ON SPECIFIC TRADE DOCUMENTS (BUT SHOWN ELSEWHERE WITHIN THE PROJECT DOCUMENTATION) DOES NOT RELIEVE THAT SUB-CONTRACTOR OF RESPONSIBILITY FOR INCLUSION OF THAT SCOPE OF WORK OR INFORMATION WITHIN THE SUB CONTRACTOR'S BID.

### **FINISH NOTES**

1. ENSURE SURFACES TO RECEIVE FINISHES ARE CLEAN, TRUE, AND FREE OF IRREGULARITIES. DO NOT PROCEED WITH WORK UNTIL UNSATISFACTORY CONDITIONS HAVE BEEN CORRECTED.

2. REPAIR EXISTING SURFACES TO REMAIN AS REQUIRED FOR APPLICATION OF NEW FINISHES.

3. ANY REQUEST FOR MATERIAL SUBSTITUTIONS ARE TO BE SENT TO ARCHITECT AND/OR CLIENT FOR APPROVAL PRIOR TO PURCHASE AND INSTALLATION. SAMPLES OF ALL FINISHES MUST BE SUBMITTED AND MUST BE APPROVED BY ARCHITECT & TENANT'S CONSTRUCTION MANAGER.

4. WIPE CLEAN ALL SURFACES WITH DAMP CLOTH.

5. RETOUCH OR REFINISH SURFACES DAMAGED BY SUBSEQUENT WORK AS DIRECTED BY GC. THE COST OF SUCH RESTORATION WORK SHALL BE BORNE BY SUB CONTRACTOR.

6. THE GC SHALL BE RESPONSIBLE FOR THE MAINTENANCE OF ALL FINISHES IN THE SPACE PRIOR TO TURNOVER. G.C. SHALL TOUCH UP ALL CORNER BEADS, WALLS, CEILING AND FLOORING AS REQUIRED PRIOR TO TURNOVER AND ANY DAMAGE CAUSED BY OTHER TRADES INCLUDING MILLWORK VENDOR.

7. EXAMINE ALL SURFACES TO BE PAINTED UNDER THIS CONTRACT TO VERIFY THAT WORK OF OTHER TRADES IS IN SATISFACTORY CONDITION TO RECEIVE SPECIFIED FINISH.

8. USE CLEAR CAULK BETWEEN MILLWORK AND GWB IF REQUIRED TO CREATE A SMOOTH FINISH.

9. GYPSUM WALL BOARD SURFACES SHALL BE WIPED WITH A DAMP CLOTH JUST PRIOR TO APPLICATION OF THE FIRST COAT OF PAINT IN ORDER TO LAY FLAT ANY NAP WHICH MAY HAVE FORMED IN SANDING. 10. PAINTING SUBCONTRACTOR IS RESPONSIBLE FOR THE PROTECTION OR REMOVAL & REINSTALLATION

11. ALL PAINTED SURFACES TO RECEIVE (1) COAT PRIMER & (2) COATS FINISH PAINT (MINIMUM) WITH ADDITIONAL COATS AS REQUIRED FOR PROPER COVERAGE.

12. AT COMPLETION OF PAINTING, ALL PAINT MATERIALS & EQUIPMENT SHALL BE REMOVED, ALL PAINT SPOTS REMOVED AND ALL AREAS THOROUGHLY CLEANED. ANY DIRT OR DEBRIS CAUSED BY WORK

ALL FINISHED FLOORING TO BE PROTECTED BY G.C. FOLLOWING INSTALLATION.

OF HARDWARE, SWITCH / OUTLET COVERS, ETC. TO PROTECT FROM PAINTING.

14. ALL INTERIOR FINISHES (WALL, FLOOR, AND CEILING), FURNISHINGS, AND MILLWORK ARE TO BE CLASS 'A' FIRE-RATED AND ARE TO COMPLY WITH CODE-REQUIRED (INTERIOR FLAME SPREAD) RATINGS.

### FIRE / LIFE SAFETY NOTES

SHALL BE CLEANED UP AS WORK PROGRESSES.

1. FIRE PROTECTION EQUIPMENT AND SERVICE ACCESS MUST BE PROVIDED DURING THE CONSTRUCTION PERIOD AS REQUIRED BY THE COUNTY.

2. PROVIDE A PORTABLE FIRE EXTINGUISHER WITH A RATING OF NOT LESS THAN 2-A WITHIN 75 FOOT TRAVEL DISTANCE TO ALL PORTIONS OF THE PROJECT, AND ADDITIONAL EXTINGUISHERS AS REQUIRED BY CAMPUS CODE ENFORCEMENT OFFICER.

3. ALL FIRE-RATED ASSEMBLES SHALL BE INSTALLED, LABELED, AND INSPECTED IN ACCORDANCE WITH THE APPLICABLE BUILDING CODE WHEN REQUIRED.

4. EVERY EXIT DOOR SHALL BE OPERABLE FROM THE INSIDE WITH ONE MOTION THE USE OF A KEY OR ANY SPECIAL KNOWLEDGE OR EFFORT. SPECIAL LOCKING DEVICES SHALL BE OF AN APPROVED TYPE. ALL NEW DOORS SHALL HAVE APPROVED LEVER HANDLES.

5. DOORS OPENING INTO REQUIRED 1-HOUR, FIRE-RESISTIVE CORRIDORS SHALL BE PROTECTED WITH A SMOK OR DRAFT STOP ASSEMBLY HAVING A 20-MINUTE RATING AND SHALL BE SELF-CLOSING.

6. 20-MINUTE DOOR JAMBS TO BE TIGHT-FITTING, SMOKE AND DRAFT CONTROLLED.

7. PROVIDE FIRE DAMPERS OR DOORS WHERE AIR DUCTS PENETRATE FIRE-RATED WALLS OR CEILINGS 8. STORAGE, DISPENSING OR USE OF ANY FLAMMABLE OR COMBUSTIBLE LIQUIDS, FLAMMABLE GAS AND

HAZARDOUS SUBSTANCES SHALL COMPLY WITH NEW YORK STATE CODE FIRE CODE REGULATIONS. 9. WOOD BLOCKING SHALL BE FIRE TREATED IN ACCORDANCE WITH APPLICABLE CODE REQUIREMENTS.

10. EXTEND OR MODIFY EXISTING FIRE / LIFE SAFETY SYSTEM AS REQUIRED TO PROVIDE AN APPROVED FIRE / LIFE SAFETY SYSTEM FOLLOWING COLLEGE APPROVAL. SUBMIT PLANS TO COLLEGE WITH COMPLETE DESCRIPTION OF SEQUENCE OF OPERATION, AND OBTAIN APPROVAL PRIOR TO INSTALLATION.

11.LOCATE THE CENTER OF FIRE ALARM INITIATING DEVICES 48" ABOVE THE LEVEL OF THE FLOOR, WORKING PLATFORM, GROUND SURFACE OR SIDEWALK, IN ACCORDANCE WITH APPLICABLE CODE REQUIREMENTS

### REFLECTED CEILING NOTES

SUPPORT LIGHT FIXTURES AND AIR DIFFUSERS DIRECTLY BY WIRES TO THE STRUCTURE ABOVE.

2. LOCATE REGISTERS AND LIGHTING FIXTURES WITHIN GRID LINES. CENTER SPRINKLER HEADS,

SPEAKERS, RECESSED FIXTURES, AND SIMILAR CEILING ELEMENTS IN ACOUSTICAL UNITS, U.O.N. 3. FINISH HVAC DIFFUSERS, TRIM PIECES, AND SPEAKER GRILLES TO MATCH ADJACENT FINISH, U.O.N.

4. ALL LIGHT FIXTURES SHALL BEAR UL LABELS. 5. CONTRACTOR TO USE LASER FOR LEVELING OF ALL SOFFITS, CEILINGS AND SUSPENDED GRIDS.

6. ALL FIXTURES TO BE INSTALLED IN ACOUSTIC CEILINGS TO BE CENTERED IN CEILING GRID, U.O.N.

ACOUSTICAL CEILINGS TO BE 10 GA. 8. HANGER WIRES SHALL BE ATTACHED TO STRUCTURAL STEEL ONLY W/ U.L. LISTED CLAMPS. DO NOT HANG SUPPORT WIRES FROM MECHANICAL EQUIPMENT OR PIPING. NO SCREWS PERMITTED IN METAL

7. HANGER WIRE AT SUSPENDED GYP BD CEILINGS TO BE 8 GA.; HANGER WIRE AT SUSPENDED

9. ALL SUSPENDED CEILING SYSTEMS TO BE INSTALLED PER INDUSTRY STANDARDS, ALL CODE

REQUIREMENTS, AND ALL RECOMMENDATIONS OF THE MANUFACTURER OF THE SYSTEM.

10.ALL LIGHT FIXTURES, HVAC EQUIPMENT AND DIFFUSERS SHALL BE SUPPORTED FROM THE TOP CHORD OF THE JOIST AND/OR STRUCTURAL MEMBERS ABOVE.

11.GC SHALL VERIFY ALL CEILING HEIGHTS, AND CONFIRM THAT THE WORK CAN BE BUILT AS SHOWN. IN

THE EVENT OF ANY CONFLICTS OR OMISSIONS WITHIN THE DRAWINGS, GC TO CONTACT ARCHITECT FOR CLARIFICATION PRIOR TO THE PERFORMANCE OF ANY WORK IN QUESTION.

12. CEILING HEIGHT DIMENSIONS ARE TO FINISHED SURFACES. 13.IF THE SPACE ABOVE THE SUSPENDED CEILING IS USED AS A RETURN AIR PLENUM, THEN ALL EQUIPMENT AND WIRING (COMMUNICATION, POWER ETC) SHALL BE LISTED FOR INSTALLATION IN A PLENUM.

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CONSULTANT

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DESCRIPTION

ISSUED FOR: BID

ISSUED DATE: 02.16.2018

DRAWN BY: JW

RAWING NAME

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GENERAL NOTES

### **MILLWORK NOTES**

- 1. ALL MILLWORK SHALL BE PROVIDED BY OTHERS (N.I.C.), HOWEVER THE GC SHALL BE RESPONSIBLE FOR SCHEUDLING, PREPING, BLOCKING, AND CONNECTING ALL REQUIRED UTILITIES AND EQUIPMENT TO MILL WORK
- 2. MILLWORK CONTRACTOR TO SITE VERIFY ALL DIMENSIONS PRIOR TO CONSTRUCTION.
- 3. TOP OF MILLWORK COUNTERS SHALL NOT EXCEED 34" ON THE PUBLIC SIDE, TYP.
- 4. G.C. IS RESPONSIBLE FOR SUPPLYING & INSTALLING ALL SITE REQUIREMENTS (IN WALL BLOCKING, ETC.) FOR MILLWORK. COORDINATE ALL REQUIREMENTS WITH VENDOR(S).
- 5. SHOP DRAWINGS MUST BE SUBMITTED AND APPROVED BY ARCHITECT & TENANT'S CONSTRUCTION MANAGER FOR APPROVAL PRIOR TO FABRICATION WHEN REQUIRED.
- 6. ALL MILLWORK IS TO CONFORM TO A.W.I./A.W.M.A.C. PREMIUM STANDARDS.
- 7. MILLWORK VENDOR TO COORDINATE WITH OTHER TRADES AND PROVIDE CONCEALED GROUNDS & OR BLOCKING AS REQUIRED. PROVIDE CUTOUTS FOR OUTLETS AND EQUIPMENT AS REQUIRED. VERIFY ALL DIMENSIONS PRIOR TO FABRICATION.
- 8. G.C. TO PROVIDE ADDITIONAL CUTOUTS AS REQUIRED IN VENDOR SUPPLIED MILLWORK. ALL MODIFICATIONS TO BE PERFORMED BY A QUALIFIED FINISH CARPENTER. ALL CUTS TO BE PLACED TO MINIMIZE VISIBILITY. NO ADDITIONAL MODIFICATION TO MILLWORK WILL ABE ALLOWED WITHOUT PRIOR APPROVAL FROM TENANT'S PROJECT MANAGER.
- 9. ALL FINISHED VENEERED WOOD SHALL BE FREE FROM KNOTS, SHAKES AND OTHER DEFECTS AFFECTING EITHER DURABILITY OR APPEARANCE, & SHALL BE CAREFULLY SELECTED FOR GRAIN & COLOR FOR MARKED VARIATIONS AT JOINTS BETWEEN VENEERS.
- 10. NO FIELD FINISHING OTHER THAN MINOR TOUCH-UPS OF MILLWORK WILL BE PERMITTED.
- 11. ALL MILLWORK HARDWARE TO BE FURNISHED & INSTALLED BY MILLWORK VENDOR.
- 12. MILLWORK VENDOR TO FURNISH & INSTALL RUBBER BUMPERS ON ALL DOORS AND DRAWERS.
- 13. ALL BLOCKING TO BE FRT
- 14. ALL SURFACES TO BE FINISHED. NO EXPOSED SURFACES WILL BE ACCEPTED.
- 15. MILLWORK CONTRACTOR TO SEAL AND CAULK AROUND ALL PENETRATIONS, CRACKS, CREVICES AND ANY OTHER OPENINGS CAPABLE OF HARBORING INSECTS OR RODENTS.
- 16. MILLWORK CONTRACTOR TO ENSURE COUNTER FITS SNUG WITH SURROUNDING SITE AND MILLWORK CONDITIONS. IF NECESSARY SCRIBE COUNTER ON SITE.
- 17. MILLWORK CONTRACTOR TO ENSURE ALL SPECIFIED EQUIPMENT FITS INTO COUNTER AS NOTED. CHECK ALL MANUFACTURER'S SPECIFICATIONS PRIOR TO FABRICATION.
- 18. COORDINATE ALL CUTOUTS & FINAL LOCATIONS WITH KITCHEN EQUIPMENT CONTRACTOR, TYP.
- 19. 1/2" X 1/2" STAINLESS STEEL CORNER GUARDS ALL EXPOSED MILLWORK CORNERS, TYP.
- 20. FIXED EQUIPMENT AND MILLWORK TO BE SEALED, USING APPROVED CLEAR SILICONE SEALANT, TO FLOORS, WALLS AND COUNTER TOPS AS REQUIRED.
- 21. INSTALLATION OF EQUIPMENT AND MILLWORK TO INCLUDE PROPER SPACING TO ALLOW FOR CLEANING.

  22. AFTER WORK IS COMPLETED ALL MILLWORK AND/OR EQUIPMENT WILL BE CLEANED AND SANITIZED BEFORE

### **EQUIPMENT NOTES** BE PERMITTED WITHOUT PRIOR AUTHORIZATION FROM ARCHITECT.

## 1. ALL EQUIPMENT SHALL BE PROVIDED BY OTHERS (N.I.C.), HOWEVER, THE GC SHALL BE RESPONSIBLE FOR SCHEDULING, PREPARING, BLOCKING, & ROUGH IN UTLITIES TO ALL EQUIPMENT.

- 2. ALL MOUNTING HEIGHTS TO BE VERIFIED WITH EQUIPMENT SPECIFICATIONS PRIOR TO INSTALLATION OF SERVICES.
- 3. GENERAL CONTRACTOR TO PRE-WIRE ALL COUNTERS PRIOR TO INSTALLATION AND FINAL CONNECTIONS MADE ON SITE BY G.C.
- 4. ALL EXPOSED UTILITY LINES AND PIPES SHALL BE INSTALLED IN A WAY THAT DOES NOT OBSTRUCT OR PREVENT THE CLEANING OF FLOORS, WALLS AND CEILING AREA. MINIMUM 6" OFF FLOORS.
- 5. ELECTRICAL ENGINEER TO BE RESPONSIBLE FOR ALL CONCERNS AND ARRANGEMENTS REGARDING PENETRATIONS INTO THE FLOOR AND WALL. BUILDING OWNER TO APPROVE PRIOR TO CONSTRUCTION.
- 6. ELECTRICAL ENGINEER TO PROVIDE G.F.I. RECEPTACLES AS REQUIRED BY THE LOCAL BUILDING CODE.
- 7. ALL EQUIPMENT REQUIRING HOT/COLD WATER CONNECTION C/W SHUT OFF VALVES.
- 8. ALL WORKS TO BE CARRIED OUT IN ACCORDANCE WITH LOCAL BUILDING CODES.
- 9. ALL ITEMS OF FOOD SERVICE EQUIPMENT SHALL BE FABRICATED AND INSTALLED IN STRICT ACCORDANCE WITH THE LATEST STANDARDS PUBLISHED BY THE NATIONAL SANITATION FOUNDATION (NSF), OR THE EQUIVALENT; AND IN STRICT COMPLIANCE WITH ALL APPLICABLE NATIONAL, STATE AND/OR LOCAL CODES AND STANDARDS.
- 10.ALL PLUMBING AND ELECTRICAL WORK, LABOR AND MATERIAL, REQUIRED TO CONNECT THIS EQUIPMENT IS TO BE FURNISHED BY THE GENERAL CONTRACTOR UNLESS SPECIFICALLY CALLED FOR IN "ITEMIZED SPECIFICATIONS". THE WORK DONE BY CONTRACTOR IS TO INCLUDE ROUGHING-IN TO POINTS INDICATED ON ROUGHING-IN PLANS, FINAL CONNECTIONS FROM ROUGH-IN POINT TO VARIOUS PIECES OF EQUIPMENT REQUIRING SUCH CONNECTIONS, AND THE SUPPLYING OF ALL NECESSARY MATERIALS AND LABOR FOR THIS WORK EXCEPT AS NOTED OTHERWISE.
- 11.ALL EXISTING HVAC, SPRINKLERS AND OTHER SERVICES TO BE RELOCATED AS REQUIRED BY MECHANICAL AND ELECTRICAL ENGINEER TO MEET ALL STANDARDS, CODES AND BYLAWS SET FORTH BY LOCAL GOVERNING AUTHORITIES.
- 12.GENERAL CONTRACTOR TO SITE VERIFY ALL DIMENSIONS PRIOR TO CONSTRUCTION.
- 13. THE GENERAL CONTRACTOR SHALL SEAL AND CAULK AROUND ALL PENETRATIONS, CRACKS, CREVICES AND ANY OTHER OPENINGS CAPABLE OF HARBORING INSECTS OR RODENTS.
- 14.IT SHALL BE THE RESPONSIBILITY OF THE FOOD SERVICE EQUIPMENT BIDDERS TO INFORM THE FOOD SERVICE CONSULTANT OF ANY DISCREPANCIES FOUND WITHIN THESE DOCUMENTS TO INCLUDE: WRITTEN SPECIFICATIONS, DRAWINGS OR SCHEDULES, TO ALLOW AN OPPORTUNITY FOR THE CONSULTANT TO PREPARE AN ADDENDUM TO CORRECT SUCH DISCREPANCIES. BIDDING ON A KNOWN DISCREPANCY WITH THE INTENTION OF EQUIPMENT
- 15. MECHANICAL AND ELECTRICAL CONTRACTOR TO BE RESPONSIBLE FOR ALL CONCERNS AND ARRANGEMENTS REGARDING PENETRATIONS INTO THE CEILING.
- 16.GENERAL CONTRACTOR TO LIAISE WITH STRUCTURAL ENGINEER PRIOR TO COMMENCEMENT OF DEMOLITIONS
- 17.ENSURE THE SAFETY OF THE WORKS AND OF THE PUBLIC DURING DEMOLITION WORK.

SUBSTITUTION OR PRICE GOUGING THROUGH CHANGE ORDERS WILL NOT BE TOLERATED.

- 18.BEFORE STARTING DEMOLITION WORK ARRANGE FOR THE APPROPRIATE AUTHORITIES TO REMOVE ALL SERVICES FROM THE AREA
- 19. CONTRACTOR TO FAMILIARIZE HIMSELF WITH ALL SERVICES PRIOR TO COMMENCEMENT OF THE DEMOLITION PHASE.
- 20.ALL WORKS TO BE CARRIED OUT IN ACCORDANCE WITH LOCAL BUILDING CODE
- 21. CONSTRUCTION DOCUMENTS INCLUDE DRAWINGS AND WRITTEN SPECIFICATIONS, WHICH SHOULD BE REASONABLY CORRECT, HOWEVER THEIR ACCURACY IS NOT GUARANTEED. SDISCREPANCIES OCCUR THEY SHALL BE BROUGHT TO THE ATTENTION OF THE FOOD SERVICE CONSULTANT AND/OR PROJECT ARCHITECT IN ORDER FOR THE CONFLICT TO BE CLARIFIED IN AN OFFICIAL REQUEST FOR INFORMATION.

### **HEALTH/ HUMAN SERVICES NOTES**

- 1. ALL WALL SURFACES IN FOOD SERVICE AREAS OR AROUND 3 COMPARTMENT SINK AND THE MOP SINK WHERE WATER, GREASE, STEAM, HEAT OR SPLASH/FOOD SPLATTER ARE PRESENT SHALL BE SMOOTH, DURABLE, EASILY CLEANABLE AND NON-ABSORBANT.
- 2. THE CEILING FINISHES FOR AREAS SUBJECT TO MOISTURE SUCH AS FOOD PREPARATION, DISHWASHING, FOOD ITEMS STORAGE AREAS AND TOILET ROOMS SHOULD BE SMOOTH, DURABLE, EASILY CLEANABLE, AND NON-ABSORBANT.
- 3. THE FLOOR FINISH IN ALL FOOD PREPARATION OR WAREWASHING AREAS SHALL BE SMOOTH, DURABLE, NON-ABSORBANT, AND EASILY CLEANABLE.
- 4. ALL EQUIPMENT SHALL MEET NSF DESIGN STANDARDS.
- 5. GENERAL CONTRACTOR TO SEAL AND CAULK AROUND ALL PENETRATIONS, CRACKS, CREVICES AND ANY OTHER OPENINGS CAPABLE OF HARBORING INSECTS OR RODENTS.
- 6. PROVIDE STORAGE FOR CLEANING EQUIPMENT AND SUPPLIES (MOPS, BROOMS, BUCKETS). AFTER USE, MOPS SHALL BE PLACED IN A POSITION THAT ALLOWS THEM TO AIR-DRY WITHOUT SOILING WALLS, EQUIPMENT, OR SUPPLIES. INSTALL A MOP RACK AT THE MOP SINK AREA.
- 7. POISONOUS OR TOXIC MATERIALS SHALL BE STORED SO THEY CANNOT CONTAMINATE FOOD, EQUIPMENT, UTENSILS, LINENS, AND SINGLE-SERVICE AND SINGLE-USE ARTICLES. DEDICATED RACK/SHELF SHALL BE
- 8. EMPLOYEE BELONGINGS AND CLOTHING SHALL NOT BE STORED IN FOOD PREP, FOOD STORAGE, AND COOKING AREAS. HOOKS AND/OR LOCKERS FOR EMPLOYEE CLOTHING AND BELONGINGS (I.E. PURSE, COATS, BOOTS, UMBRELLAS, ETC.) SHALL BE PROVIDED BY TENANT.
- 9. THE LIGHT INTENSITY SHALL BE AT LEAST 50 FOOT CANDLES (540 LUX) AT ANY SURFACE WHERE AN EMPLOYEE IS WORKING WITH FOOD OR WORKING WITH UTENSILS WHERE EMPLOYEE SAFETY IS A FACTOR.
- 10.ALL FOOD SERVICE EQUIPMENT THAT IS DIRECTLY CONNECTED TO THE POTABLE WATER SUPPLY SYSTEM MUST BE EQUIPPED WITH AN APPROPRIATE BACKFLOW PREVENTION DEVICE TO PREVENT CONTAMINATION OF THE WATER SUPPLY.
- 11.ALL LIGHTING IN FOOD SERVICE AREAS MUST BE SHIELDED, ROUGH-SKIN COATED OR SHATTERPROOF TO PROTECT FOOD FROM CONTAMINATION. THIS INCLUDES PENDANTS, TRACK, AND RECESS LIGHTS.

### **ELECTRICAL/ TELEPHONE NOTES**

- 1. ALL ELECTRICAL WORK, LABOR AND MATERIAL, REQUIRED TO CONNECT THIS EQUIPMENT IS TO BE FURNISHED BY CONTRACTOR UNLESS SPECIFICALLY CALLED FOR IN "ITEMIZED SPECIFICATIONS". THE WORK DONE BY CONTRACTOR IS TO INCLUDE ROUGHING-IN TO POINTS INDICATED ON ROUGHING-IN PLANS, FINAL CONNECTING FROM ROUGH-IN POINT TO VARIOUS PIECES OF EQUIPMENT REQUIRING SUCH CONNECTIONS, AND THE SUPPLYING OF ALL NECESSARY MATERIALS AND LABOR FOR THIS WORK EXCEPT AS HEREINAFTER NOTED.
- 2. UTILITIES SHOWN ON ARCHITECT'S DRAWINGS ARE FOR REFERENCE ONLY. SEE ELECTRICAL ENGINEERS' DRAWINGS FOR ANY ADDITIONAL INFORMATION. FINAL CONNECTIONS OF EQUIPMENT TO BUILDING'S UTILITY SYSTEMS TO BE BY APPROPRIATE ELECTRICAL TRADES.
- 3. FINAL CONNECTIONS TO ALL EQUIPMENT SHALL BE BY THE ELECTRICAL CONTRACTOR, INCLUDING ALL REQUIRED MATERIALS SUCH AS DISCONNECTS, BOXES, OUTLETS (EXCEPT AS FURNISHED AS PART OF THE EQUIPMENT), RIGID CONDUIT, FLEXIBLE CONDUIT, WIRING, ETC.
- 4. THE ELECTRICAL CONTRACTOR SHALL FURNISH AND INSTALL THE FOLLOWING:  $\frac{1}{2}$
- a. ALL JUNCTION BOXES, ELECTRICAL OUTLETS, COVER PLATES, SWITCHES, ETC. NOT BUILT INTO FIXTURES OR EQUIPMENT. ALL OUTLETS, JUNCTION BOXES, COVER PLATES, ETC. IN FOOD SERVICE AREAS MUST BE MOISTURE PROOF
- b. ALL PLUGS AND CORDS SHALL BE N.E.M.A. RATED AND U.L. APPROVED FOR MANUFACTURED AND FABRICATED EQUIPMENT.
- c. DISCONNECTS OR OTHER DEVICES AS MAY BE REQUIRED BY LOCAL/STATE/NATIONAL CODES.
- 5. PROVIDE COMPUTER GRADE, CLEAN GROUND SERVICE FOR ELECTRONIC CASH REGISTERS. PROVIDE EMPTY CONDUIT BETWEEN CASH REGISTER LOCATIONS TO ALLOW UNITS TO BE TIED TOGETHER. REFER TO ARCHITECTURAL PLANS FOR CLOCKS, INTERCOM, TIME CLOCKS, POINT OF SALE (POS), CASH MACHINERY AND OTHER ITEMS LOCATED IN FOOD SERVICE AREA BUT NOT INCLUDED IN THE FOOD SERVICE EQUIPMENT CONTRACT. PRIOR TO INSTALLATION, VERIFY CASH REGISTER POWER REQUIREMENTS WITH WNER/OPERATOR.
- 6. ELECTRICAL COMPONENTS MUST NOT INTERFERE WITH THE OPERATION OF THE EQUIPMENT IT SERVICES.
  7. ALL LINE AND DISCONNECT SWITCHES, SAFETY CUT-OUTS, CONTROL PANELS, FUSE BOXES, OR OTHER ELECTRICAL CONTROLS, FITTINGS, AND CONNECTIONS NOT FURNISHED AS A STANDARD PART OF THE FIXTURE BY THE MANUFACTURER TO BE FURNISHED AND INSTALLED UNDER ELECTRICAL CONTRACT. STARTING SWITCHES PROVIDED BY EQUIPMENT CONTRACTOR AND FURNISHED LOOSE AS STANDARD BY FOOD SERVICE EQUIPMENT MANUFACTURERS (OTHER THAN CUSTOM FABRICATED ITEMS) IS TO BE MOUNTED AND WIRED COMPLETE UNDER ELECTRICAL CONTRACT.
- 8. ELECTRICAL SUB TO VERIFY SERVICE PROVIDED IS ADEQUATE. IF NOT, NOTIFY ARCHITECT IMMEDIATELY.
- 9. PRIOR TO CORING SLAB, REVIEW LOCATIONS WITH ARCHITECT AND COORDINATE LOCATIONS WITH OWNER. ALL LOCATIONS SHALL BE MARKED FOR LANDLORD APPROVAL PRIOR TO CORING.
- 10. CONTRACTOR TO COORDINATE INSTALLATION OF TELECOMMUNICATIONS, DATA AND SECURITY SYSTEMS.
- 11. VERIFY EQUIPMENT SPECIFICATIONS, POWER AND INSTALLATION REQUIREMENTS WITH MANUFACTURER TO ENSURE PROPER FIT AND FUNCTION.
- 12. VERIFY MOUNTING REQUIREMENTS OF ELECTRICAL, TELEPHONE AND OTHER EQUIPMENT. PROVIDE NON-
- COMBUSTIBLE BLOCKING WITHIN WALLS AS REQUIRED FOR PROPER EQUIPMENT INSTALLATION.
- 14. INDICATED DIMENSIONS ARE TO THE CENTER LINE OF OUTLET OR SWITCH, OR CLUSTER OF OUTLETS OR
- SWITCHES, UNLESS OTHERWISE NOTED.
- 15. INSTALL OUTLETS ON OPPOSITE SIDES OF PARTITIONS IN SEPARATE STUD CAVITIES. DO NOT INSTALL BACK-TO-BACK.
- 16. PROVIDE MATCHING COVER PLATES, RECEPTACLES AND RELATED ITEMS. PROVIDE ONE-PIECE TYPE GANG COVER PLATES, UNLESS OTHERWISE NOTED.
- 17.IDENTIFY DEDICATED OR ISOLATED GROUND ELECTRICAL OUTLETS WITH A RED DOT.

13. GANG ADJACENT LIGHT SWITCHES AND COVER WITH A SINGLE PLATE.

- 18. MOUNT STANDARD WALL OUTLETS, SWITCHES AND THERMOSTATS AT HEIGHTS REQUIRED BY TITLE 24 AND ADA GUIDELINES, UNLESS OTHERWISE NOTED. WHEN THERMOSTATS AND LIGHT SWITCH OCCUR TOGETHER, INSTALL BOTH ALIGNED HORIZONTALLY WITH CENTER LINE AT +3'-2" ABOVE FINISHED FLOOR.
- 19. ALL OUTLETS TO BE INSTALLED AS DIMENSIONED ON THIS PLAN. ANY DISCREPANCIES BETWEEN PLAN AND EXISTING FIELD CONDITIONS TO BE CLARIFIED WITH THE ARCHITECT BEFORE COMMENCEMENT OF WORK.
- 20.ALL ELECTRICAL AND TELEPHONE WORK TO BE INSTALLED IN STRICT ACCORDANCE WITH THE REQUIREMENTS OF ALL ELECTRICAL CODES, NATIONAL BOARD OF FIRE UNDERWRITERS, UTILITY COMPANIES, TELEPHONE COMPANIES, THE LANDLORD, AND ALL OTHER AUTHORITIES HAVING JURISDICTION.
- 21.THE GC SHALL PROVIDE ALL CUTTING AND PATCHING OF FLOORS, WALLS AND CEILING AS REQUIRED.
- 22.U.O.N. ALL DEVICES (TELEPHONE, DATA, ELECTRIC, SWITCH) SHALL BE WHITE WITH WHITE COVER PLATES AND ALL EXISTING OUTLETS TO REMAIN TO RECEIVE NEW WHITE DEVICES WITH WHITE COVER PLATES.
- 23. ALL SURFACES WITH EXISTING OUTLETS BEING REMOVED SHALL BE PATCHED FLUSH WITH ADJACENT WALL SURFACES.
- 24. PROVIDE BREAKER LOCKS FOR A.C. UNITS AND POS/PHONE SYSTEMS.
- 25. ALL TELEPHONE OUTLETS SHALL BE PROVIDED WITH TWO (2) PULL STRINGS BACK TO THE TELEPHONE EQUIPMENT.
- 26.U.O.N, ALL ELECTRICAL, TELEPHONE, AND DATA OUTLETS ARE TO BE MOUNTED 15" A.F.F.
- 27.CENTERLINE TO CENTERLINE DIMENSIONS OF ANY OUTLET PAIR OR GROUP SHALL NOT EXCEED 6".
- 28. ALL CERCUIT BREAKER PANELS SHALL BE LABELED TO SHOW WHAT EACH BREAKER ACTIVATES.

### PLUMBING NOTES

- 1. THE WORK DONE BY CONTRACTOR IS TO INCLUDE ROUGHING-IN TO POINTS INDICATED ON ROUGHING-IN PLANS, FINAL CONNECTING FROM ROUGH-IN POINT TO VARIOUS PIECES OF EQUIPMENT REQUIRING SUCH CONNECTIONS, AND THE SUPPLYING OF ALL NECESSARY MATERIALS AND LABOR FOR THIS WORK EXCEPT AS HEREINAFTER
- 2. UTILITIES SHOWN ON ARCHITECT'S DRAWINGS ARE FOR REFERENCE ONLY. SEE PLUMBING ENGINEERS' DRAWINGS FOR ANY ADDITIONAL INFORMATION. FINAL CONNECTIONS OF EQUIPMENT TO BUILDING'S UTILITY SYSTEMS TO BE BY APPROPRIATE PLUMBING TRADES.
- 3. ALL TRAPS, GREASE TRAPS, TAIL PIECES, VALVES, STOPS, SHUT-OFFS, AND FITTINGS NECESSARY ARE TO BE FURNISHED AND INSTALLED UNDER PLUMBING CONTRACT, UNLESS SPECIFICALLY CALLED FOR UNDER ITEMIZED
- 4. FINAL CONNECTIONS TO ALL EQUIPMENT SHALL BE BY THE PLUMBING CONTRACTOR, INCLUDING ALL REQUIRED MATERIALS SUCH AS STOPS, VALVES FILTERS, TRAPS, CHECK VALVES, PIPING, TUBING, ETC.
- 5. THE PLUMBING CONTRACTOR SHALL FURNISH AND INSTALL THE FOLLOWING:
- a. ALL WATER AND WASTE SERVICE TO POINT OF ROUGH-IN AS SHOWN ON PLAN. ROUGH-IN OUTLETS TO STUB 4"OUT OF WALLS AT HEIGHT INDICATED FROM FINISHED FLOOR TO CENTERLINE OF SERVICE LINE. FLOOR ROUGH-INS TO STUB UP 3" ABOVE FINISHED FLOOR OR CURBS. ALL FLOOR OPENINGS OR PENETRATIONS TO BE SEALED WATERTIGHT.
- b. ALL FLOOR SINKS, COMPLETE WITH TOP GRATES (AS INDICATED) AND REMOVABLE SEDIMENT BUCKETS. ALL FIXTURES TO BE SET FLUSH WITH FINISHED FLOOR, EXCEPT AS OTHERWISE NOTED.
- c. ALL WASTE LINES, DIRECT OR INDIRECT, EXCEPT AS OTHERWISE NOTED. MINIMUM DIAMETER OF LINE SHALL BE AS INDICATED ON PLAN REGARDLESS OF CONNECTION, AND SHALL BE PITCHED DOWNWARD.

  MAINTAIN DRAIN LINES AS HIGH AS POSSIBLE (MINIMUM 6" CLEAR ABOVE FINISHEDFLOOR) ABOVE FLOOR FOR SANITATION AND CLEANING. ALL WASTE LINES SHALL HAVE ADEQUATE CLEAN-OUT PROVISIONS PER LOCAL CODES.
- d. ALL REQUIRED GREASE TRAPS, OUTSIDE THE BUILDING WHERE POSSIBLE, OTHERWISE BELOW OISET FLUSH WITH THE FINISHED FLOOR. STRICT COORDINATION WITH EQUIPMENT AND LOCAL CODES REQUIRED IF GREASE TRAP IS TO BE SET ABOVE THE FLOOR OR UNDER EQUIPMENT
- 6. INSULATION ON ALL HOT WATER LINES WITHIN THE FOOD SERVICE AREAS. ALL SUCH LINES ARE TO BE
- 7. WHERE POSSIBLE, UTILITIES SHALL BE CONCEALED WITHIN BUILDING WALLS OR COLUMN CHASES, NOT RUN ALONG WALL FACE. DO NOT STUB OUT OF FLOOR AND RUN ON THE FACE OF THE WALL.
- 8. ANY AND ALL EXPOSED PIPING OR FITTINGS TO BE STAINLESS STEEL, CHROME PLATED OR ENCLOSED IN A CONCEALED, MOUNTED STAINLESS STEEL CHASE.
- 9. ALL HORIZONTAL PIPING RUNS EXTENDED TO AND CONNECTED TO EQUIPMENT ITEMS SHALL BE AT THE HIGHEST PRACTICAL ELEVATION AND NOT LESS THAN 6" ABOVE FINISHED FLOOR SO AS TO PROVIDE
- CLEARANCE FOR CLEANING.
- OF THE EQUIPMENT.

  11. DRINKING FOUNTAINS ARE BY MECHANICAL TRADES. VERIFY UTILITY REQUIREMENTS WITH MECHANICAL

10.ALL LINES ROUTED THROUGH EQUIPMENT SHALL NOT INTERFERE WITH THE INTENDED USE OF, OR SERVICING

- 12.INDOOR GREASE TRAPS ARE TO BE RECESSED, FLUSH WITH TOP OF FINISHED FLOOR (UNLESS SPECIFIED
- OTHERWISE) AND REMOVAL OF COVER SHALL NOT INTERFERE WITH THE OPERATION OF EQUIPMENT ITEMS.
- 13.INDIRECT WASTES TO BE EXTENDED OVER BUILDING DRAINS BY PLUMBING TRADE.

### **MECHANICAL NOTES**

COLOR-CODED ACCORDING TO LOCAL CODES.

- 1. ALL MECHANICAL WORK, LABOR AND MATERIAL, REQUIRED TO CONNECT THIS EQUIPMENT IS TO BE FURNISHED BYCONTRACTOR UNLESS SPECIFICALLY CALLED FOR IN "ITEMIZED SPECIFICATIONS". THE WORK DONE BY CONTRACTOR IS TO INCLUDE ROUGHING-IN TO POINTS INDICATED ON ROUGHING-IN PLANS, FINAL CONNECTING FROM ROUGH-IN POINT TO VARIOUS PIECES OF EQUIPMENT REQUIRING SUCH CONNECTIONS, AND THE SUPPLYING OF ALL NECESSARY MATERIALS AND LABOR FOR THIS WORK EXCEPT AS HEREINAFTER NOTED.
- 2. EXCEPT WHERE SHOWN IN DIMENSIONAL DETAIL, THE LOCATIONS OF MECHANICAL EQUIPMENT, DUCTS, PIPING, AND FITTING ARE ONLY APPROXIMATE. THE EXACT LOCATIONS SHALL BE DETERMINED BY THE CONTRACTOR, SUBJECT TO APPROVAL BY THE ARCHITECT.
- 3. CONTRACTOR SHALL VERIFY SIZES AND LOCATIONS OF ALL MECHANICAL EQUIPMENT PADS AND BASES AS WELL AS POWER AND WATER OR DRAIN INSTALLATIONS WITH EQUIPMENT MANUFACTURERS BEFORE PROCEEDING WITH THE WORK. CHANGES TO ACCOMMODATE FIELD CONDITIONS OR SUBSTITUTIONS SHALL BE MADE AT NO ADDITIONAL COST.
- 4. MECHANICAL SUPPLY AND RETURN AIR SHAFTS SHALL BE AIRTIGHT AND SEALED.
- 5. ALL FLEXIBLE AIRDUCTS, IF USED, SHALL MEET THE REQUIREMENTS OF NFPA 90A, 2-3-2 IN CONSTRUCTION AND INSTALLATION.



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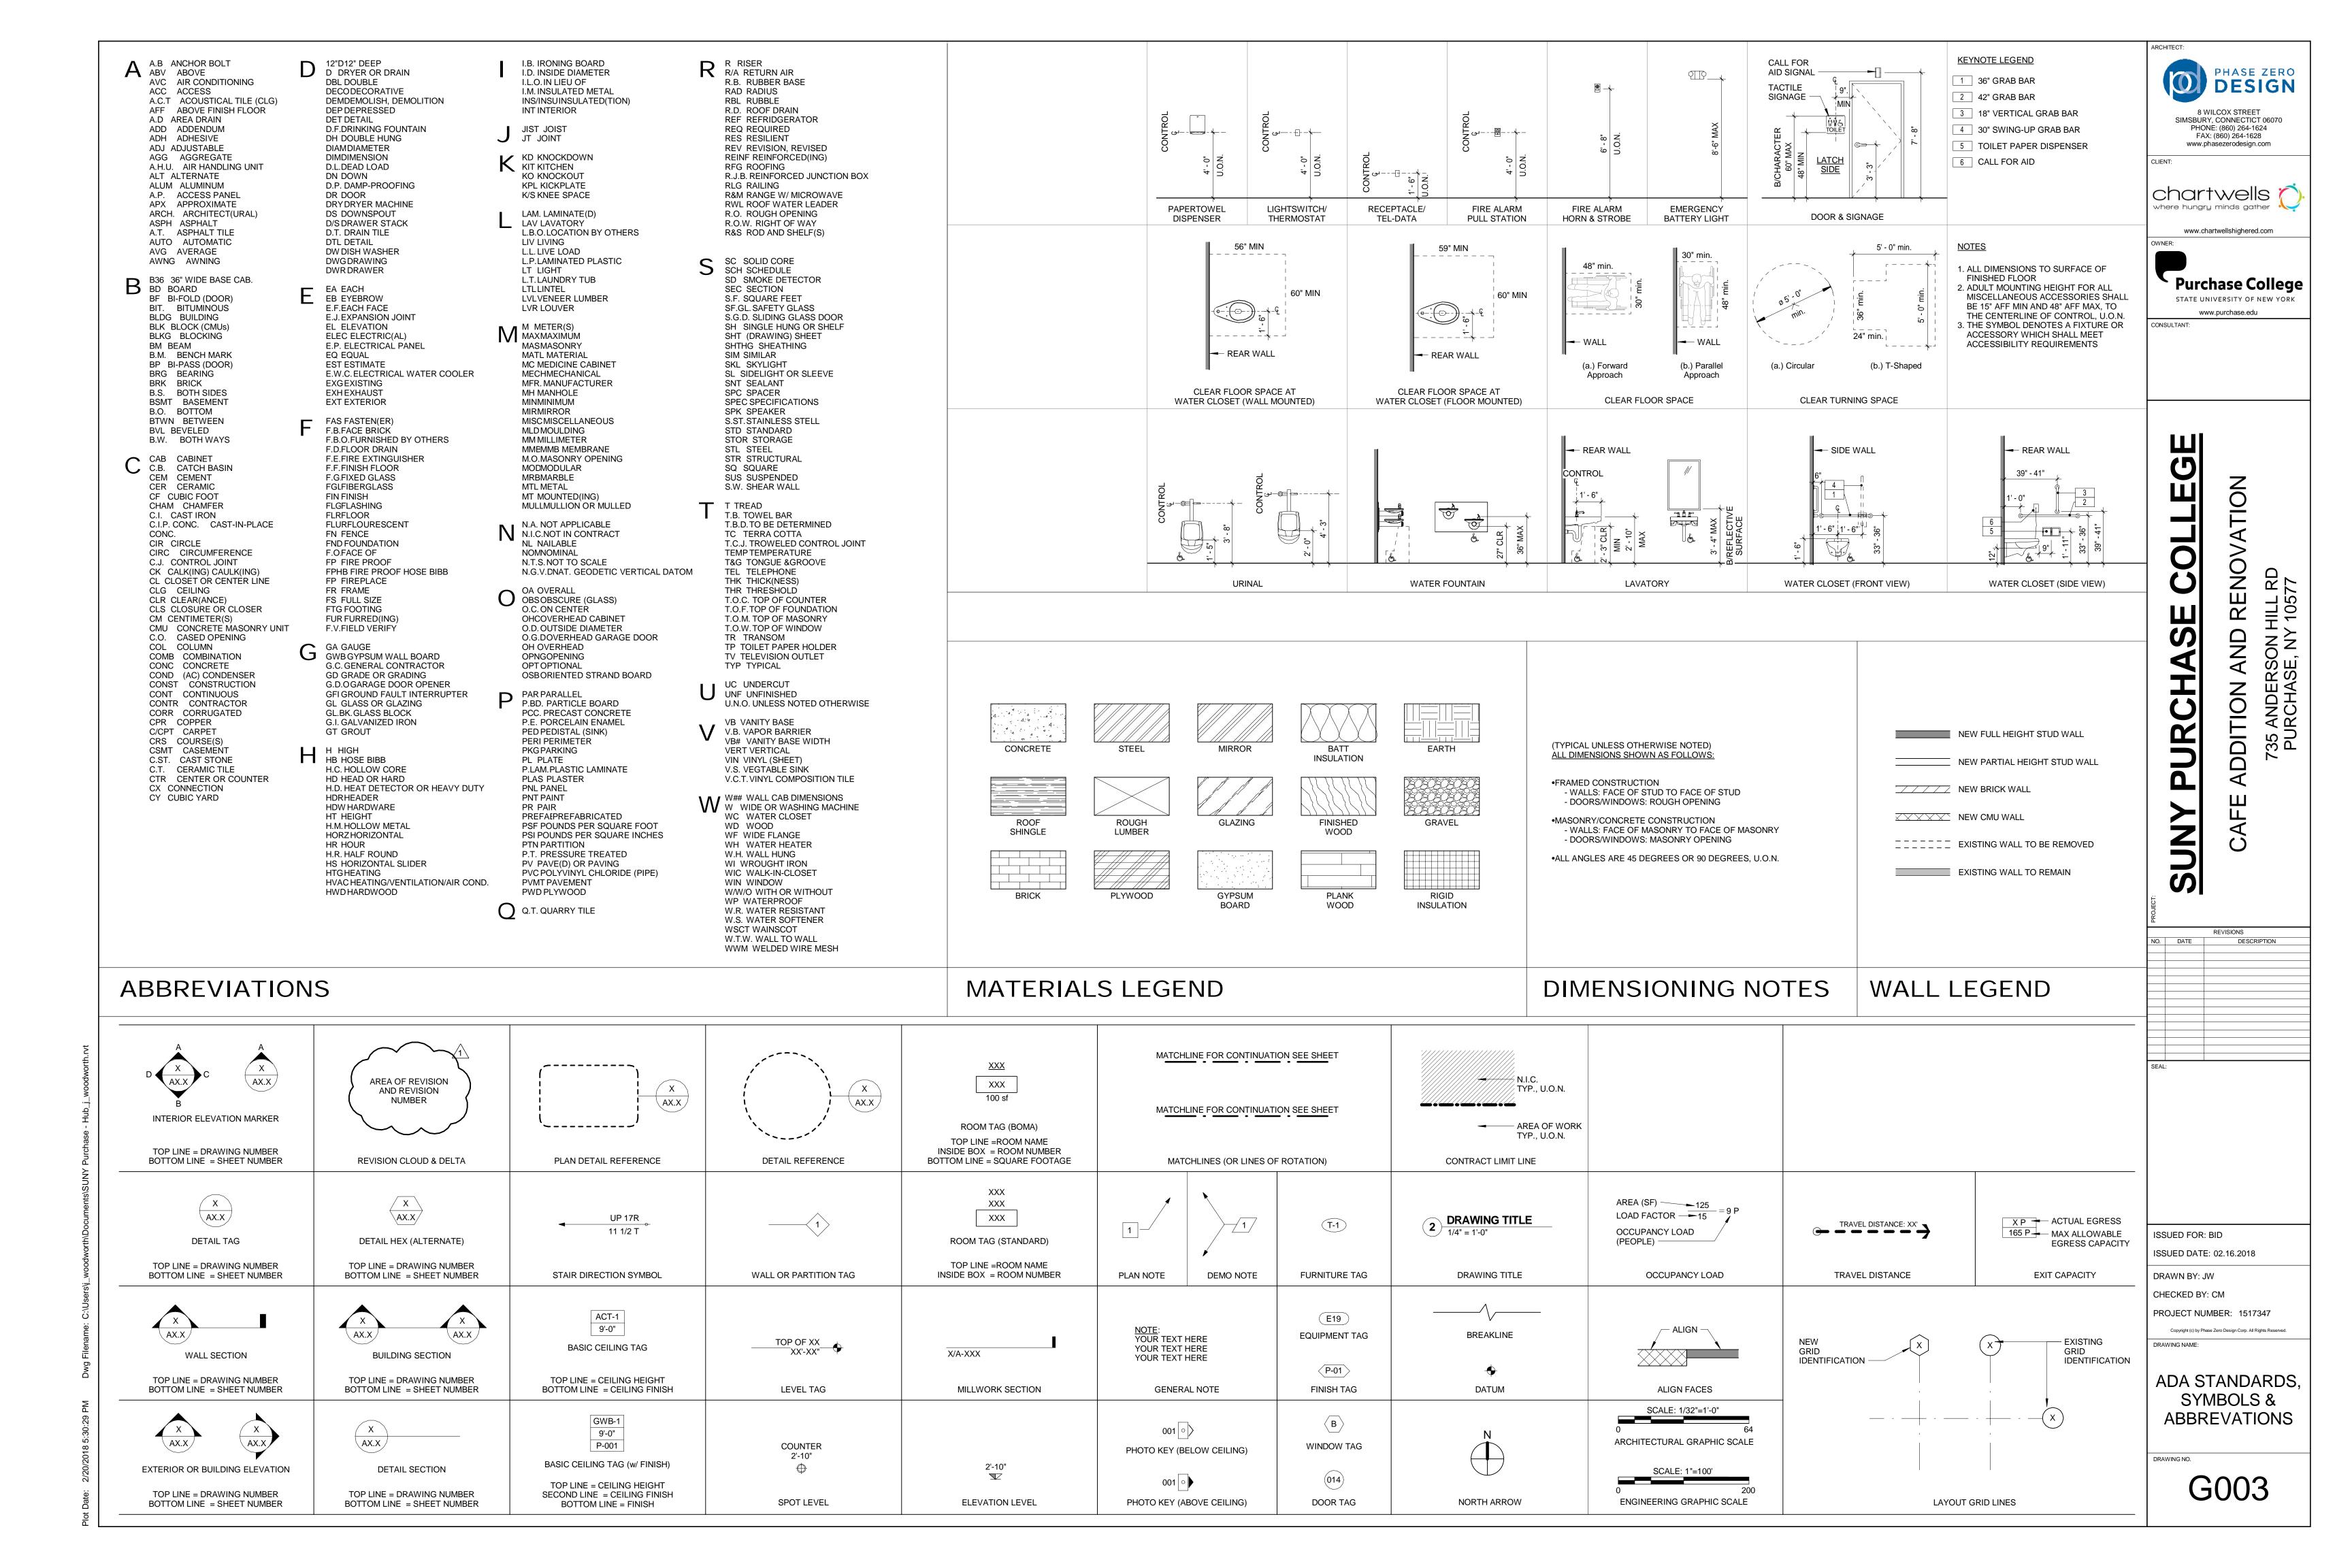
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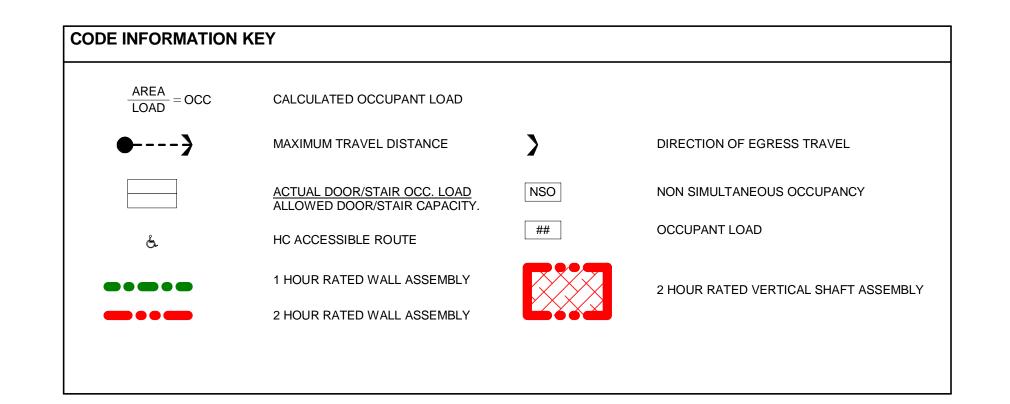


ITEM	CODE SECTION(S)	
CONSTRUCTION TYPE	IBC: 602	2B
USE & OCCUPANCY CLASSIFICATION	IBC: 302	SEPERATED MIXED USE:
USE & OCCUPANCY CLASSIFICATION	IBC. 302	
INCIDENTAL ACCESSORY	100 500	(A-2) / (S-2) / (B) / (R-2)
INCIDENTAL ACCESSORY	IBC: 509	MECHANICAL ROOM
ACCESSORY USE AREA	IBC: 508.2	N/A
TABULAR ALLOWABLE BUILDING HEIGHT	IBC: TABLE 504.3 & 504.4	(A-2) = 75'-0", 3 STORY(S) SPRINKLERED
		(S-2) = 55'-0", 3 STORY(S) NON - SPRINKLERED
		(B) = 55'-0", 3 STORY(S) NON - SPRINKLERED
		(R-2) = 55'-0", 3 STORY(S) NON - SPRINKLERED
ACTUAL BUILDING HEIGHT		3 STORY(S), 53'-0"
TABULAR ALLOWABLE BUILDING AREA	IBC: TABLE 506.2	(A-2) = 28,500 SF., NON SPRINKLERED
		(S-2) = 26,000 SF, NON SPRINKLERED
		(B) = 23,000 NON SPRINKLERED
		(R-2) = 16,000 SF, NON SPRINKLERED
		SEE KEY PLANS FOR MIXED AREA CALCULATIONS
ACTUAL BUILDING AREA	IBC: TABLE 506.2	BASEMENT = 17,220 SF
(SEE PLANS FOR USE SEPERATION S.F.)		FIRST FLOOR = 19,839 SF
		SECOND FLOOR = 4,000 SF
		THIRD FLOOR = 4,000 SF
		TOTAL BUILDING = 45,059 SF
FIRE SURPRESSION	IBC: 903.2.1.2	PARTIAL - (A-2) & (S-2) FIRE AREA WILL BE PROVIDED WITH AUTOMATIC SPRINKLER SYSTEM
FIRE DETECTION	IBC: 907	PROVIDED
TOTAL BUILDING OCCUPANT LOAD	IBC: TABLE 1004.1.2	SEE CODE PLAN
AREA OF REFUGE	IBC: 1009.3 - EXCEPTION 5	NOT REQUIRED WHERE EQUIPPED THROUGHOUT WITH
		AN AUTOMATIC SPRINKLER SYSTEM.  (A-2) FIRE AREA ONLY WILL BE PROVED WITH AUTOMATIC SPRINKLER SYSTEM
STAIR WIDTH	IBC: 1009.3 - EXCEPTION 2 & 1011.2	CLEAR WIDTH OF 48" IS NOT REQUIRED WHERE EQUIPPED THROUGHOUT WITH AN AUTOMATIC SPRINKLER SYSTEM.  (A-2) FIRE AREA ONLY WILL BE PROVIDED WITH AUTOMATIC SPRINKLER SYSTEM.  44" MINIMUM
MAX TRAVEL DISTANCE	IBC: TABLE 1017.2	(A-2) 250' WITH AUTOMATIC SPRINKLER SYSTEM
		(S-2) 300' W/OUT AUTOMATIC SPRINKLER SYSTEM
		(B) 200' W/OUT AUTOMATIC SPRINKLER SYSTEM
		(R-2) 200' W/OUT AUTOMATIC SPRINKLER SYSTEM
CORRIDOR WIDTH	IBC: TABLE 1020.2	44", MINIMUM
DEAD END CORRIDOR	IBC: TABLE 1020.4	(A-2) = 20' W/OUT AUTOMATIC SPRINKLER SYSTEM
		(S-2) = 20' W/OUT AUTOMATIC SPRINKLER SYSTEM
		(B) = 20' W/OUT AUTOMATIC SPRINKLER SYSTEM
		(R-2) = 20' W/OUT AUTOMATIC SPRINKLER SYSTEM
NUMBER OF EXITS	IBC: 1006.2.11 & IBC: TABLE 1006.2.1	(A-2) = 2 WHEN 500 OR LESS OCCUPANTS
TOWNER OF EATIO	156. 1666.2.11 & 156. TABLE 1666.2.1	(S-2) = 2 WHEN GREATER THAN 75' TRAVEL DISTANCE & 30 OCCUPANTS
		(B) = 2 WHEN GREATER THAN 75' DISTANCE TRAVEL & 30 OCCUPANTS
		. ,
		(R-2) = 2 MINIMUM

ASSEMBLY TOTAL OCC	UPANTS = 493.47 / BUSINES	SS TOTAL OCCU	PANTS = 98.33 / S	STORAGE TOT	TAL OCCUPANTS = 1	0.93			
		REQUIRED FIXTURE COUNT		CALCULATED FIXTURE COUNT		TOTAL FIXTURES REQUIRED		TOTAL FIXTURES PROVIDED	
OCCUPANCY CLASS		MALE	FEMALE	MALE	FEMALE	MALE	FEMALE	MALE	FEMALE
A-2, ASSEMBLY	WATER CLOSETS	1 PER 75	1 PER 75	3.29	3.29				
B, BUSINESS	WATER CLOSETS	1 PER 25	1 PER 25	1.97	1.97	5.31 (6)	5.31 (6)	2 WC* 3 URINALS*	4*
S-2, STORAGE	WATER CLOSETS	1 PER 100	1 PER 100	.05	.05				
A-2, ASSEMBLY	LAVATORIES	1 PER 200	1 PER 200	1.23	1.23				
B, BUSINESS	LAVATORIES	1 PER 40	1 PER 40	1.23	1.23	2.51 (3)	2.51 (3)	2*	5
S-2, STORAGE	LAVATORIES	1 PER 100	1 PER 100	.05	.05				
A-2, ASSEMBLY	DRINKING FOUNTAIN	1 PER 500	1	.98	,		1		
B, BUSINESS	DRINKING FOUNTAIN	1 PER 500	1 PER 500 .19			1.18 (2)			
S-2, STORAGE	DRINKING FOUNTAIN	1 PER 1000		.01					
A-2, ASSEMBLY	SERVICE SINK	1 SERVICE SINK 1 SERVICE SINK							
B, BUSINESS	SERVICE SINK	1 SERVICE SINK		1 SERVICE SINK		1		1	
S-2, STORAGE	SERVICE SINK	1 SERVICE SINK		1 SERVICE SINK					

ITEM	CODE SECTION(S)	
PRIMARY STRUCTURE FRAME		0 HOUR(S)
BEARING WALLS		EXTERIOR: 0 HOUR(S)
	IBC: TABLE 601	INTERIOR: 0 HOUR(S)
NON - BEARING WALLS		EXERIOR: 0 HOUR(S)
		INTERIOR: 0 HOUR(S)
FLOOR CONSTRUCTION		0 HOUR(S)
ROOF CONSTRUCTION		0 HOUR(S)
SHAFT ENCLOSURES	IBC: 713.4	2 HOUR(S) - CONNECTING 4 STORIES OR MORE, OR WHERE PENETRATING 2 HR FLOOR CONSTRUCTION
EXIT ENCLOSURES	IBC: 1023.2	2 HOUR(S) - CONNECTING 4 STORIES OR MORE, OR WHERE PENETRATING 2 HR FLOOR CONSTRUCTION
CORRIDORS	IBC: TABLE 1020.1	1 HOUR(S) WITHOUT SPRINKLER SYSTEM
		0 HOUR(S) WITH SPRINKLER SYSTEM
DOOR RATING	IBC: TABLE 716.5	1 HOUR(S) EXIT ENCLOSURE = 1 HOUR(S) DOOR
		1 HOUR(S) CORDDIDOR WALL = 1/3 HOUR(S) DOOR
USE GROUPS	IBC: 302	A-2: DINING & KITCHEN
		B: EDUCATIONAL
		R-2 DORMITORY
		S-2: STORAGE
USE GROUPS	IBC: 508.4, TABLE 508.4	2 HOUR(S): A-2 / B
		1 HOUR(S) - A-2 / S-2
		2 HOUR(S) S-2 / B
		2 HOUR(S) R-2 / B (NOT IN RENOVATION SCOPE)
VERTICAL DWELLING UNIT SEPARATION	IBC: 420.2, 708.1	1 HOUR(S) (NOT IN SCOPE)
HORIZONTAL DWELLING UNIT SEPARATION	IBC: 420.3, 711.2.4.3	1 HOUR(S) (NOT IN SCOPE)

CODE	CODE SECTION(S)
BUILDING CODE	2015 INTERNATIONAL BUILDING CODE
	2015 INTERNATIONAL RESIDENTIAL BUILDING CODE
	2017 UNIFORM CODE SUPPLEMENT
PLUMBING CODE	2015 INTERNATIONAL PLUMBING CODE
MECHANICAL CODE	2015 INTERNATIONAL MECHANICAL CODE
ELECTRICAL CODE	2014 NATIONAL ELECTRICAL CODE (NFPA 70)
FUEL & GAS	2015 INTERNATIONAL FUEL & GAS CODE
ACCESSIBILITY	ACESSIBILITY
ENERGY CODE COMPLIANCE	2015 INTERNATIONAL ENERGY CONSERVATION CODE W/ 2016 SUPPLEMENT





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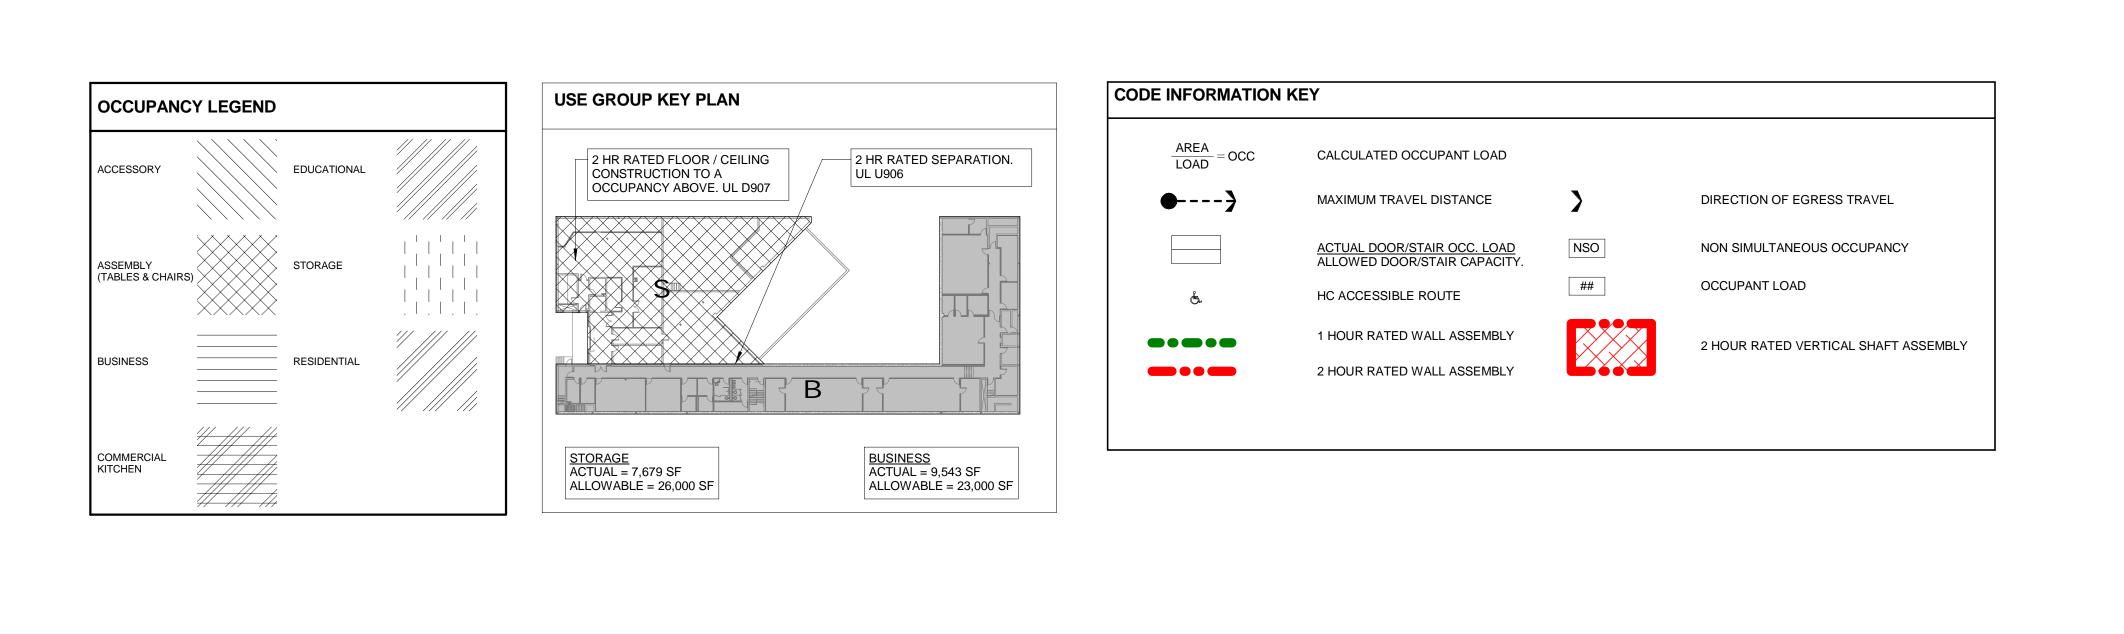
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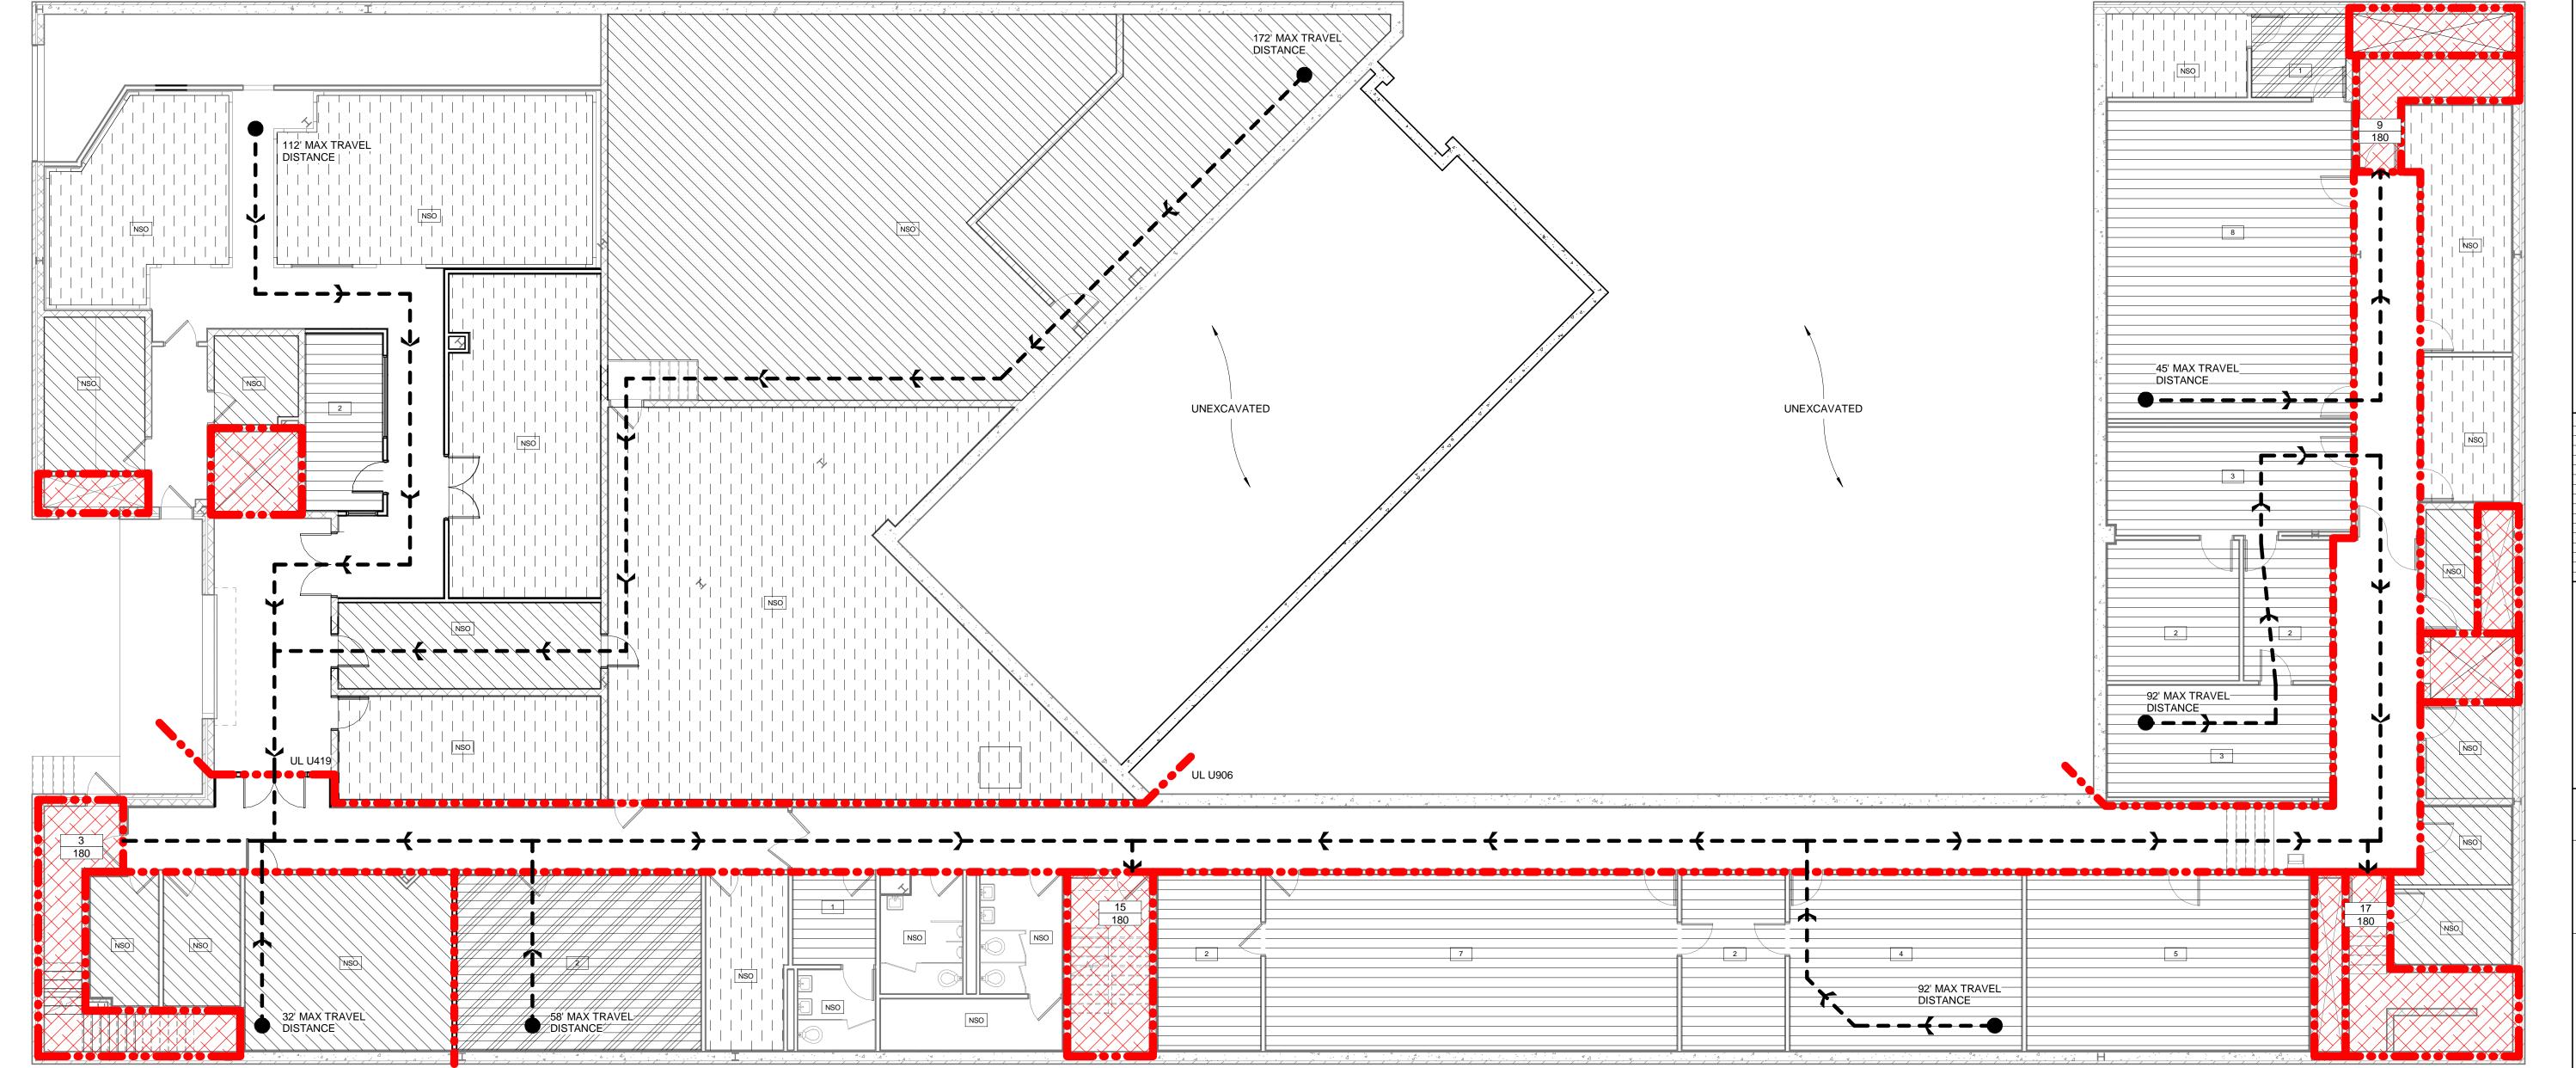
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CODE DATA





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D. DATE DESCRIPTION ISSUED FOR: BID ISSUED DATE: 02.16.2018 DRAWN BY: JW CHECKED BY: CM PROJECT NUMBER: 1517347 CODE PLAN & ANALYSIS


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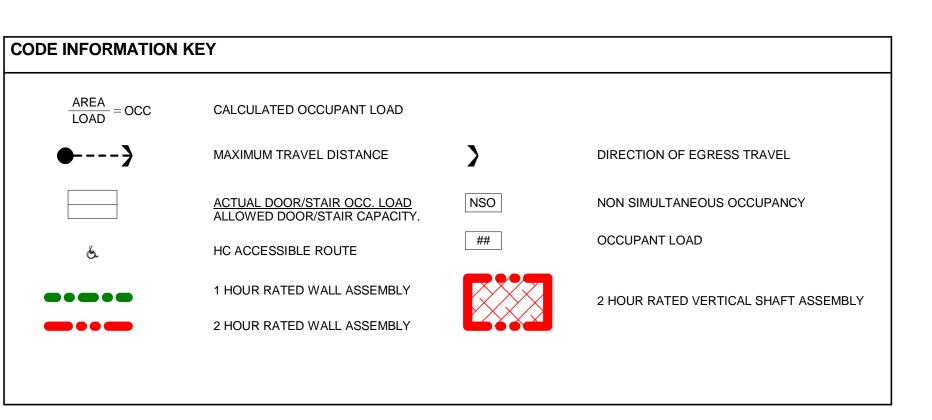
1) BASEMENT CODE PLAN
1/8" = 1'-0"


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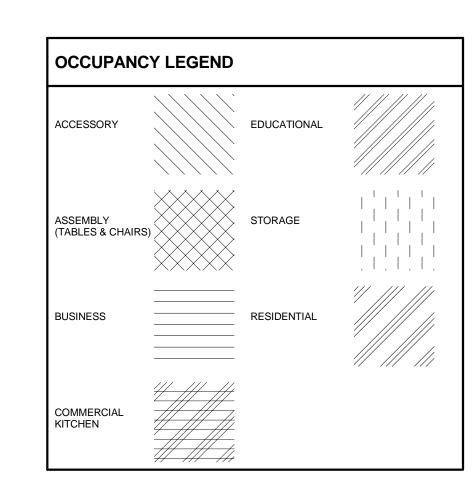
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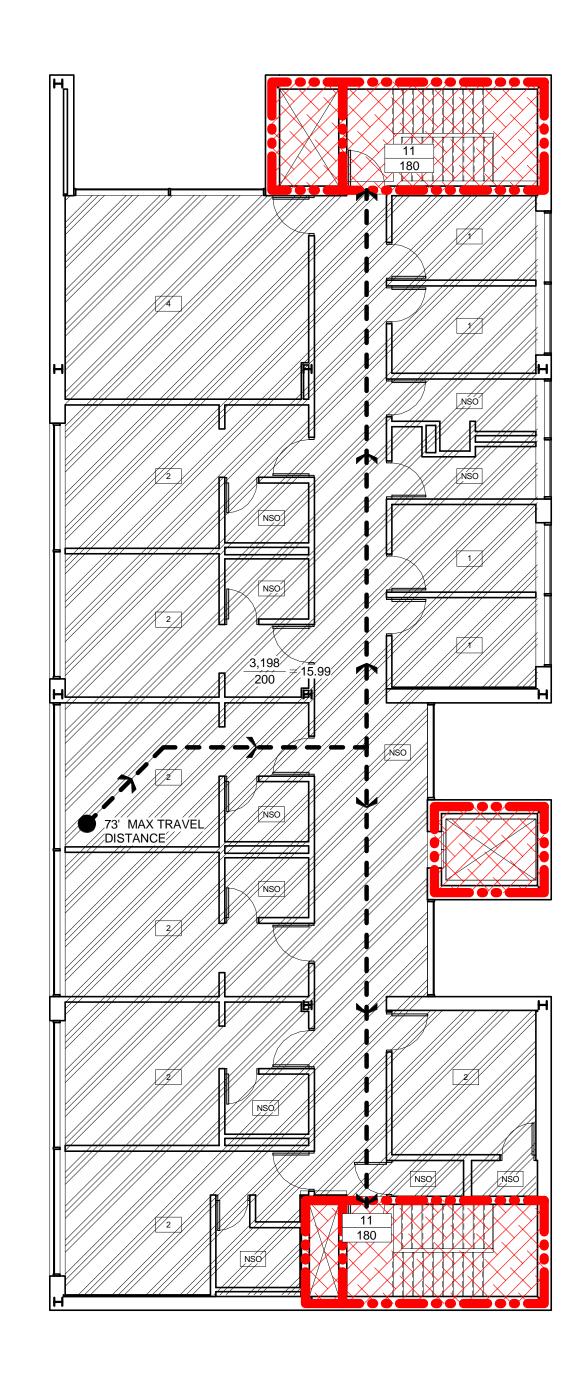


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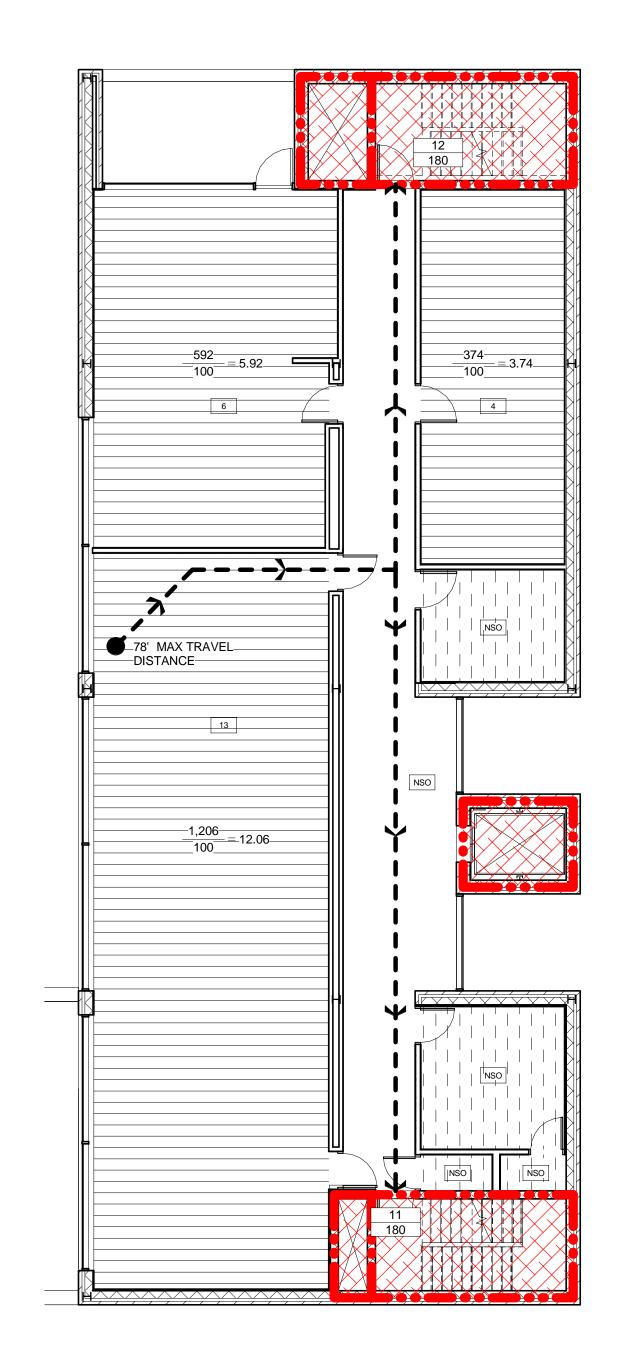






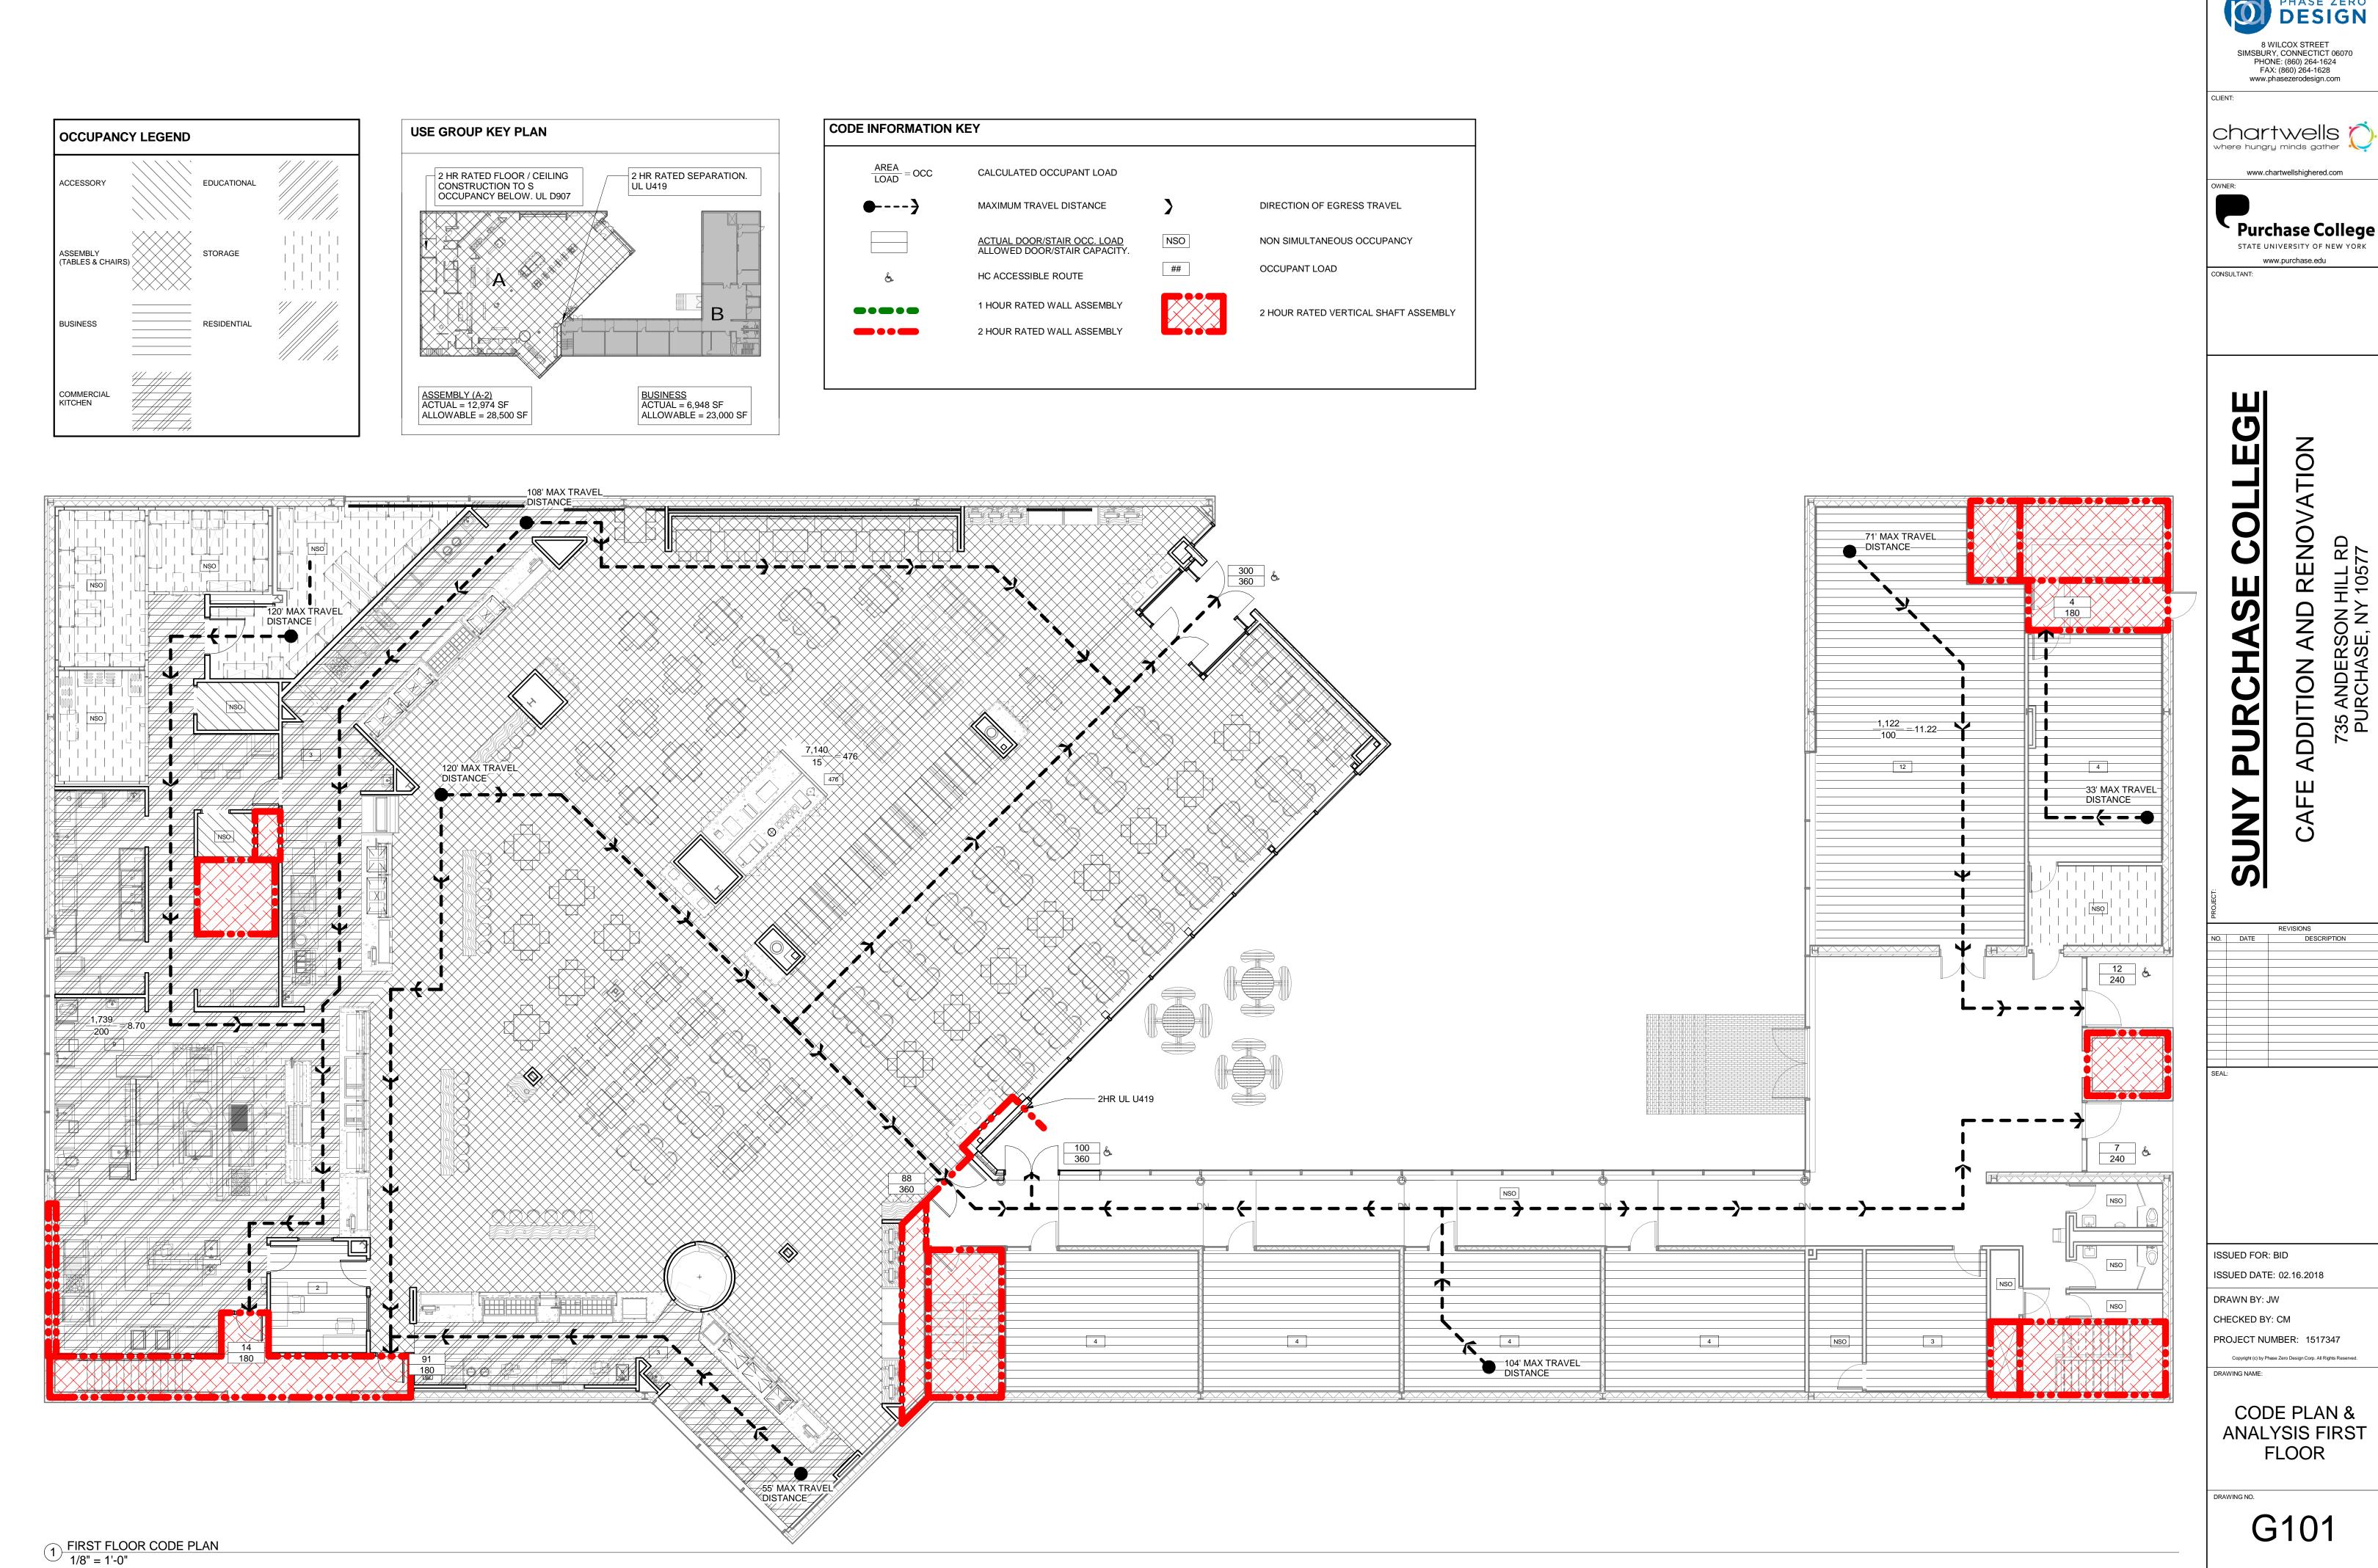

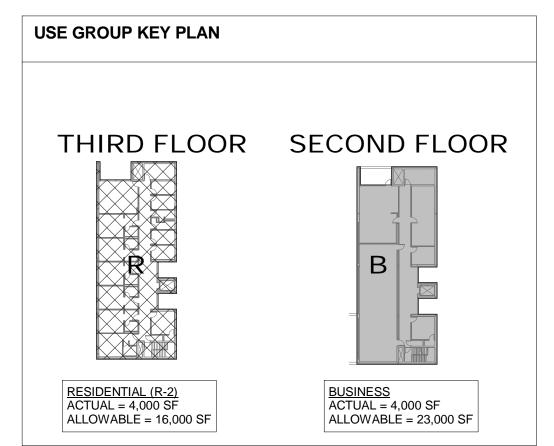2 THIRD LEVEL - CODE PLAN 1/8" = 1'-0"



1 SECOND LEVEL - CODE PLAN 1/8" = 1'-0"

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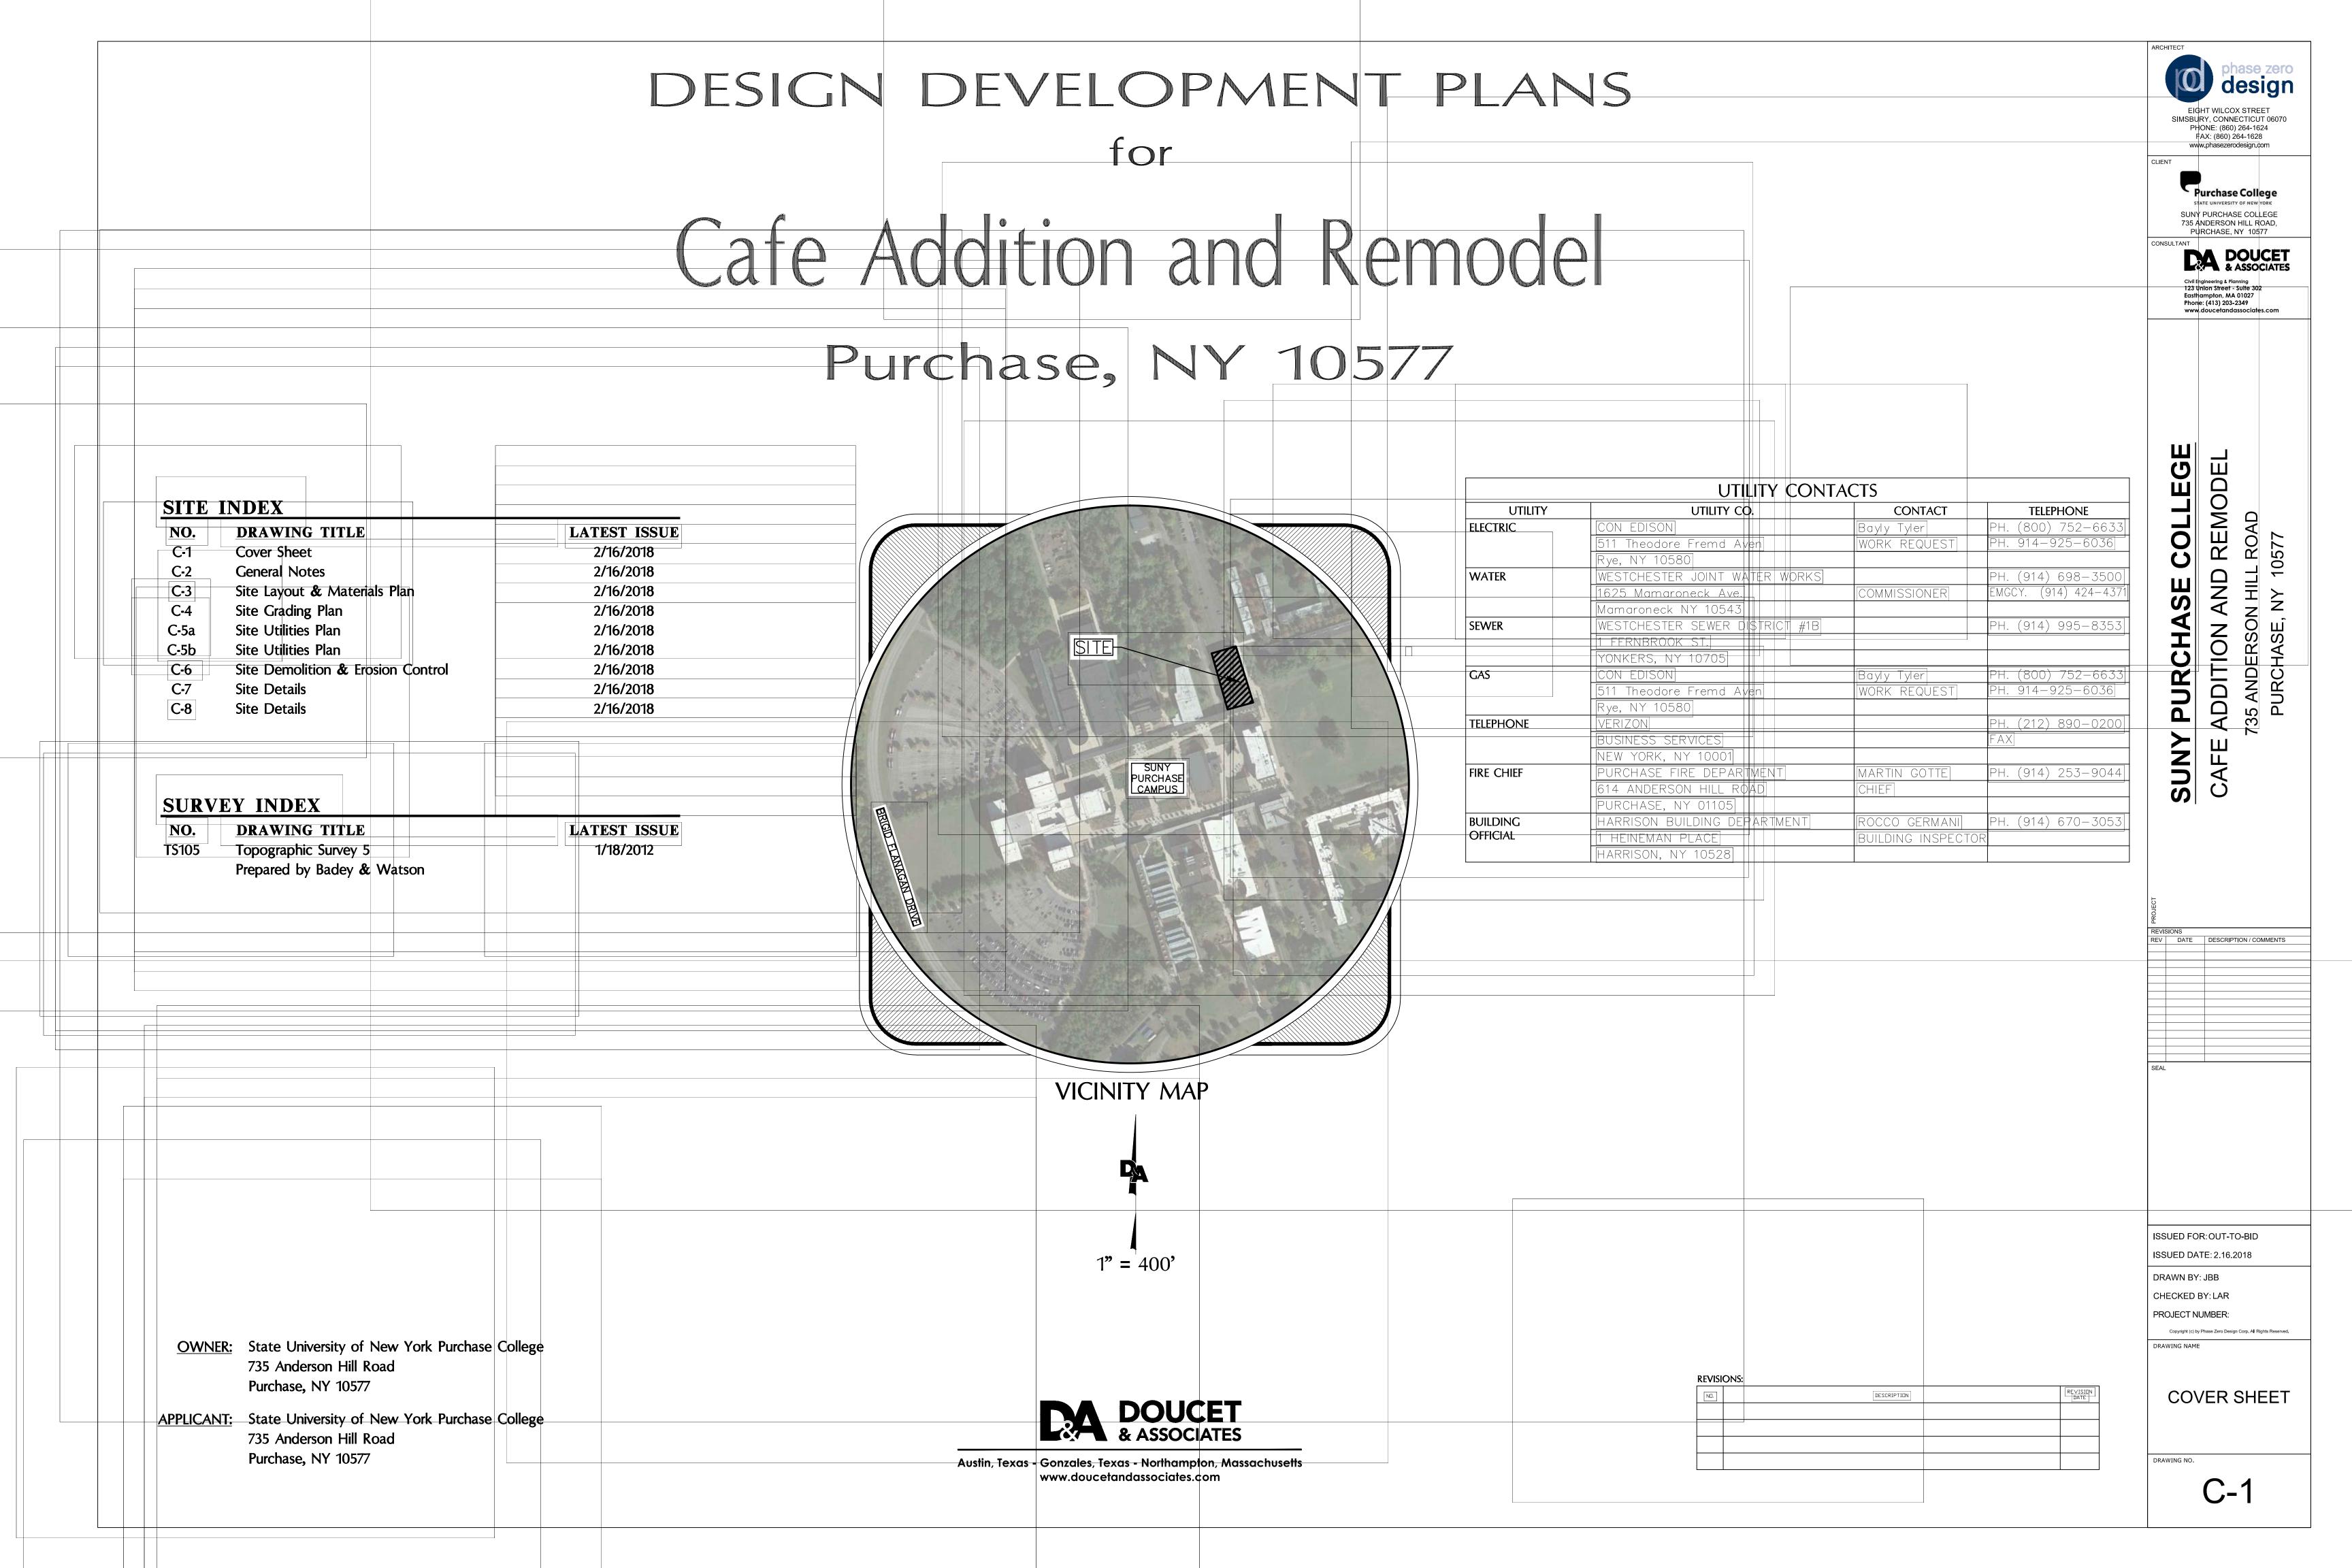
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RAWING NAME:

CODE PLAN &
ANALYSIS SECOND
AND THIRD FLOOR



	LEGEN	
EXISTING	PROPOSED	
		- LOCUS PROPERTY LINE
		- ABUTTER PROPERTY LINE
X	X	- CHAIN LINK FENCE
		- STOCKADE FENCE
10+00	10+00	- BASELINE
<u>100</u>	100	- MAJOR CONTOUR (5 FEET)
100	100	- MINOR CONTOUR (1 FOOT)
		- TREE LINE
		— UNDERGROUND WATER LINE
S		- UNDERGROUND SEWER LINE
		- UNDERGROUND TELEPHONE LINE
		- UNDERGROUND DRAIN LINE
E	E	- UNDERGROUND ELECTRIC LINE
		- UNDERGROUND GAS LINE
OHW-	ОНШ	- OVERHEAD WIRE
0	o	- BOLLARD
		- SIGN
	<del>_0</del> _	- DOUBLE SIGN
٥		- IRON PIPE
		- PULL BOX
	C)	- UTILITY POLE
<b>⊘</b> <i>B</i> −80	<b>B-1</b>	- BORING LOCATION
		- CATCH BASIN
		- DOUBLE CATCH BASIN
$\bigcirc$		- DRAIN MANHOLE
S		- SEWER MANHOLE
10	<b>_</b>	- HYDRANT
₩V		- WATER VALVE
V 4	С	- PLUG/STUB
$\dot{\square}$		- LAMP POST
TBM	TBM	- TEMPORARY BENCHMARK
0 0 0	o o o	- GUARDRAIL
	£45	- TREE (DECIDUOUS)
		- TREE (CONIFEROUS)
"add William.	8	- PARKING COUNT
		- HANDICAP RAMP
on NA on NA	Ø	- HANDICAP PARKING
٨	w Z	- VAN-ACCESSIBLE HANDICAP PAR

### **ABBREVIATIONS**

### **GENERAL**

ACR ADJ CCESSIBLE CURB RAMP APPROX APPROXIMATE BITUMINOUS BERM BITUMINOUS CURB BOTTOM OF SLOP BOTTOM OF SLOP CONCRETE CURB CAPE COD BERM CONCRETE CURB & GUTTER ELEV EXIST FDN GC GE MAX LEVATION **EXISTING** FOUNDATION GRANITE CURB GRANITE EDGING MAXIMUM MAX MCC MIN NIC NTS PCC PROP REM RET REMOC MONOLITHIC CONCRETE CURB MINIMUM NOT IN CONTRACT NOT TO SCALE PRECAST CONCRETE CURB PROPOSED REMOVE RETAIN REMODEL REMOVE AND RESET REMOVE AND STACK SLOPED GRANITE EDGING STOCKADE FENCE TOS TS TYP VGC TOP OF SLOPE TOP OF SLOPE TYPICAL VERTICAL GRANITE CURB

### UTILITY

ASPHALT COATED CORRUGATED METAL PIPE CAP CORRUGATED ALUMINUM PIPE C&C CIP CIT COND DIP UT AND CAPPE CAST IRON PIPE CHANGE IN TYPE DUCTILE IRON PIPE F&G F&C HDPE HH HYD FLARED END SECTION FRAME AND GRATE FRAME AND COVER HIGH DENSITY POLYETHYLENE PIPE ELECTRIC HANDHOLE HYDRANT INVERT ELEVATION PIV PWW POST INDICATOR VALVE PAVED WATER WAY PVC RCP POLYVINYLCHLORIDE PIPE REINFORCED CONCRETE PIPE TSV&B TAPPING SLEEVE, VALVE AND BOX UTILITY POLE

VITRIFIED CLAY PIPE

### SITE PLAN NOTES

- EXISTING CONDITIONS INFORMATION WAS TAKEN FROM A SURVEY PERFORMED BY NORTHEAST SURVEY CONSULTANTS. DATED NOVEMBER 13, 2014 AND COMPILED FROM INFRASTRUCTURE CONSTRUCTION PLANS.
- ALL WORK AND MATERIALS SHALL COMPLY WITH ALL LOCAL, STATE, AND/OR FEDERAL REGULATIONS GOVERNING SUCH OPERATIONS AND ALL OTHER O.S.H.A. STANDARDS.
- CONTRACTOR SHALL REFER TO THE ARCHITECTURAL PLANS FOR EXACT LOCATIONS AND DIMENSIONS OF VESTIBULES, SLOPE PAVING, SIDEWALKS, EXIT PORCHES, PRECISE BUILDING DIMENSIONS, STAIRWAYS AND EXACT BUILDING UTILITY ENTRANCE LOCATIONS.
- ALL DISTURBED AREAS ARE TO RECEIVE MINIMUM FOUR INCHES OF TOPSOIL, SEED, MULCH AND WATER UNTIL A HEALTHY STAND OF GRASS IS ESTABLISHED.
- ALL EDGES OF PAVEMENT TO BE CURBED. BACK OF CURB SHALL BE FLUSH WITH GRADE UNLESS NOTED OTHERWISE. ALL CURBING AS NOTED ON THE DRAWINGS.
- ALL PAVED RADII ARE TO BE 2' UNLESS OTHERWISE NOTED.
- ALL DIMENSIONS AND RADII ARE TO THE EDGE OF PAVEMENT UNLESS OTHERWISE NOTED.
- EXISTING STRUCTURES WITHIN CONSTRUCTION LIMITS ARE TO BE ABANDONED, REMOVED, REMODELED OR RELOCATED AS NECESSARY. ALL COST SHALL BE INCLUDED IN BASE BID.
- EXISTING PAVED AREAS ON SITE (SITE DRIVE, SIDEWALKS, PARKING AREAS) SHALL RECEIVE A SURFACE COURSE AS SPECIFIED IN THE PAVING DETAILS. ADJUST STRUCTURE FRAMES TO MATCH FINISHED GRADE.
- D. ALL CONSTRUCTION IN TOWN RIGHT-OF-WAYS AND/OR EASEMENTS SHALL BE IN ACCORDANCE WITH THE TOWN OF PURCHASE STANDARD SPECIFICATIONS.
- I. IN THE EVENT OF DISCREPANCIES BETWEEN LOCAL SPECIFICATIONS & STATE SPECIFICATIONS, THE MORE STRINGENT REQUIREMENT SHALL GOVERN.
- 12. CONTRACTOR SHALL REFER TO ARCHITECTURAL DETAILS AND SPECIFICATIONS FOR REQUIREMENTS OF CONSTRUCTION AND JOINT SPACING OF SIDEWALKS, RAMPS, AND CURBING ADJACENT TO BUILDING.
- 13. CONTRACTOR IS RESPONSIBLE FOR REPAIRS OF DAMAGE TO ANY EXISTING IMPROVEMENTS DURING CONSTRUCTION, SUCH AS, BUT NOT LIMITED TO, DRAINAGE, UTILITIES, PAVEMENT, STRIPING, CURB. ETC. REPAIRS SHALL BE EQUAL TO OR BETTER THAN EXISTING CONDITIONS.
- 14 THE CONTRACTOR SHALL PROTECT ALL BENCHMARKS AND PROPERTY MONUMENTATION. BENCHMARKS AND MONUMENTATION DISTURBED DURING CONSTRUCTION SHALL BE REPLACED OR
- REPAIRED BY A LICENSED SURVEYOR AT THE CONTRACTORS EXPENSE. 15. ALL STRIPING, PAVEMENT MARKINGS, AND TRAFFIC SIGNAGE SHALL BE IN ACCORDANCE WITH THE MANUAL ON UNIFORM TRAFFIC CONTROL DEVICES, LATEST EDITION, UNLESS OTHERWISE

# NOTED ON THE PLANS. STRIPED AREAS SHALL BE 2 FEET O.C. UNLESS OTHERWISE NOTED..

# **GENERAL NOTES:**

SITE ADDRESS: 735 ANDERSON HILL ROAD PURCHASE, NEW YORK 10577 PARCEL ID: 11110-0454 TOTAL PARCEL AREA: 479,595 SF. (11.0 AC.) Plan 211 Page 97 DEED REFERENCES: R-2 ONE - FAMILY RESIDENCE CURRENT ZONING: **EDUCATIONAL** PROPOSED USES:

PROPOSED STRUCTURES: +/-1,400 SF EXPANSION FLOOD CERTIFICATION: THIS SITE IS ZONED 'X' AS PER FIRM, FLOOD INSURANCE RATE MAP.

TOPOGRAPHIC & ROLINDARY SURVEY INCLUDING PROPERTY LINES EXISTING LITHLITIES SITE TOPOGRAPHY WITH SPOT ELEVATIONS, OUTSTANDING PHYSICAL FEATURES AND EXISTING STRUCTURE LOCATIONS WAS PROVIDED BY THE FOLLOWING COMPANY & WAS DATED DECEMBER

BADFY & WATSON 3043 ROUTE 9 COLD SPRING, NY 10516

PRIOR TO RECORDING THE FINAL APPROVED SITE PLAN, AN AS-BUILT PLAN SHALL BE PROVIDED TO THE OWNER AND DOUCET & ASSOCIATES, INC.

- DISPOSAL OF MATERIALS SHALL BE IN ACCORDANCE WITH ALL LOCAL, STATE, AND/OR FEDERAL REGULATIONS GOVERNING SUCH OPERATIONS.
- ALL CONSTRUCTION IN TOWN RIGHT-OF-WAY SHALL BE COORDINATED WITH THE PURCHASE DPW AND PURCHASE WATER & SEWER COMMISSION.
- ANY DEVELOPMENT, EXCAVATION, CONSTRUCTION IS SUBJECT TO LOCAL, STATE, AND FEDERAL APPROVALS. THE CONTRACTOR SHALL COMPLY WITH ALL PERMIT REQUIREMENTS AND/OR RESTRICTIONS AND ANY VIOLATION WILL BE SUBJECT TO PENALTY. THE CONTRACTOR SHALL HOLD THE OWNER/APPLICANT, THE ENGINEER AND THE LOCAL GOVERNING AGENCIES HARMLESS AGAINST SUCH VIOLATION.
- CONSTRUCTION OF BUILDING, AND UTILITY ENTRANCES SHALL BE IN ACCORDANCE WITH ASSOCIATED ARCHITECTS PLANS PREPARED BY PHASE ZERO DESIGN..
- THE AREA SHALL BE KEPT CLEAN AND FREE FROM DEBRIS AT ALL TIMES DURING CONSTRUCTION.
- ALL AREAS DISTURBED BY CONSTRUCTION SHALL BE RESTORED AND GRADED TO ORIGINAL GRADES UNLESS OTHERWISE SHOWN ON THE THE CONSTRUCTION DRAWINGS.
- 14. A STORMWATER POLLUTION PREVENTION PLAN SHALL BE PREPARED FOR THIS PROJECT. THE
- CONTRACTOR IS RESPONSIBLE FOR IMPLEMENTING THIS PLAN AT THE JOB SITE. THE CONTRACTOR SHALL NOTIFY DIG SAFE @ 1-888-DIG-SAFE OR 811 PRIOR TO
- COMMENCEMENT OF ANY DEMOLITION/CONSTRUCTION ACTIVITY.

### SPECIAL CONSTRUCTION NOTES

- PRIOR TO BEGINNING CONSTRUCTION, THE CONTRACTOR OR HIS AUTHORIZED REPRESENTATIVE SHALL CONVENE A PRE-CONSTRUCTION CONFERENCE BETWEEN THE TOWN OF PURCHASE REPRESENTATIVES, ENGINEER, ARCHITECT, UTILITY COMPANY REPRESENTATIVES, A.I.C. REPRESENTATIVE AND ANY OTHER AFFECTED PARTIES.
- ALL AREAS DISTURBED BY CONSTRUCTION SHALL BE RESTORED AND GRADED TO ORIGINAL GRADES UNLESS OTHERWISE SHOWN ON THE THE CONSTRUCTION DRAWINGS.
- THE CONTRACTOR IS RESPONSIBLE FOR IMPLEMENTING THE STORMWATER POLLUTION PREVENTION PLAN AT THE JOB SITE. CONTRACTOR SHALL PROVIDE INLET PROTECTION TO ADJACENT SITE DRAINS AND/OR CATCH BASINS.
- THE CONTRACTOR SHALL NOTIFY DIG SAFE @ 1-888-344-7233 PRIOR TO COMMENCEMENT OF ANY DEMOLITION/CONSTRUCTION ACTIVITY.
- CONTRACTOR SHALL PROVIDE TWO SETS OF AS-BUILT DRAWINGS, PRIOR TO FINAL PAYMENT. AS-BUILT DRAWINGS SHALL INCLUDE ALL INSTALLED UTILITIES WITH VERTICAL AND HORIZONTAL LOCATIONS AND BE SATISFACTORY TO THE BUILDING OFFICIAL FOR ISSUANCE OF A CERTIFICATE OF OCCUPANCY. THE AS-BUILT DRAWINGS SHALL ALSO INCLUDE PIPE INVERTS, SPOT GRADES AND CONTOUR ELEVATIONS. THE FINAL PLAN SHALL BE STAMPED AND SIGNED BY A MASSACHSETTS REGISTERED PROFESSIONAL LAND SURVEYOR.
- PRIOR TO SUBMITTING THE NOTICE OF TERMINATION, CONTRACT SHALL CLEAN ALL STORMWATER DRAINAGE STRUCTURES, CATCH BASINS, OUTLET CONTROL STRUCTURES AND SUBSURFACE STORMWATER INFILTRATION ACCESS PORTS.
- CONTACT THE PURCHASE WATER AND SEWER COMMISSION & DPW FOR REVIEW & APPROVAL OF ANY MODIFICATIONS TO THE APPROVED SITE PLANS PRIOR TO THE WORK BEING PERFORMED.
- ANY WORK & MATERIAL WITHIN THE TOWN RIGHT-OF-WAY SHALL CONFORM TO THE TOWN OF PURCHASE STANDARD SPECIFICATIONS AND REQUIREMENTS.
- UNDERGROUND UTILITY MARK OUT OF WATER OR SANITARY SEWER STRUCTURES, CONTACT THE COMMISSION'S FIELD SERVICES OFFICE AT 413-787-6206 A MINIMUM OF 72 HOURS BEFORE ANY EXCAVATION OCCURS.

THE PURCHASE WATER AND SEWER COMMISSION IS NOT PART OF DIGSAFE. FOR ANY

- . CONSTRUCTION UPGRADES TO THE WATER AND SEWER SERVICES MAY ONLY BE
- PERFORMED BY COMMISSION APPROVED CONTRACTORS. CONTRACTOR SHALL COORDINATE WITH THE COLLEGE AND ALL OTHER APPLICABLE AGENCIES FOR TEMPORARY LANE CLOSURES OR SHUT-DOWN OF LINCOLN AVENUE.

CONTRACTOR SHALL PROVIDE SAFETY MEASURES INCLUDING FLAG MEN IF NEEDED.

### SITE GRADING NOTES

- THE CONTRACTOR IS SPECIFICALLY CAUTIONED THAT THE LOCATION AND/OR ELEVATION OF EXISTING UTILITIES AS SHOWN ON THESE PLANS IS BASED ON RECORDS OF THE VARIOUS UTILITY COMPANIES, AND WHERE POSSIBLE. MEASUREMENTS TAKEN IN THE FIELD. THE INFORMATION IS NOT TO BE RELIED ON AS BEING EXACT OR COMPLETE. THF CONTRACTOR SHALL CONTACT THE COLLEGE AN DIG SAFE @ 1-888-DIG-SAFE AT LEAST 72 HOURS PRIOR TO BEGINNING CONSTRUCTION TO REQUEST EXACT FIELD LOCATION OF UTILITIES. IT SHALL BE THE RESPONSIBILITY OF THE CONTRACTOR TO RELOCATE ALL EXISTING UTILITIES WHICH CONFLICT WITH THE PROPOSED IMPROVEMENTS SHOWN ON THE PLANS.
- ALL CUT OR FILL SLOPES SHALL BE 3:1 OR FLATTER UNLESS OTHERWISE NOTED. PRECAST STRUCTURES MAY BE USED AT CONTRACTORS OPTION.
- STORM PIPE SHALL BE AS FOLLOWS UNLESS OTHERWISE NOTED: HIGH DENSITY
- POLYETHYLENE PIPE (HDPE) SMOOTH INTERIOR/ANNULAR EXTERIOR. PIPE JOINTS AND FITTINGS SHALL CONFORM TO AASHTO M252 AND M294.
- EXISTING DRAINAGE STRUCTURES TO BE INSPECTED AND REPAIRED AS NEEDED. AND EXISTING PIPES TO BE CLEANED OUT TO REMOVE ALL SILT AND DEBRIS.
- EXISTING GRADE CONTOUR INTERVALS SHOWN AT 1 FOOT INTERVALS.

PROPOSED GRADE CONTOUR INTERVALS SHOWN AT 1 FOOT INTERVALS.

- IF ANY EXISTING STRUCTURES TO REMAIN ARE DAMAGED DURING CONSTRUCTION IT SHALL BE THE CONTRACTORS RESPONSIBILITY TO REPAIR AND/OR REPLACE THE EXISTING STRUCTURE AS NECESSARY TO RETURN IT TO EXISTING CONDITIONS OR
- ALL STORM PIPES ENTERING STRUCTURES SHALL BE GROUTED TO ASSURE CONNECTION AT STRUCTURE IS WATERTIGHT
- 10. ALL STORM SEWER MANHOLES IN PAVED AREAS SHALL BE FLUSH WITH PAVEMENT, AND SHALL HAVE TRAFFIC BEARING (H20) RING & COVER MANHOLES
- CONTRACTOR SHALL ADJUST AND/OR SAWCUT EXISTING PAVEMENT AS NECESSARY TO ASSURE A SMOOTH FIT AND CONTINUOUS GRADE.
- . CONTRACTOR SHALL ASSURE POSITIVE DRAINAGE AWAY FROM BUILDINGS FOR ALL NATURAL AND PAVED AREAS.
- 13. EXISTING CONDITIONS INFORMATION WAS TAKEN FROM A SURVEY PERFORMED BY NORTHEAST SURVEY CONSULTANTS. DATED NOVEMBER 13, 2014 AND COMPILED FROM
- INFRASTRUCTURE DESIGN PLANS. 14. ALL UNSURFACED AREAS DISTURBED BY GRADING OPERATION SHALL RECEIVE 4 INCHES OF TOPSOIL. CONTRACTOR SHALL APPLY STABILIZATION FABRIC TO ALL SLOPES STEEPER THAN 3H:1V. CONTRACTOR SHALL GRASS DISTURBED AREAS IN ACCORDANCE
- WITH THE SPECIFICATIONS UNTIL A HEALTHY STAND OF GRASS IS OBTAINED. 15. ALL STORM MANHOLES SHALL HAVE A SMOOTH UNIFORM POURED MORTAR INVERT FROM INVERT IN TO INVERT OUT.
- IF CONTRACTOR RELOCATES OR SETS NEW BENCHMARKS, THE VERTICAL ELEVATIONS OF THE BENCHMARKS SHALL BE SET, BY A LICENSED SURVEYOR, WITHIN A TOLERANCE OF
- ALL UTILITY ADJUSTMENTS SHALL BE COMPLETED PRIOR TO FINAL PAVING CONSTRUCTION

### SITE UTILITY NOTES

ALL FILL MATERIAL IS TO BE IN PLACE, AND COMPACTED BEFORE INSTALLATION OF

CONTRACTOR SHALL NOTIFY THE COLLEGE AND APPLICABLE UTILITY AUTHORITY INSPECTORS 72 HOURS BEFORE CONNECTING TO ANY EXISTING LINE.

SANITARY SEWER PIPE SHALL BE AS FOLLOWS: SDR35 PER ASTM D 3034, FOR PIPES LESS THAN 12' DEEP SDR26 PER ASTM D 3034, FOR PIPES MORE THAN 12' DEEP

WATER LINES SHALL BE AS FOLLOWS: ALL WATER SYSTEM COMPONENTS AND WATER LINES SHALL COMPLY WITH TOWN OF PURCHASE WATER & SEWER COMMISSION GUIDELINES & POLICIES AND ANY OTHER PUBLISHED TOWN SPECIFICATIONS OR

- CONTRACTOR SHALL MAINTAIN A MINIMUM OF 5' COVER ON ALL WATERLINES.
- WATER AND SANITARY SEWER SEPARATION SHALL BE 10' MIN. HORIZONTAL FROM OUTSIDE EDGE OF PIPES. IF HORIZONTAL SEPARATION CAN NOT BE OBTAINED, THE WATER LINE MUST BE INSTALLED A MIN. OF 18" ABOVE SANITARY SEWER LINE. THE SANITARY SEWER LINE SHALL BE DUCTILE IRON PIPE WITH MECHANICAL JOINTS AT LEAST 10 FEET ON BOTH SIDES OF CROSSING, THE WATER LINE SHALL HAVE MECHANICAL JOINTS WITH APPROPRIATE THRUST BLOCKING AS REQUIRED TO PROVIDE A MINIMUM OF 18" VERTICAL CLEARANCE. MEETING REQUIREMENTS OF ANSI A21.10 OR ANSI 21.11 (AWWA C-151) (CLASS 52).
- LINES UNDERGROUND SHALL BE INSTALLED, INSPECTED AND APPROVED BEFORE
- TOPS OF EXISTING MANHOLES AND OTHER STRUCTURES SHALL BE RAISED AS NECESSARY TO BE FLUSH WITH PROPOSED PAVEMENT ELEVATIONS. ALL UTILITY ADJUSTMENTS SHALL BE COMPLETED PRIOR TO FINAL PAVING CONSTRUCTION.
- ALL CONCRETE FOR ENCASEMENTS SHALL HAVE A MINIMUM 28 DAY COMPRESSION STRENGTH AT 3000 P.S.I.
- 10. DRAWINGS DO NOT PURPORT TO SHOW ALL EXISTING UTILITIES.
- EXISTING UTILITIES SHALL BE VERIFIED IN FIELD PRIOR TO INSTALLATION OF ANY NEW
- . REFER TO ARCHITECTURAL INTERIOR DRAWINGS FOR TIE-IN OF ALL UTILITIES.
- CONTRACTOR IS RESPONSIBLE FOR COMPLYING TO THE SPECIFICATIONS OF THE TOWN OF PURCHASE WITH REGARDS TO MATERIALS OF THE WATER AND SEWER LINES.
- THE CONTRACTOR IS SPECIFICALLY CAUTIONED THAT THE LOCATION AND/OR ELEVATION OF EXISTING UTILITIES AS SHOWN ON THESE PLANS IS BASED ON RECORDS F THE VARIOUS UTILITY COMPANIES, AND WHERE POSSIBLE, MEASUREMENTS TAKEN IN THE FIELD. THE INFORMATION IS NOT TO BE RELIED ON AS BEING EXACT OR COMPLETE. THE CONTRACTOR SHALL CONTACT DIG SAFE @ 1-888-DIG-SAFE AT LEAST 72 HOURS PRIOR TO BEGINNING CONSTRUCTION TO REQUEST EXACT FIELD LOCATION OF UTILITIES. IT SHALL BE THE RESPONSIBILITY OF THE CONTRACTOR TO RELOCATE ALL EXISTING UTILITIES WHICH CONFLICT WITH THE PROPOSED
- ALL NECESSARY INSPECTIONS AND/OR CERTIFICATIONS REQUIRED BY CODES AND/OR UTILITY SERVICE COMPANIES SHALL BE PERFORMED PRIOR TO ANNOUNCED BUILDING POSSESSION AND THE FINAL CONNECTION OF SERVICE.
- CONTRACTOR SHALL COORDINATE WITH ALL UTILITY COMPANIES FOR INSTALLATION REQUIREMENTS AND SPECIFICATIONS.
- REFER TO ARCHITECT PLANS FOR SITE LIGHTING ELECTRICAL PLAN

IMPROVEMENTS SHOWN ON THE PLANS.

The University of the State of New York

THE STATE EDUCATION DEPARTMENT

State Board for Engineering, Land Surveying, and Geology Education Building, 89 Washington Avenue

2nd Floor, Mezzanine East-Wing

Albany, NY 12234 <sup>∞</sup> Email: enginbd@nysed gov

Website www op nysed gov/prof/pels

- CONTRACTOR SHALL COMPLY WITH THE LATEST OSHA STANDARDS & TOWN OF PURCHASE DPW SPECIFICATIONS FOR EXCAVATION AND TRENCHING PROCEDURES. THE CONTRACTOR SHALL BE RESPONSIBLE FOR THE DESIGN AND MAINTENANCE OF ALL SUPPORT SYSTEMS, SLOPING, BENCHING, AND OTHER MEANS OF PROTECTION.
- . CONTRACTOR SHALL ENSURE UNINTERRUPTED SERVICE OF ALL EXISTING UTILITIES ON THE SITE INCLUDING BUT NOT LIMITED TO SEWER, WATER, ELECTRIC, GAS, TELEPHONE, CATV AND OTHERS.
- 20. SITE LIGHT POLES ARE TO REMAIN AND BE RELOCATED AS INDICATED ON THE PLAN.

EIGHT WILCOX STREET SIMSBURY, CONNECTICUT 06070 PHONE: (860) 264-1624 FAX: (860) 264-1628 www.phasezerodesign.com



STATE UNIVERSITY OF NEW YOR SUNY PURCHASE COLLEGE 735 ANDERSON HILL ROAD, PURCHASE, NY 10577

DA DOUCET & ASSOCIATES ivil Engineering & Planning


123 Union Street - Suite 302 Easthampton, MA 01027

Phone: (413) 203-2349 www.doucetandassociates.com

EMO  $\overline{\Upsilon}$ 5  $\triangleleft$ Z 0 NOI-RS Ш **TIDO!** ANDE 2

REV DATE DESCRIPTION / COMMENTS

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Executive Secretary

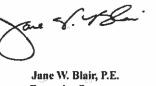DRAWING NAME

LEGEND & **GENERAL** 

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NOTES

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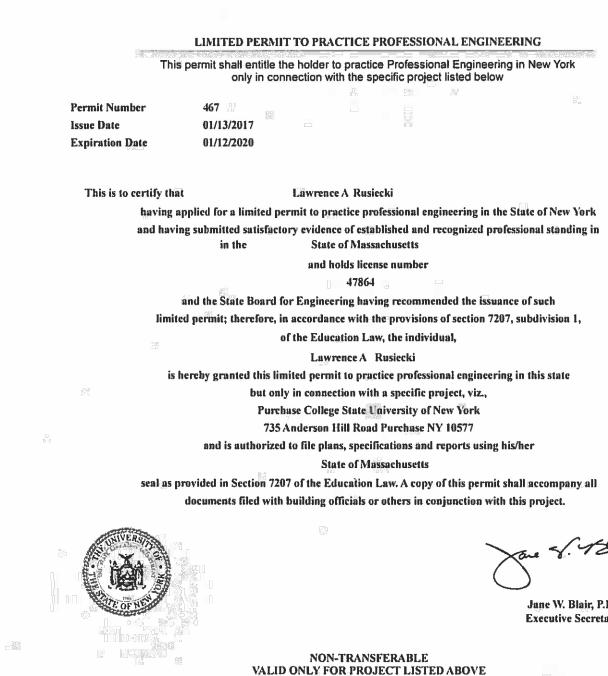
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DRAWN BY: JBB

CHECKED BY: LAR

PROJECT NUMBER:


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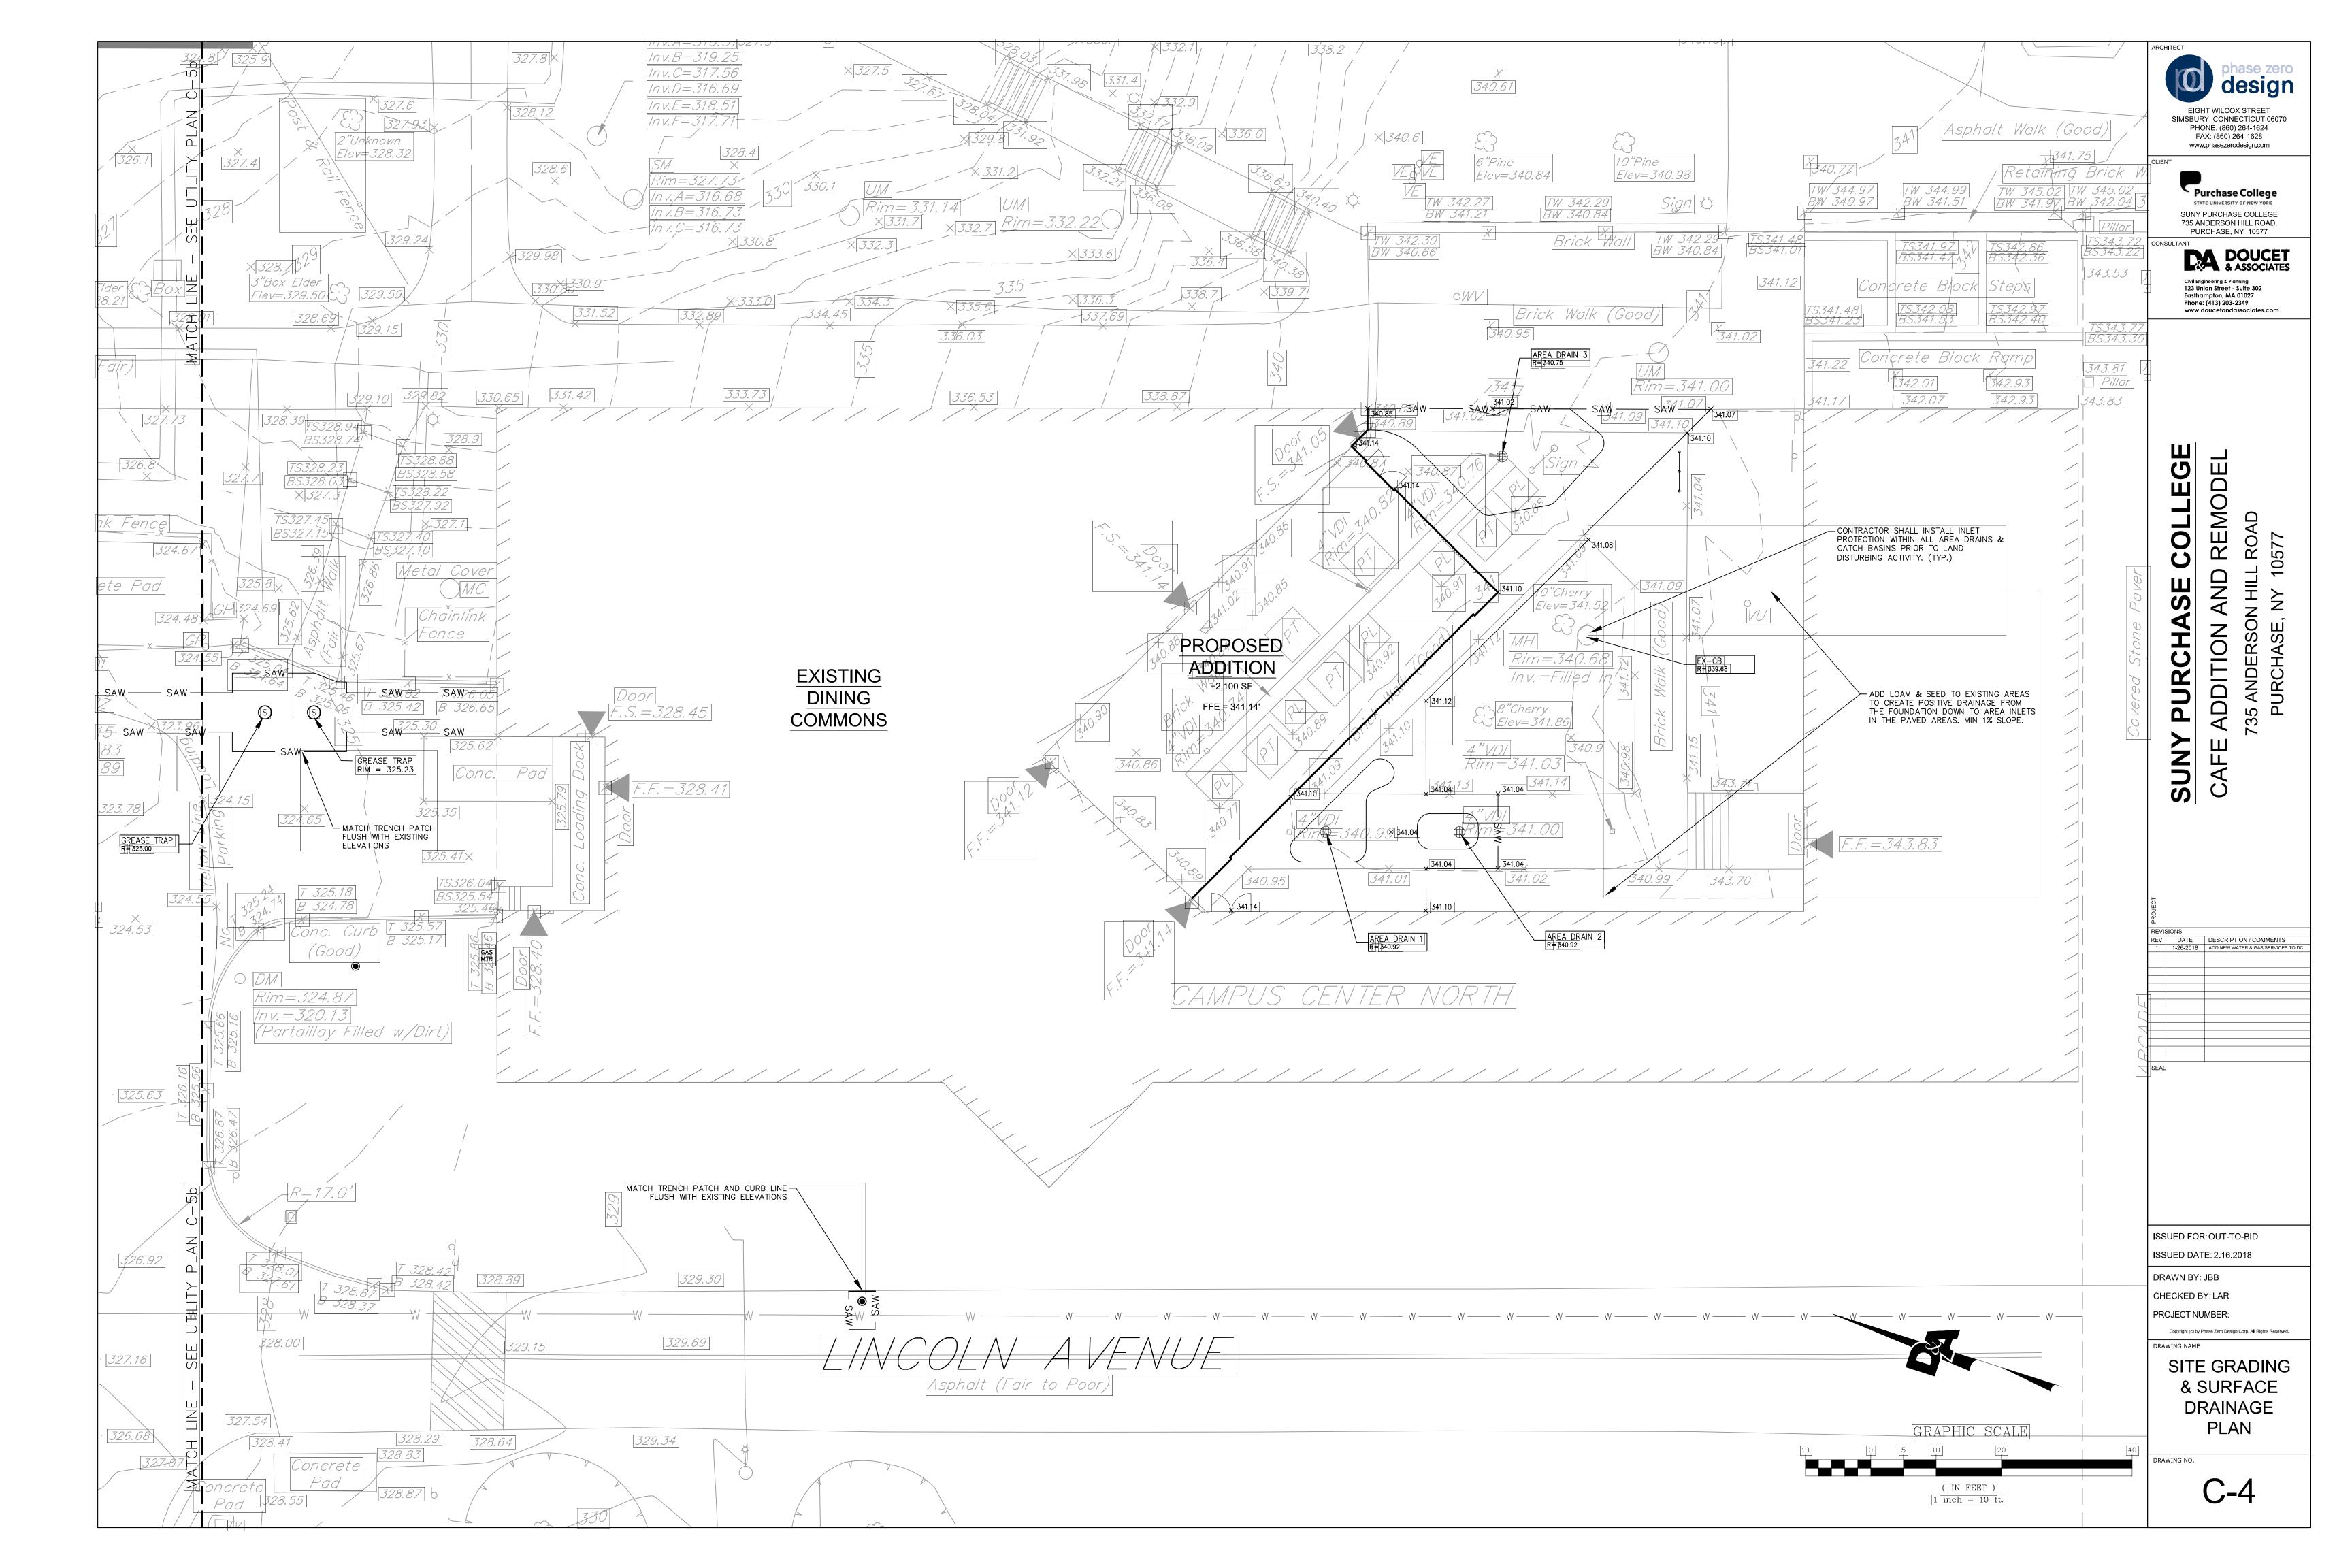



Professional Engineers must register triennially with the department to practice the profession in


New York State. Limited Permit holders whose projects may take longer to complete than the 3 year


registration period must renew their NYS registration to practice the profession in New York State




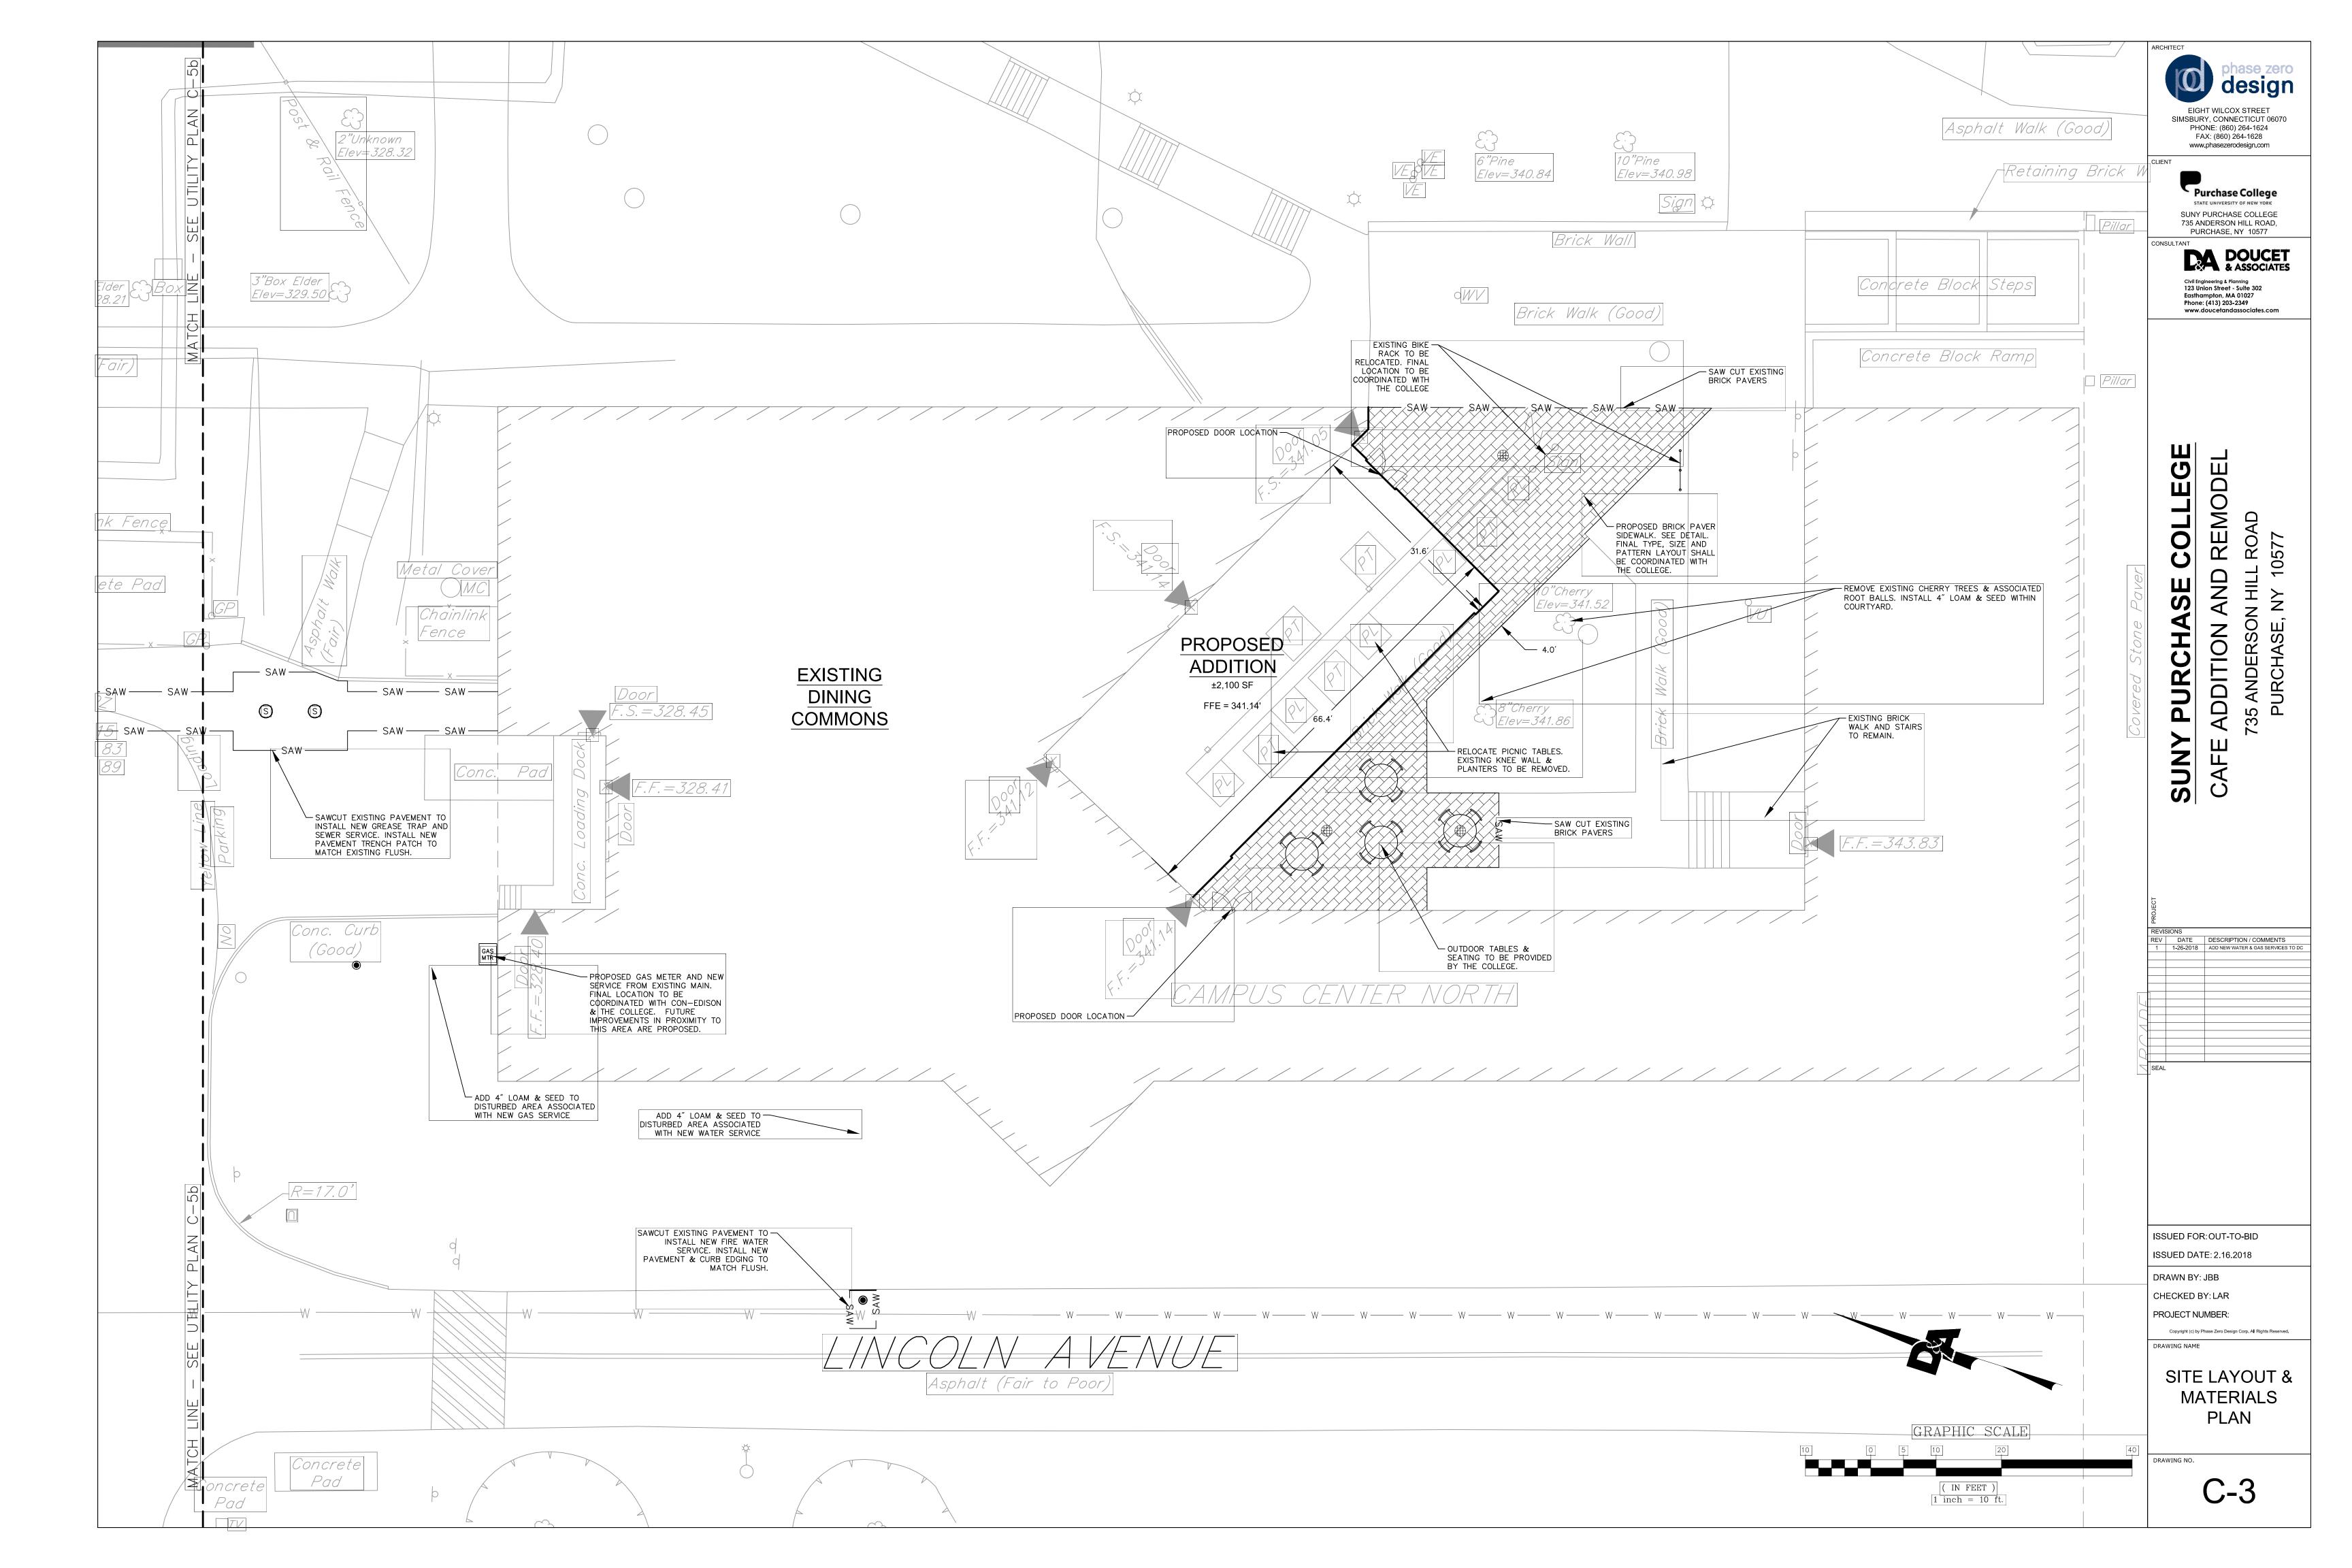


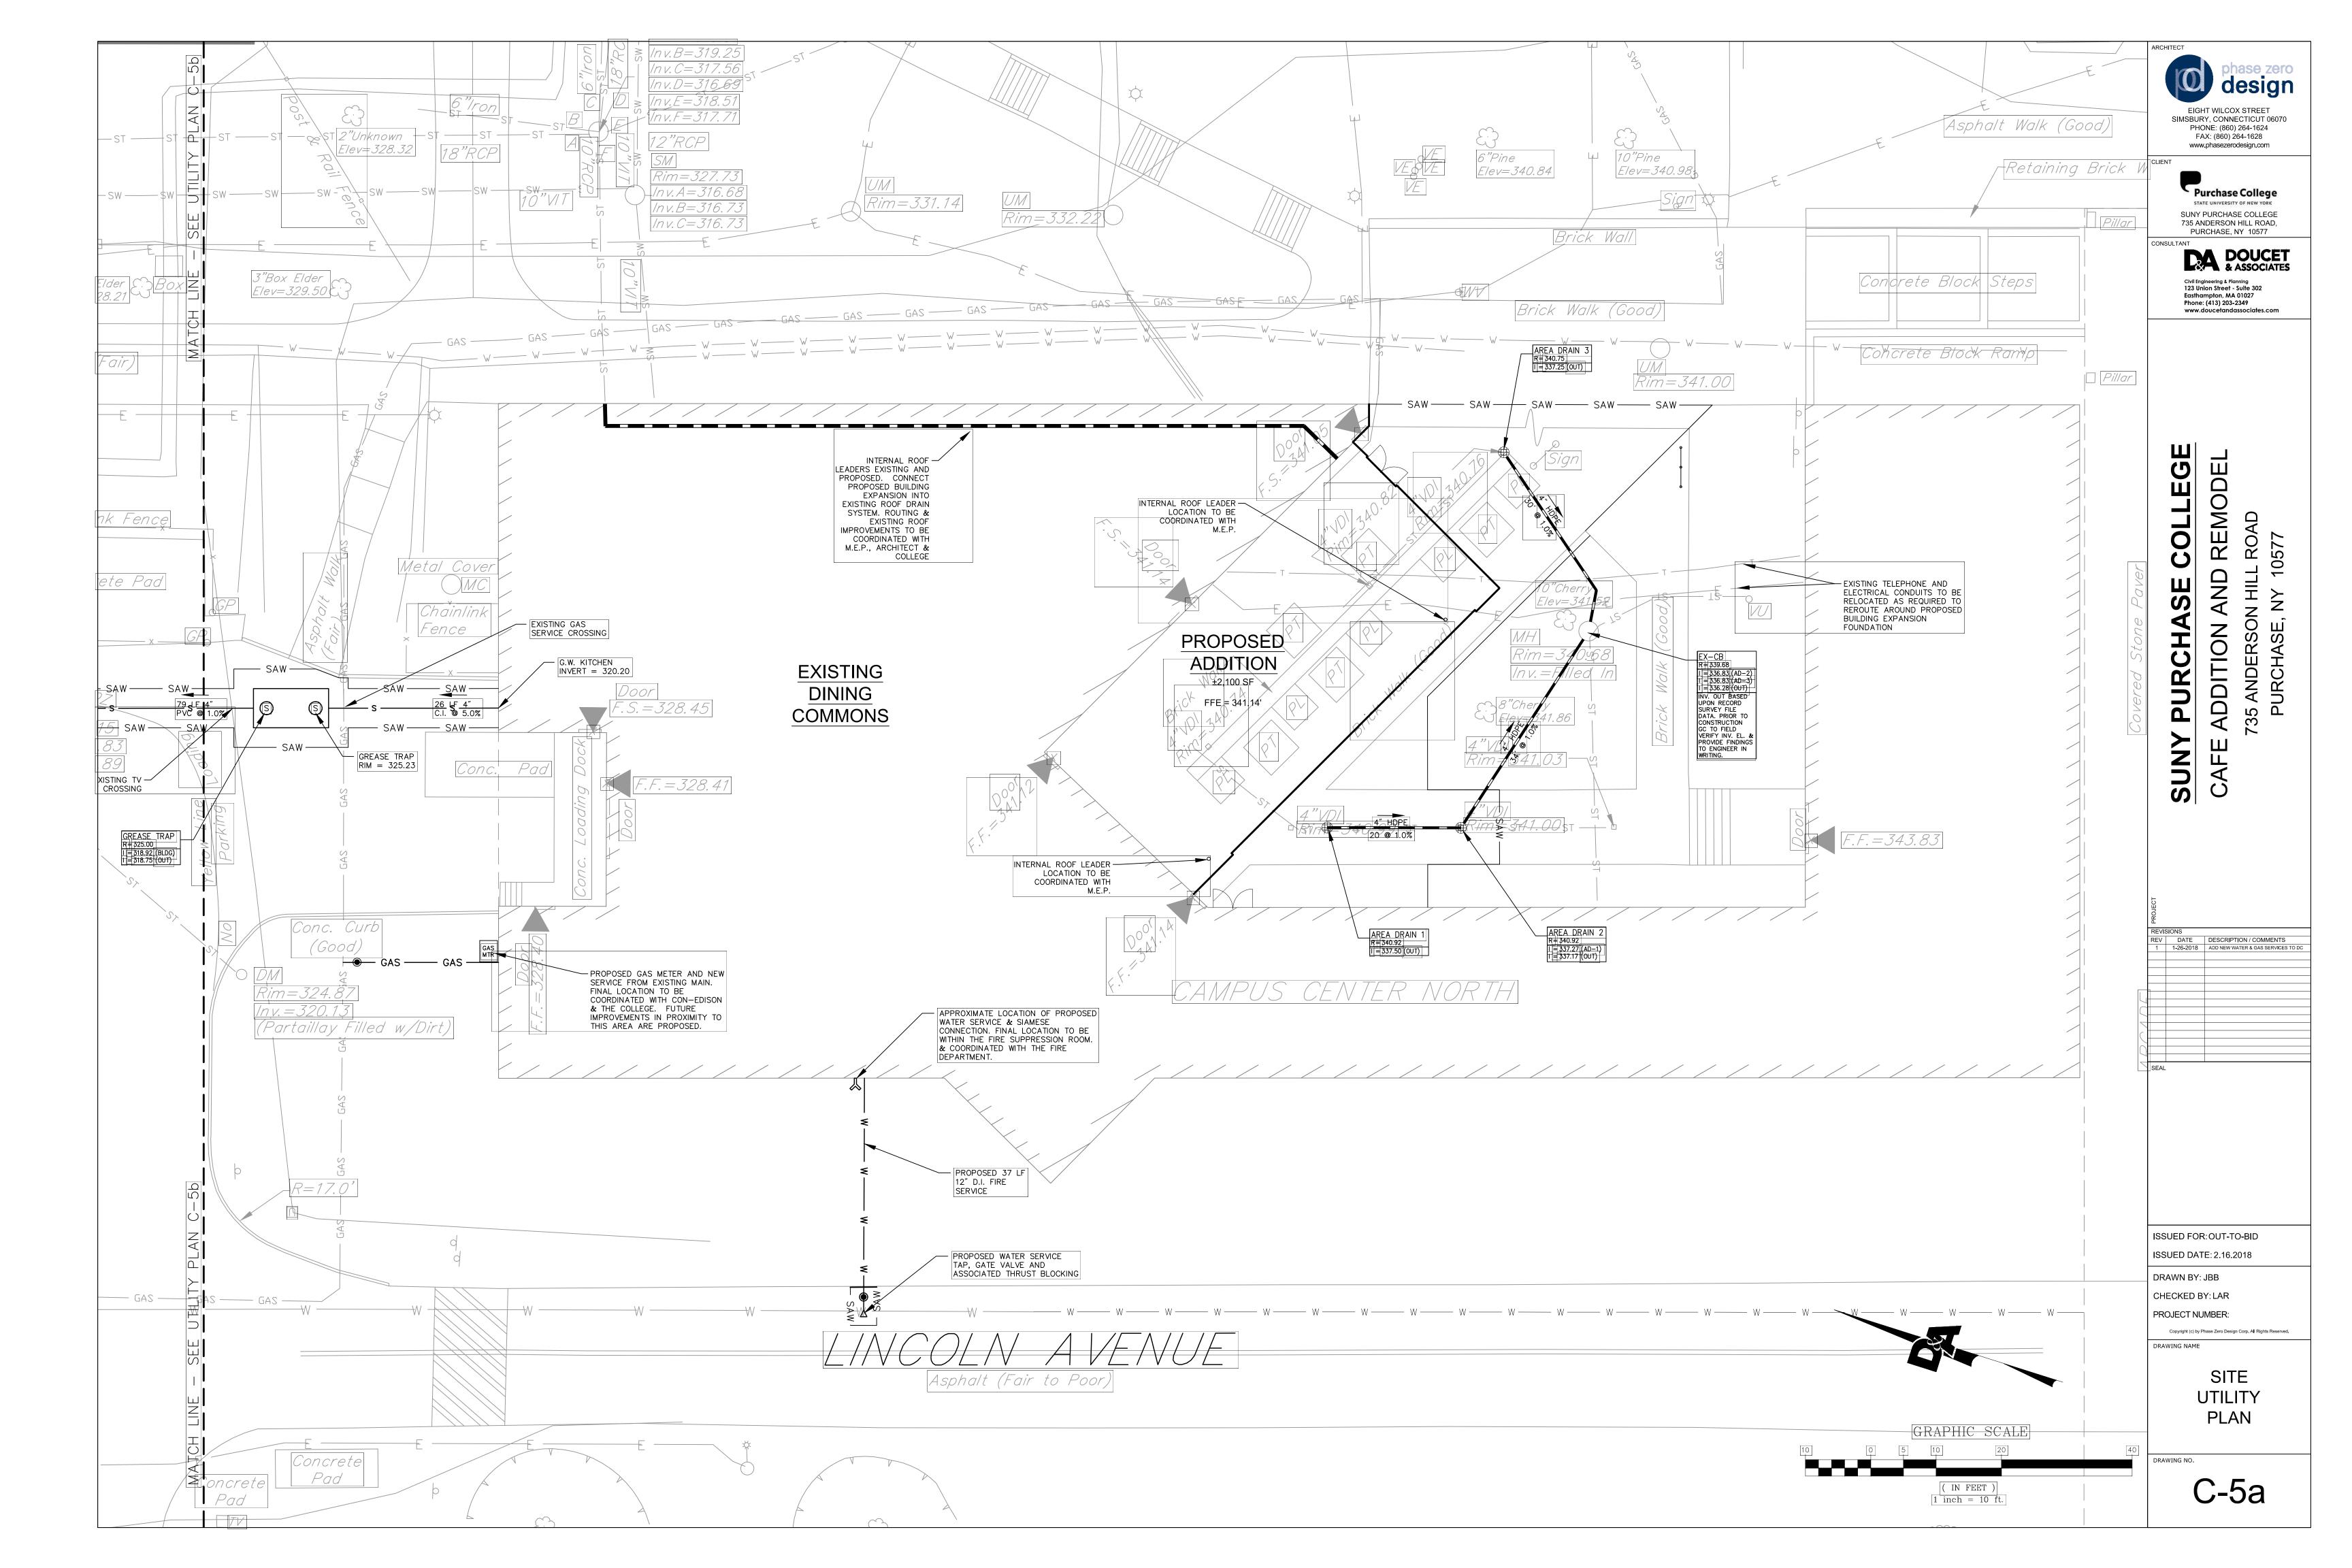


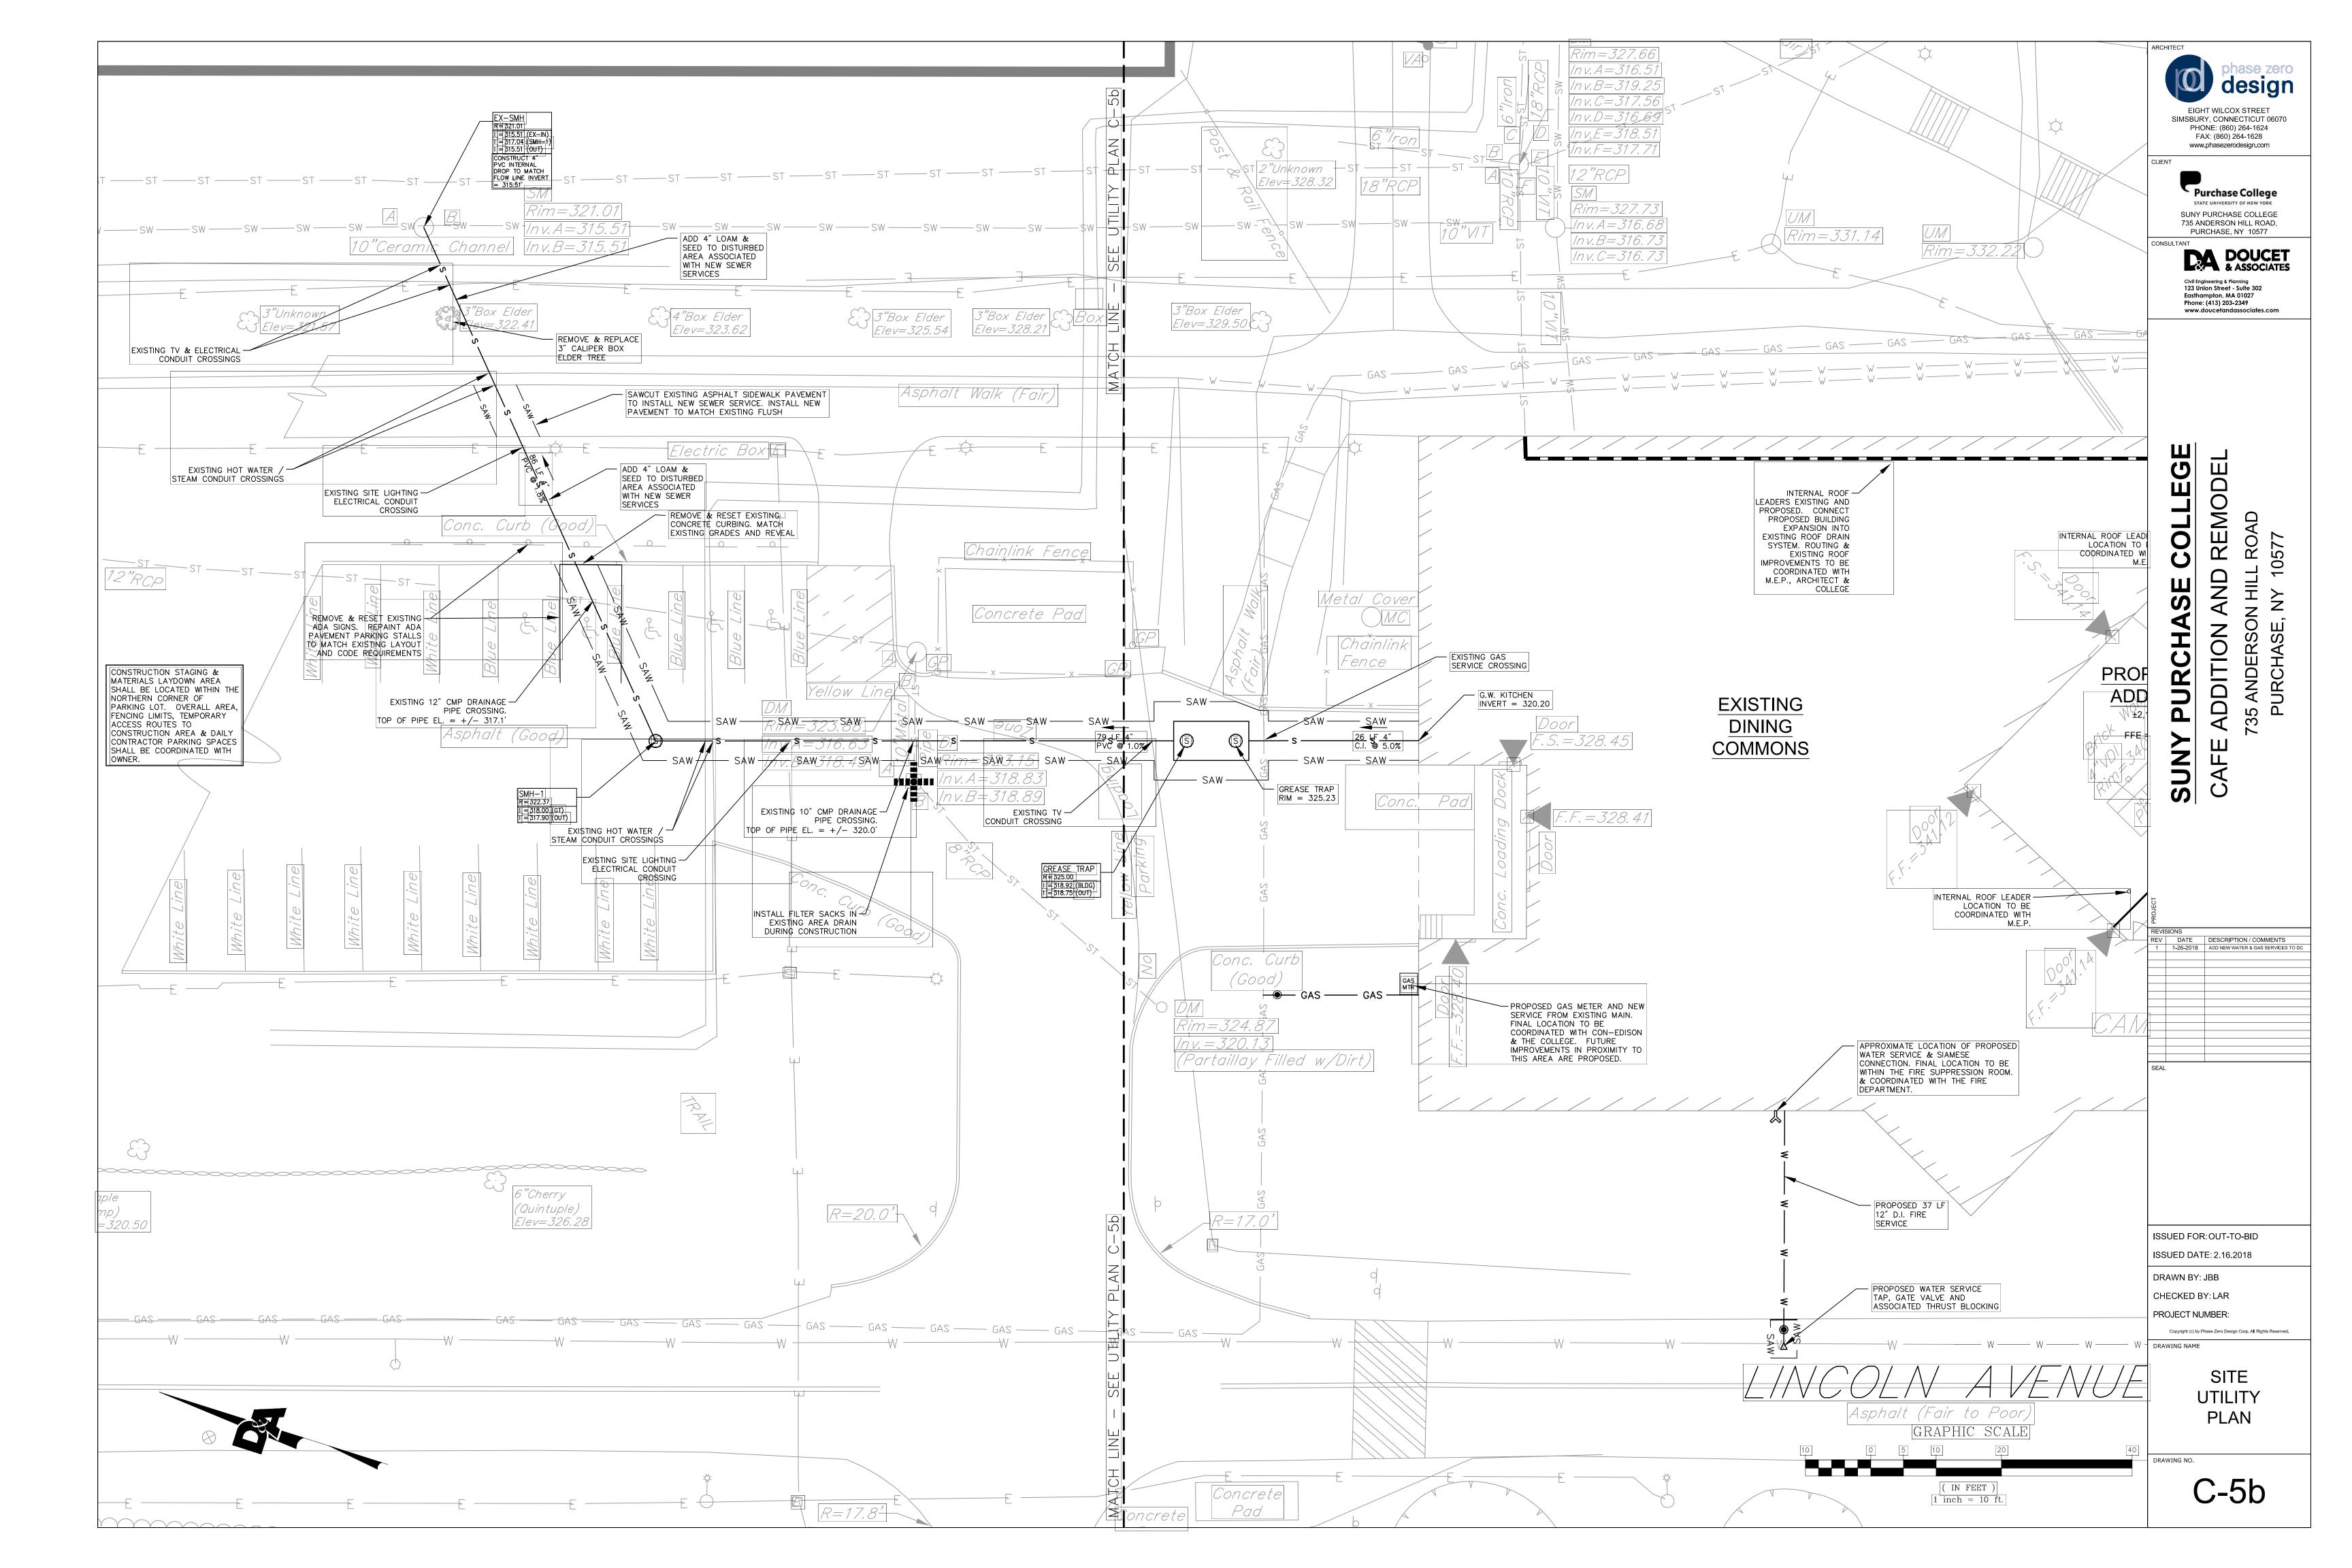

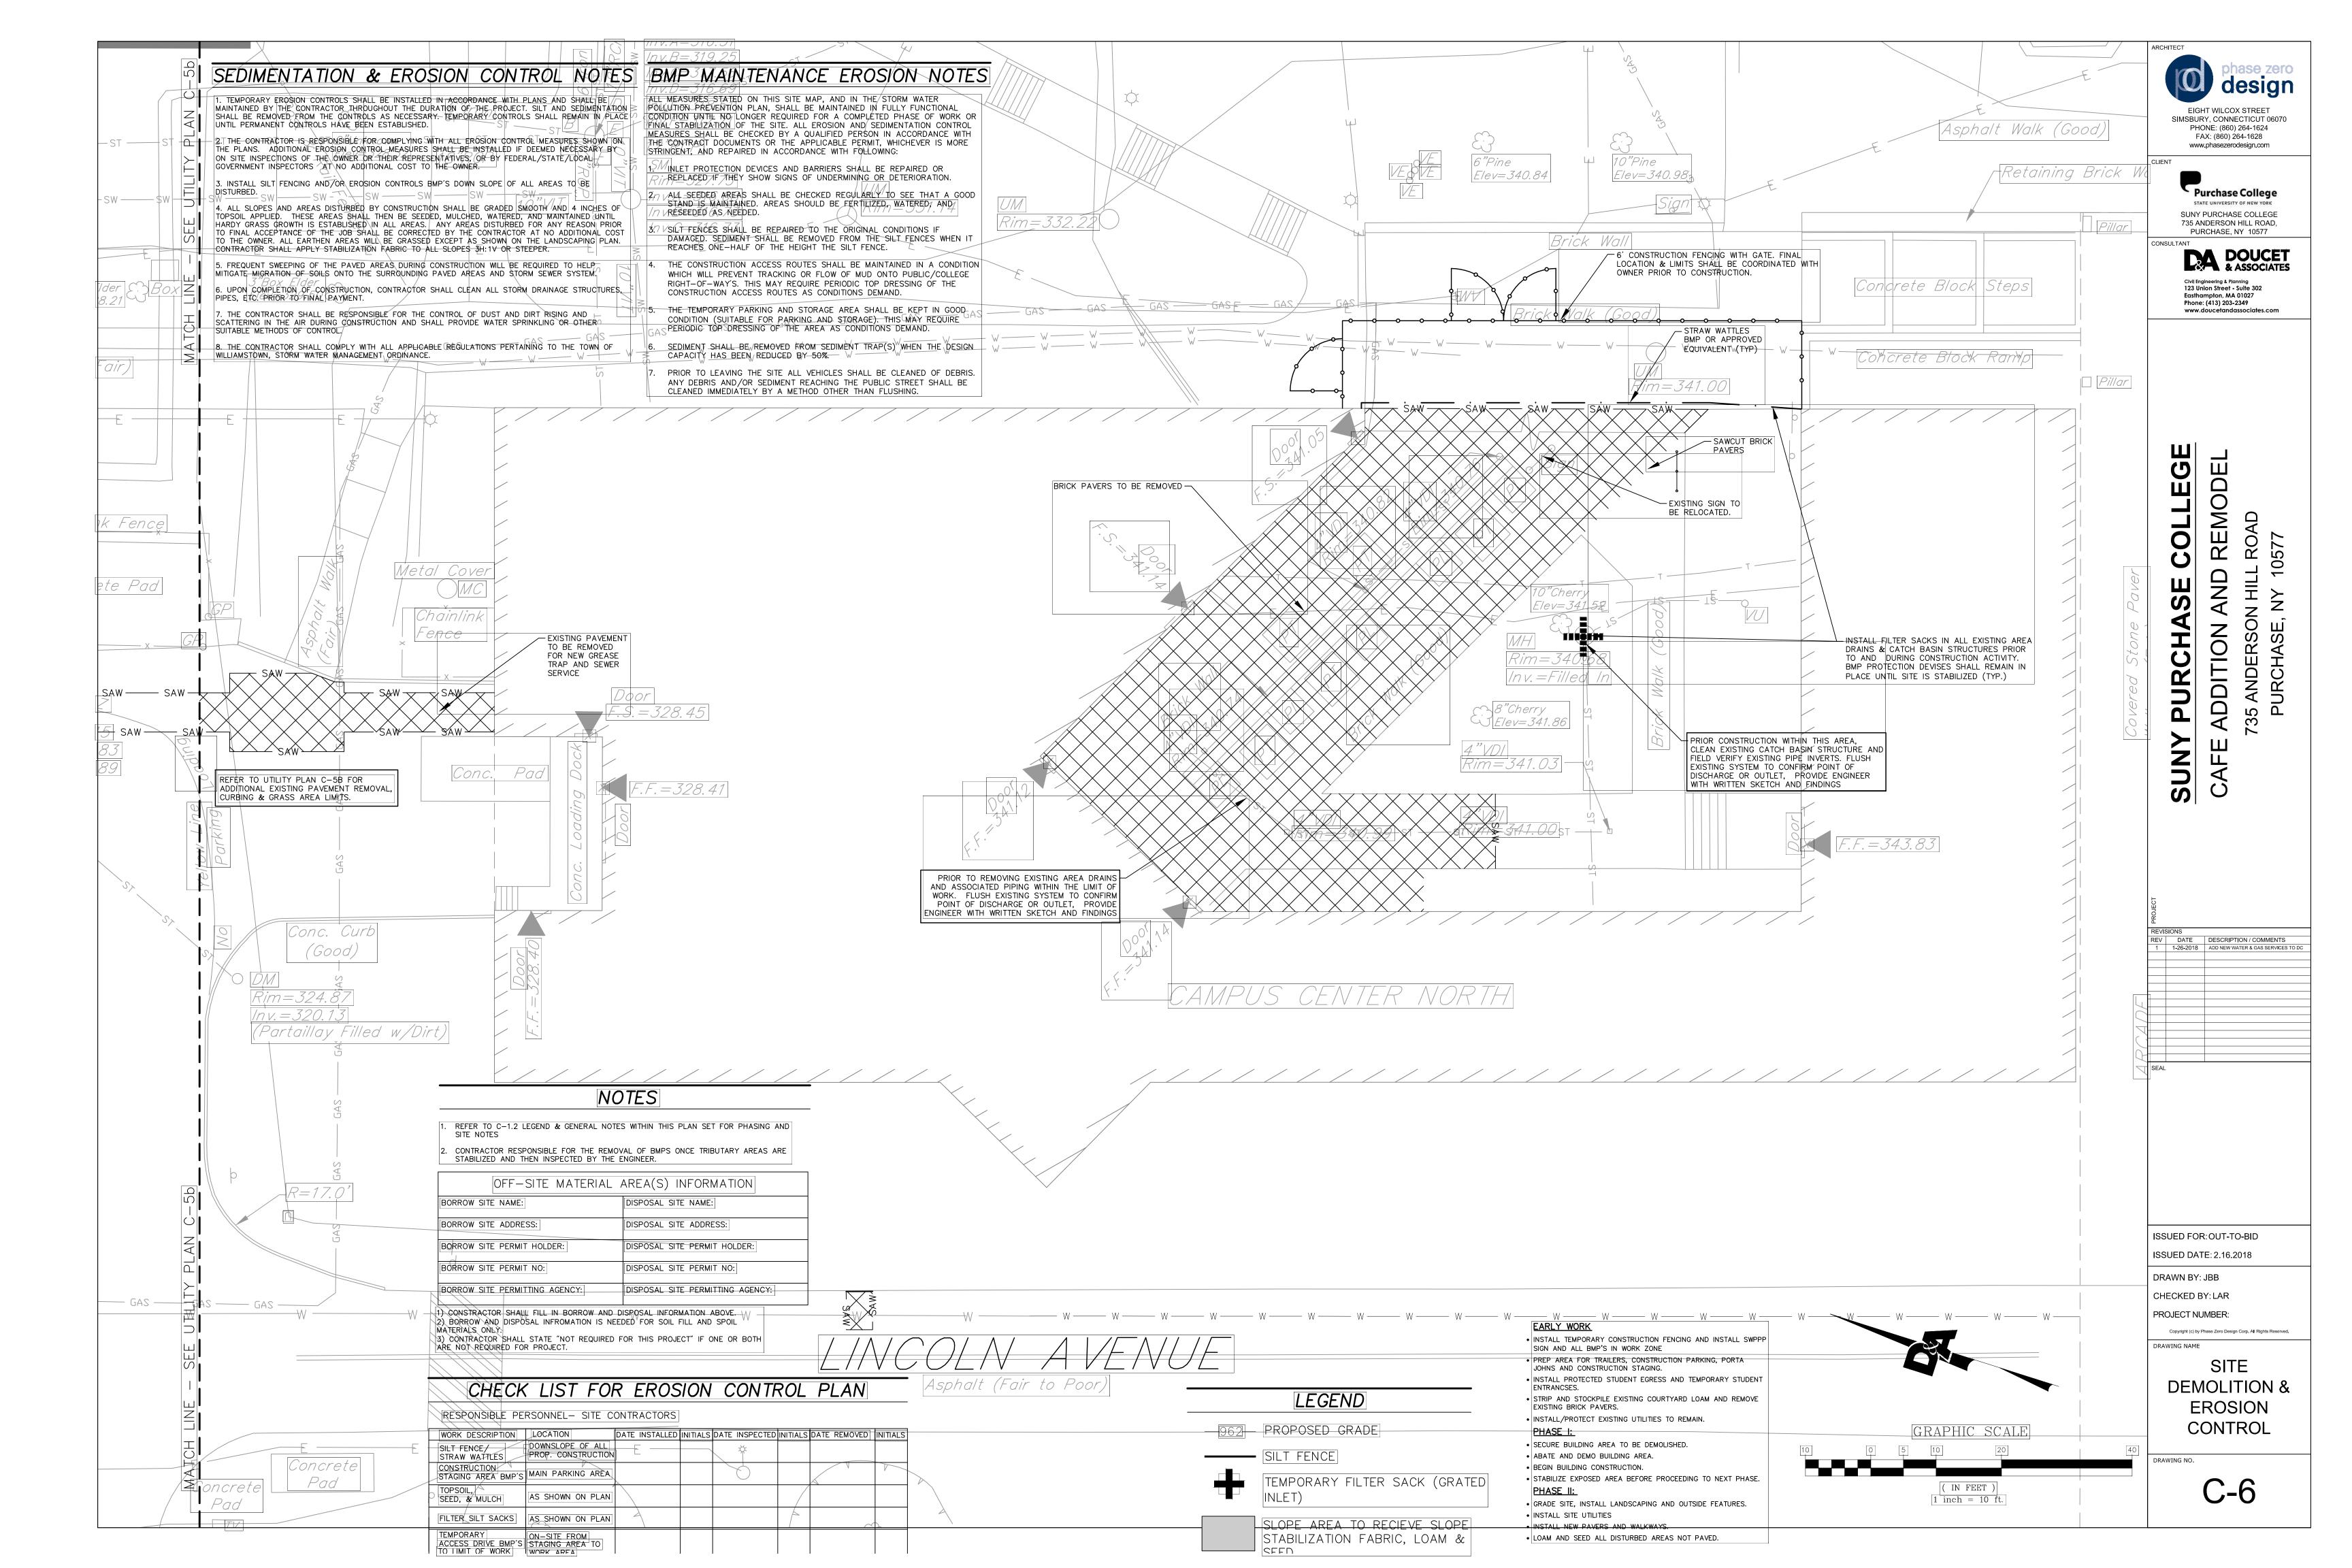

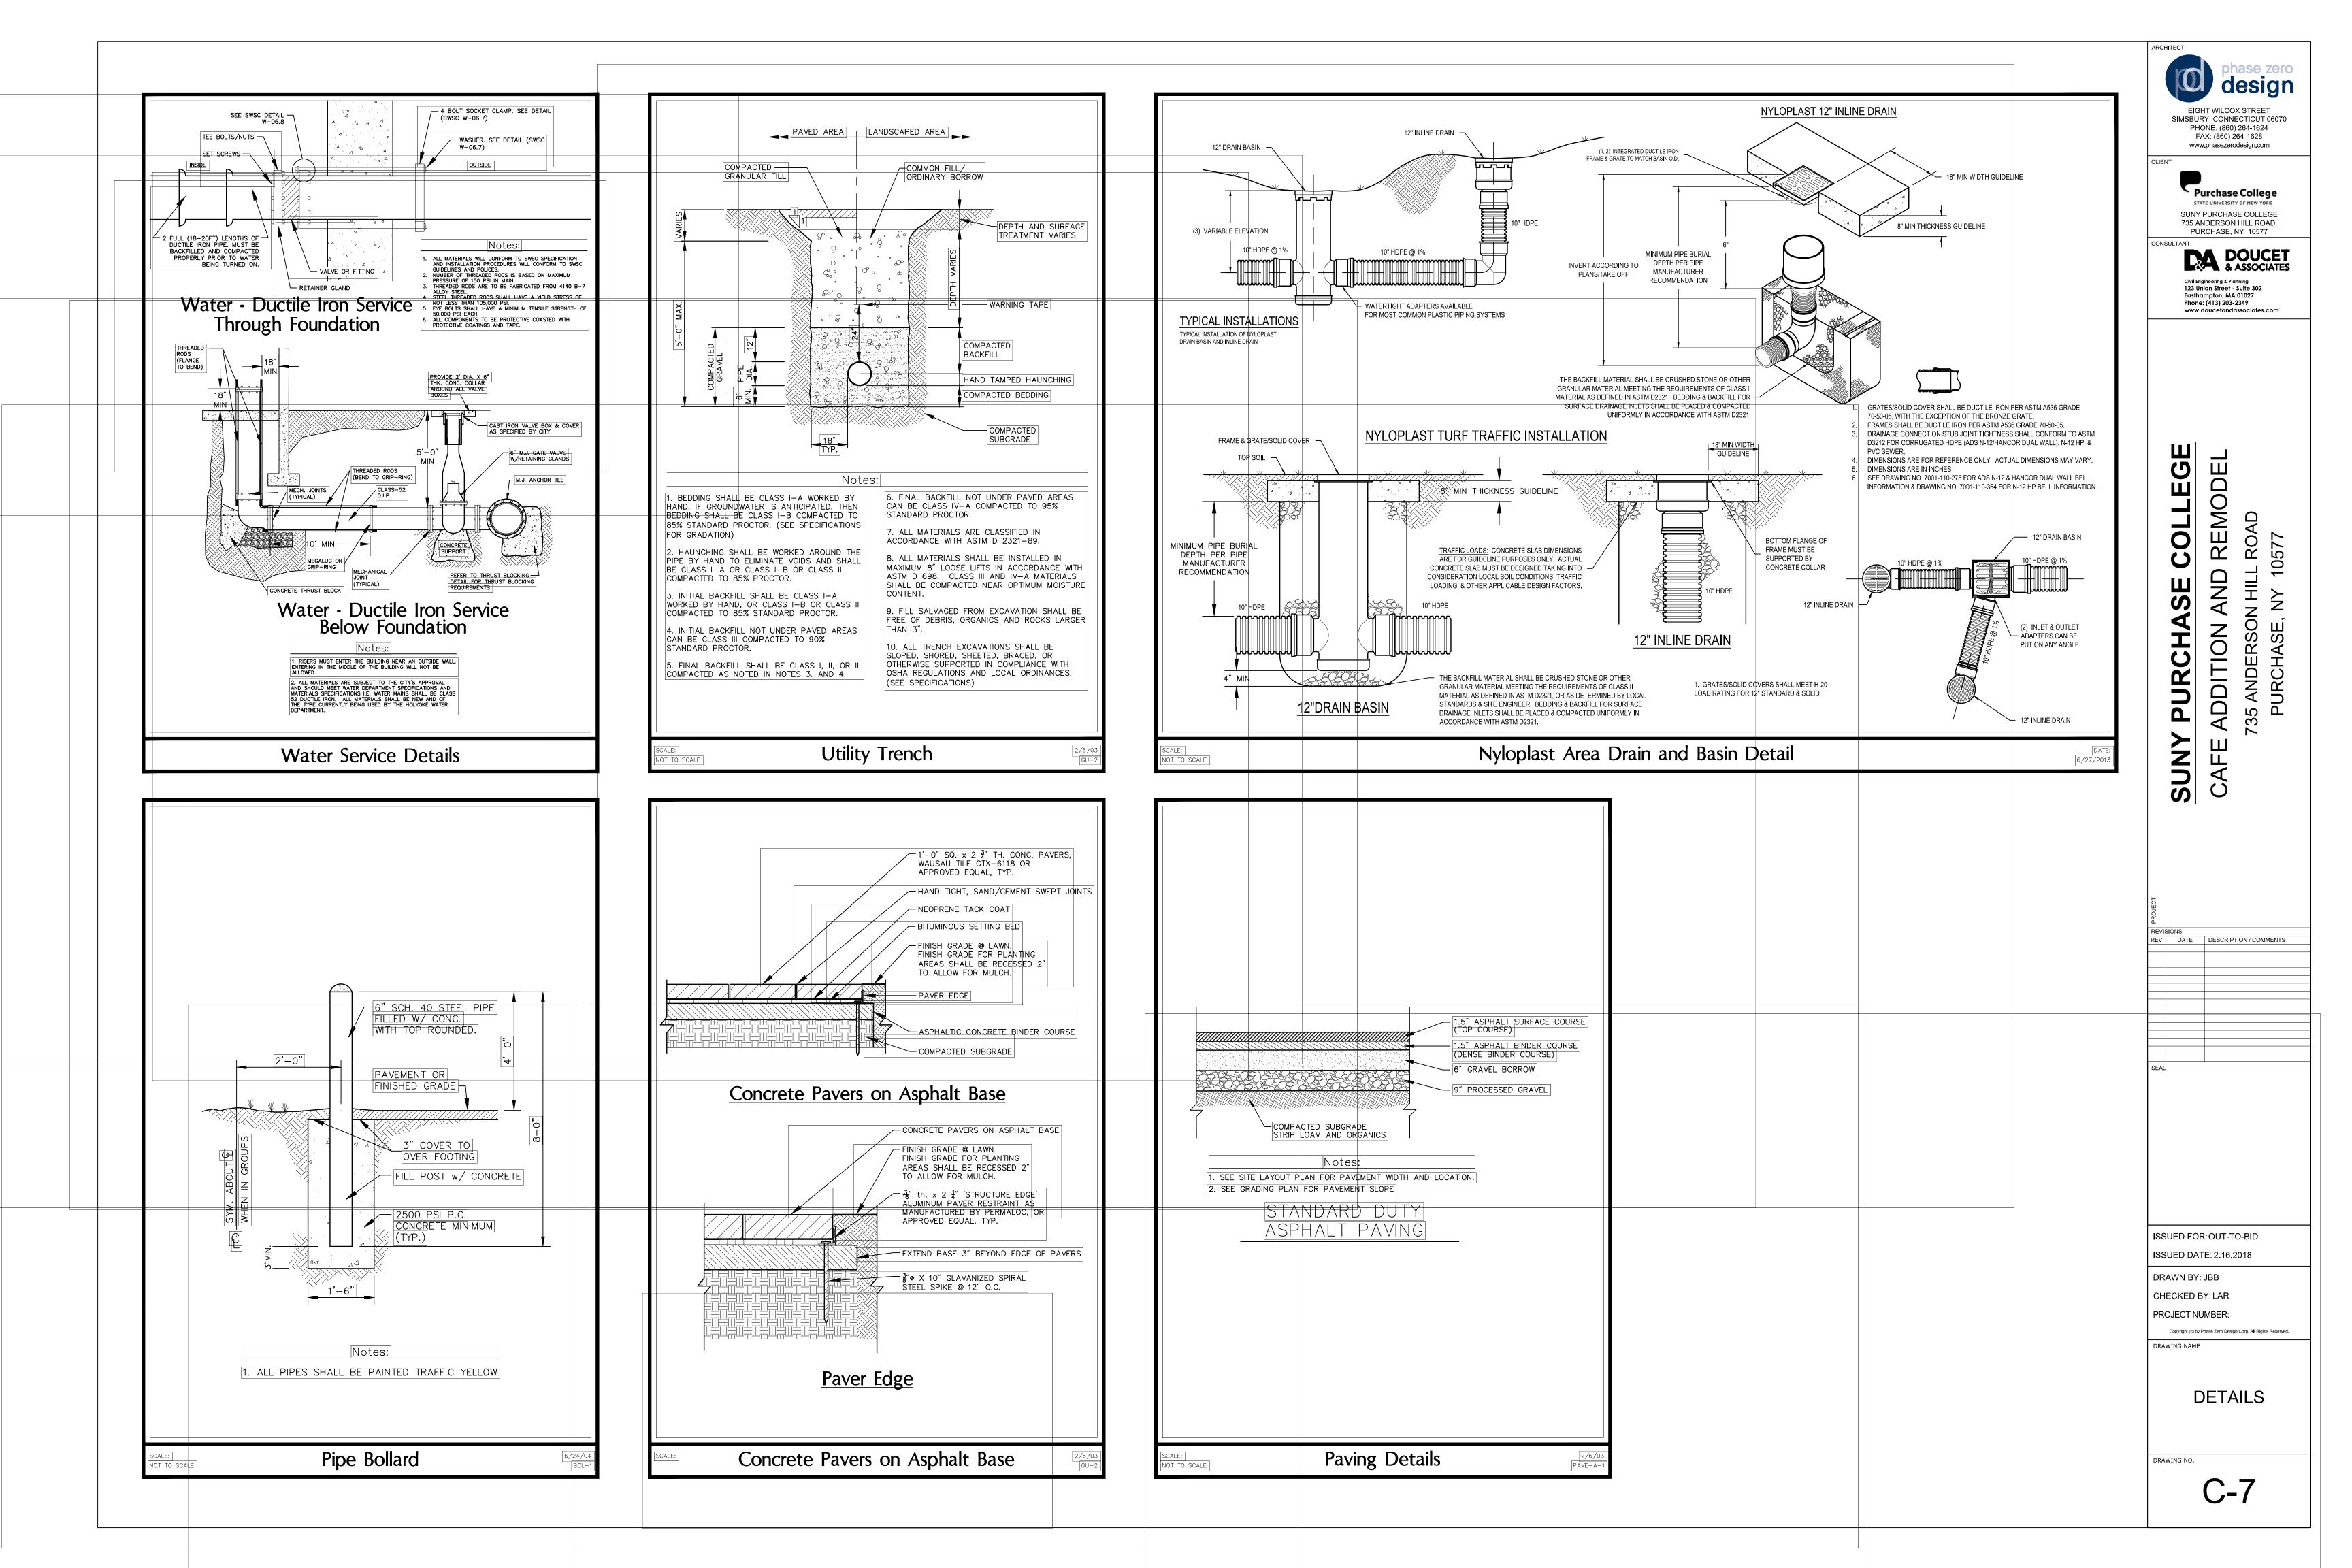

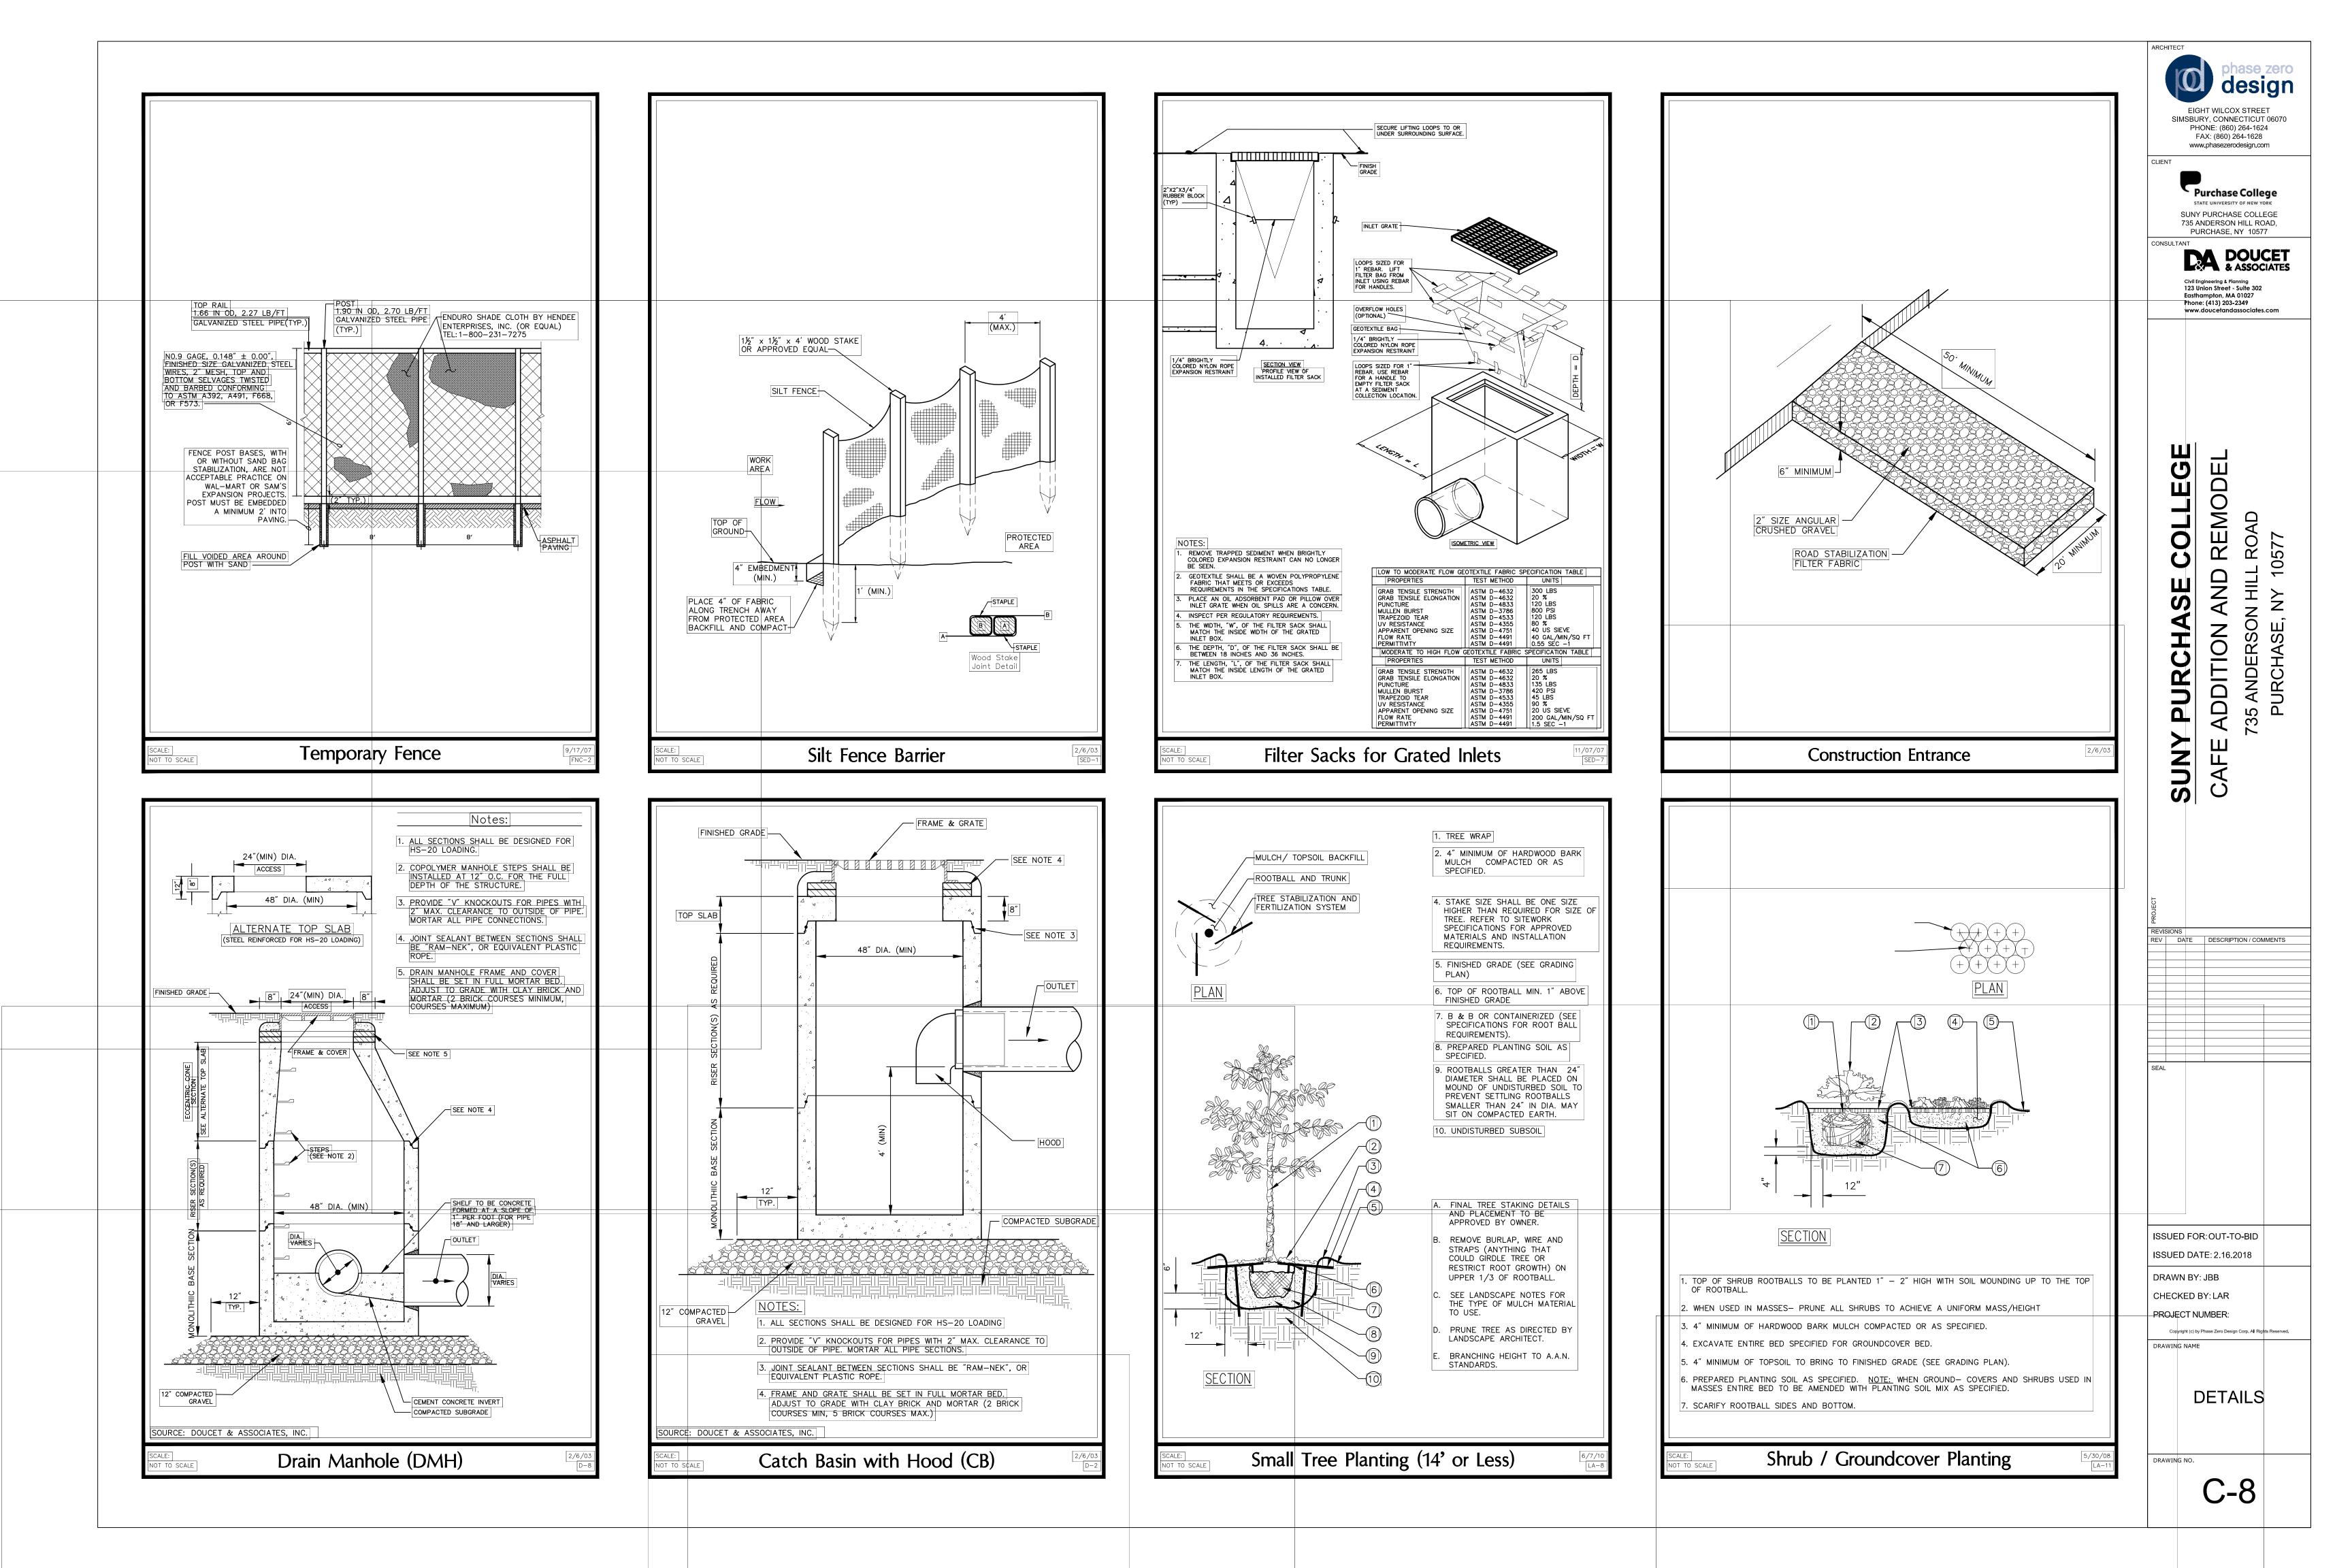

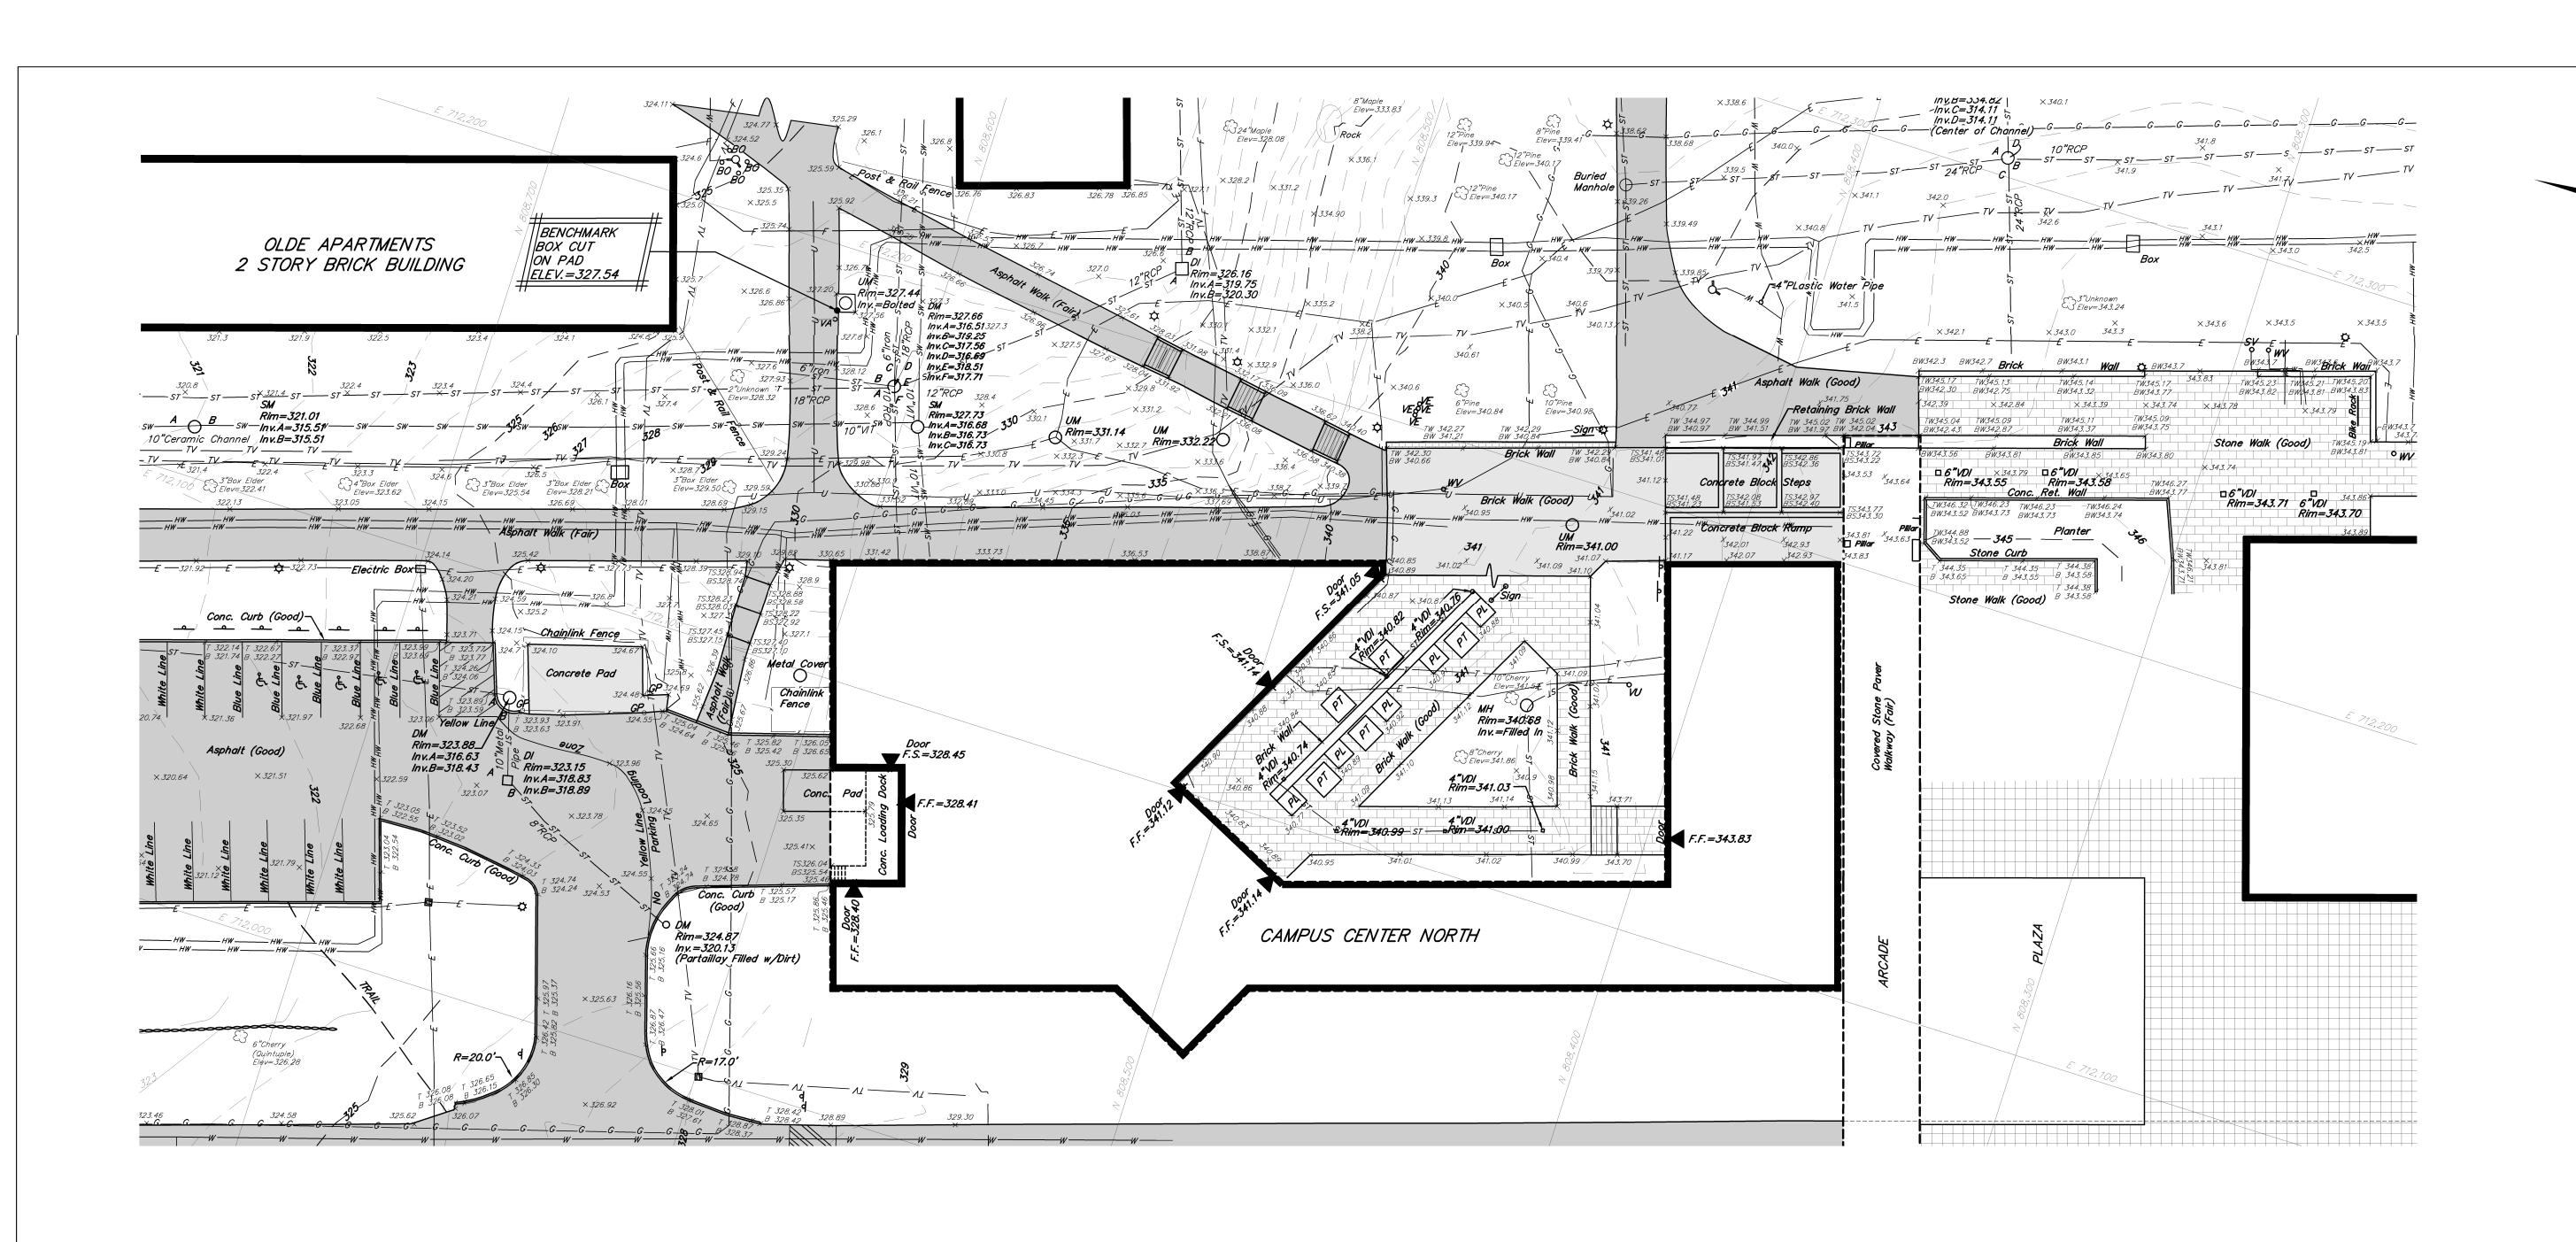



REHABILITATE
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PATHWAYS

State University of New York at Purchase College

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CIVIL MEP ENGINEER:
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Middlesex, NJ 08846

BUILDING ENVELOPE CONSULTANT: ERWIN LOBO BIELINSKI, PLLC 37 West 39th Street, Suite 1201 New York, NY 10018

WARREN & PANZER ENGINEERS, P.C. 228 East 45th Street, 10th Floor New York, NY 10017


COST CONSULTANT:

TOSCANO CLEMENTS TAYLOR

**ENVIRONMENTAL ENGINEER:** 

227 Main Street
Huntington, NY 11743
PREPARED BY:


BADEY & WATSON 3043 Route 9 Cold Spring, NY 10516

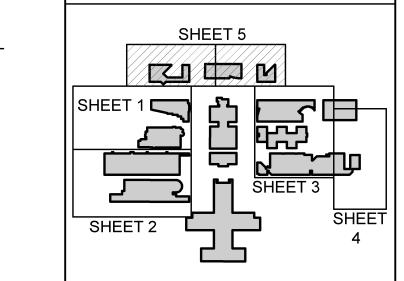

# Key P

FOR ALL NOTES SEE SHEET 5
FOR LEGEND SEE SHEET 5

No. 8	1/18/12	Edited Frame
No. 7	1/13/12	Additional Topography
No. 6	1/04/12	Additional Topography
No. 5	12/20/11	Additional Topography
No. 4	8/4/11	Additional Topography
No. 3	6/24/11	Additional Topography
No. 2	6/2/11	Sheet Set Reformed
No. 1	5/11/11	Original Issue

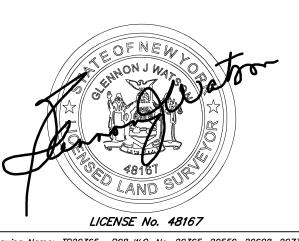


Drawing Name: IP20365\_\_R08 W.O. No. 20365, 20559, 20608, Layout: SHEET 5 T.M. : 0661-1, 0661-13 GEOGRAPHIC INDEX: 382790, 673890

Drawing Title:

TOPOGRAPHIC SURVEY 5

Contract No. SUCF 29435			
Drawn by:	DAP	Drawing No.	
Approved by:	GJW	TS105	
Scale: 1"=20'		13103	
Date: APRIL 28	, 2011	Sheet No. 9 of 58	

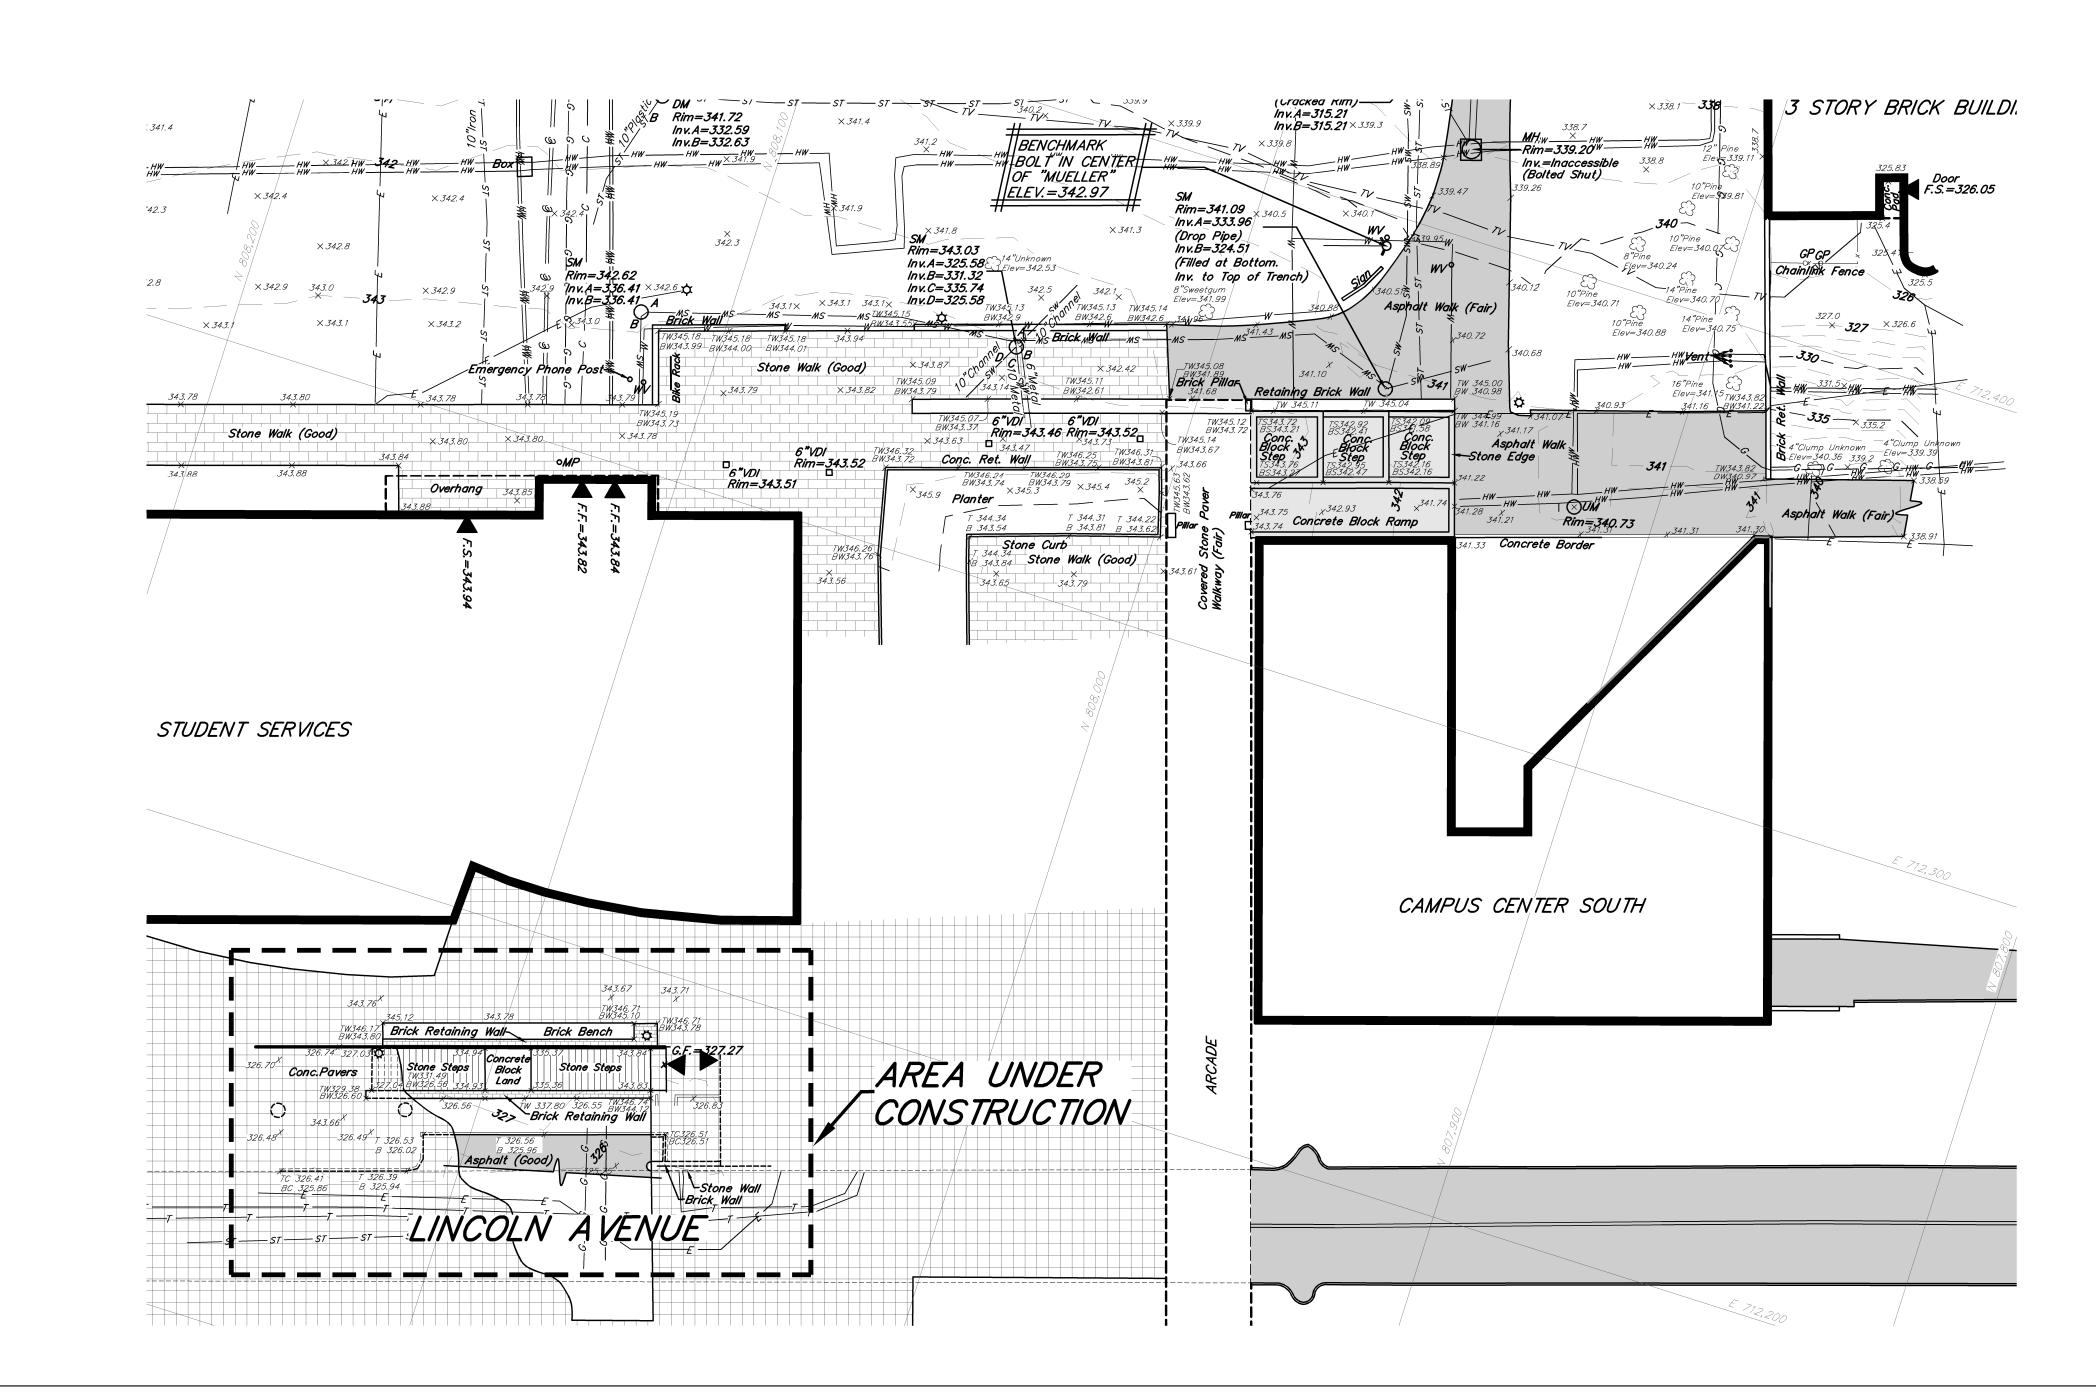

# - EXISTING AIR PLENUM TO REMAIN, SEE MEP DRAWINGS 31' - 8 1/2" FOR ADDITIONAL INFORMATION\_ REMOVE PORTION OF EXISTING AIR PLENUM WALL FOR NEW ACCESS DOOR, SEE MECHANICAL DRAWINGS FOR ADDITIONAL INFORMATION - EXISTING ACCESS PANEL TO /NO ARCHITÉCTURAL DEMOLITION/ BE REMOVED WORK IN HATCHED, SEE AD200/ FOR ADDITIONAL INOFMRATION, /-F--t---REMOVE EXISTING COMPRESSORS IN THEIR ENTIRETY, SEE MEP DEMO DRAWINGS FOR ADDITIONAL INFORMATION -REMOVE EXISTING PLATFORM -- NÓ ÁRCHÍTECTURAL DÉMOLÍTIÓN / / WORK IN HATCHED, SEE AD200 / EXISTING ELETRICAL PANELS, SEE ELECTRICAL FOR ADDITIONAL INOFMRATION, DRAWINGS FOR ADDITIONAL INFORMATION -REMOVE EXISTING CAN WASH STATION IN IT'S ENITRETY NO ARCHITECTURAL DEMOLITION WORK IN HATCHED, SEE AD200 FOR ADDITIONAL INOFMRATION, REMOVE EXISTING HANDRAIL IN THIS STAIR (BOTH SIDES)

BASEMENT - DEMO PLAN

### DEMOLITION GENERAL NOTES

1. THE G.C. IS TO FIELD VERIFY ALL DIMENSIONS USING THE CONTSTRUCTION DOCUMENTS. IF ANY DISCREPANCIES EXISTING, G.C. TO MARK UP DRAWINGS THAT REFLECT THE ACTUAL CONDITION. FORWARD THEM TO THE ARCHITECT WITHIN (3) DAYS FOR REVIEW AND CLARIFICATION AS REQUIRED.

2. THE G.C. IS TO VERIFY THE EXISTING CONDITIONS OF THE SPACING INCLUDING BUT NOT LIMITED TO SLAB CONDITION AND ANY ISSUES THAT MAY EFFECT NEW FLOOR FINISH, IF ANY ISSUES EXIST, CONTACT ARCHITECT.

3. NO DEMOLITION SHALL TAKE PLACE OUTSIDE OF THE SCOPE OF WORK WITHOUT THE APPROVAL OF THE OWNER.

4. ALL EXISTING STRUCTURE IS TO BE PROPERALY SUPPORTED DURING DEMOLITION, COORDINATE ALL WORK WITH STRUCTURAL DRAWINGS.

5. PATCH AND REPAIR EXISTING ROOF SYSTEM WHERE DEMOLITION IS TO OCCUR TO MAINTAIN WATER TIGHT. PATCH WITH NEW TO MATCH EXISTING. MAINTAIN WATER TIGHT. PATCH WITH NEW TO MATCH EXISTING. 6. GC IS TO REFER TO Q010 EQUIPMENT DEMO LAYOUT FOR ADDITIONAL DEMOLITION NOTES.
7. GC TO REFER STRUCTURAL DRAWINGS AND MEP DRAWINGS FOR ADDITIONAL DEMOLITION NOTES.

- 1 DEMOLISH PORTION OF EXISTING WALL CONSTRUCTION. 2 DEMOLISH EXISTING STOREFRONT SYSTEM. REMOVE EXISTING DOOR AND FRAME. 4 REMOVE EXISTING FLOOR FINISH AND WALL BASE. 5 REMOVE EXISTING COLUMN ENCLOSURE. 6 REMOVE EXISTING PORTION OF SLAB FLOOR, GC TO COORDINATE W/ MEP AND STRUCTURAL DRAWINGS. 7 EXISTING WINDOW TO REMAIN, PROTECT AS NEEDED DURING 8 REMOVE EXISTING MILLWORK AND ALL ASSOCIATED EQUIPMENT AND UTILITIES.
- DEMO SCHEDULE
- 9 REMOVE EXISTING COOLERS IN THEIR ENTIRETY, SEE MEP DRAWINGS FOR ADDITIONAL INFORMATION.

DESIGN 8 WILCOX STREET SIMSBURY, CONNECTICT 06070

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**Purchase College** STATE UNIVERSITY OF NEW YORK

www.purchase.edu CONSULTANT:

RENOV, AND NOILION

REVISIONS
IO. DATE DESCRIPTION

ISSUED FOR: BID


ISSUED DATE: 02.16.2018

DRAWN BY: JW CHECKED BY: CM

DRAWING NAME:

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**BASEMENT** DEMOLITION PLAN

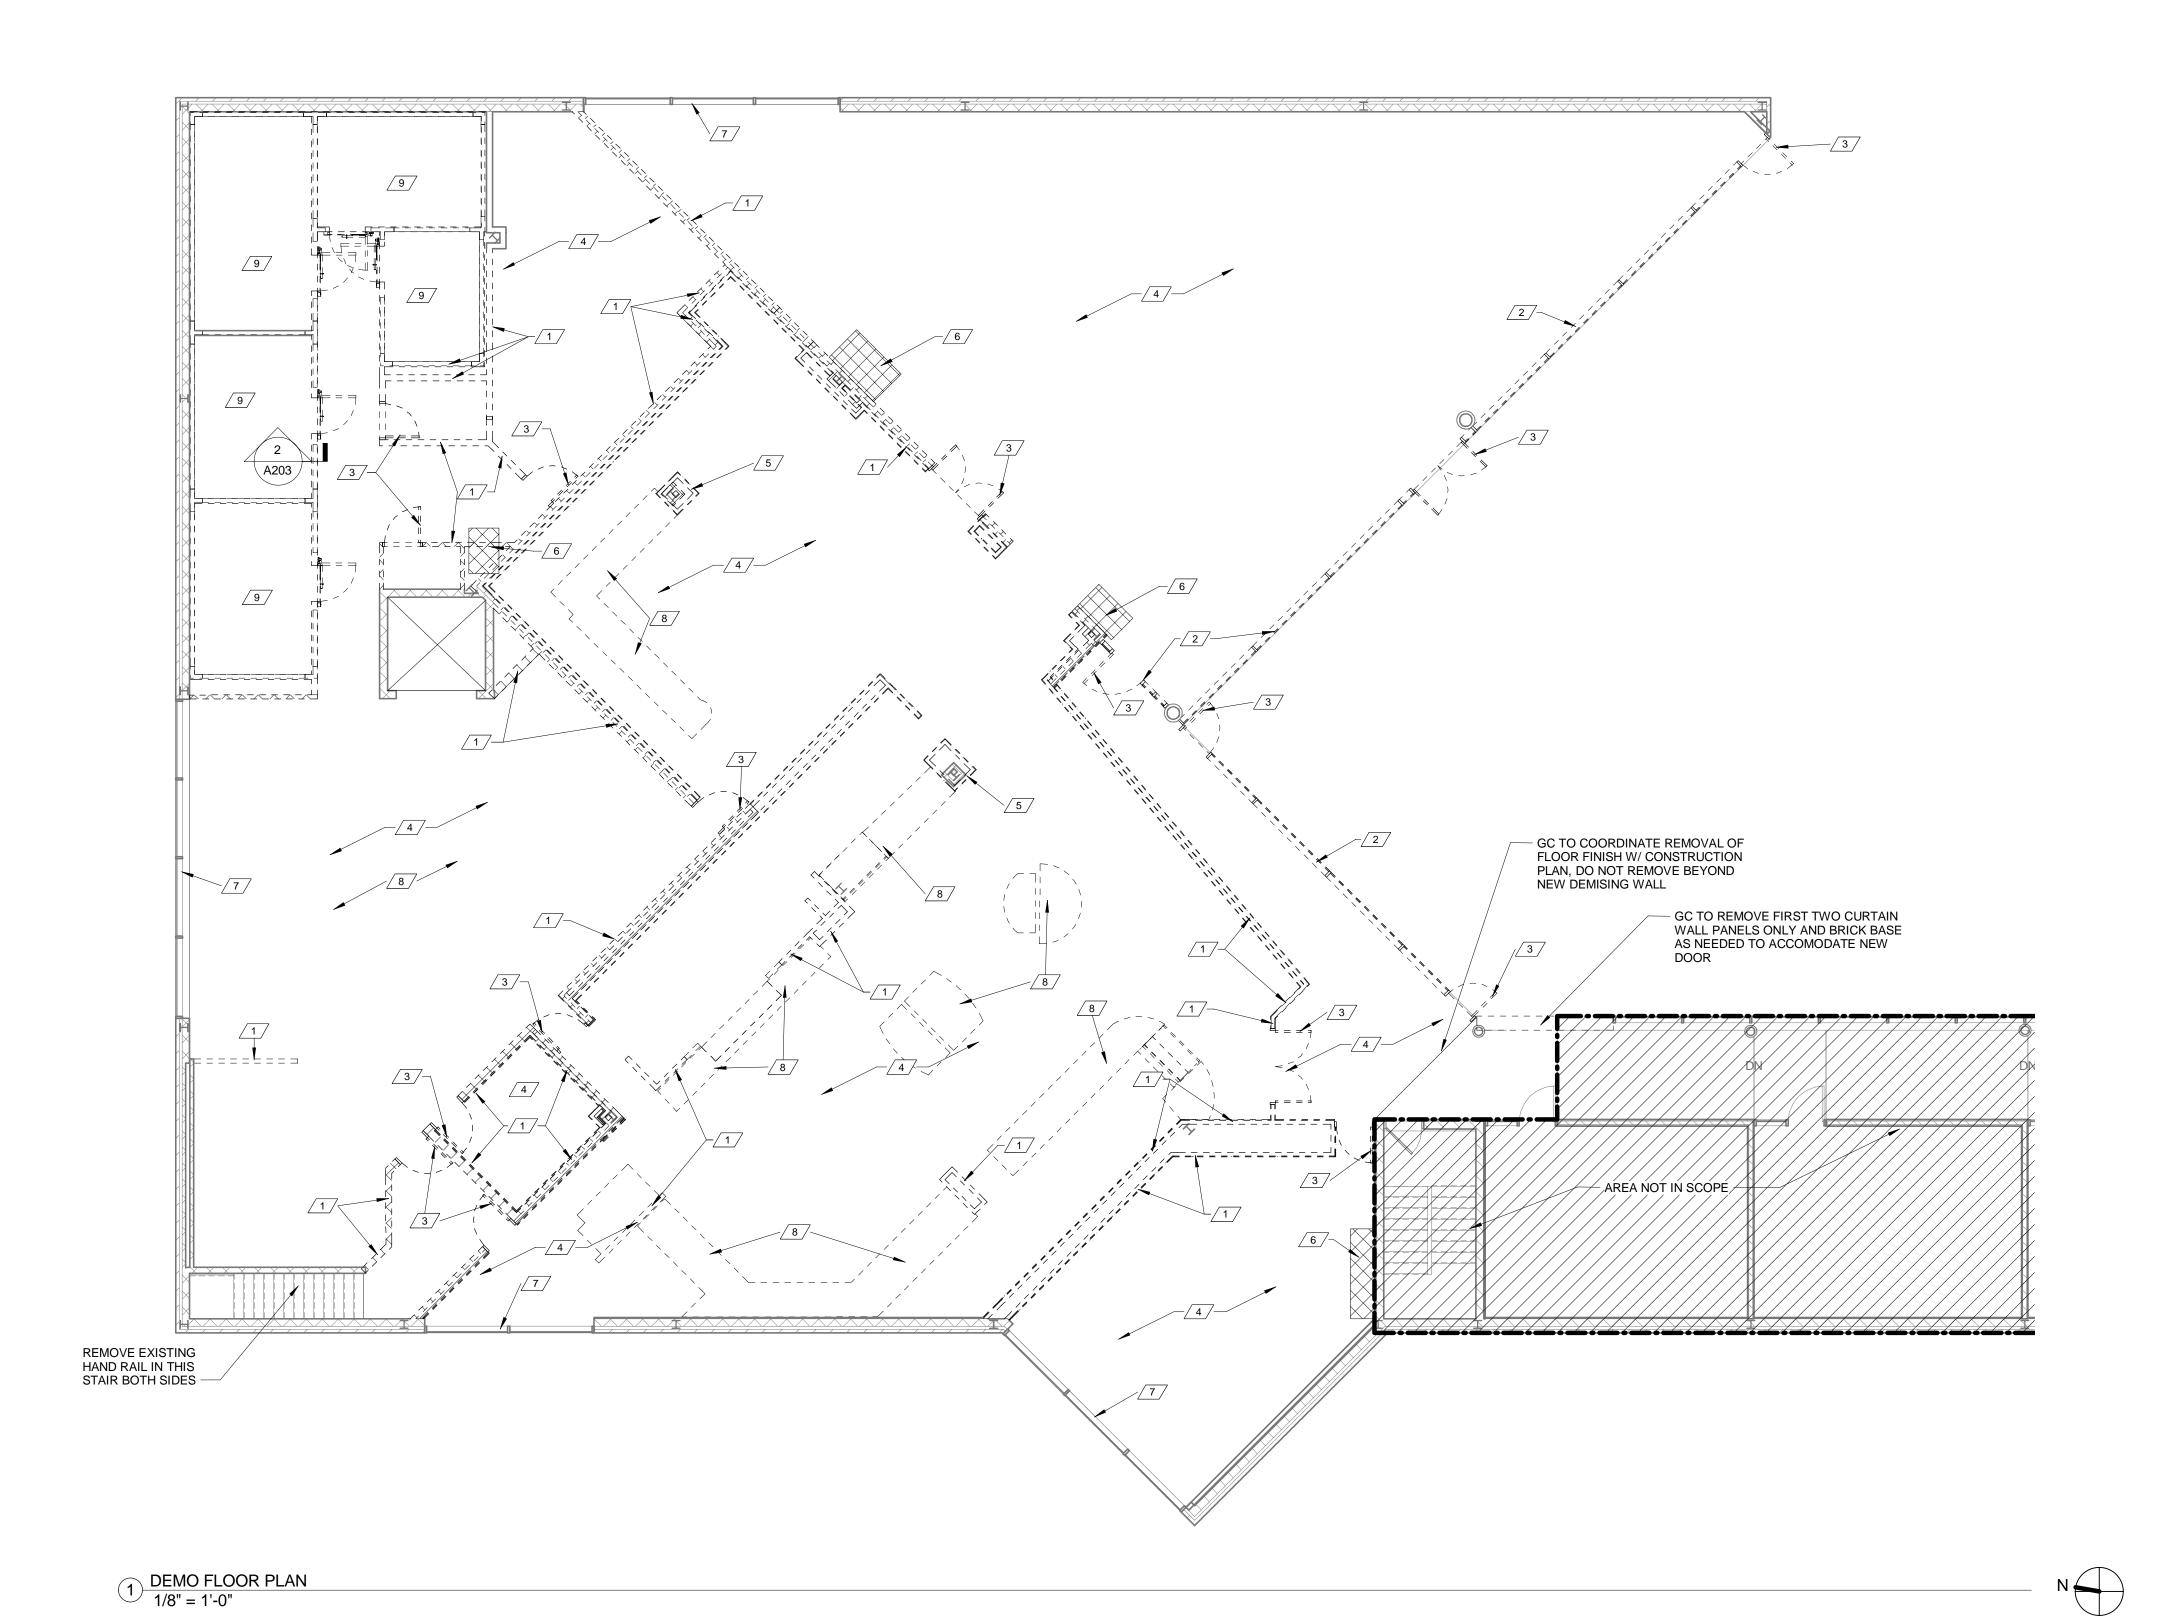

DEMOLITION GENERAL NOTES

1. THE G.C. IS TO FIELD VERIFY ALL DIMENSIONS USING THE CONTSTRUCTION DOCUMENTS. IF ANY DISCREPANCIES EXISTING, G.C. TO MARK UP DRAWINGS THAT REFLECT THE ACTUAL CONDITION. FORWARD THEM TO THE ARCHITECT WITHIN (3) DAYS FOR REVIEW AND CLARIFICATION AS REQUIRED.

2. THE G.C. IS TO VERIFY THE EXISTING CONDITIONS OF THE SPACING INCLUDING BUT NOT LIMITED TO SLAB CONDITION AND ANY ISSUES THAT MAY EFFECT NEW FLOOR FINISH, IF ANY ISSUES EXIST, CONTACT ARCHITECT.

3. NO DEMOLITION SHALL TAKE PLACE OUTSIDE OF THE SCOPE OF WORK WITHOUT THE APPROVAL OF THE OWNER.

4. ALL EXISTING STRUCTURE IS TO BE PROPERALY SUPPORTED DURING DEMOLITION, COORDINATE ALL WORK WITH STRUCTURAL DRAWINGS.

5. PATCH AND REPAIR EXISTING ROOF SYSTEM WHERE DEMOLITION IS TO OCCUR TO MAINTAIN WATER TIGHT. PATCH WITH NEW TO MATCH EXISTING.

6. GC IS TO REFER TO Q010 EQUIPMENT DEMO LAYOUT FOR ADDITIONAL DEMOLITION NOTES.

NOTES.
7. GC TO REFER STRUCTURAL DRAWINGS AND MEP DRAWINGS FOR ADDITIONAL DEMOLITION NOTES.

### **DEMO SCHEDULE**

- DEMOLISH PORTION OF EXISTING WALL CONSTRUCTION.
   DEMOLISH EXISTING STOREFRONT SYSTEM.
- REMOVE EXISTING DOOR AND FRAME.
- 4 REMOVE EXISTING FLOOR FINISH AND WALL BASE.
  5 REMOVE EXISTING COLUMN ENCLOSURE.
  6 REMOVE EXISTING PORTION OF SLAB FLOOR, GC TO COORDINATE W/ MEP AND STRUCTURAL DRAWINGS.
- 7 EXISTING WINDOW TO REMAIN, PROTECT AS NEEDED DURING DEMOLITION.
- 8 REMOVE EXISTING MILLWORK AND ALL ASSOCIATED EQUIPMEN AND UTILITIES.
- 9 REMOVE EXISTING COOLERS IN THEIR ENTIRETY, SEE MEP DRAWINGS FOR ADDITIONAL INFORMATION.

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ISSUED FOR: BID

ISSUED DATE: 02.16.2018

DRAWN BY: JW CHECKED BY: CM

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FIRST FLOOR DEMOLITION PLAN

DEMO CEILING

REMOVE EXISTING GYPSUM CEILING/SOFFIT IN IT'S ENTIRETY.
REMOVE EXISTING ACT TILE CEILING IN IT'S ENTIRETY.


REMOVE EXISTING SPLINE CEILING IN IT'S ENTIRETY.

GC IS TO REMOVE PORTION OF EXISTING TILE CEILING.

REMOVE ALL EXISTING LIGHT FIXTURES IN THIS AREA UNLESS OTHERWISE NOTED.

DEMOLITION GENERAL NOTES

1. GC IS TO REFER TO EQUIPMENT DRAWINGS FOR ADDITIONAL DEMOLITION NOTES. 2. REFER TO MEP AND STRUCTURAL DRAWINGS FOR ADDITIONAL DEMOLITION NOTES.

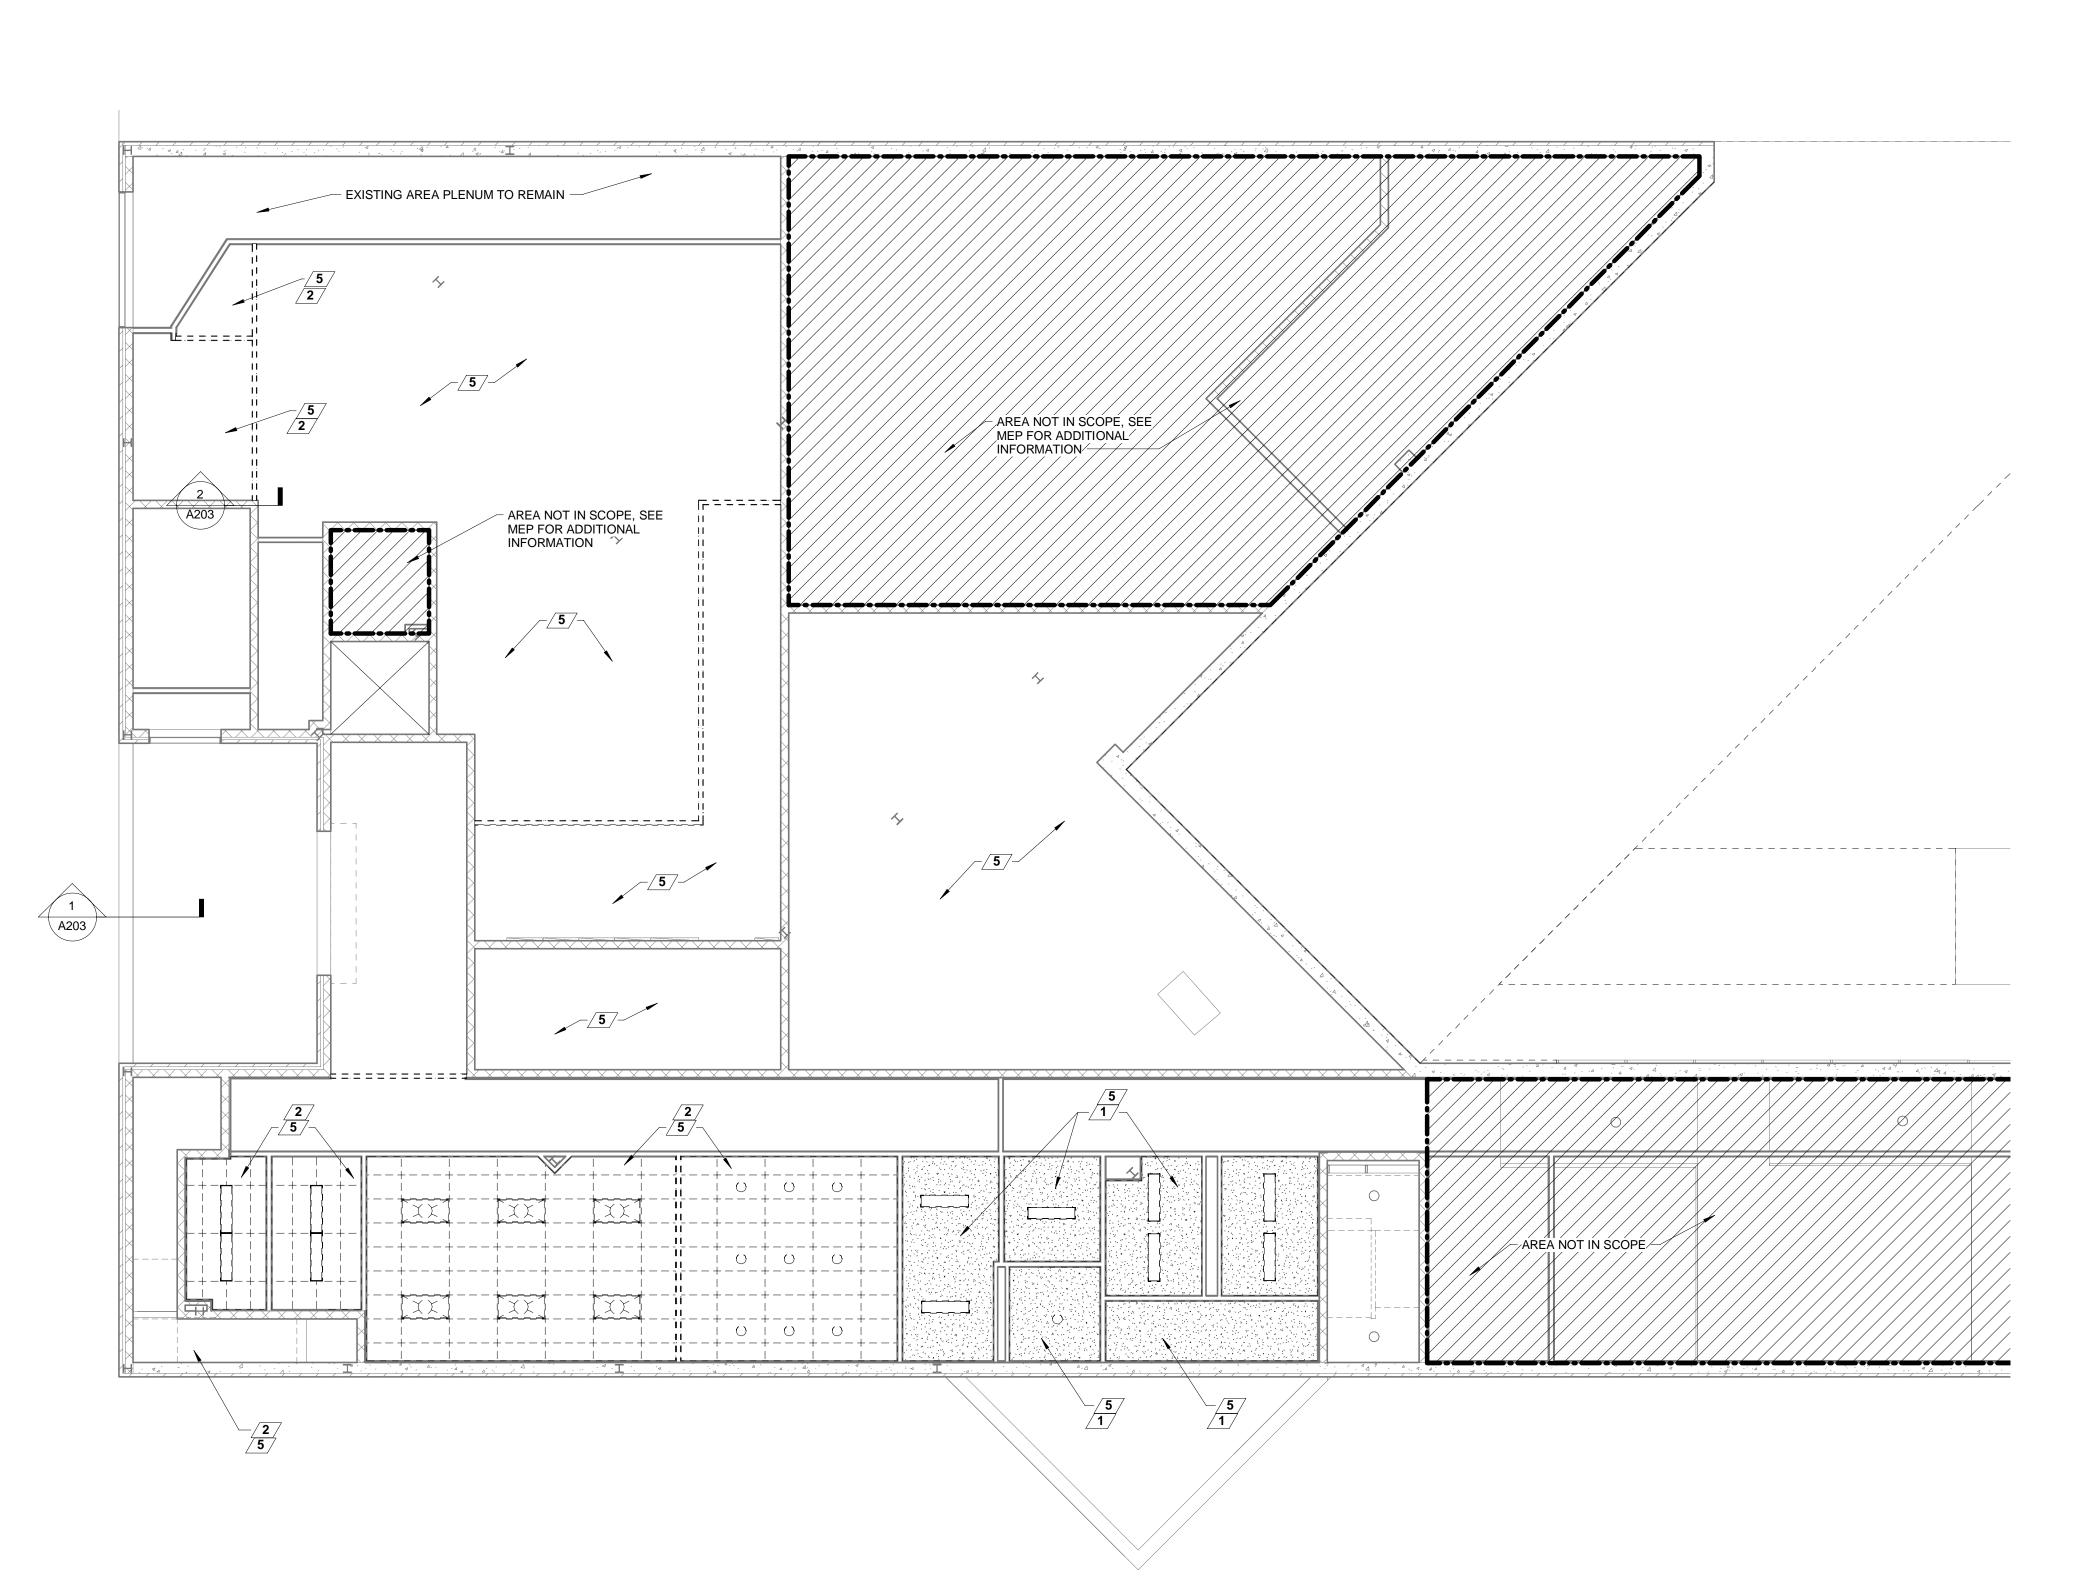

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RENOVATION

**ADDITION** 

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DRAWN BY: JW CHECKED BY: CM

PROJECT NUMBER: 1517347

BASEMENT CELING DEMOLITION PLAN

· - + - + - |+ | - + - + - + - + <u>.</u> < GC IS TO SALAVGE EXISTING CEILING TILE CEILING TO ALLOW FOR NEW CONSTRUCTION ∠AREA NOT IN SCOPE **2 / 5 / -**

1 DINING LEVEL - DEMO CEILING PLAN 1/8" = 1'-0"

**DEMO CEILING** 

REMOVE EXISTING GYPSUM CEILING/SOFFIT IN IT'S ENTIRETY. REMOVE EXISTING ACT TILE CEILING IN IT'S ENTIRETY.

REMOVE EXISTING SPLINE CEILING IN IT'S ENTIRETY.

GC IS TO REMOVE PORTION OF EXISTING TILE CEILING.
REMOVE ALL EXISTING LIGHT FIXTURES IN THIS AREA UNLESS OTHERWISE NOTED.

**DEMOLITION GENERAL NOTES** 

1. GC IS TO REFER TO EQUIPMENT DRAWINGS FOR ADDITIONAL DEMOLITION NOTES. 2. REFER TO MEP AND STRUCTURAL DRAWINGS FOR ADDITIONAL DEMOLITION NOTES.

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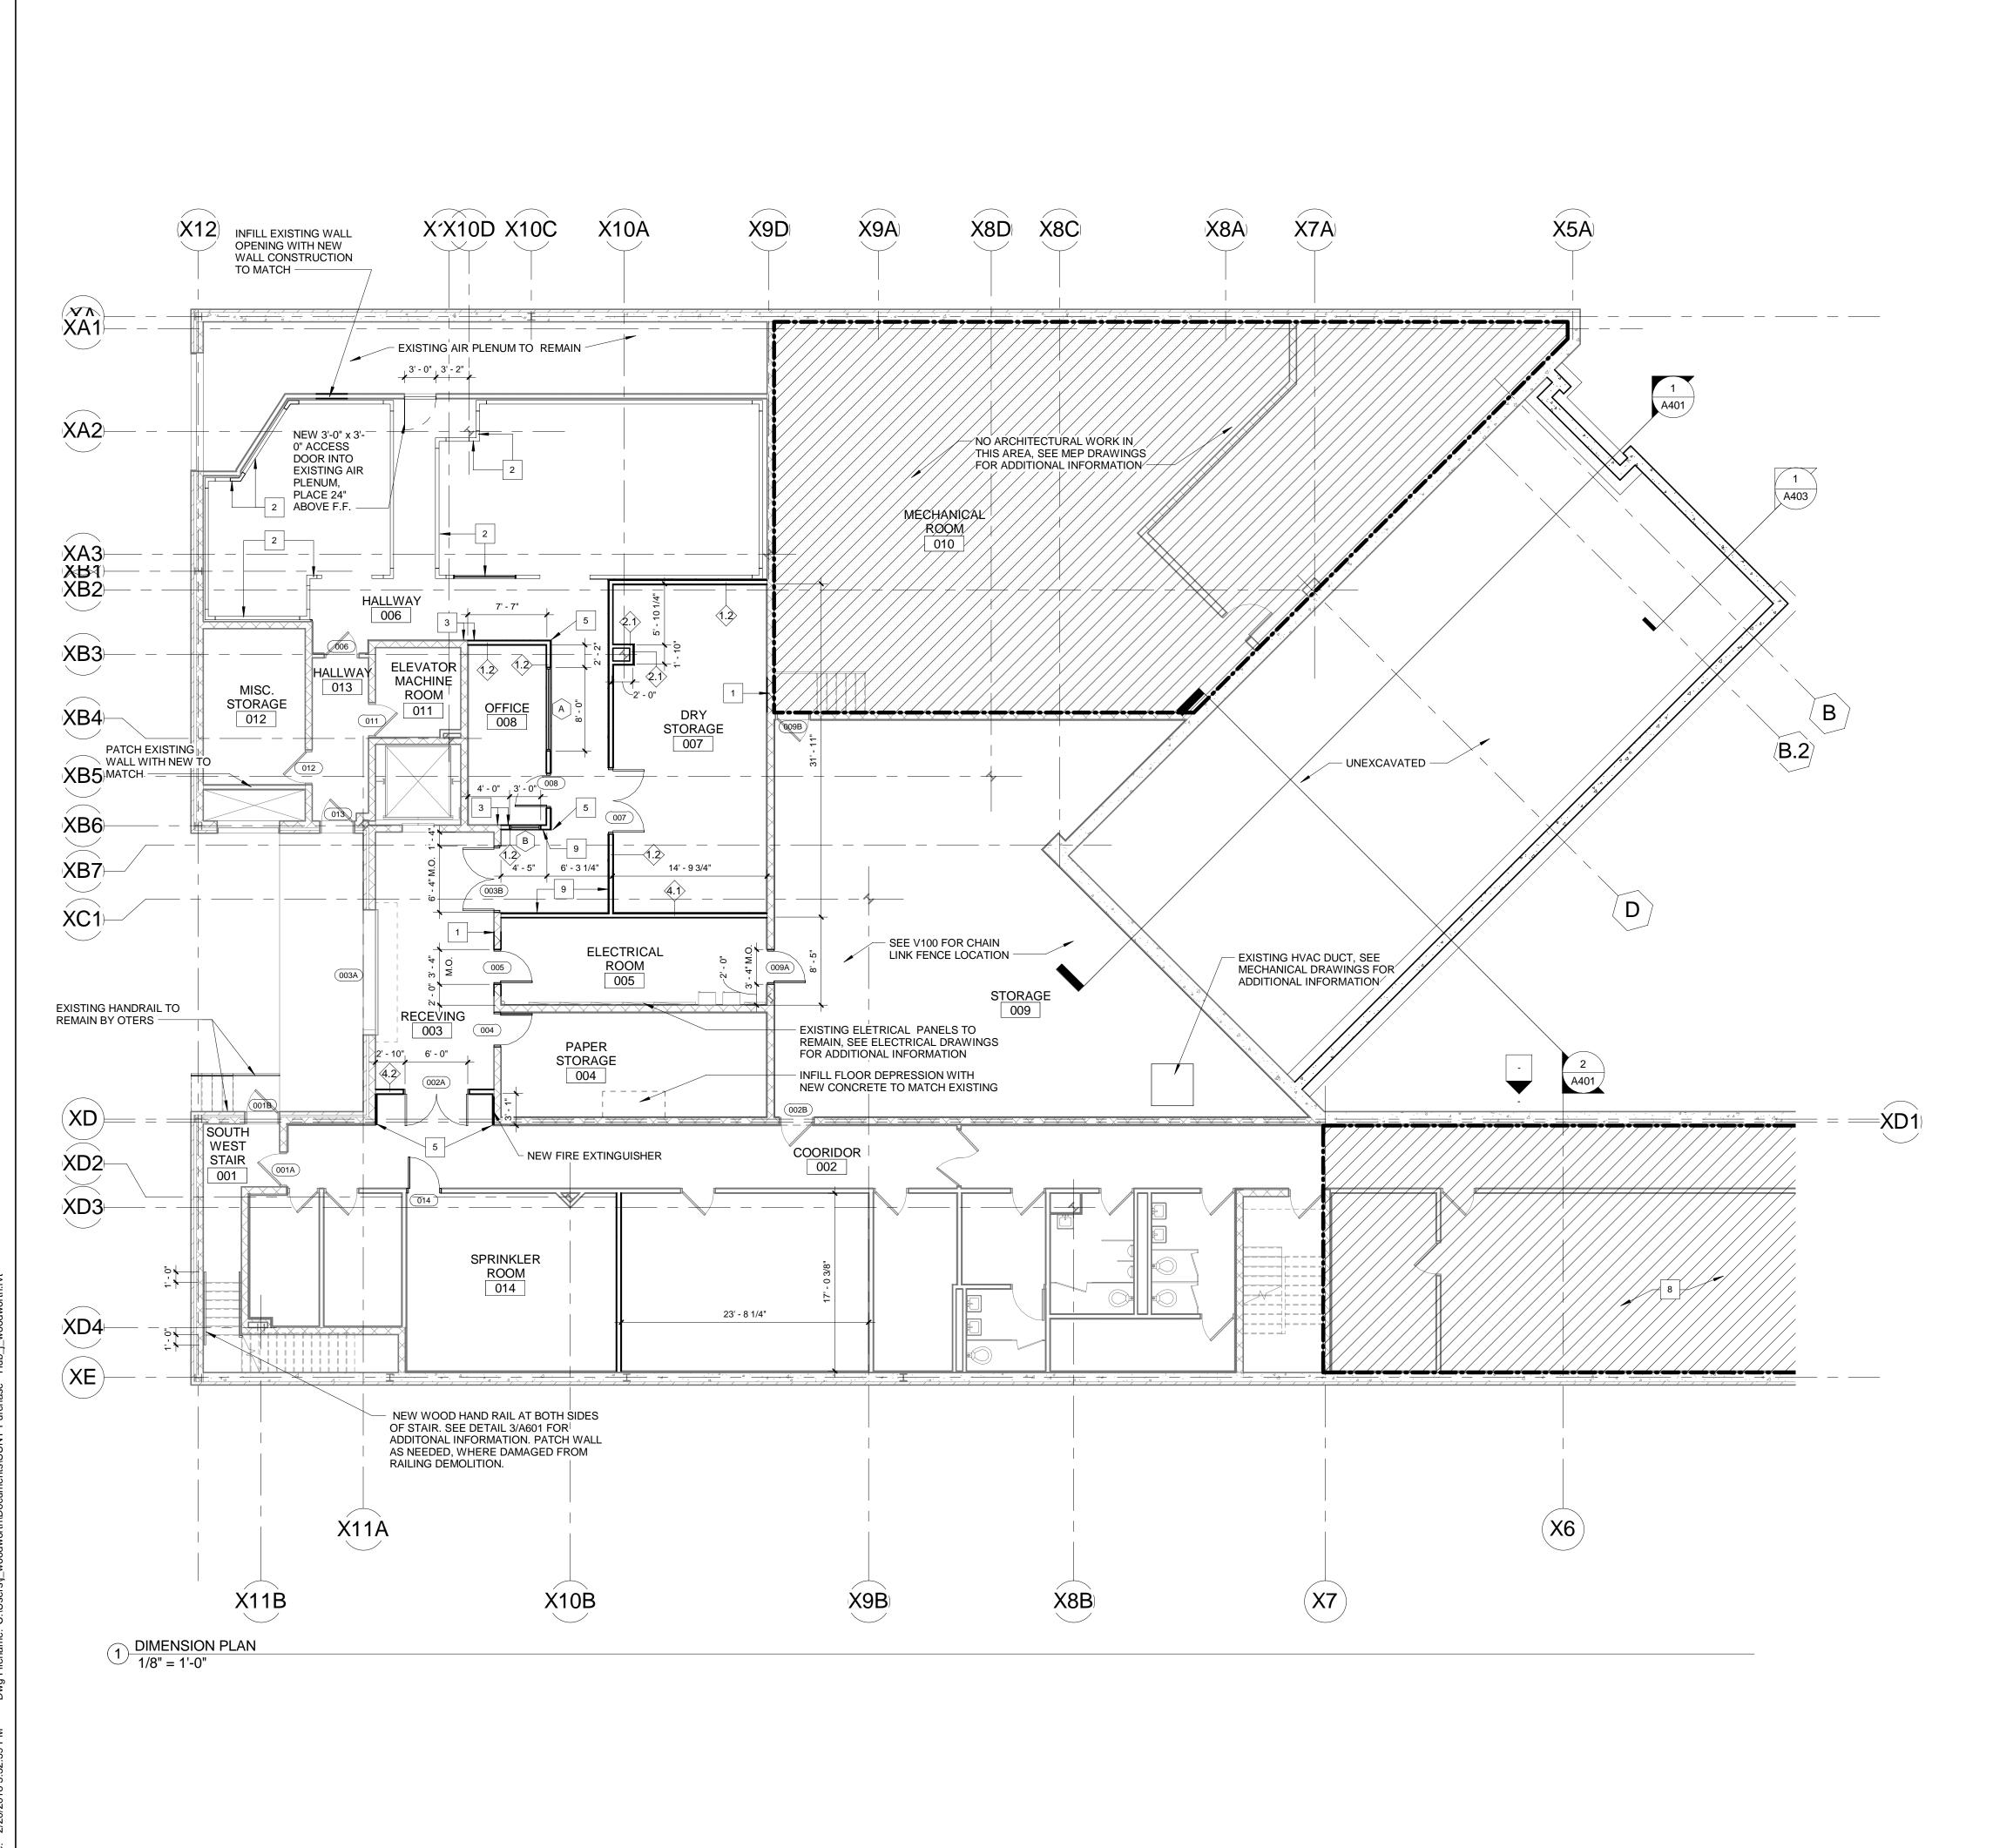
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CHECKED BY: CM PROJECT NUMBER: 1517347

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FIRST FLOOR CEILING DEMOLITION PLAN



FLOOR PLAN GENERAL NOTES:

1. PROVIDE MOISETURE RESISTANT GYPSUM BOARD AT ALL NEW WET WALLS LOCATIONS, UNLESS OTHERWISE NOTED. 2. ALL NEW WALLS THAT ARE TO RECIEVE FRP OR CERAMIC TILE SHALL HAVE CEMENT BACKER BOARD IN LIEU OF GYPSUM BOARD. SEE FINISH DRRAWINGS FOR LOCATIONS. SEE FINISH LEGEND & INTERIOR ELEVATIONS FOR WALL FINISHES.

3. REFERENCE CEILING PLAN, INTERIOR ELEVATIONS AND EQUIPMENT DRAWINGS FOR ADDITIONAL INFORMATION.
4. GC TO PATCH AND REPAIR MASNORY WALLS AS NEEDED WHERE DEMOLITION

HAS OCCURED. 5. SEE V100 AND V110 FOR INTERIOR GENERAL ARRANGEMENT PLANS.
6. SEE EQUIPMENT DRAWING FOR ADDITIONAL COOLER OR KITCHEN EQUIPMENT

### PLAN NOTES - FLOOR PLAN

IN FILL EXISTING MASONRY WALL WITH NEW MASONRY WALL CONSTRUCTION TO MATCH EXISTING

NEW COOLER/ FREEZER, SEE EQUIPMENT DRAWINGS FOR ADDITIONAL INFORMATION.

NEW WALL CONSTRCUTION IS TO ALIGN WITH EXISTING. NEW MILLWORK BY OTHERS.

7. SEE V100 AND V110 FOR INTERIOR FINISH TAGS.

CORNER GUARDS, SEE FINISH SCHEDULE FOR ADDITIONAL INFORMATION.

NEW STRUCTURAL COLUMN, SEE STRUCTURAL DRAWINGS FOR ADDITIONAL INFORMATION.

DASHED LINE REPRESENTS SOFFIT ABOVE, SEE A201 FOR ADDITIONAL INFORMATION. AREA NOT IN SCOPE.

INFILL FLOOR OPENING WITH NEW CONSTRUCTION TO MATCH EXISTING, SEE STRUCTURAL DRAWINGS FOR ADDITIONAL INFORMATION.

EXISTING COLUMN TO REMAIN. GC TO SAW CUT FLOOR AS NEEDED TO ALLOW FOR NEW DUCT WORK, SEE MEP AND STRUCTURAL DRAWINGS FOR ADDITIONAL INFORMATION.

PROVIDE 1/2" FIRE RETARDENT PLYWOOD SHEATHING, 4'-0" AF.F. SCREW TO FINISH FACE OF WALL

NEW ROOF DRAIN, SEE ROOF PLAN AND MEP DRAWINGS FOR ADDITIONAL INFORMATION.

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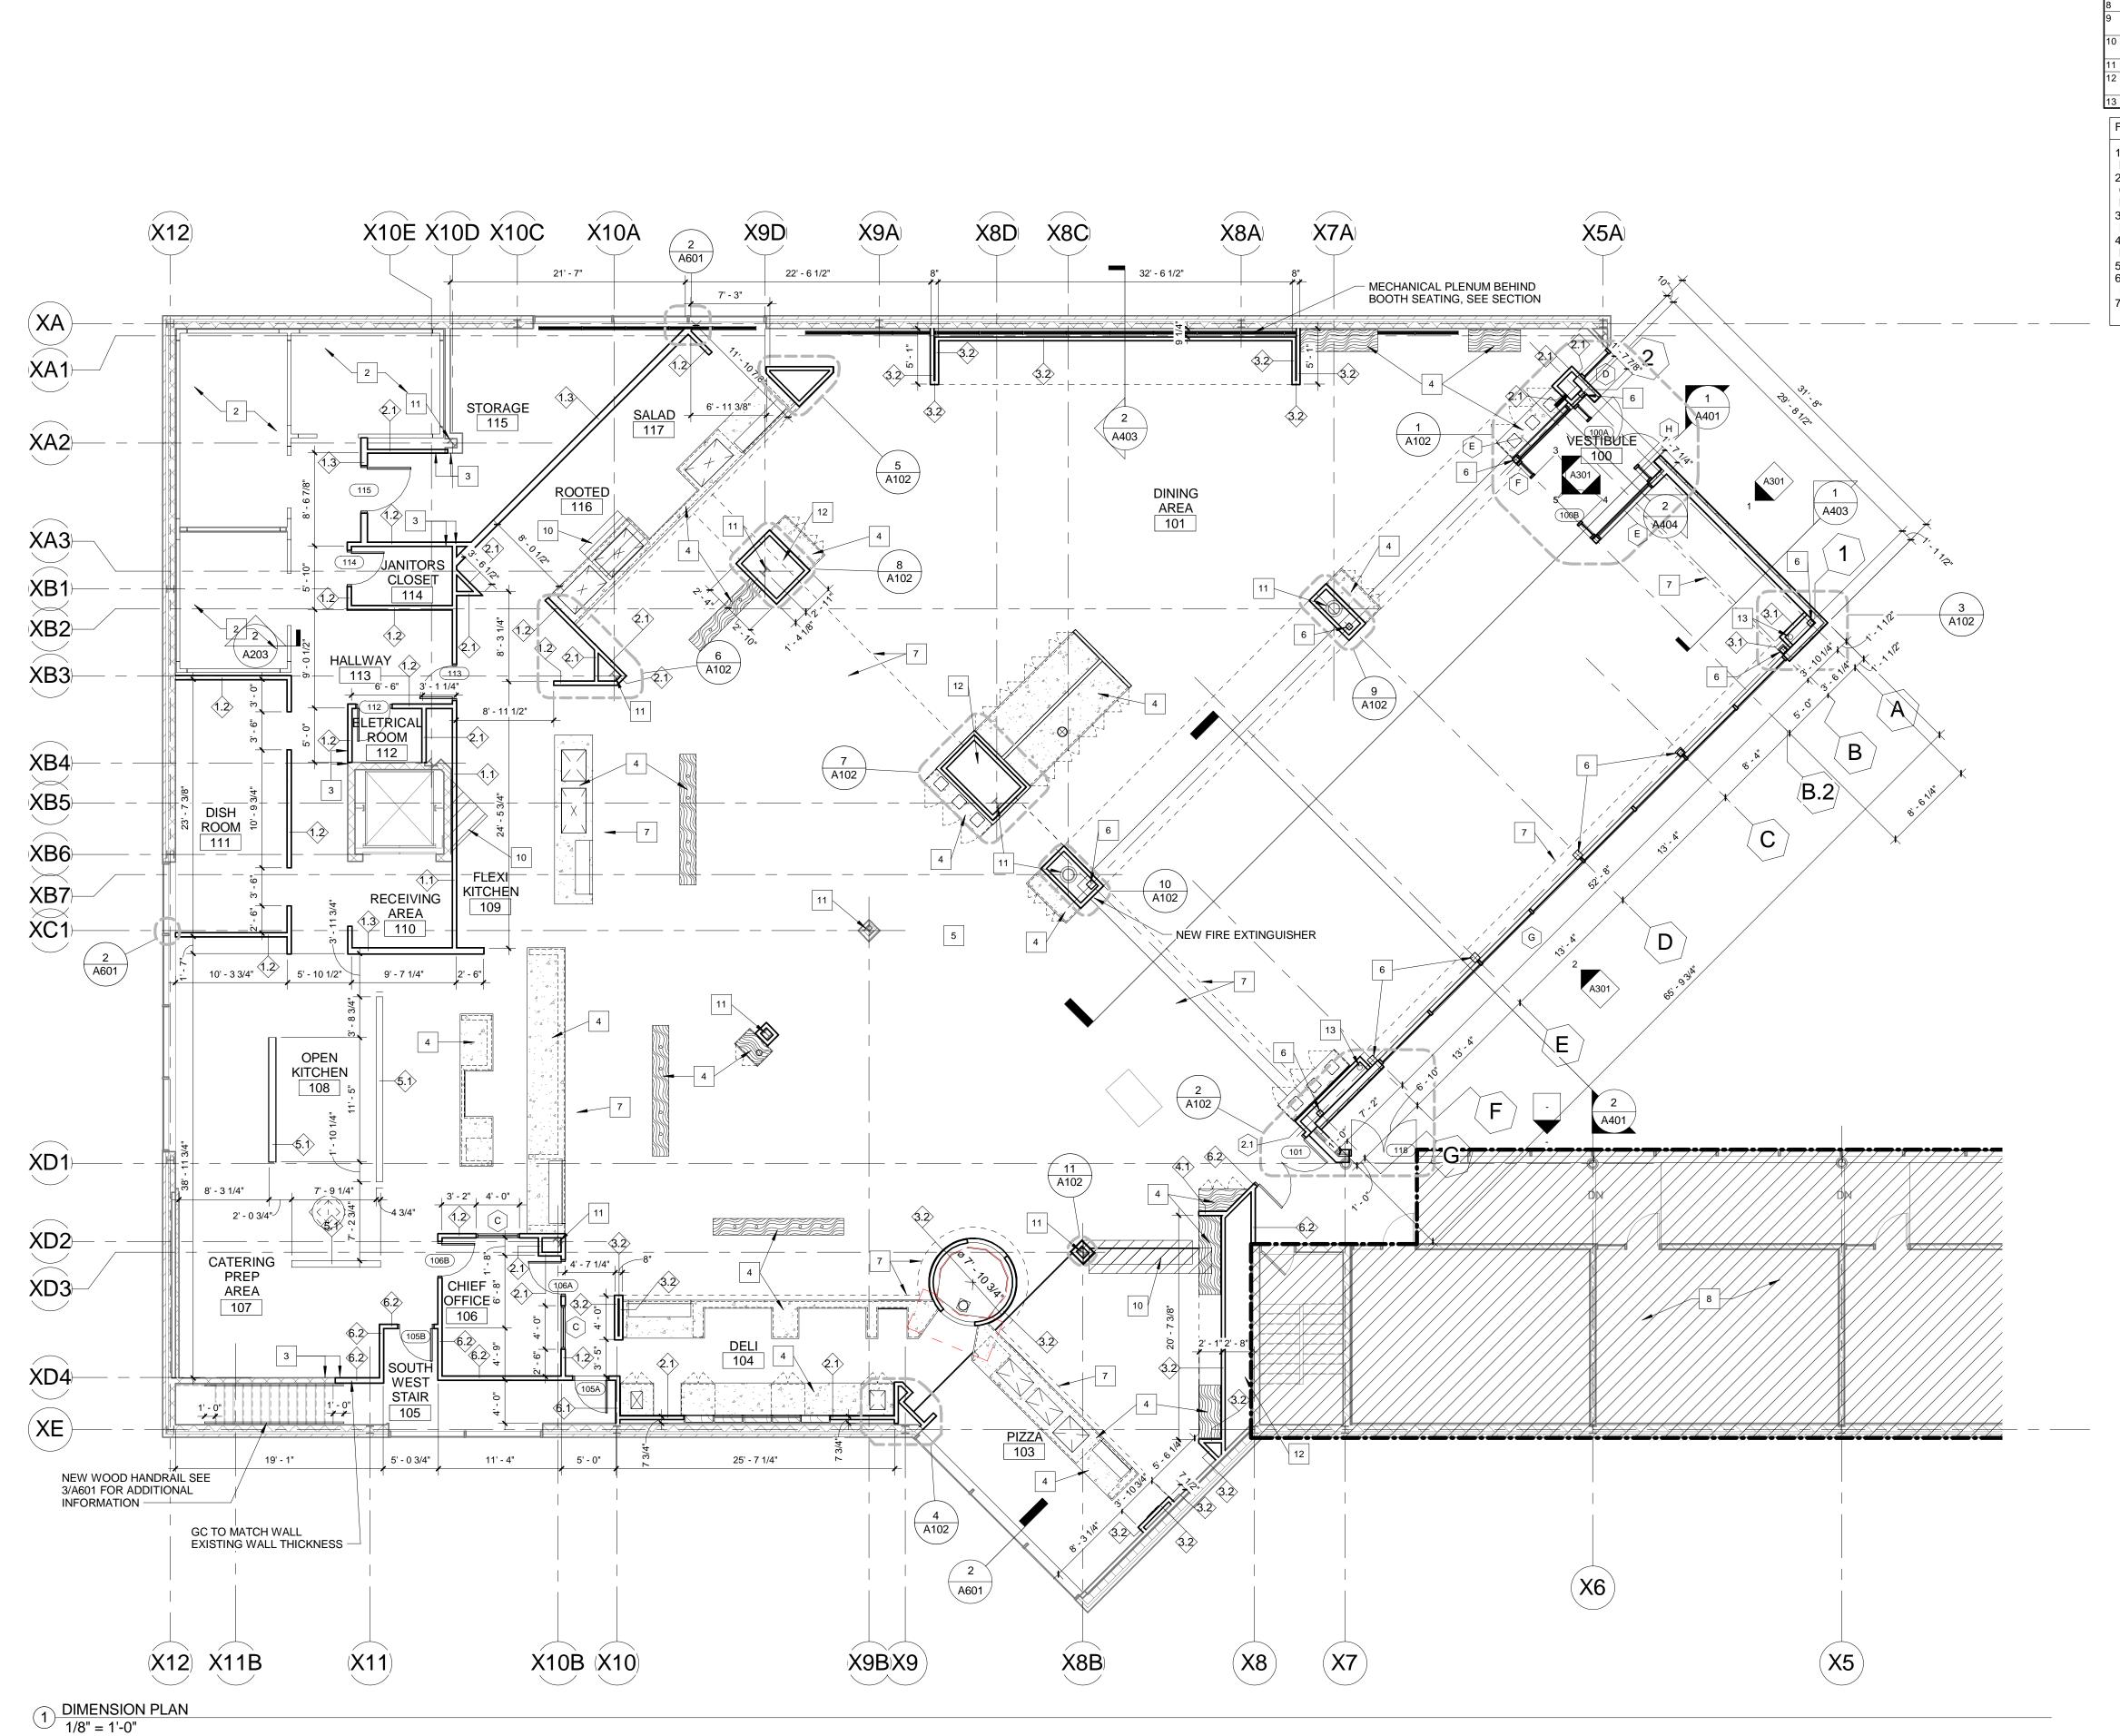
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**BASEMENT** CONSTRUCTION FLOOR PLAN



### PLAN NOTES - FLOOR PLAN

IN FILL EXISTING MASONRY WALL WITH NEW MASONRY WALL CONSTRUCTION TO MATCH EXISTING

NEW COOLER/ FREEZER, SEE EQUIPMENT DRAWINGS FOR ADDITIONAL INFORMATION.

NEW WALL CONSTRCUTION IS TO ALIGN WITH EXISTING. NEW MILLWORK BY OTHERS.

CORNER GUARDS, SEE FINISH SCHEDULE FOR ADDITIONAL INFORMATION. NEW STRUCTURAL COLUMN, SEE STRUCTURAL DRAWINGS FOR ADDITIONAL INFORMATION. DASHED LINE REPRESENTS SOFFIT ABOVE, SEE A201 FOR ADDITIONAL INFORMATION. AREA NOT IN SCOPE.

INFILL FLOOR OPENING WITH NEW CONSTRUCTION TO MATCH EXISTING, SEE STRUCTURAL DRAWINGS FOR ADDITIONAL INFORMATION.

PROVIDE 1/2" FIRE RETARDENT PLYWOOD SHEATHING, 4'-0" AF.F. SCREW TO FINISH FACE OF WALL

EXISTING COLUMN TO REMAIN.

GC TO SAW CUT FLOOR AS NEEDED TO ALLOW FOR NEW DUCT WORK, SEE MEP AND STRUCTURAL DRAWINGS FOR ADDITIONAL INFORMATION.

NEW ROOF DRAIN, SEE ROOF PLAN AND MEP DRAWINGS FOR ADDITIONAL INFORMATION.

FLOOR PLAN GENERAL NOTES:

1. PROVIDE MOISETURE RESISTANT GYPSUM BOARD AT ALL NEW WET WALLS LOCATIONS, UNLESS OTHERWISE NOTED.

2. ALL NEW WALLS THAT ARE TO RECIEVE FRP OR CERAMIC TILE SHALL HAVE CEMENT BACKER BOARD IN LIEU OF GYPSUM BOARD. SEE FINISH DRRAWINGS FOR LOCATIONS. SEE FINISH LEGEND & INTERIOR ELEVATIONS FOR WALL FINISHES. 3. REFERENCE CEILING PLAN, INTERIOR ELEVATIONS AND EQUIPMENT DRAWINGS FOR ADDITIONAL INFORMATION.

4. GC TO PATCH AND REPAIR MASNORY WALLS AS NEEDED WHERE DEMOLITION

HAS OCCURED.

5. SEE V100 AND V110 FOR INTERIOR GENERAL ARRANGEMENT PLANS.
6. SEE EQUIPMENT DRAWING FOR ADDITIONAL COOLER OR KITCHEN EQUIPMENT INFORMATION

7. SEE V100 AND V110 FOR INTERIOR FINISH TAGS.

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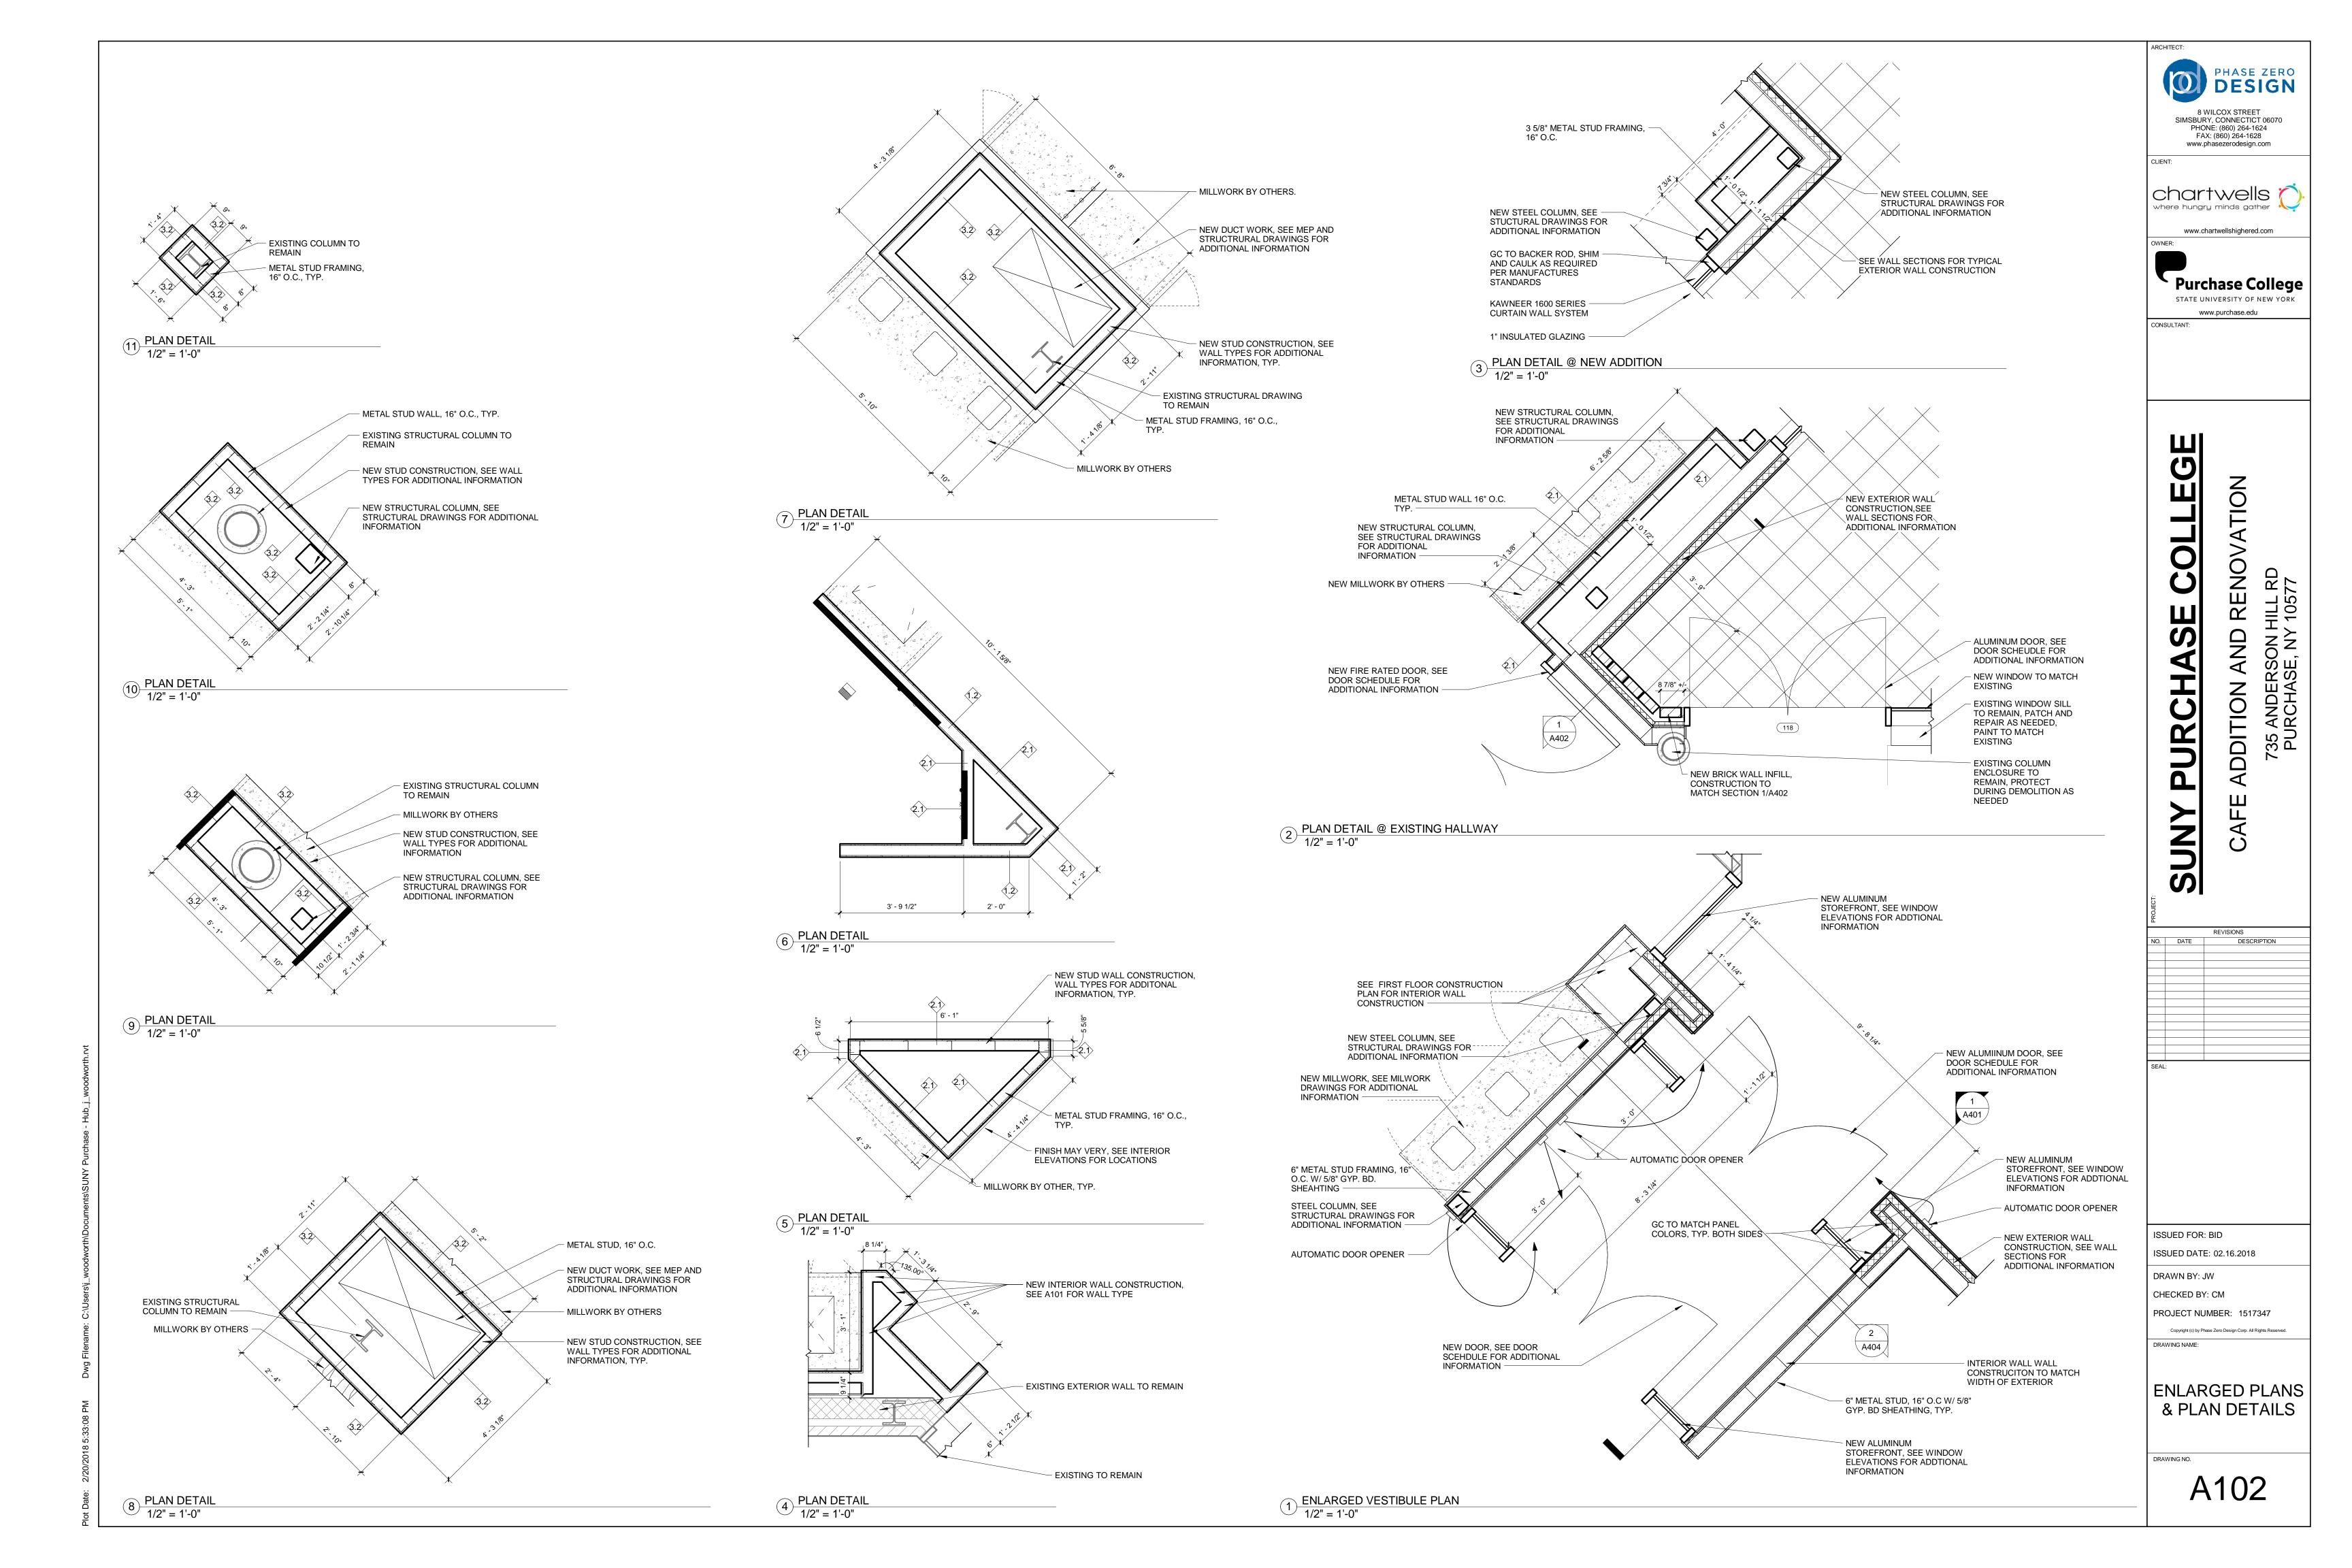
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FIRST FLOOR CONSTRUCTION PLAN



PLAN NOTES - ROOF PLAN NEW STORM DRAIN, GC TO COORDINATE WITH ROOFING CONTRACTOR. SEE DETAIL 6/A601 FOR ADDITIONAL INFORMATION. NEW THRU WALL ROOF SCUPPER, ALIGN BOTTOM OF SCUPPER W/ TOP OF ROOF MEMBRANE AT EACH LOCATION TO BE INSTALLED. SCUPPER PER ROOF FASCIA MANUFACTURER. NEW MEMBRANE ROOF BY OTHERS. SELECT ROOF EQUIPMENT DEMOLTION, SEE MECHANICAL DRAWINGS FOR ADDITIONAL NEW ROOF EQUIPMENT, SEE MECHANICAL DRAWINGS FOR ADDITIONAL INFORMATION

**GENERAL NOTES:** 

1. ALL ROOF CRICKETS SHALL BE CONSTRUCTED WITH 1/2" TAPERED INSULATION.
2. PROVIDE TAPERED INSULATION CRICKETS AT UPSLOPE SIDE OF ALL ROOF CURBS PER ROOFING MFG'S RECOMMENDATIONS.
3. FLASH ALL ROOF CURBS, PENETRATIONS, ETC. PER ROOFING MANUFACTURER RECOMMENDATIONS - REFER TO/COORDINATE WITH MECHANICAL AND PLUMBING PLANS AND FLASH ALL PENETRATIONS AS REQUIRED.
4. SEE MECHANICAL DRAWINGS AND EQUIPMENT DRAWINGS FOR ADDITIONAL INFORMATION.
5. GC TO COORDINATE NEW ROOF PENETRATIONS, EQUIPMENT, ETC., WITH COLLEGE. EXISTING ROOF TO BE REPLACED DURING CONSTRUCTION BY SEPERATE CONTRATOR.

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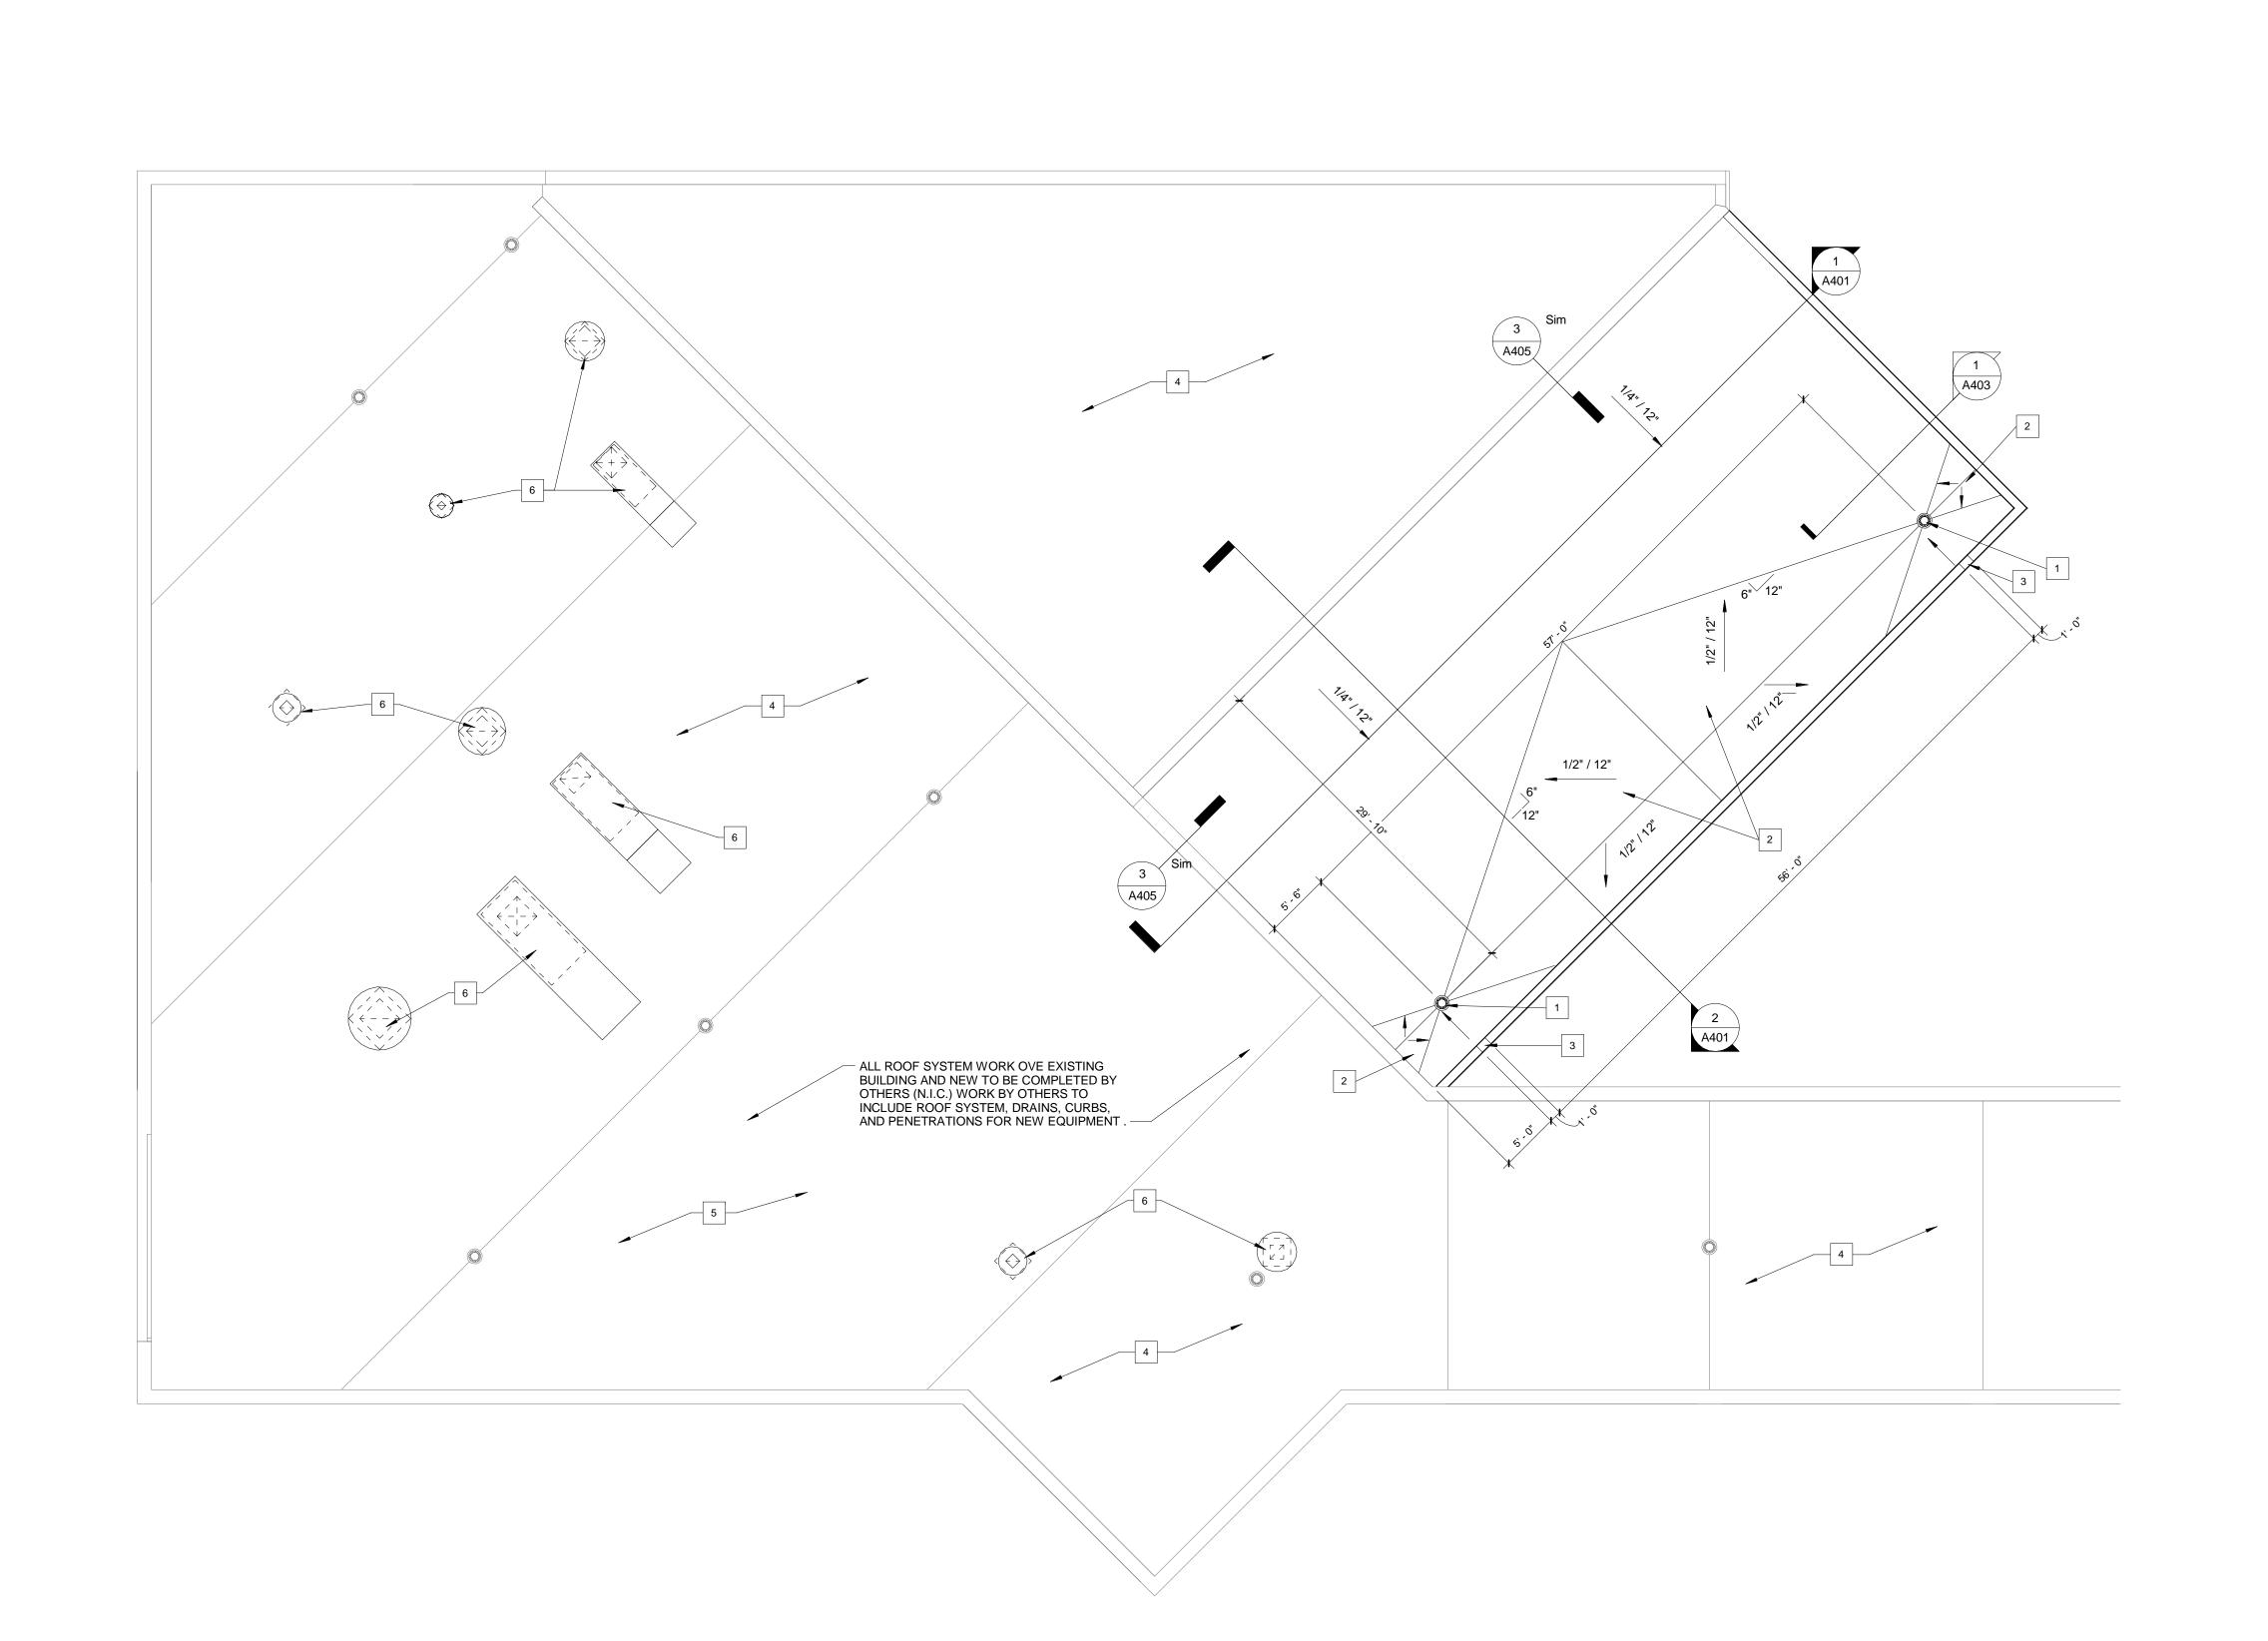
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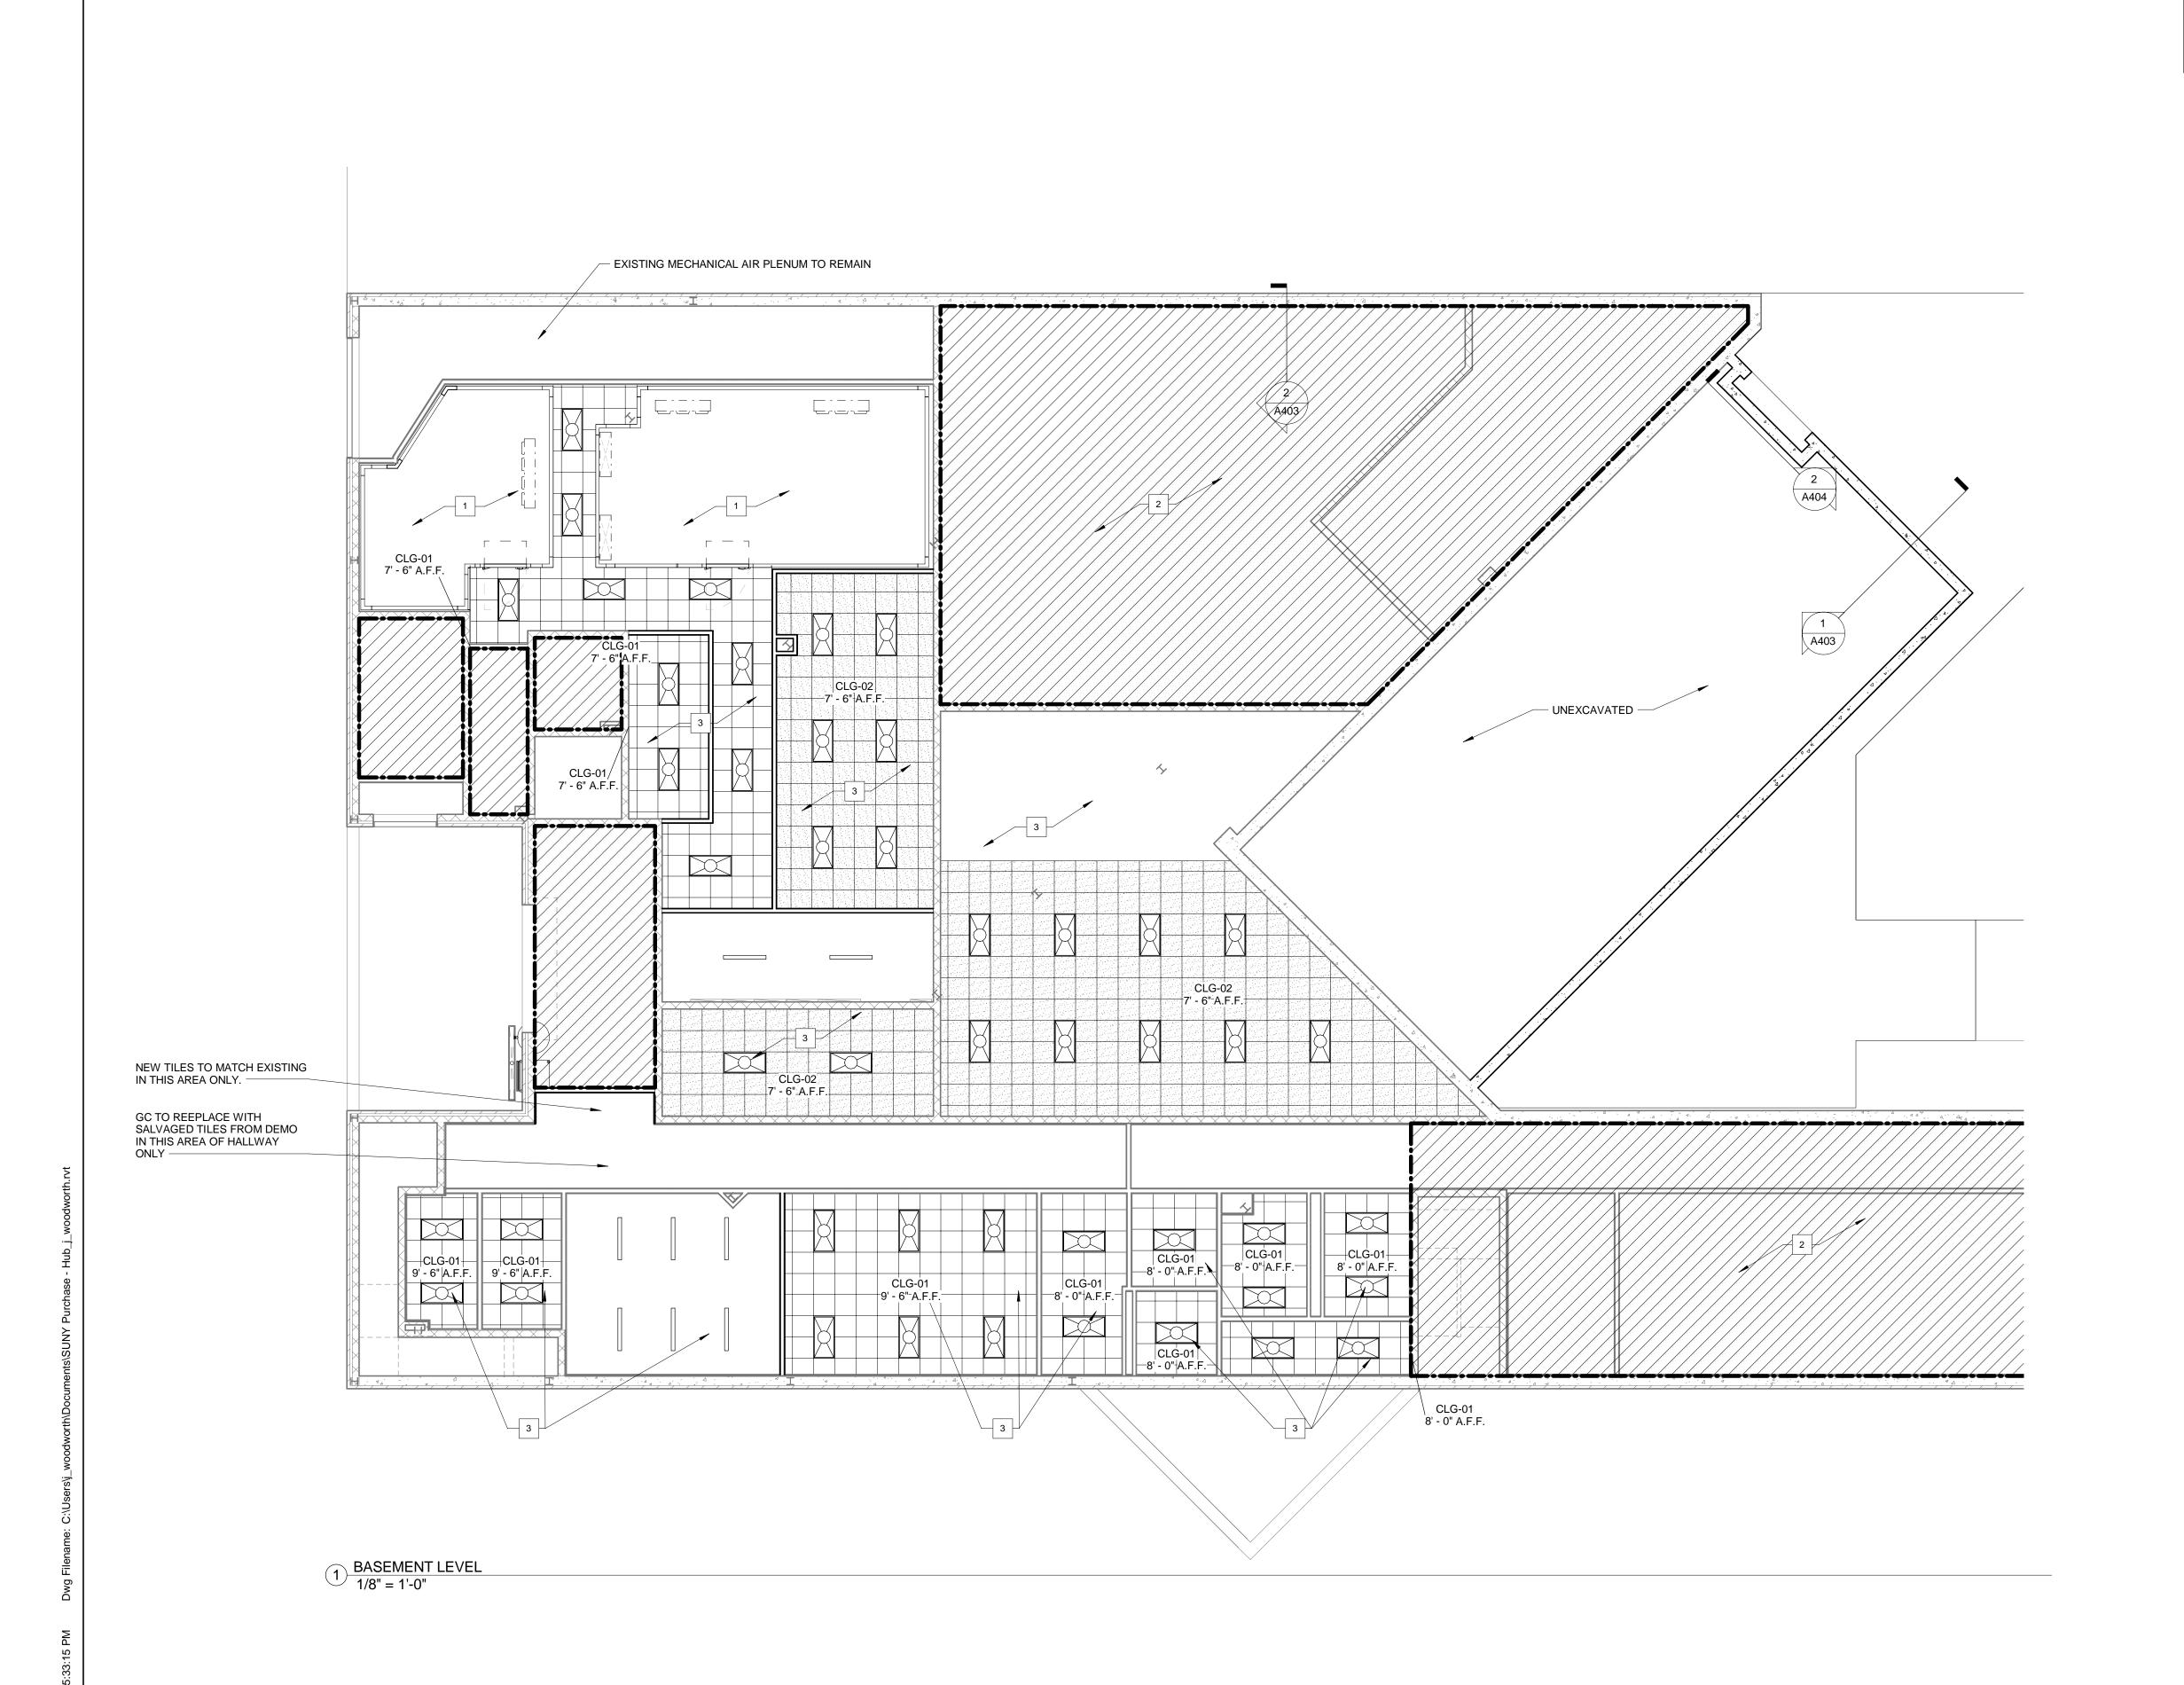
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**ROOF PLAN** 





CEILING PLAN GENERAL NOTES

1. ALL CEILING MOUNTED WIRING WITHIN THE EXPOSED CEILING AREAS OF THE HUB SHALL BE RUN WITHIN A RACEWAY, AND THE RACEWAY AND ALL ASSOCIATED ATTACHEMENTS, ETC. WILL BE PAINTED BLACK TO MATCH THE CEILING FINISHES.

2. ALL CEILING GRIDS TO BE CENTERED IN ROOM, UNLESS NOTED OTHERWISE. 3. SEE EQUIPMENT DRAWINGS AND ELECTRICAL DRAWINGS FOR ADDITIONAL LIGHTING INFORMATION.

4. SEE ELECTRICAL DRAWINGS FOR ADDITIONAL SYMBOLS.
5. REFER TO V102 AND V112 FOR ALL CEILING HEIGHTS, FINISHES AND LIGHTING LOCATIONS. 6. GC IS TO V.I.F. THE HEIGHTS OF DUCTS IN BASEMENT PRIOR TO CEILING INSTALLTION.
ANY CONFLICTS, CONTACT ARCHITECT.
7. SEE MEP DRAWINGS FOR SUPPLY AND RETURN GRILL LOCATIONS

### PLAN NOTES - RCP

SEE EQUIPMENT DRAWINGS FOR LIGHT INFORMATION IN COOLERS AREA NOT IN SCOPE.

NEW ACT TILE CEILING, SEE V102 AND V112 FOR ADDITIONAL INFORMATION NEW GYP. BD. SOFFIT CEILING, SEE V102 AND V112FOR ADDITIONAL INFORMATION DECORATIVE CEILING TRELLIS, SEE 4/A203 FOR ADDITIONAL INFORMATION. SEE V112 FOR FINISH INFORMATION.

TVS TO BE PROVIDED BY OTHERS.

DECORATIVE TRELLIS, SEE V112 FOR ADDITIONAL INFORMATION.

DECORATIVE PENDANT LIGHT

HIGH BAY LIGHT FIXTURE

DECORATIVELINEAR LIGHT FIXTURE

INDUSTRIAL STRIPE LIGHTING

MONITOR

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SYMBOL LEGEND

2X4 LED FIXTURE 2X2 LED FIXTURE

RECESSED CAN FIXTURE

LAMINATE CEILING

RENOV, NOILION

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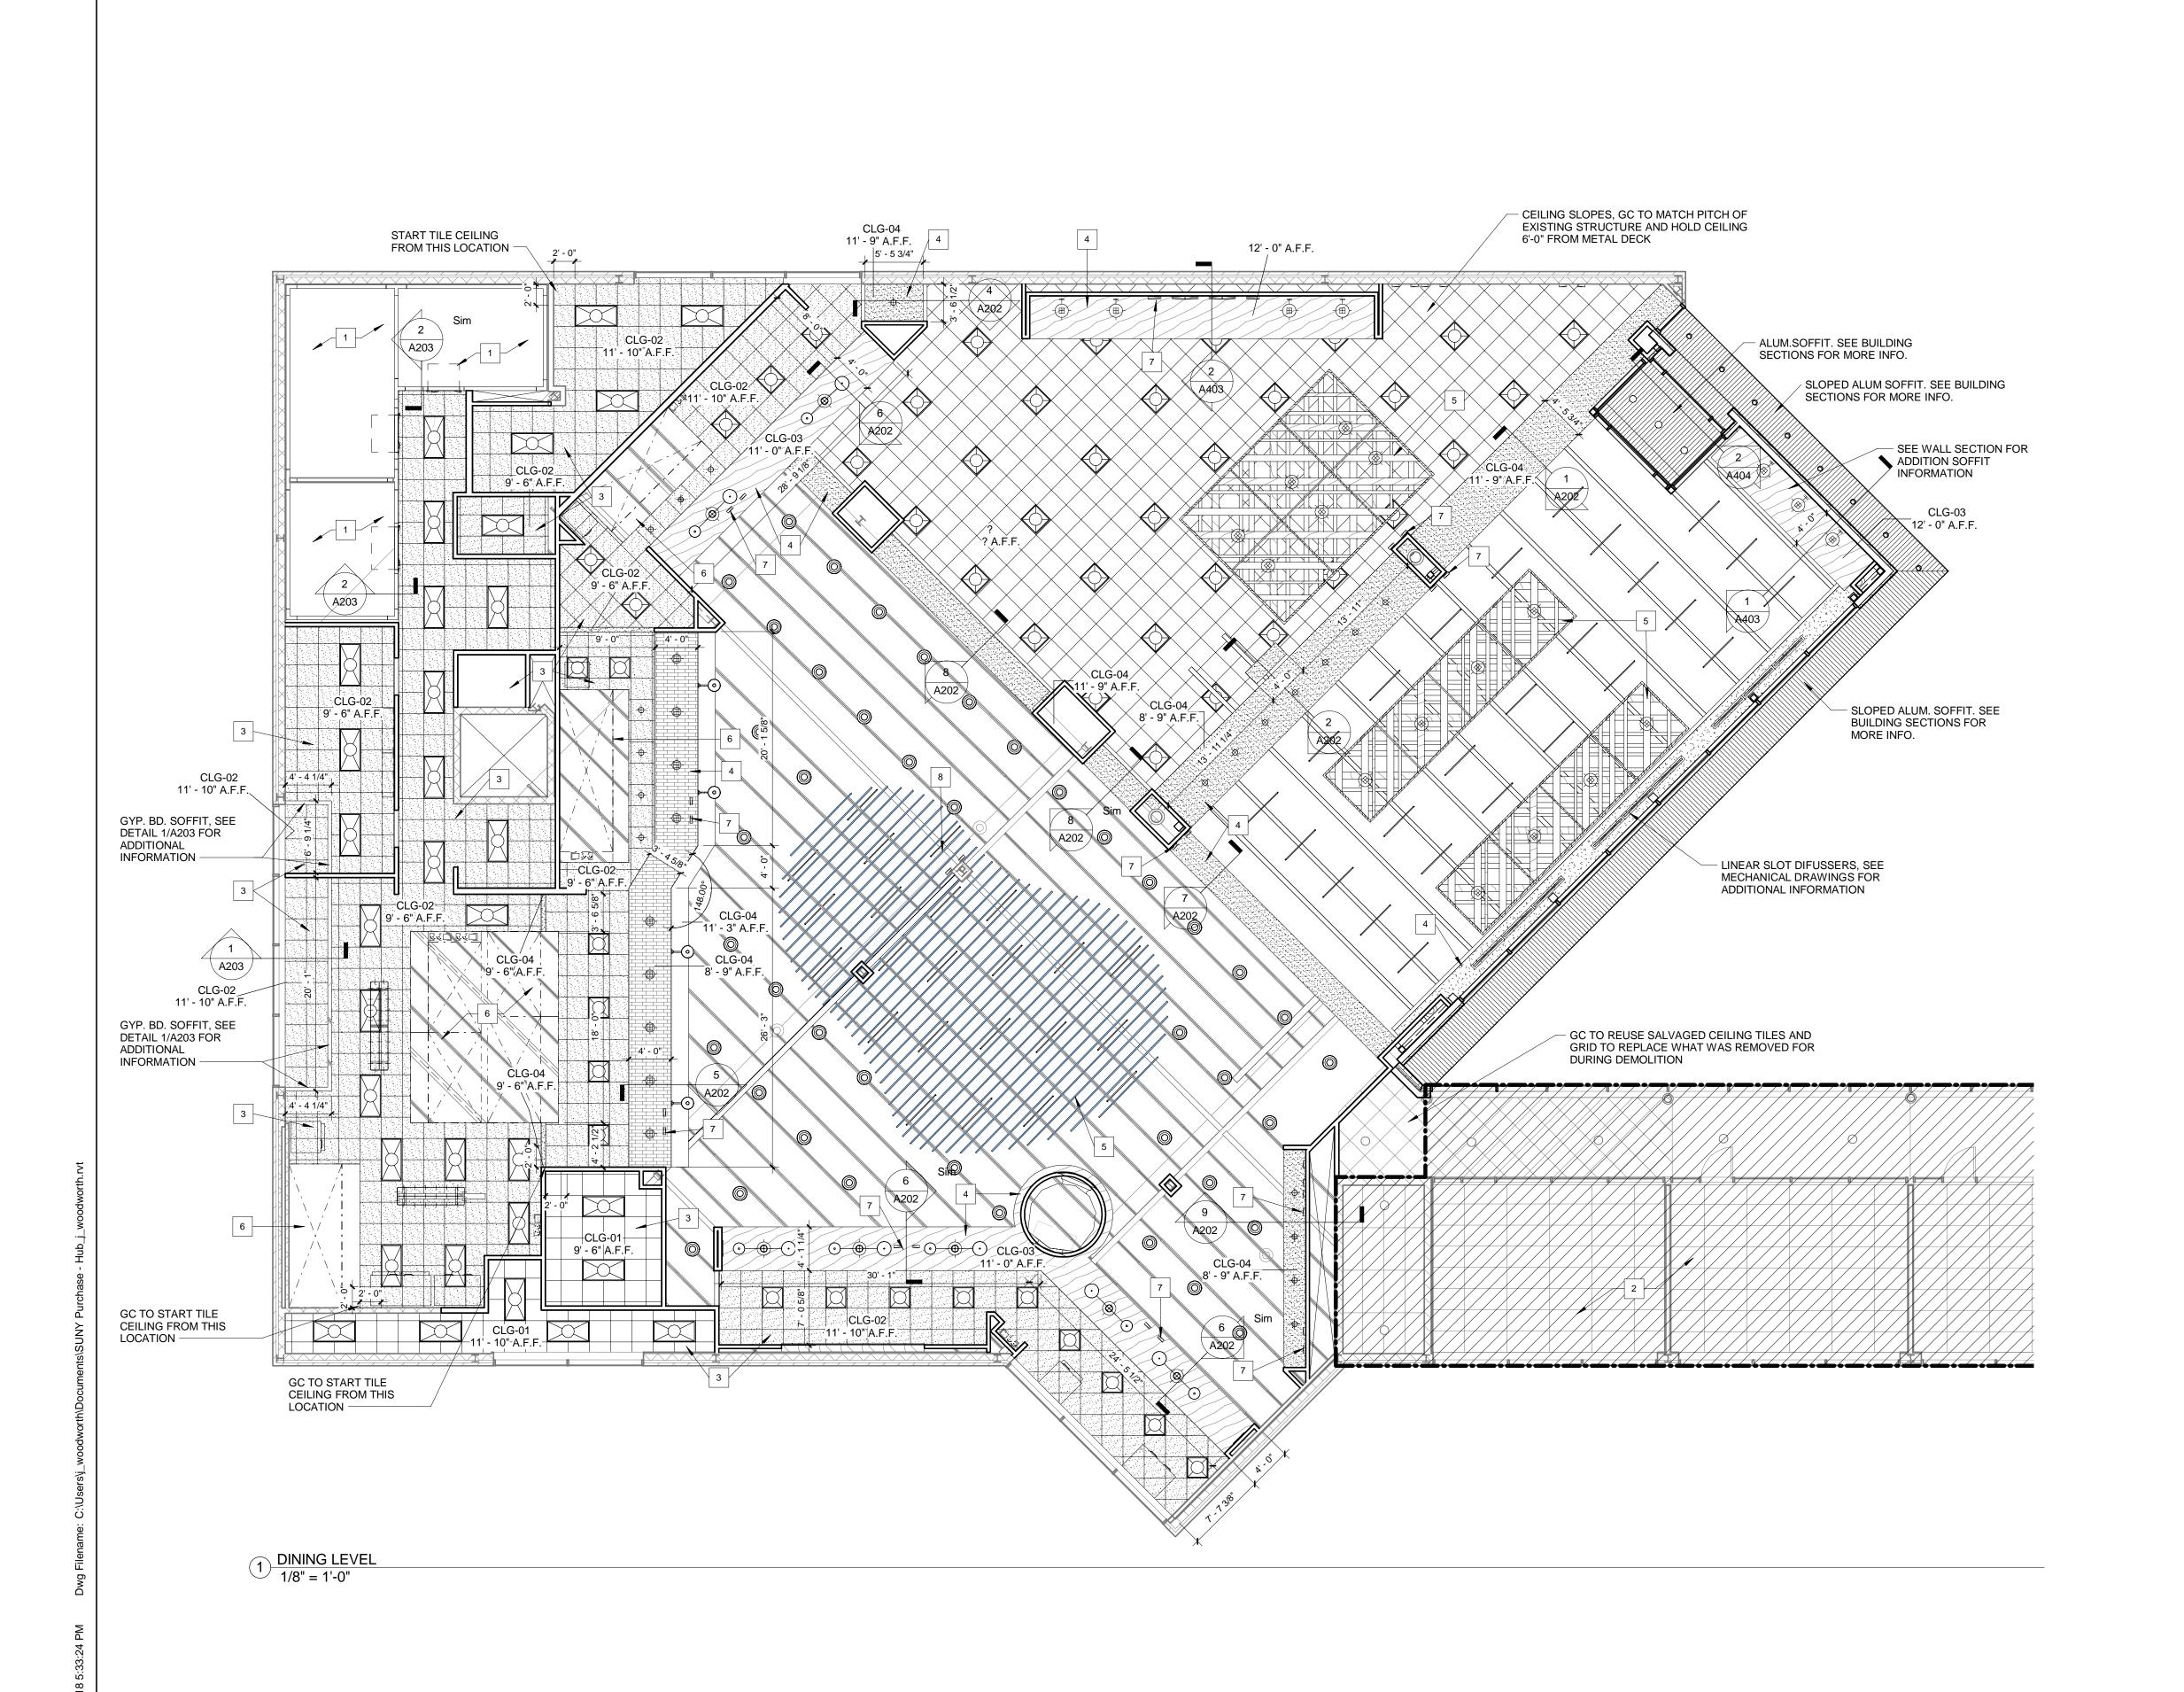
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**BASEMENT** REFLECTED

**CEILING PLAN** 



**CEILING PLAN GENERAL NOTES** 

1. ALL CEILING MOUNTED WIRING WITHIN THE EXPOSED CEILING AREAS OF THE HUB SHALL BE RUN WITHIN A RACEWAY, AND THE RACEWAY AND ALL ASSOCIATED ATTACHEMENTS, ETC. WILL BE PAINTED BLACK TO MATCH THE CEILING FINISHES. 2. ALL CEILING GRIDS TO BE CENTERED IN ROOM, UNLESS NOTED OTHERWISE. 3. SEE EQUIPMENT DRAWINGS AND ELECTRICAL DRAWINGS FOR ADDITIONAL LIGHTING

4. SEE ELECTRICAL DRAWINGS FOR ADDITIONAL SYMBOLS.
5. REFER TO V102 AND V112 FOR ALL CEILING HEIGHTS, FINISHES AND LIGHTING LOCATIONS. 6. GC IS TO V.I.F. THE HEIGHTS OF DUCTS IN BASEMENT PRIOR TO CEILING INSTALLTION.
ANY CONFLICTS, CONTACT ARCHITECT.
7. SEE MEP DRAWINGS FOR SUPPLY AND RETURN GRILL LOCATIONS

PLAN NOTES - RCP

SEE EQUIPMENT DRAWINGS FOR LIGHT INFORMATION IN COOLERS AREA NOT IN SCOPE.

NEW ACT TILE CEILING, SEE V102 AND V112 FOR ADDITIONAL INFORMATION NEW GYP. BD. SOFFIT CEILING, SEE V102 AND V112FOR ADDITIONAL INFORMATION DECORATIVE CEILING TRELLIS, SEE 4/A203 FOR ADDITIONAL INFORMATION. SEE V112 FOR FINISH INFORMATION.

TVS TO BE PROVIDED BY OTHERS. DECORATIVE TRELLIS, SEE V112 FOR ADDITIONAL INFORMATION.

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SYMBOL LEGEND

2X4 LED FIXTURE 2X2 LED FIXTURE

DECORATIVE PENDANT LIGHT

HIGH BAY LIGHT FIXTURE

DECORATIVELINEAR LIGHT FIXTURE

INDUSTRIAL STRIPE LIGHTING

MONITOR MONITOR

RECESSED CAN FIXTURE

LAMINATE CEILING

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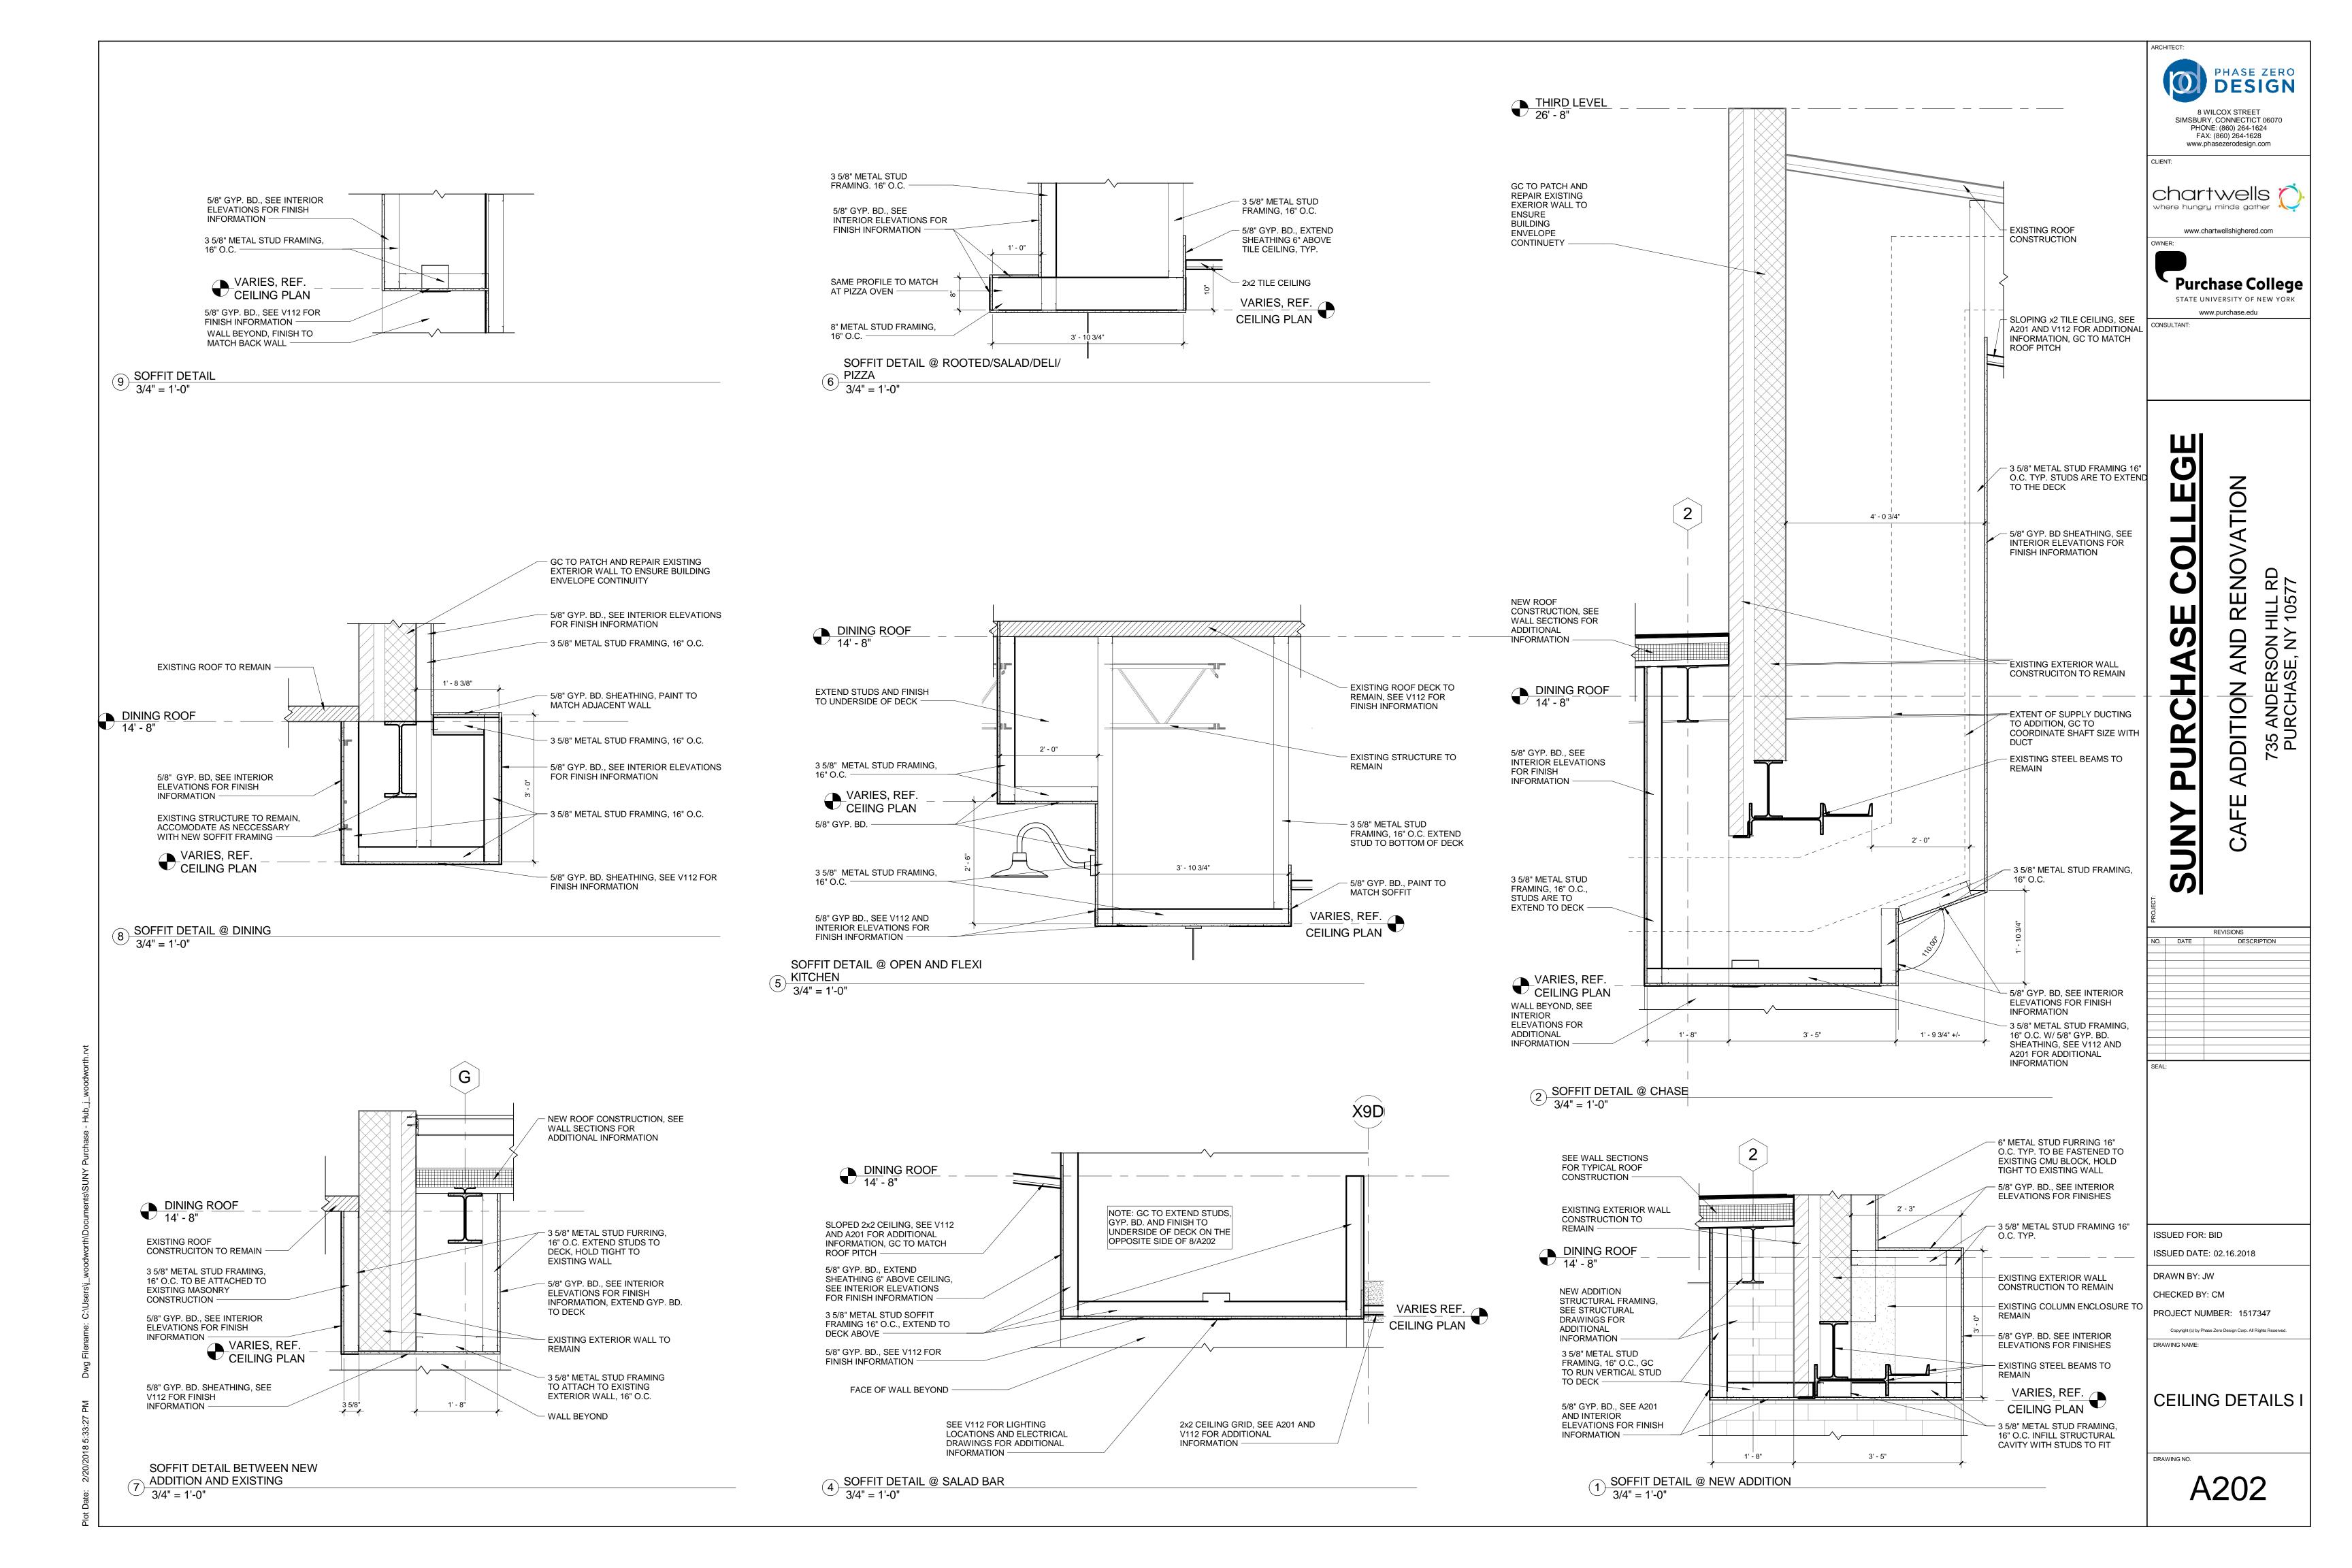
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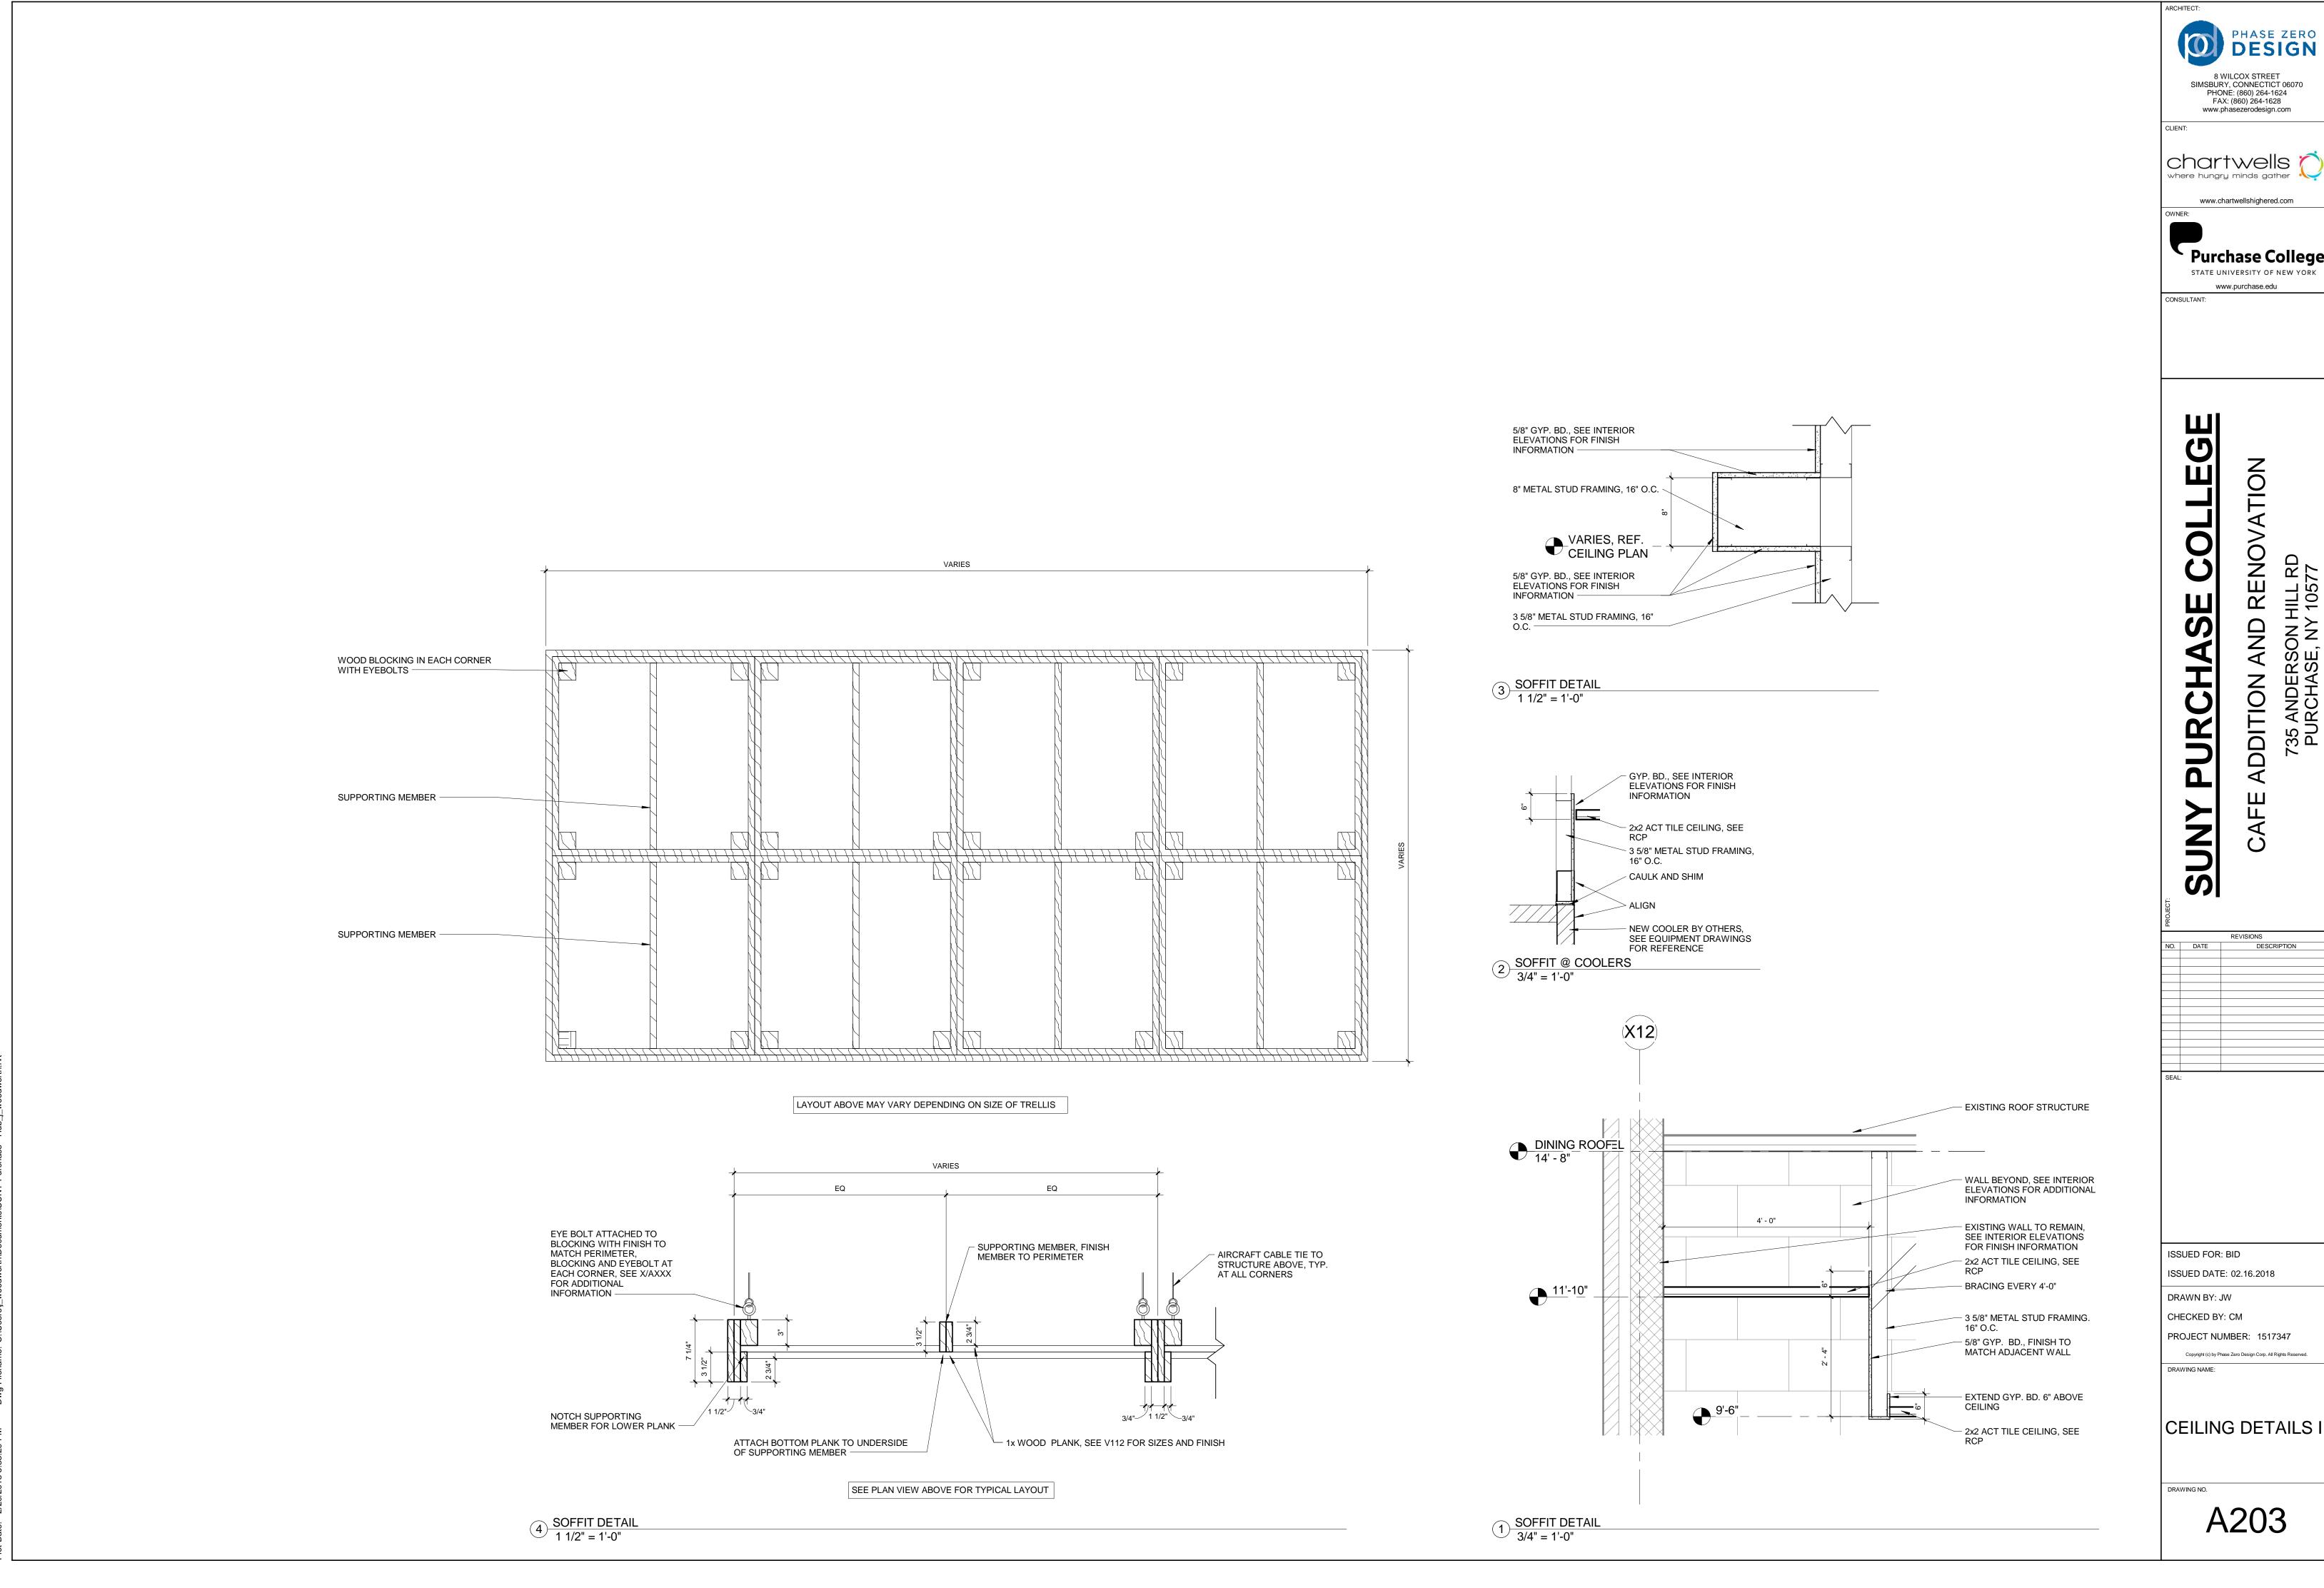
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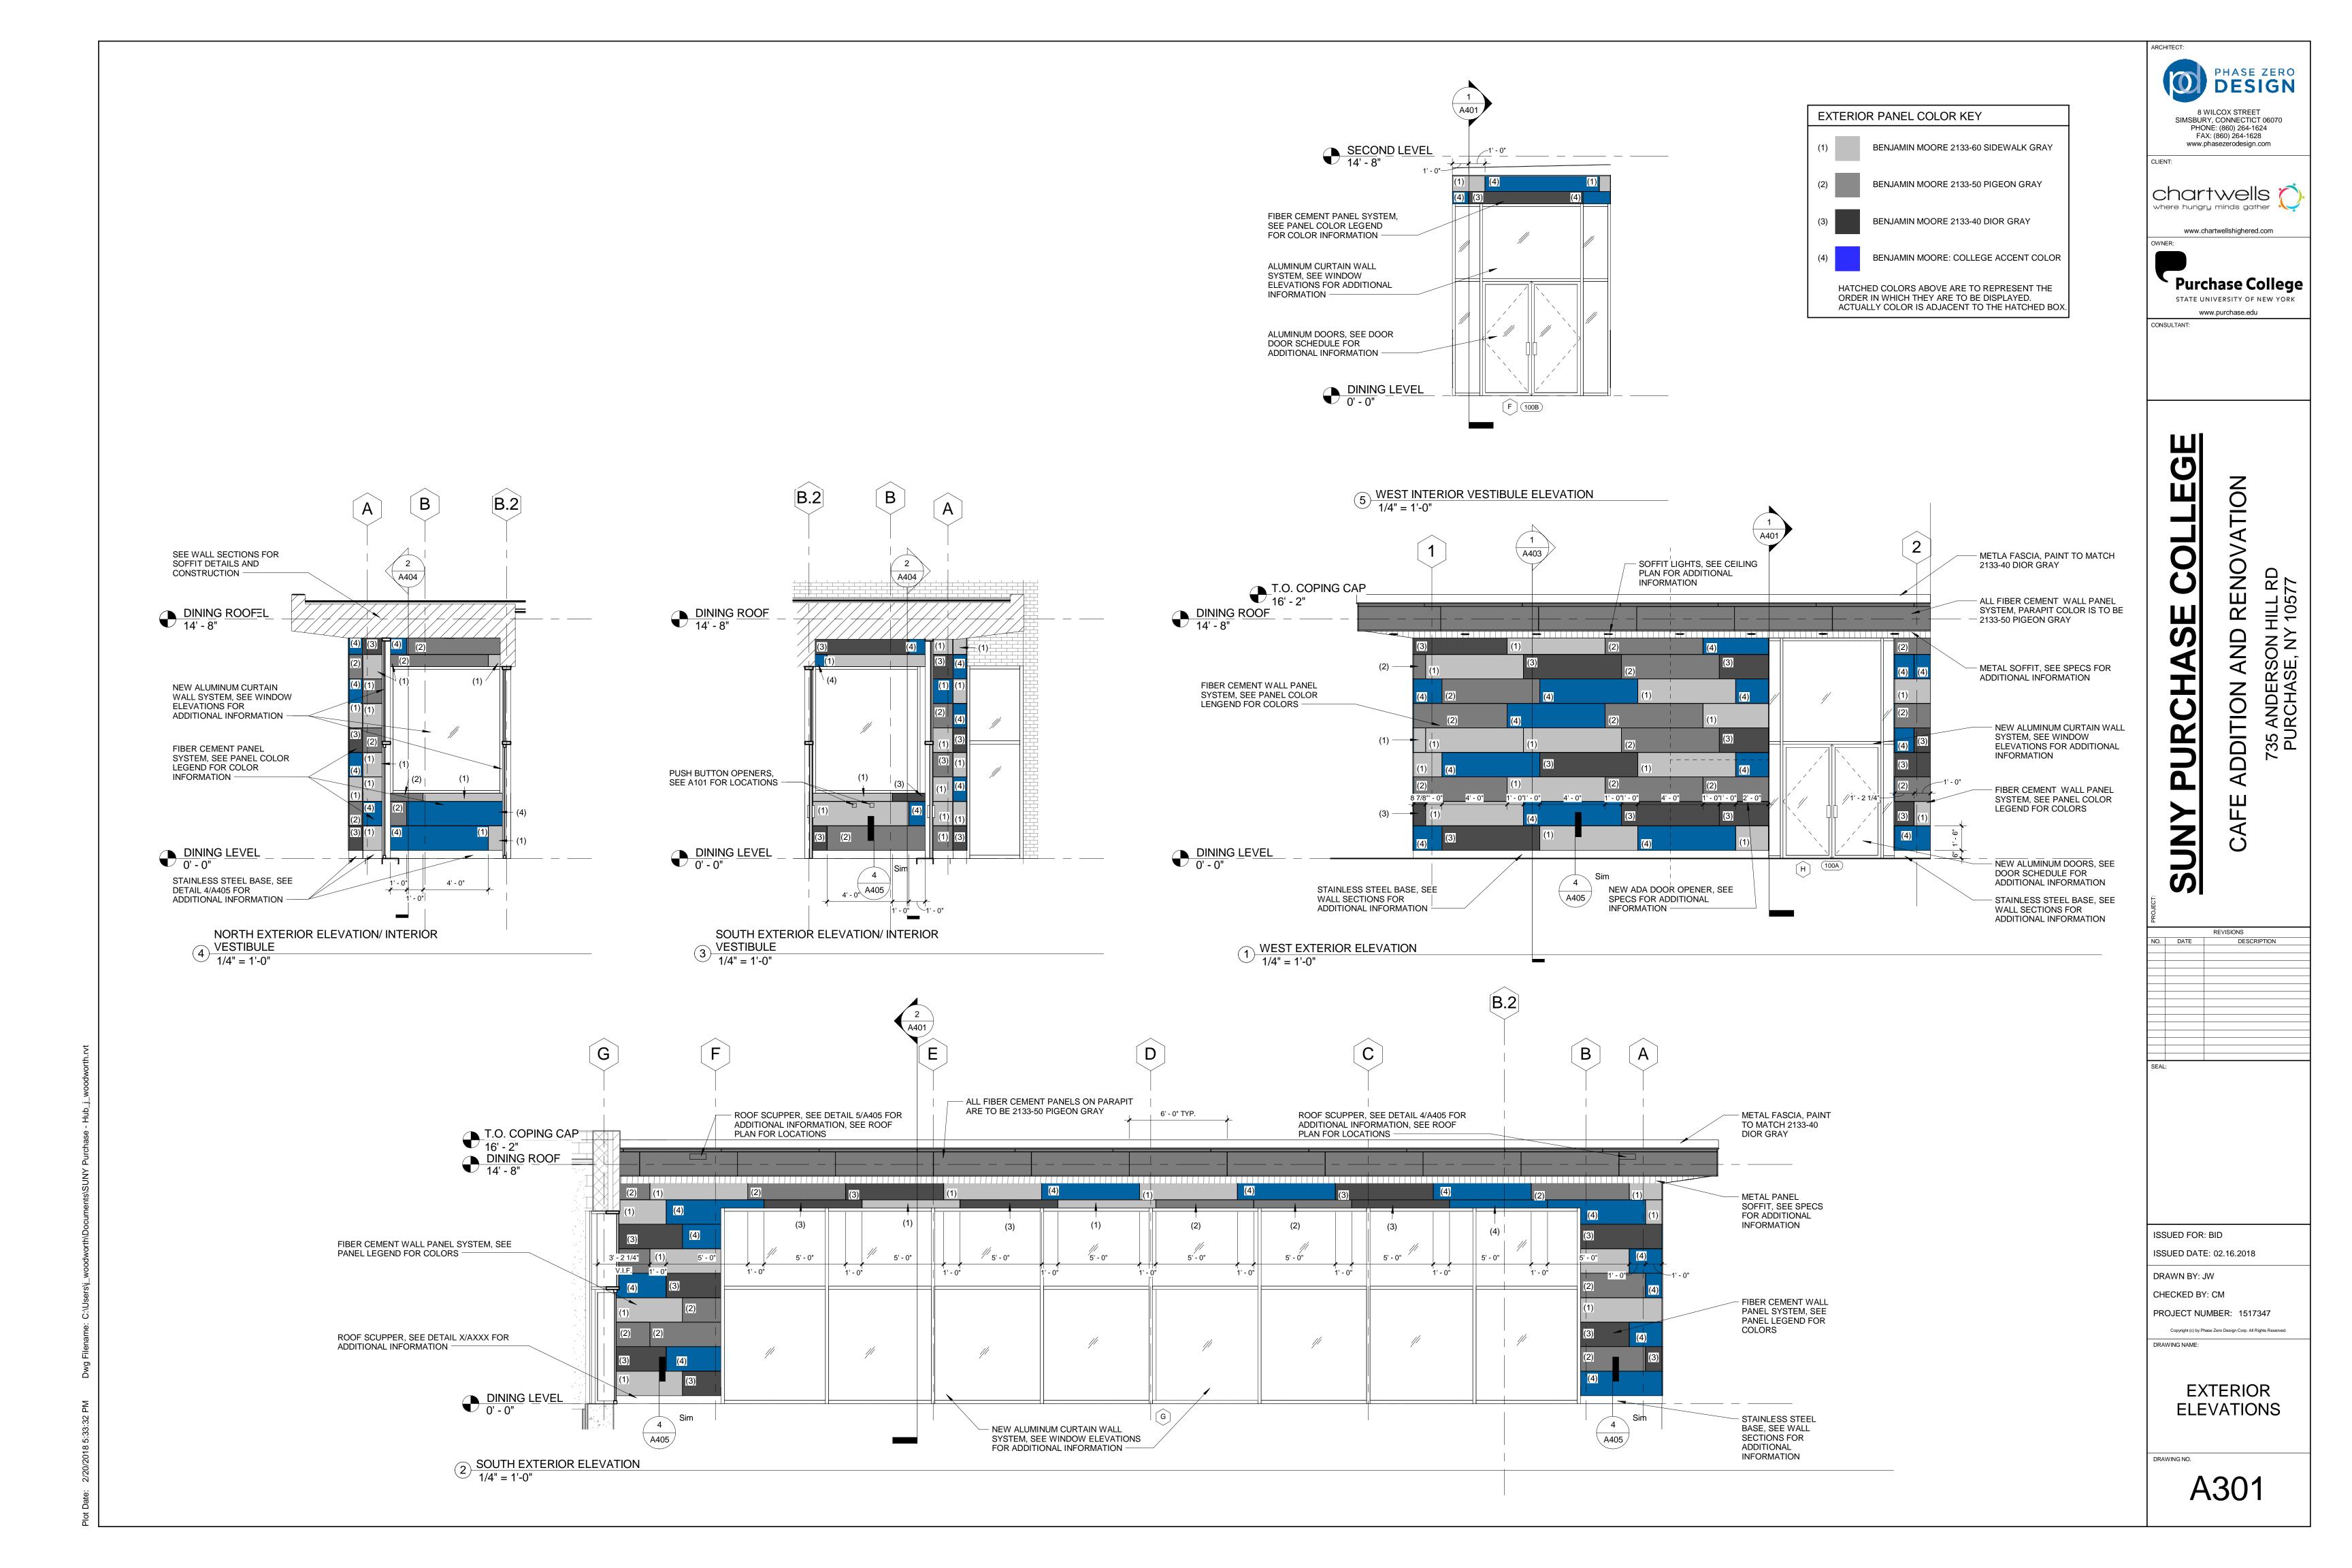
**CEILING PLAN** 







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# CAFE ADDITION AND RENOVATION

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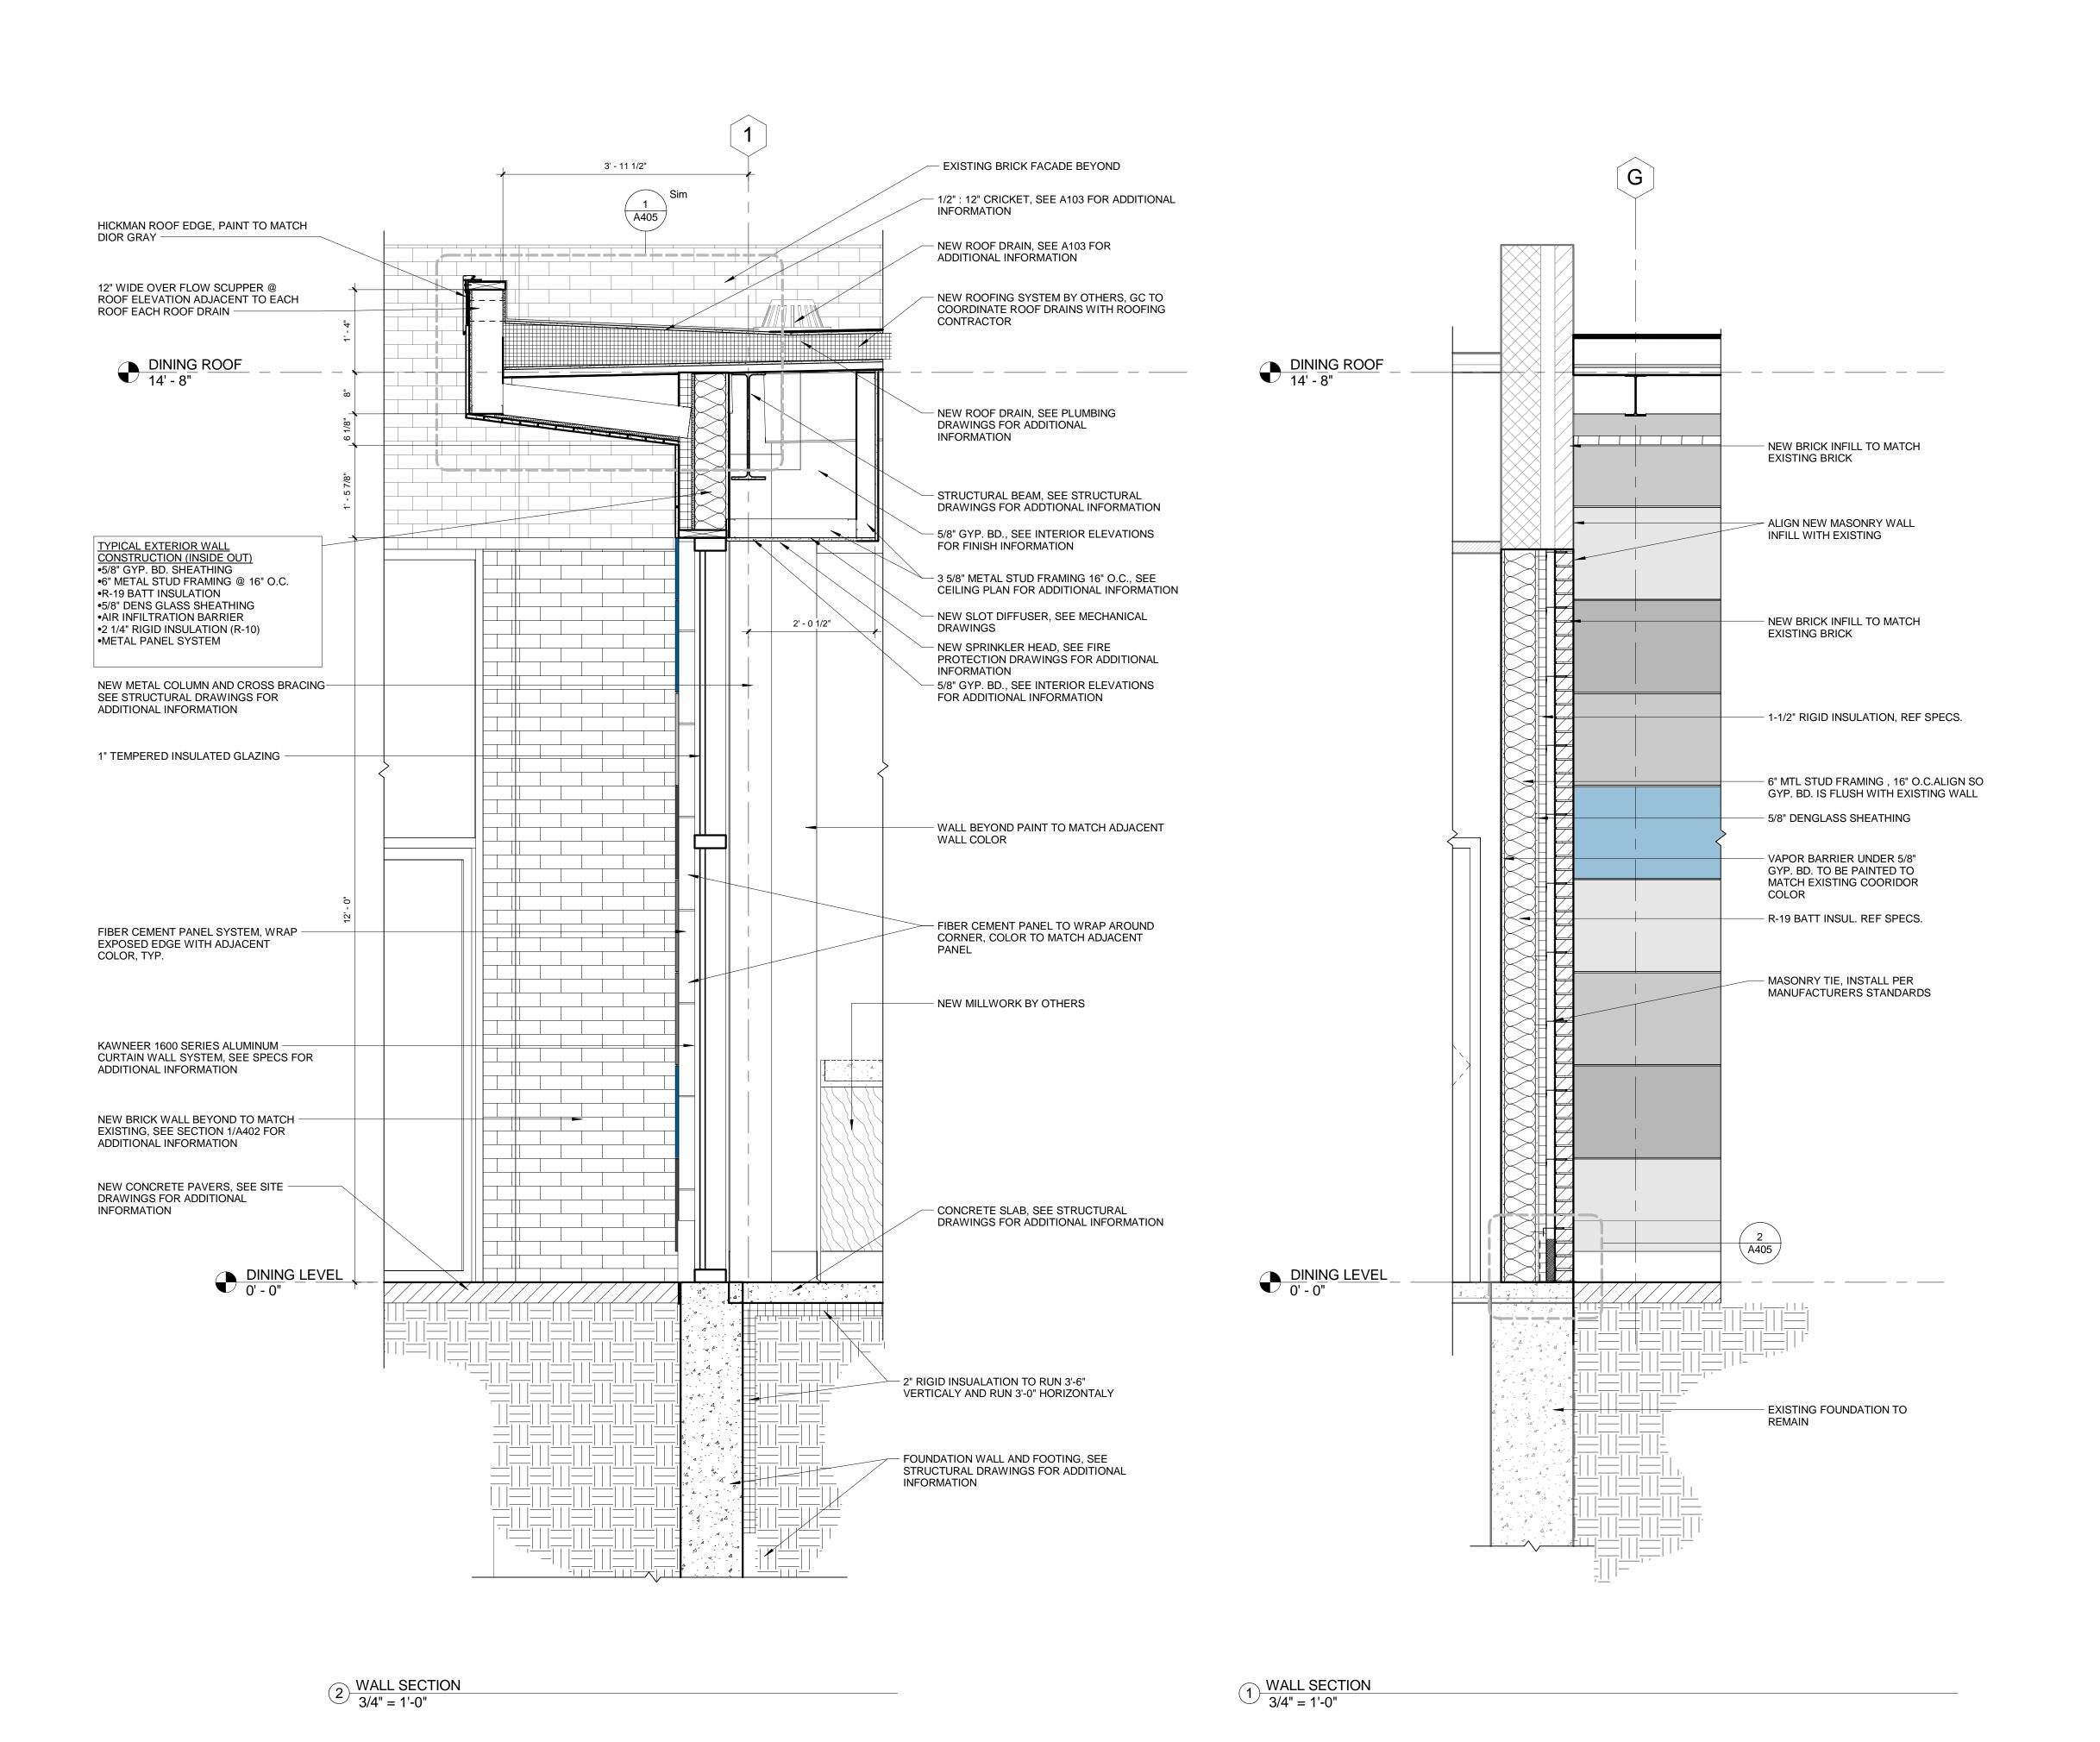
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BUILDING SECTIONS

DRAWING NO

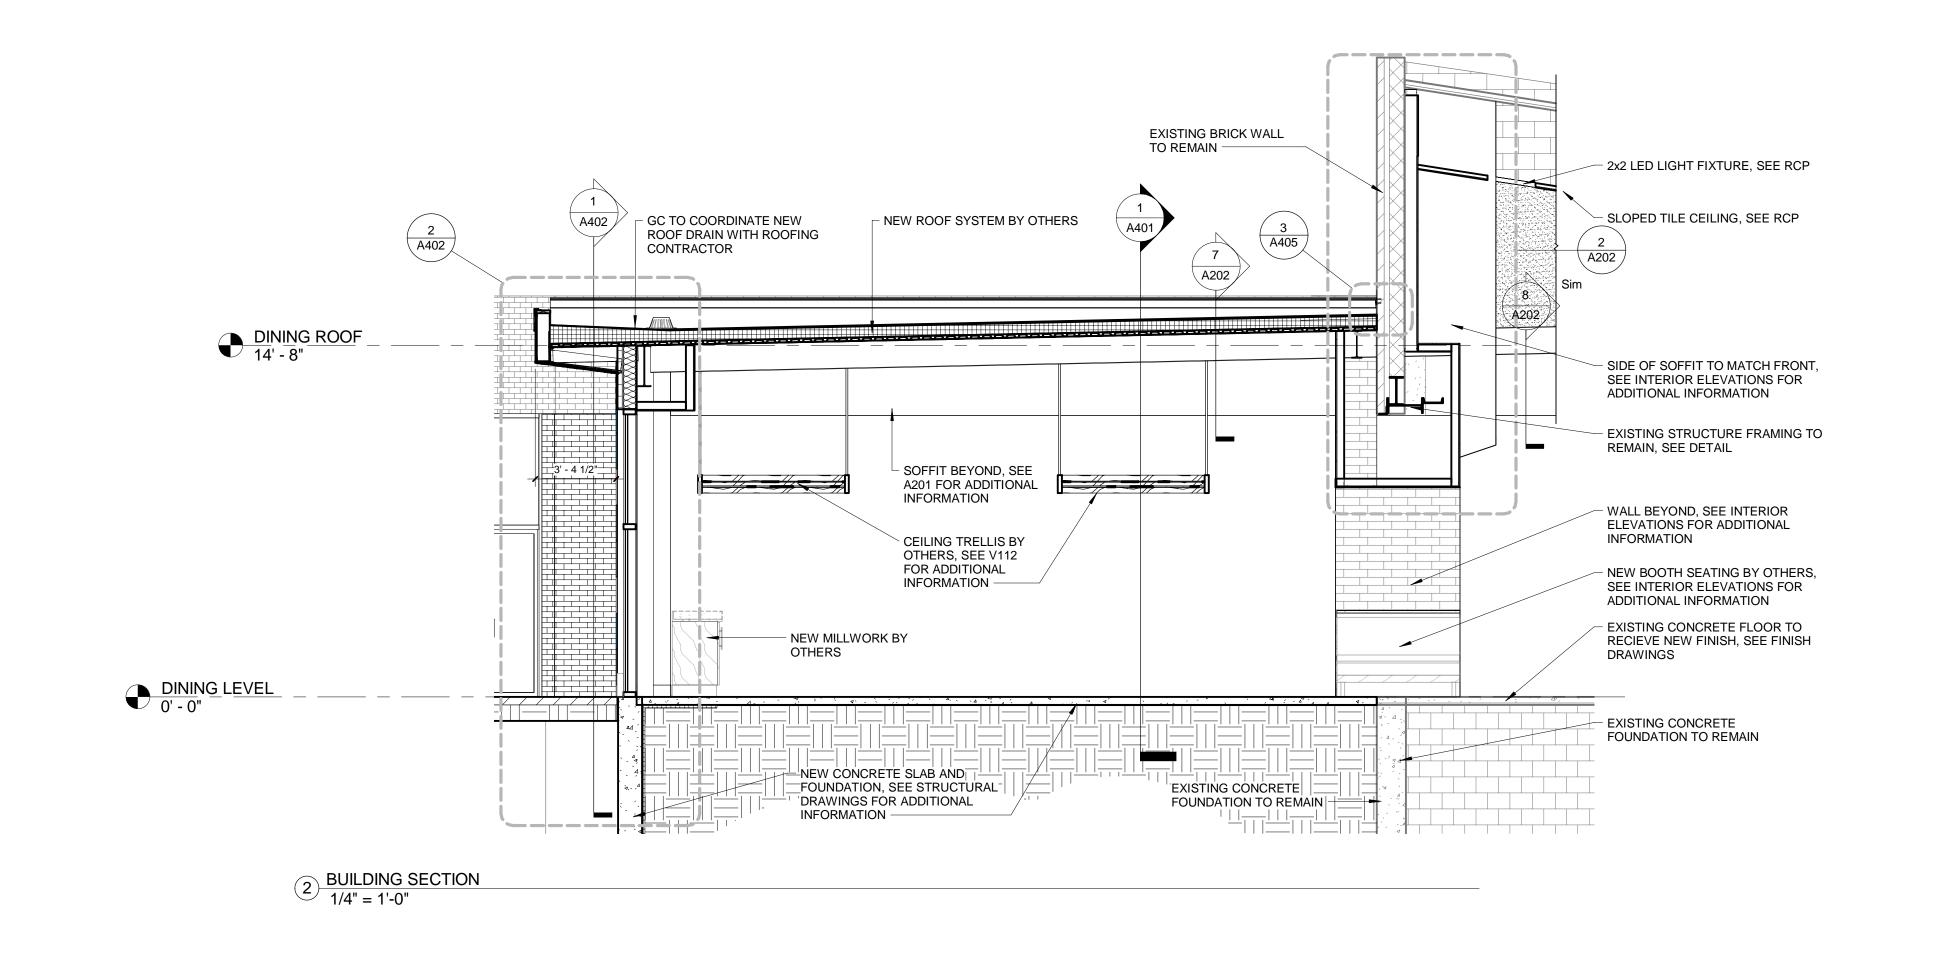
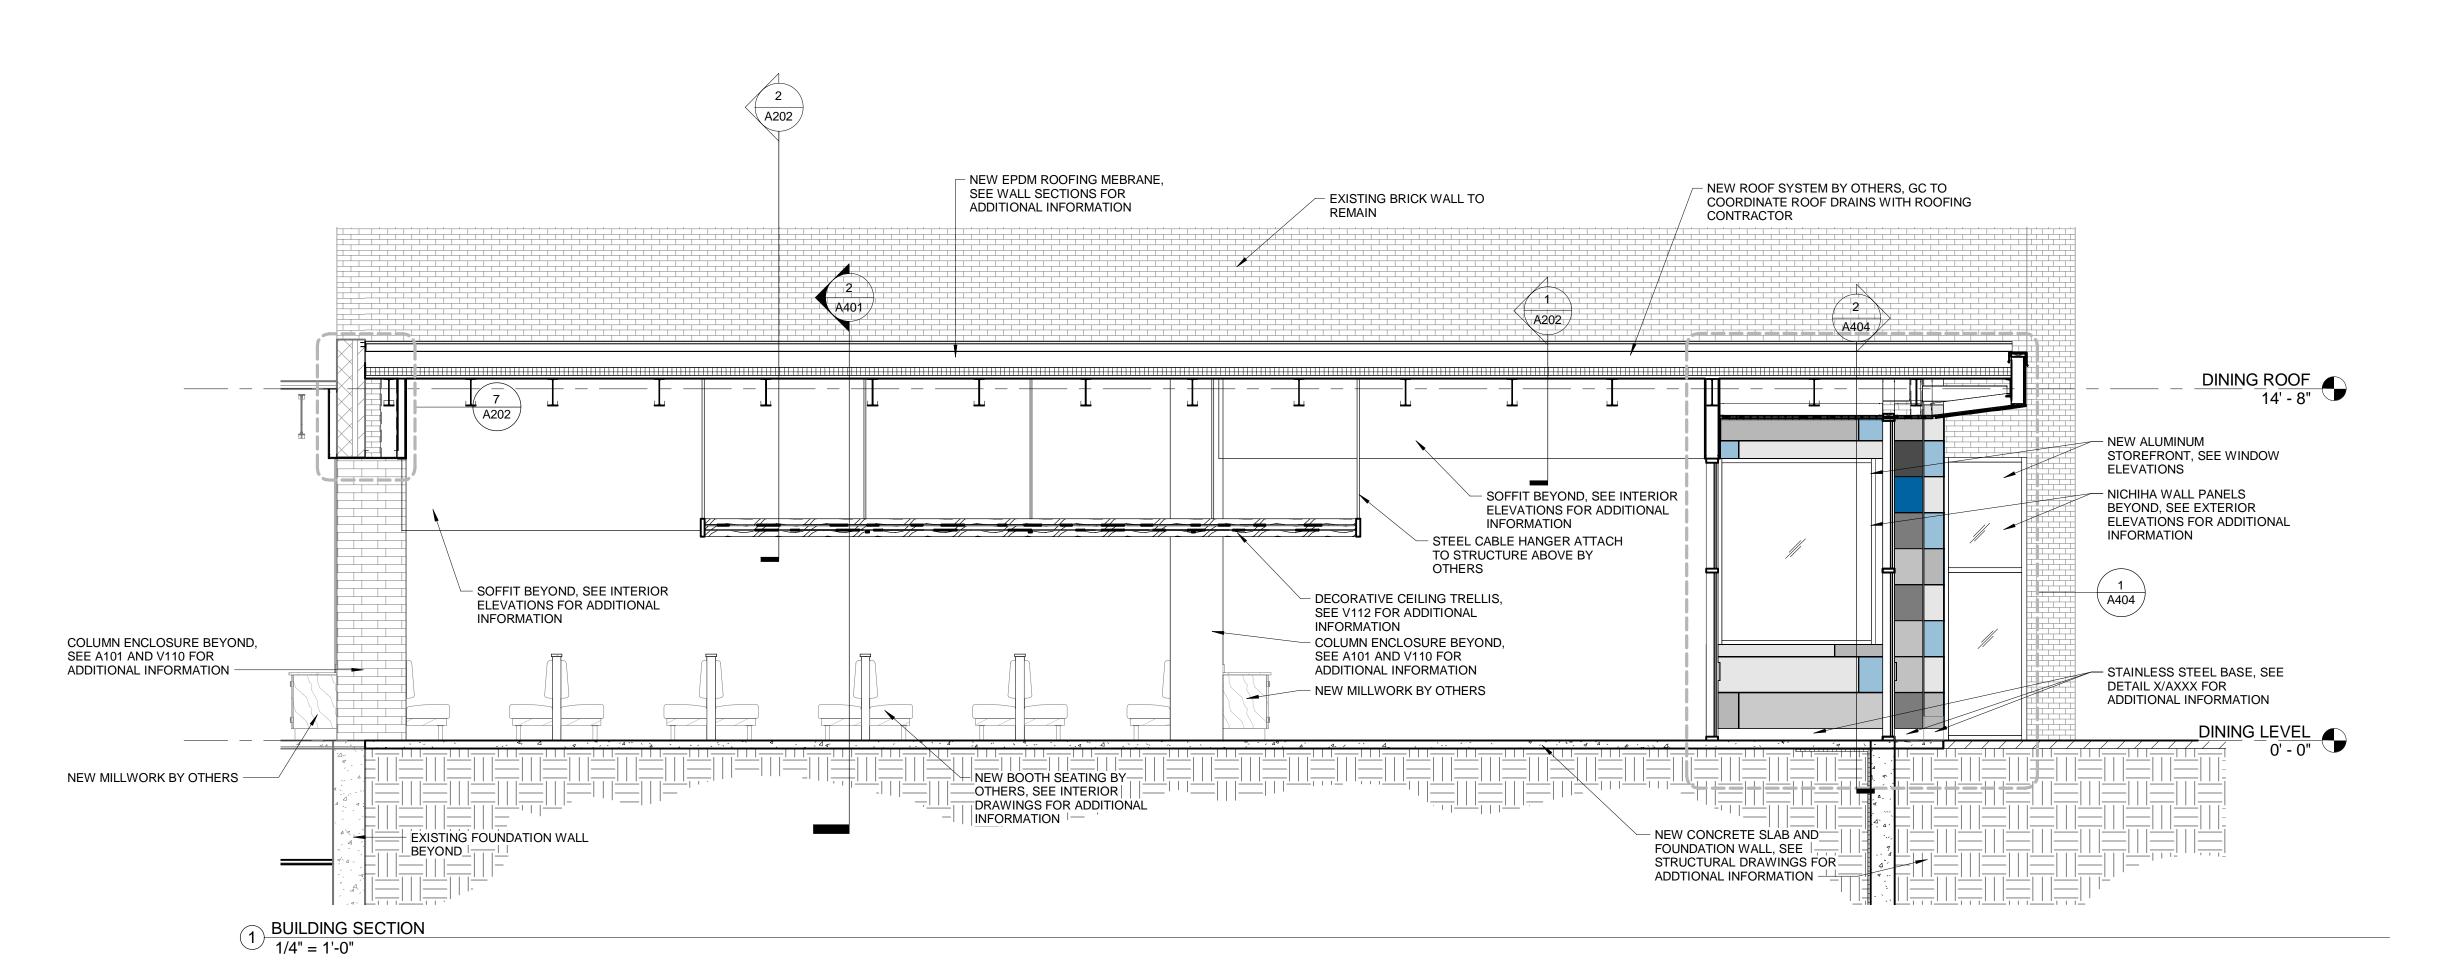
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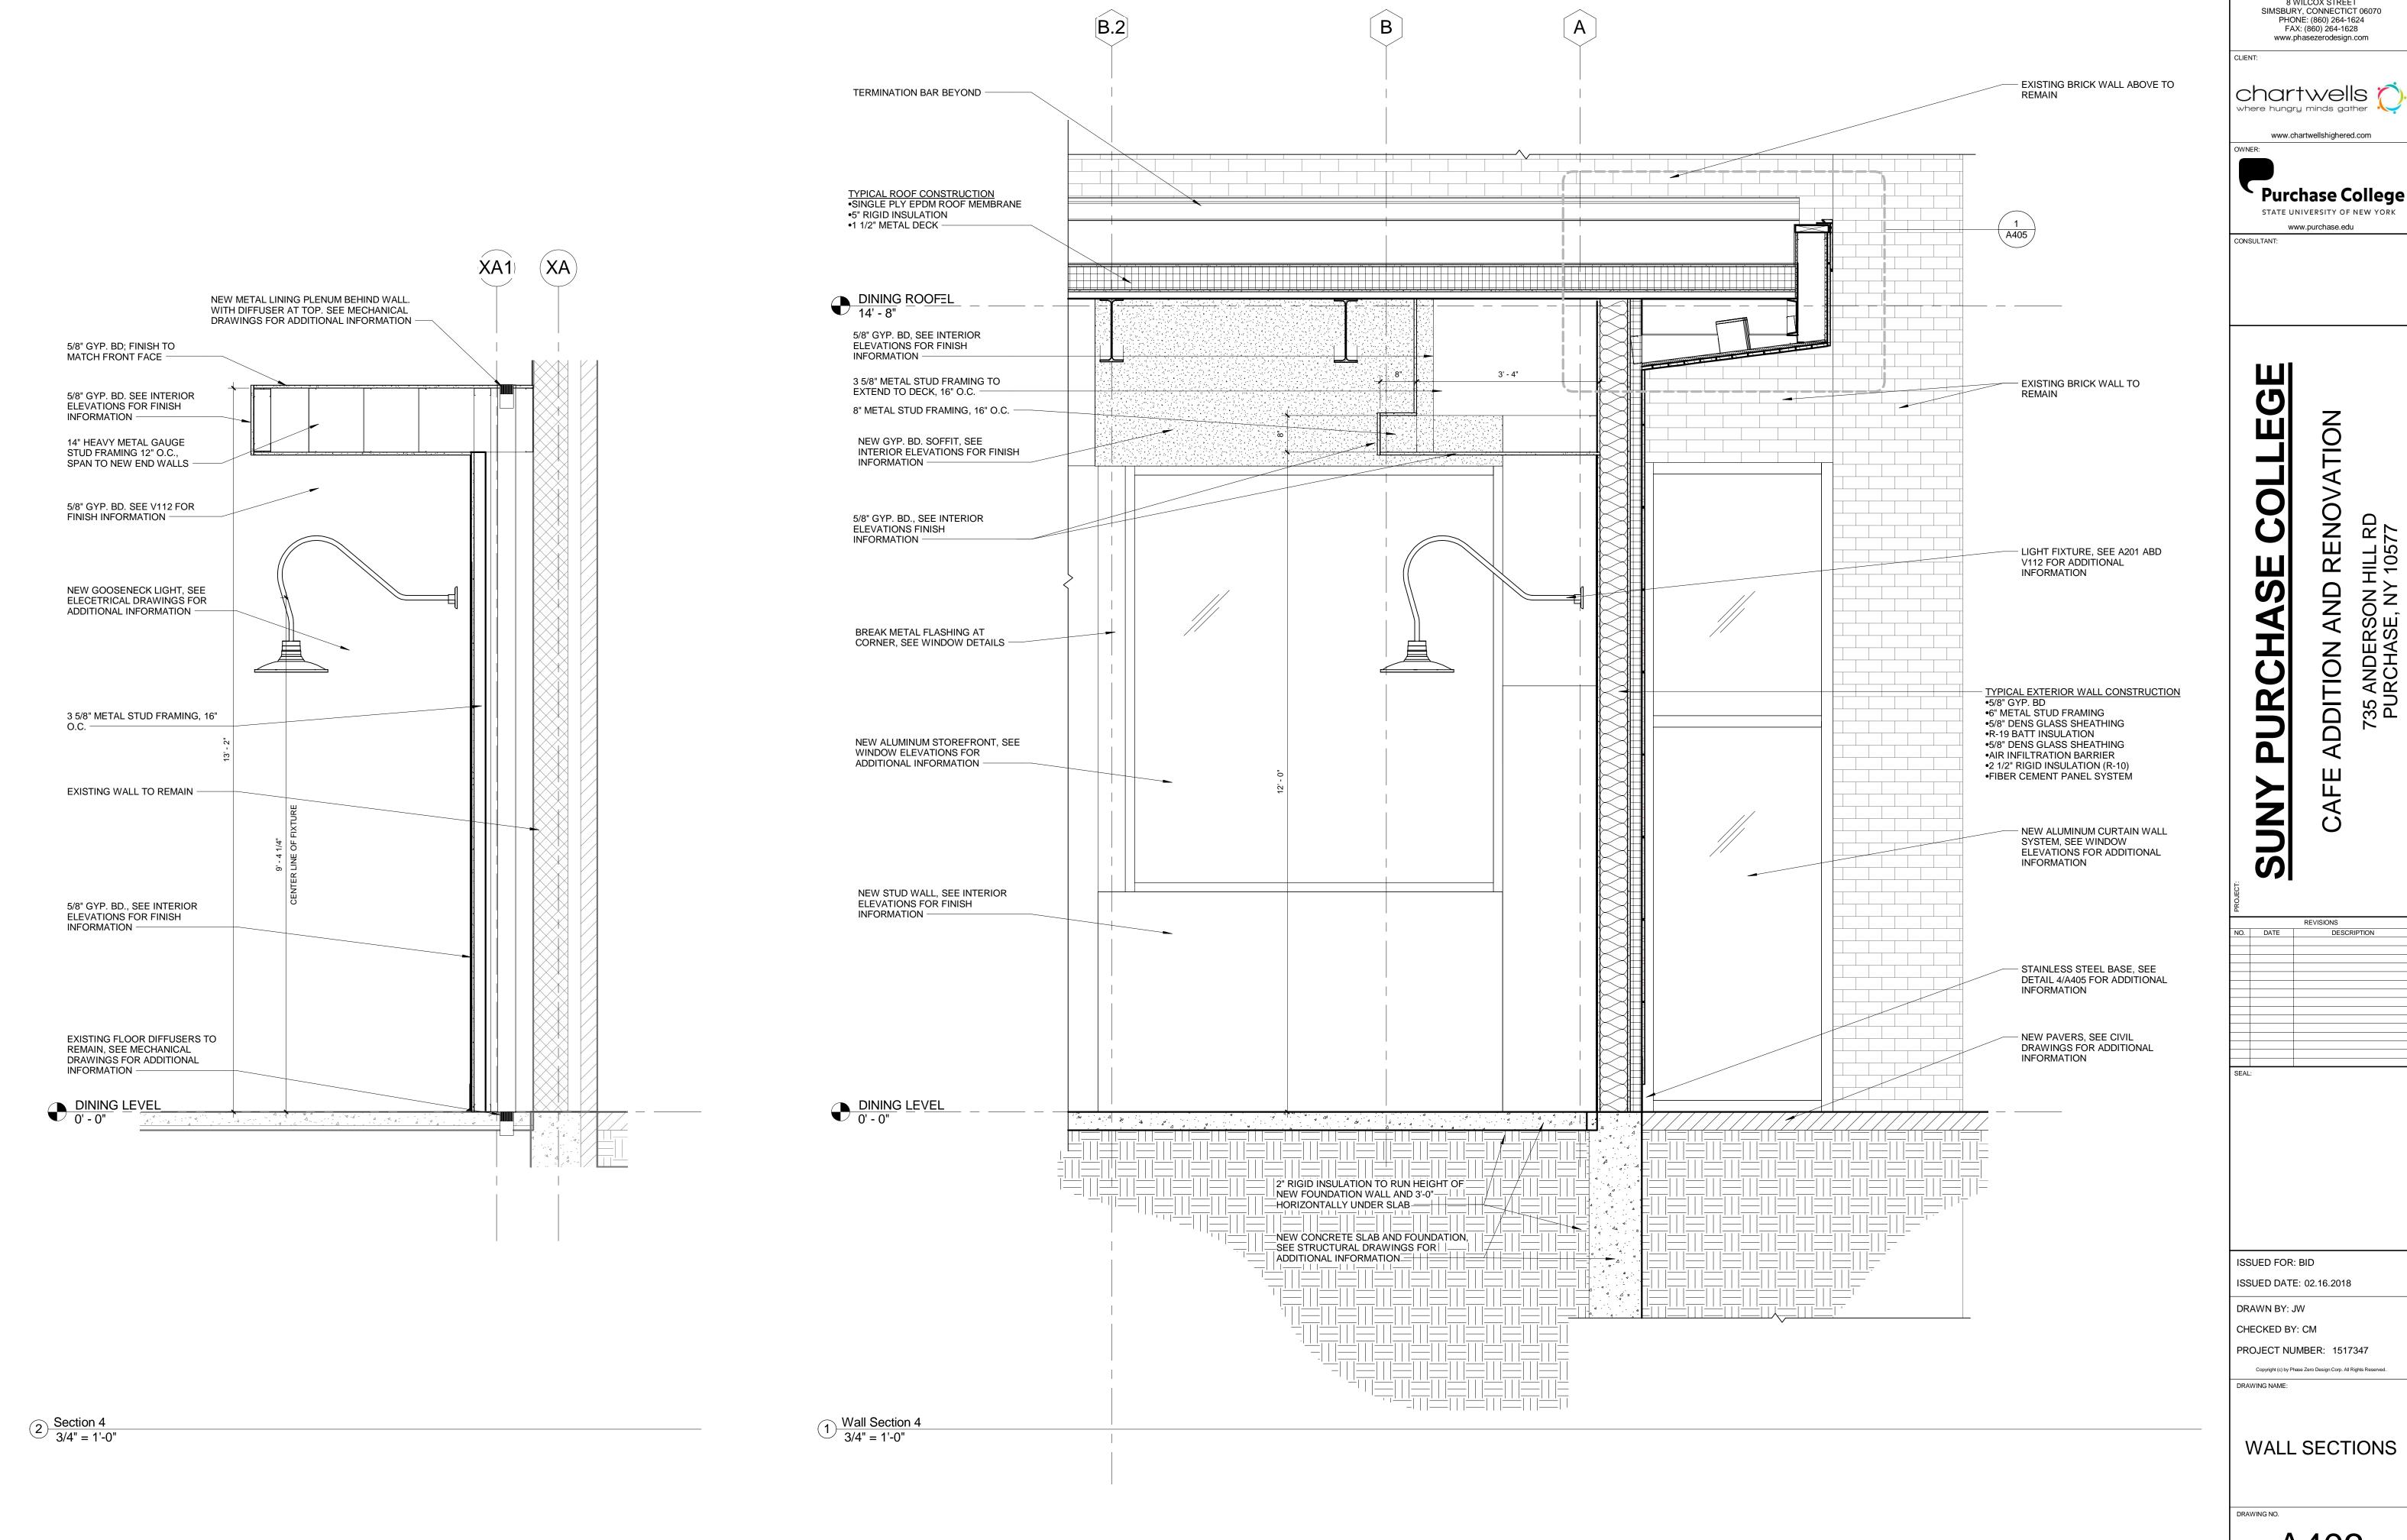
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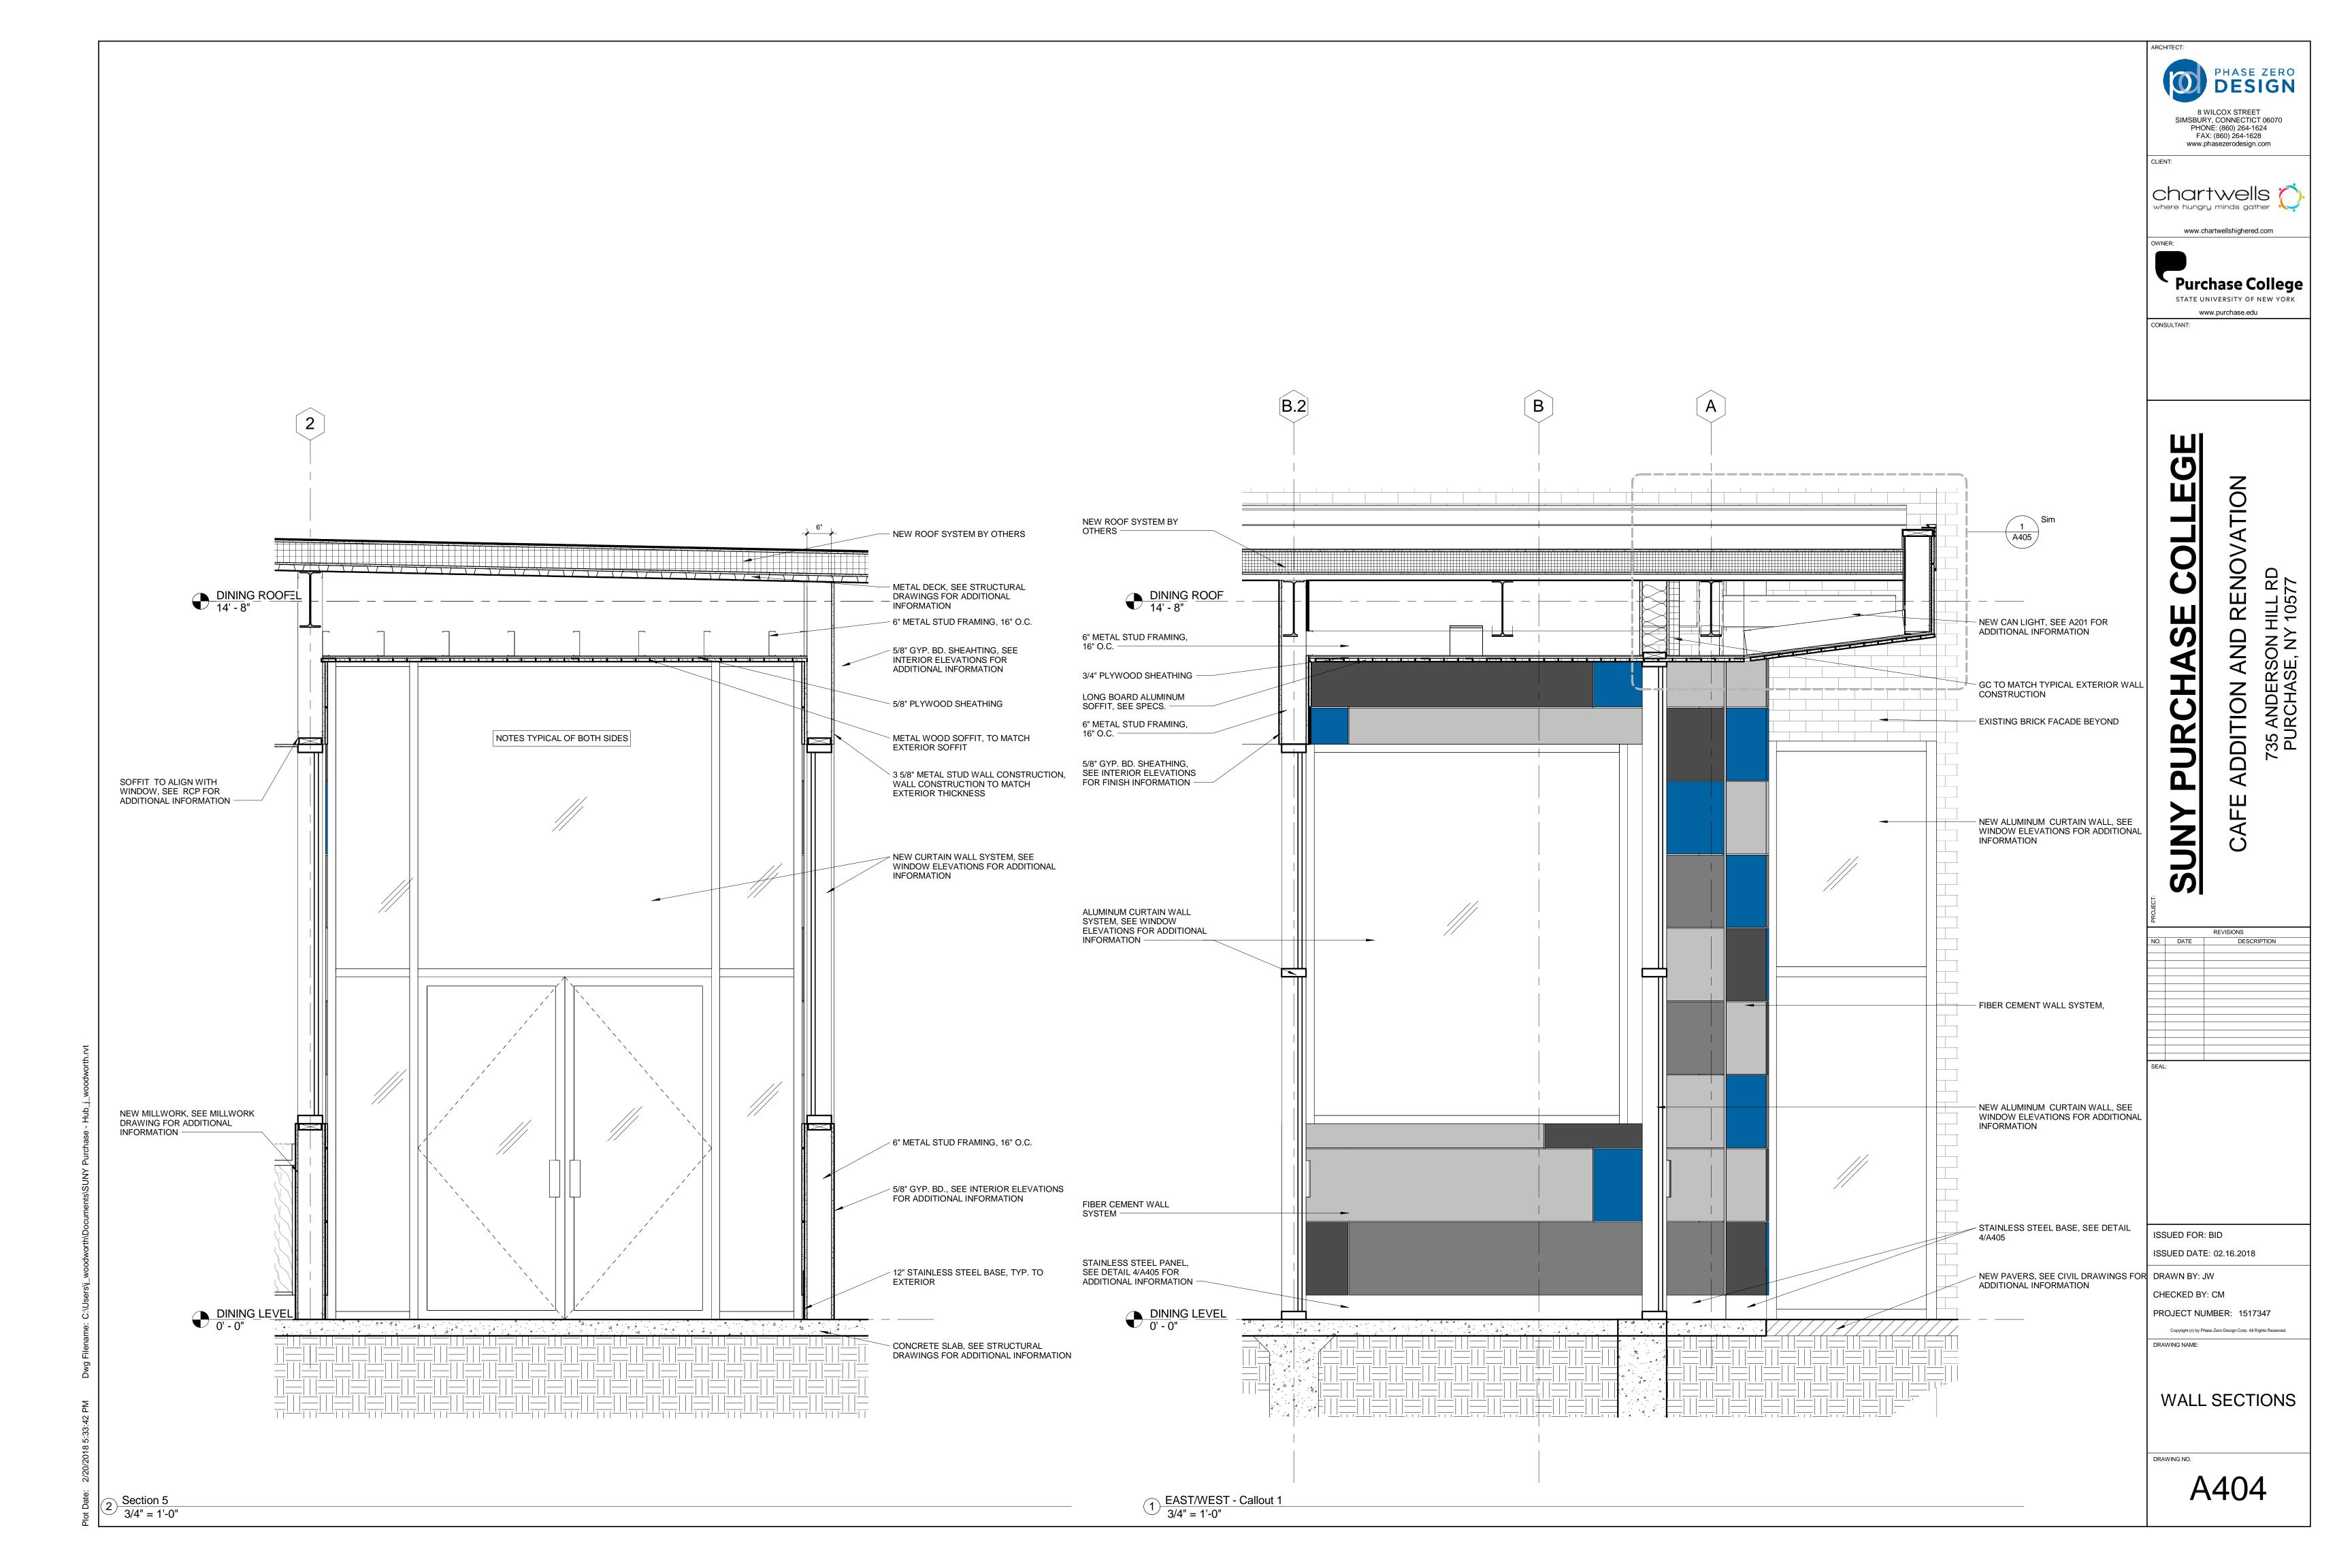
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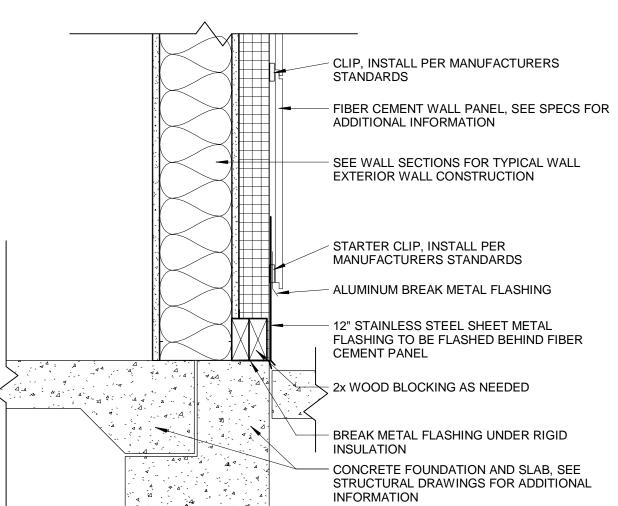
WALL SECTIONS


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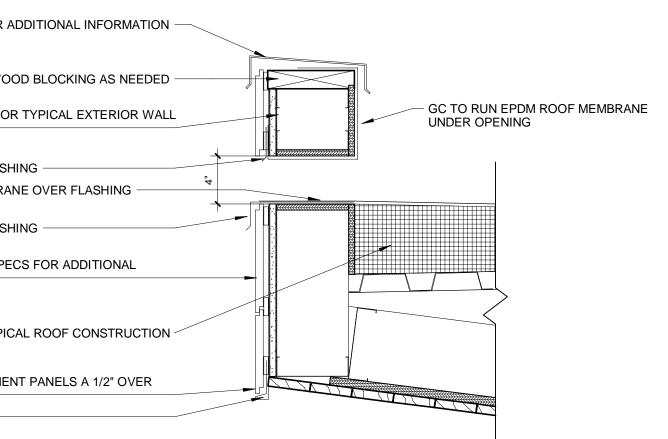








5 WALL SCUPPER 1 1/2" = 1'-0"

4 EXTERIOR WALL BASE 1 1/2" = 1'-0"

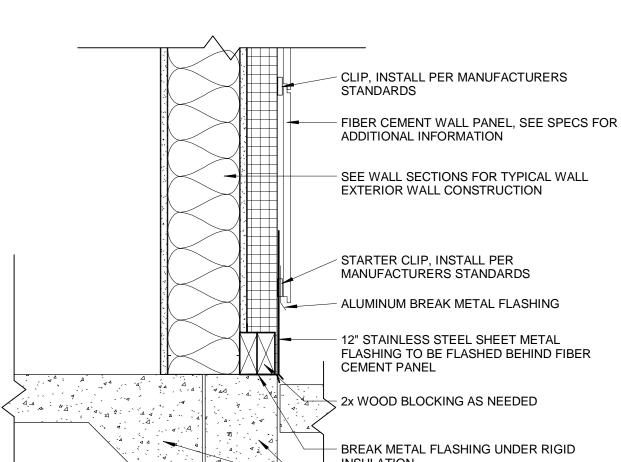

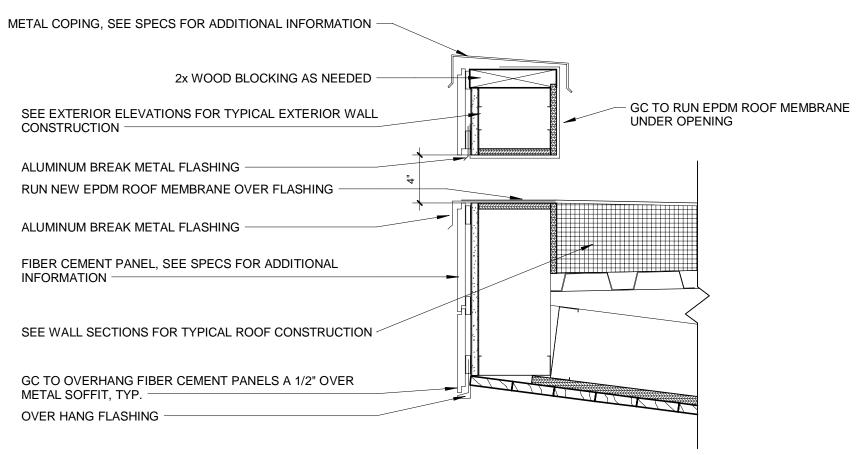


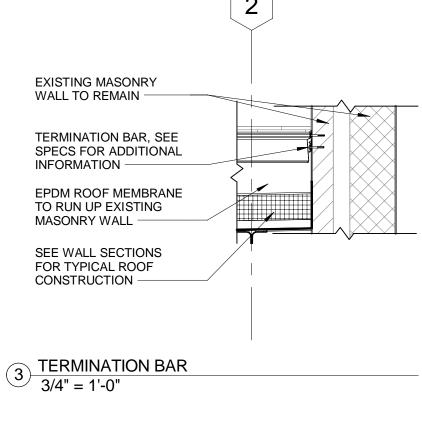

2 SECTION DETAIL 1 1/2" = 1'-0"

DINING ROOF 14' - 8"

1 Typical Roof Overhang 1 1/2" = 1'-0"

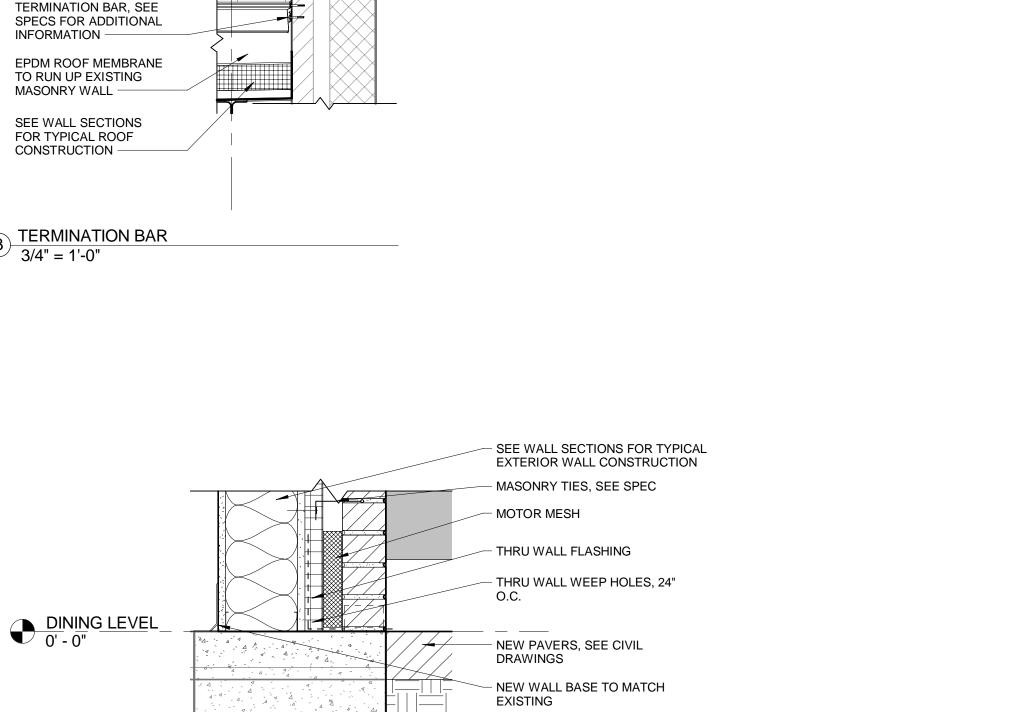



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SECTION DETAILS

- EPDM ROOF MEMBRANE AND

RUN MEMBRANE UNDER COPING \_2x WOOD BLOCKING AS NEEDED

METAL COPING CAP, SEE SPECS FOR ADDITIONAL INFORMATION

NEW ROOF SYSTEM BY OTHERS

FOR ADDITIONAL INFORMATION

SEE DETAIL 5/A405 FOR OVERHAND

FIBER CEMENT DETAIL

STANDARDS 5/0 DEINGGLASS SHEATHING

METAL SOFFIT, SEE SPECS FOR ADDITIONAL INFORMATION

- FIBER CEMENT WALL PANEL, SEE SPECS

METAL FLASHING PER MANUFACTURERS

SEE WALL SECTIONS FOR EXTERIOR WALL CONSTRUCTION

TERMINATION BAR

PHASE ZERO


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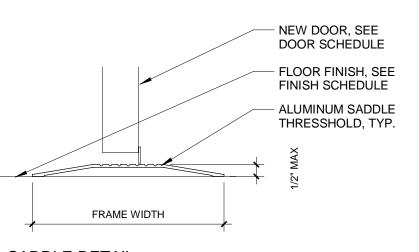
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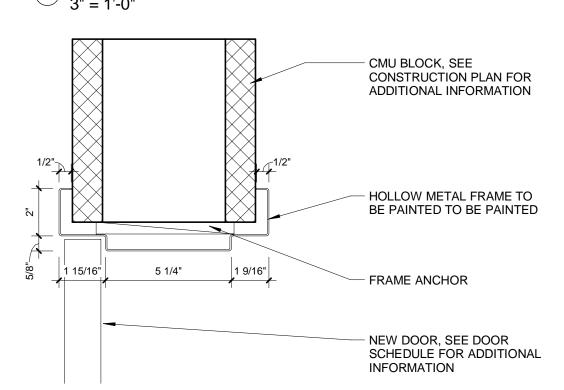
DOOR SCHEDULE NOTES:

- X = NEW ITEM, REPLACE EXISTING ITEMS WHERE NOTED AT EXISTING CONDITIONS EX = EXISTING ITEM TO REMAIN. GC SHALL VERIFY ALL EXISTING CONDITIONS AND CONFIRM WORKING ORDER
- T = TEMPERED GLAZING TI = TEMPERED & INSULATED GLAZING S = SAFETY / FIRE GLASS


WHERE NOTED WITH TOP & BOTTOM BOLTS, BOLTS SHALL BE PROVIDED ON INACTIVE LEAF WITH DUMMY LEVER AND ACTIVE LEAF LATCHING INTO INACTIVE DOOR.



S1 SADDLE DETAIL 3'' = 1'-0''

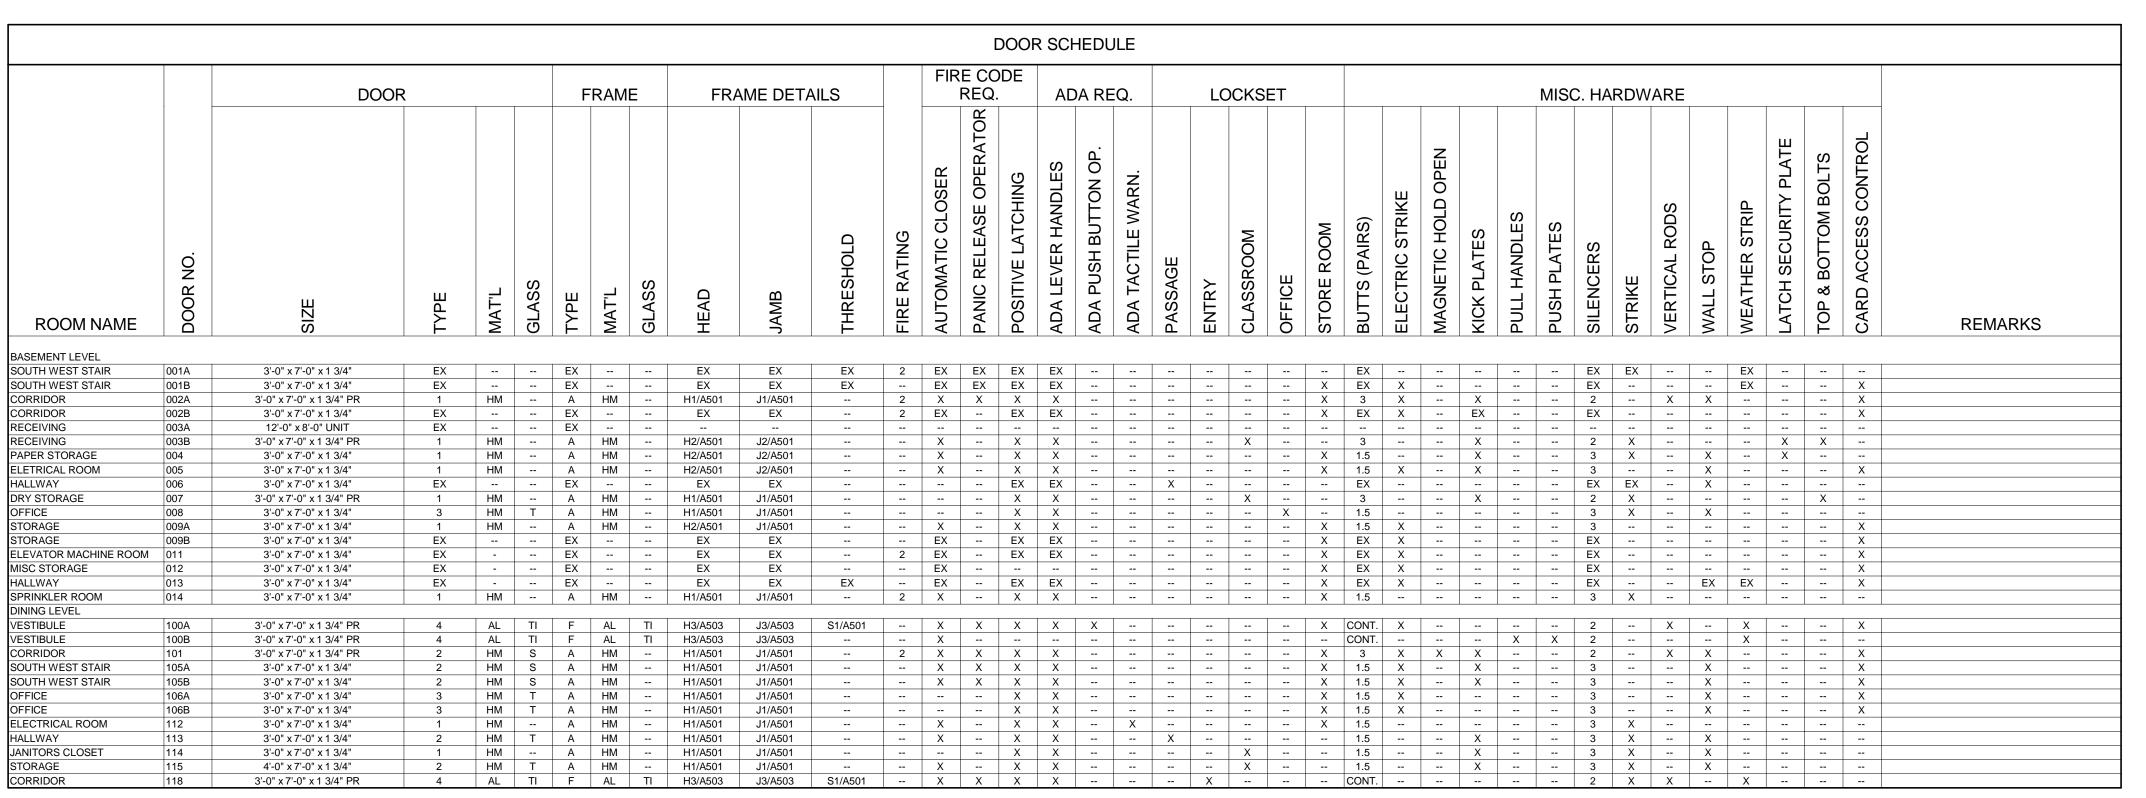


H2 ALUM STOREFRONT INTERIOR (SILL)
3" = 1'-0"

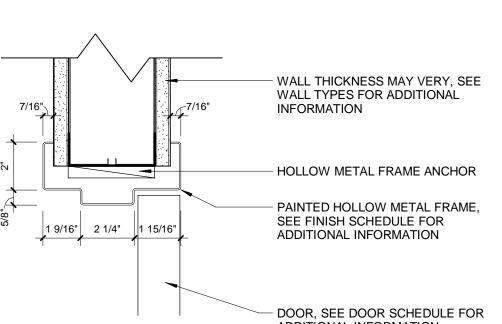



ADDITIONAL INFORMATION

H1 INTERIOR DOOR HEAD DETAIL 3" = 1'-0"

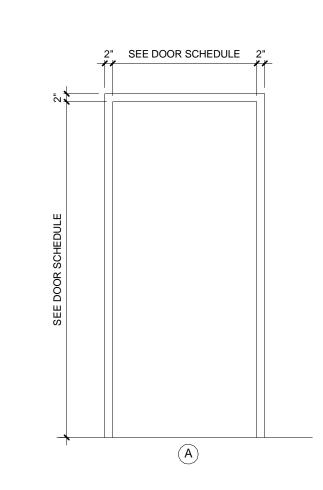


3'-0" x 7'-0" x 1 3/4" PR

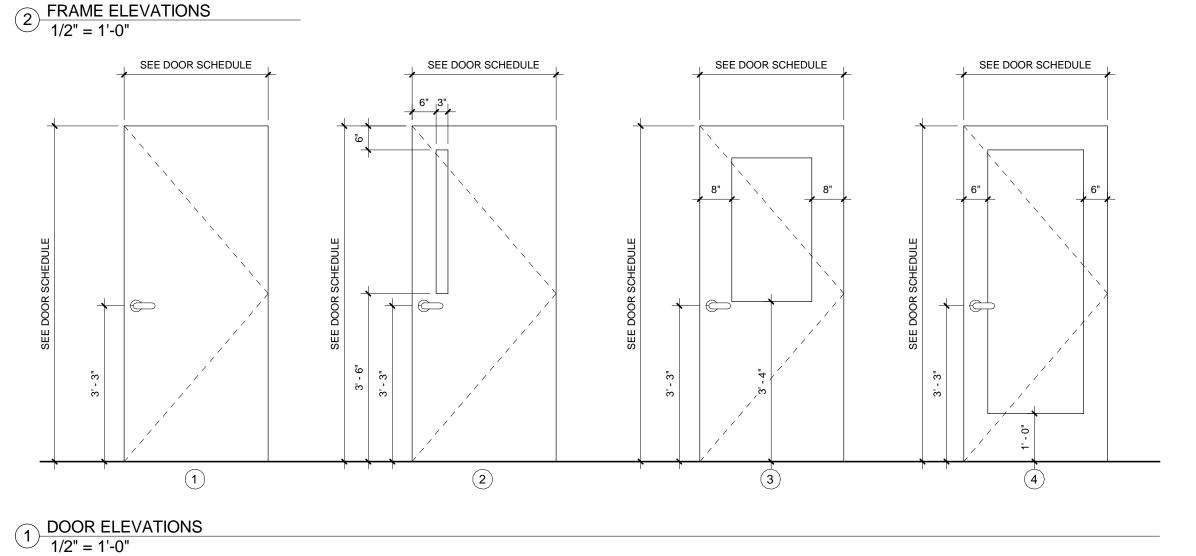

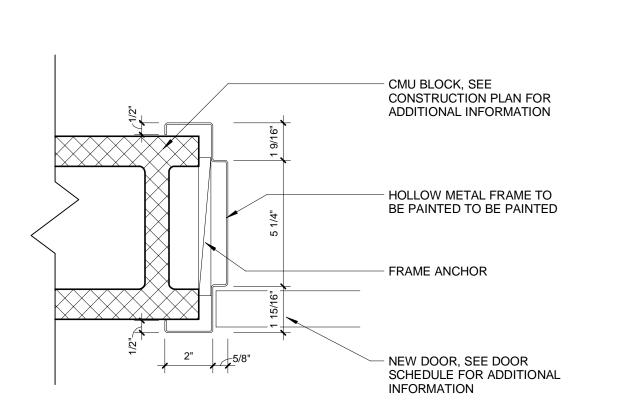



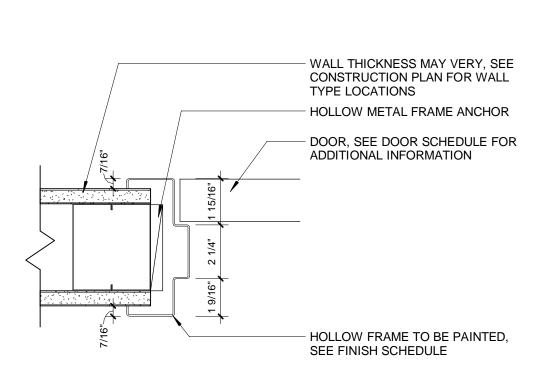

TYP. INTERIOR DOOR JAMB
3" = 1'-0"

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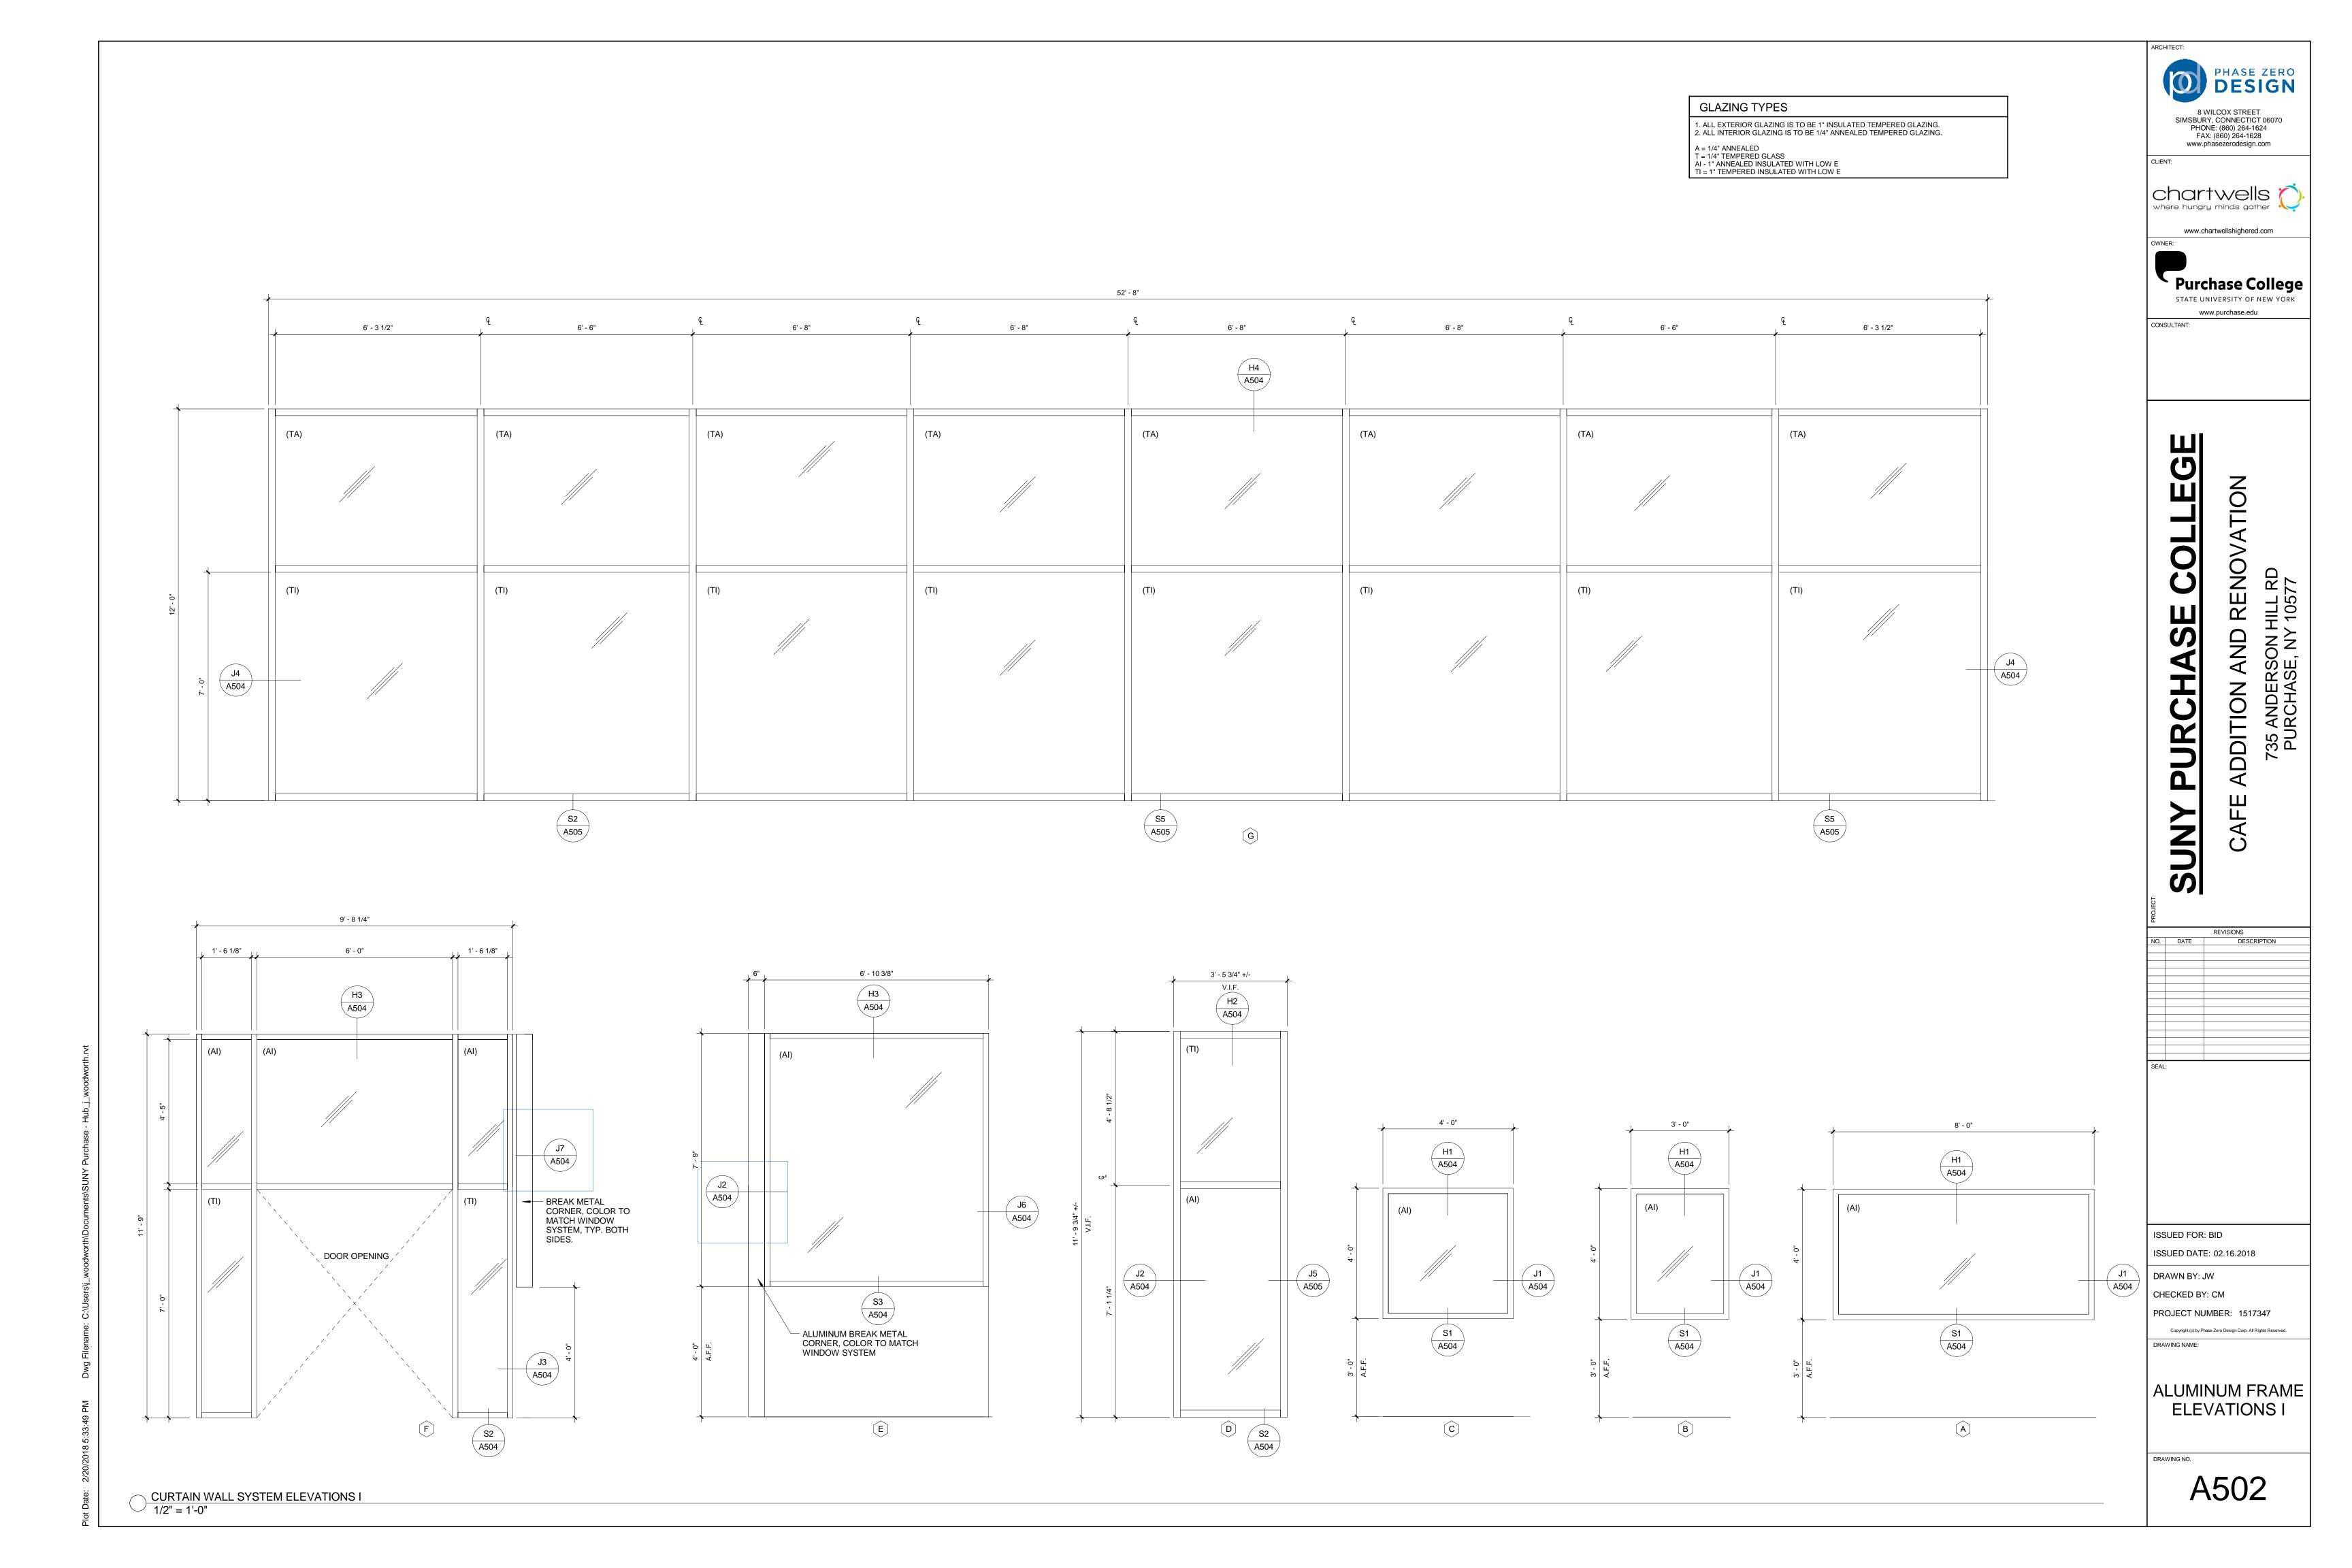
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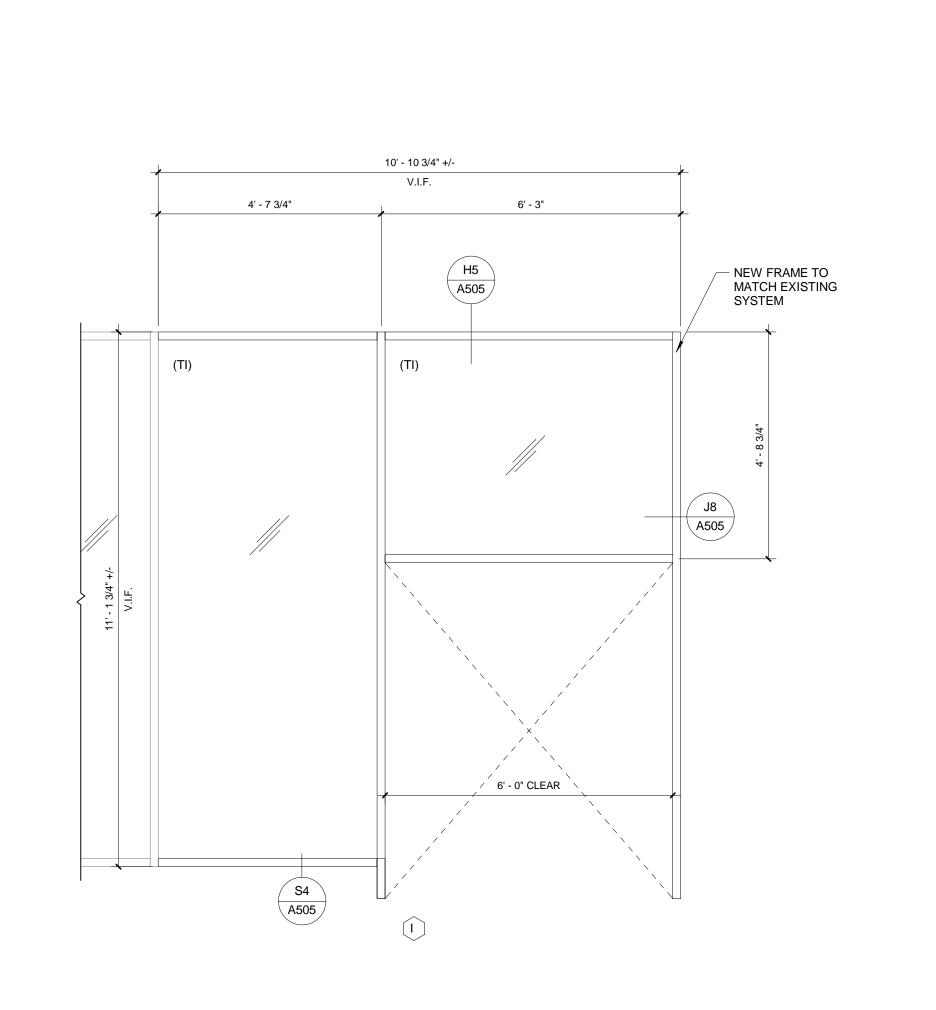
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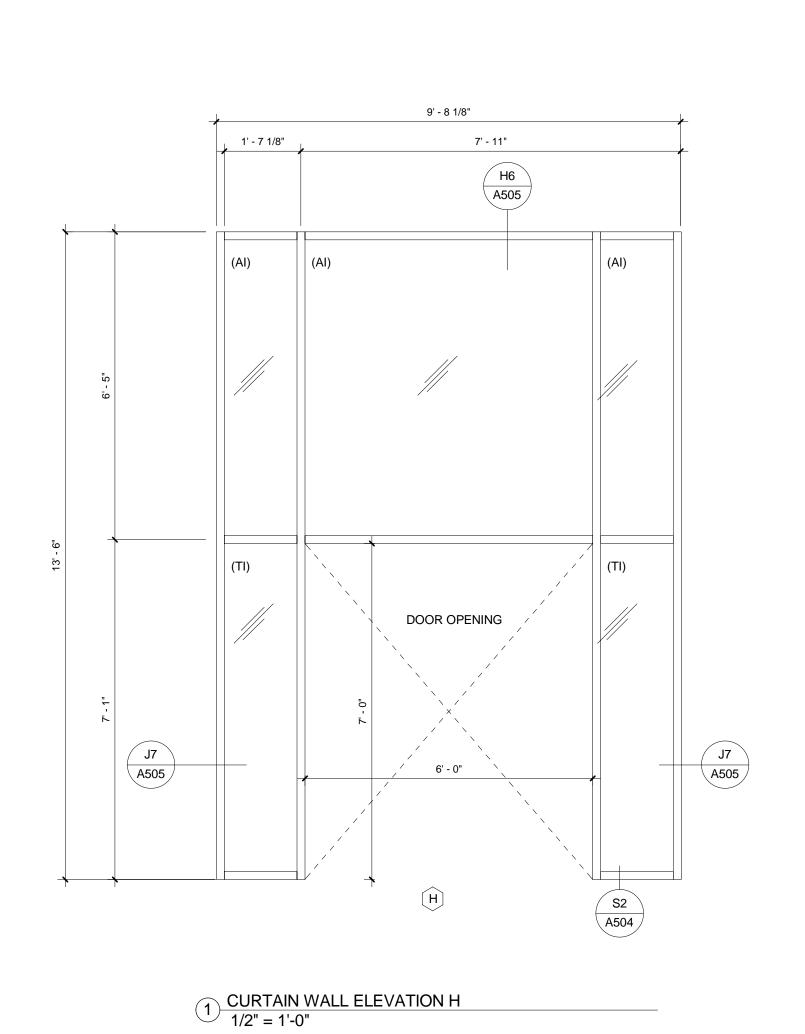
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DOOR SCHEDULE

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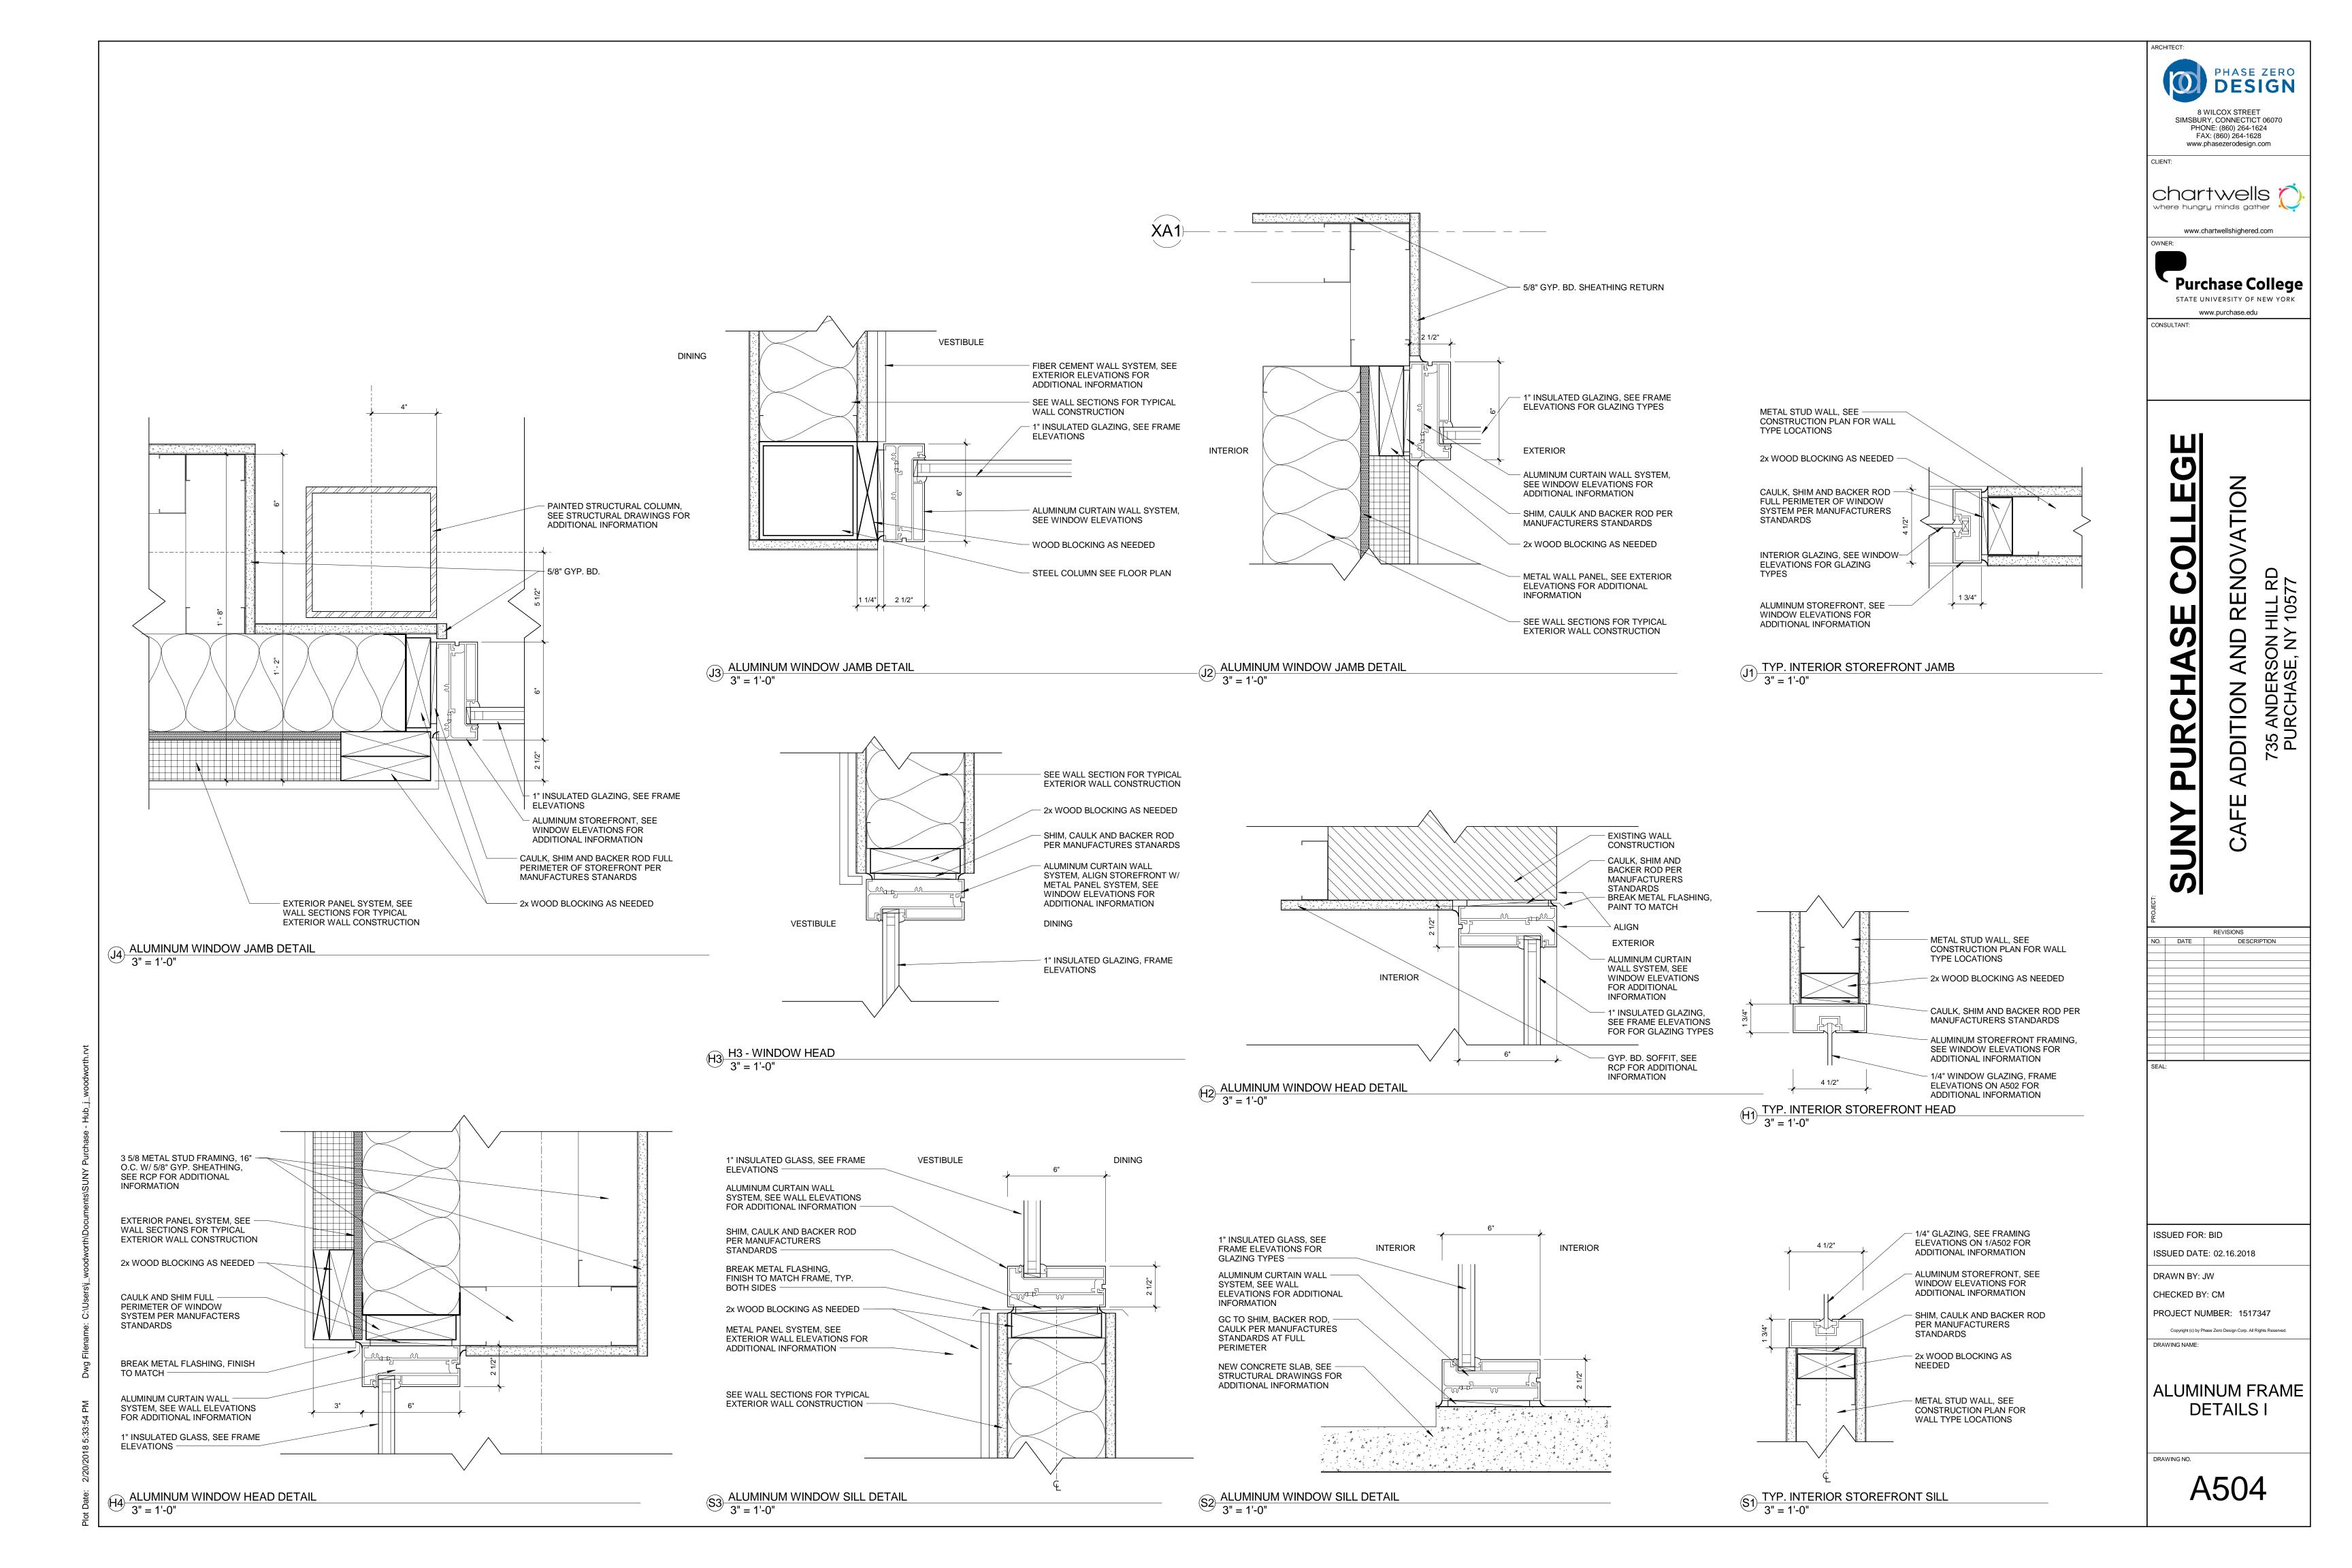
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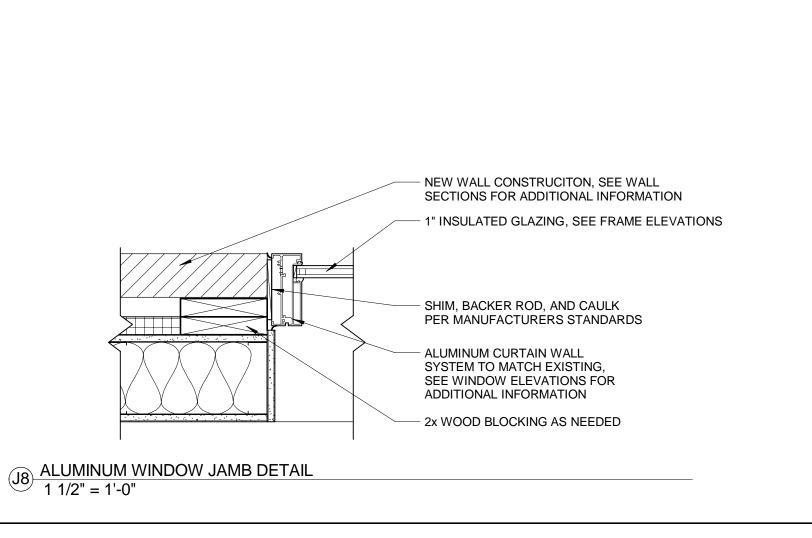
ALUMINUM FRAME ELEVATIONS II

DRAWING NO


A503

2 CURTAIN WALL ELEVATION I 1/2" = 1'-0"





H6 ALUMINUM WINDOW HEAD DETAIL
1 1/2" = 1'-0"

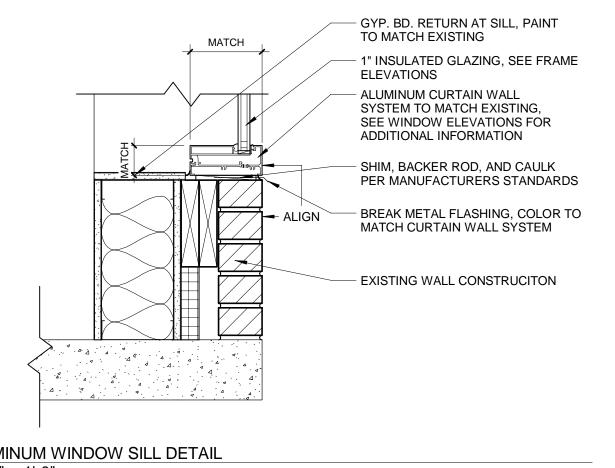

- EXISTING WALL CONSTRUCITON

SHIM, BACKER ROD, AND CAULK

MATCH CURTAIN WALL SYSTEM


— ALUMINUM CURTAIN WALL SYSTEM TO MATCH EXISTING, SEE WINDOW ELEVATIONS FOR ADDITIONAL INFORMATION

1" INSULATED GLAZING, SEE FRAME

**ELEVATIONS** 

PER MANUFACTURERS STANDARDS

BREAK METAL FLASHING, COLOR TO

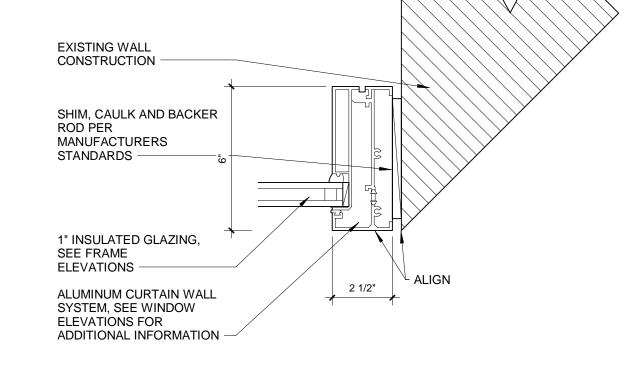

J5 ALUMINUM WINDOW JAMB DETAIL
3" = 1'-0"

2 ALUMINUM WINDOW SILL DETAIL 1 1/2" = 1'-0"

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CONSULTANT:

1" INSULATED GLAZING, SEE FRAME

- ALUMINUM CURTAIN WALL SYSTEM , SEE WINDOW ELEVATIONS FOR ADDITIONAL INFORMATION

BREAK METAL FLASHING, COLOR TO

FIBER CEMENT WALL SYSTEM, SEE EXTERIOR ELEVATIONS

— 2x WOOD BLOCKING AS NEEDED

SHIM, CAULK, AND BACKER ROD

ALUMINUM CURTAIN WALL SYSTEM,
 SEE WINDOW ELEVATIONS FOR
 ADDITIONAL INFORMATION

- 1" INSULATED GLASS, SEE FRAME

5/8" GYP. BD. TO BE PAINTED, SEE INTERIOR ELEVATIONS

PER MANUFACTURERS

STANDARDS

OF WINDOW

**ELEVATIONS** 

SEE WALL SECTIONS FOR TYPICAL EXTERIOR WALL CONSTRUCTION

MATCH CURTAIN WALL SYSTEM SHIM, BACKER ROD, AND CAULK PER MANUFACTURERS STANDARDS NEW CONCRETE FOUNDATION AND SLAB, SEE STRUCTURAL DRAWINGS

**ELEVATIONS** 

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> AND **DDITION**

REVISIONS
NO. DATE DESCRIPTION - 2" X 2" ALUMINUM CORNER FULL HEIGHT

ISSUED FOR: BID ISSUED DATE: 02.16.2018 DRAWN BY: JW

CHECKED BY: CM PROJECT NUMBER: 1517347

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ALUMINUM FRAME **DETAILS II** 

A505

H5 ALUMINUM WINDOW HEAD DETAIL 1/2" = 1'-0"

1 ALUMINUM WINDOW SILL DETAIL
1 1/2" = 1'-0"

- 6" METAL STUD FRAMING 16" O.C.

- SHIM, BACKER ROD, AND CAULK PER MANUFACTURERS STANDARDS

- METAL SOFFIT TO MATCH EXTERIOR,

- ALUMINUM CURTAIN WALL SYSTEM, SEE WINDOW ELEVATIONS FOR


1" INSULATED GLAZING, SEE FRAME


- 5/8" PLYWOOD SHEATHING.

ADDITIONAL INFORMATION

SEE RCP

**ELEVATIONS** 

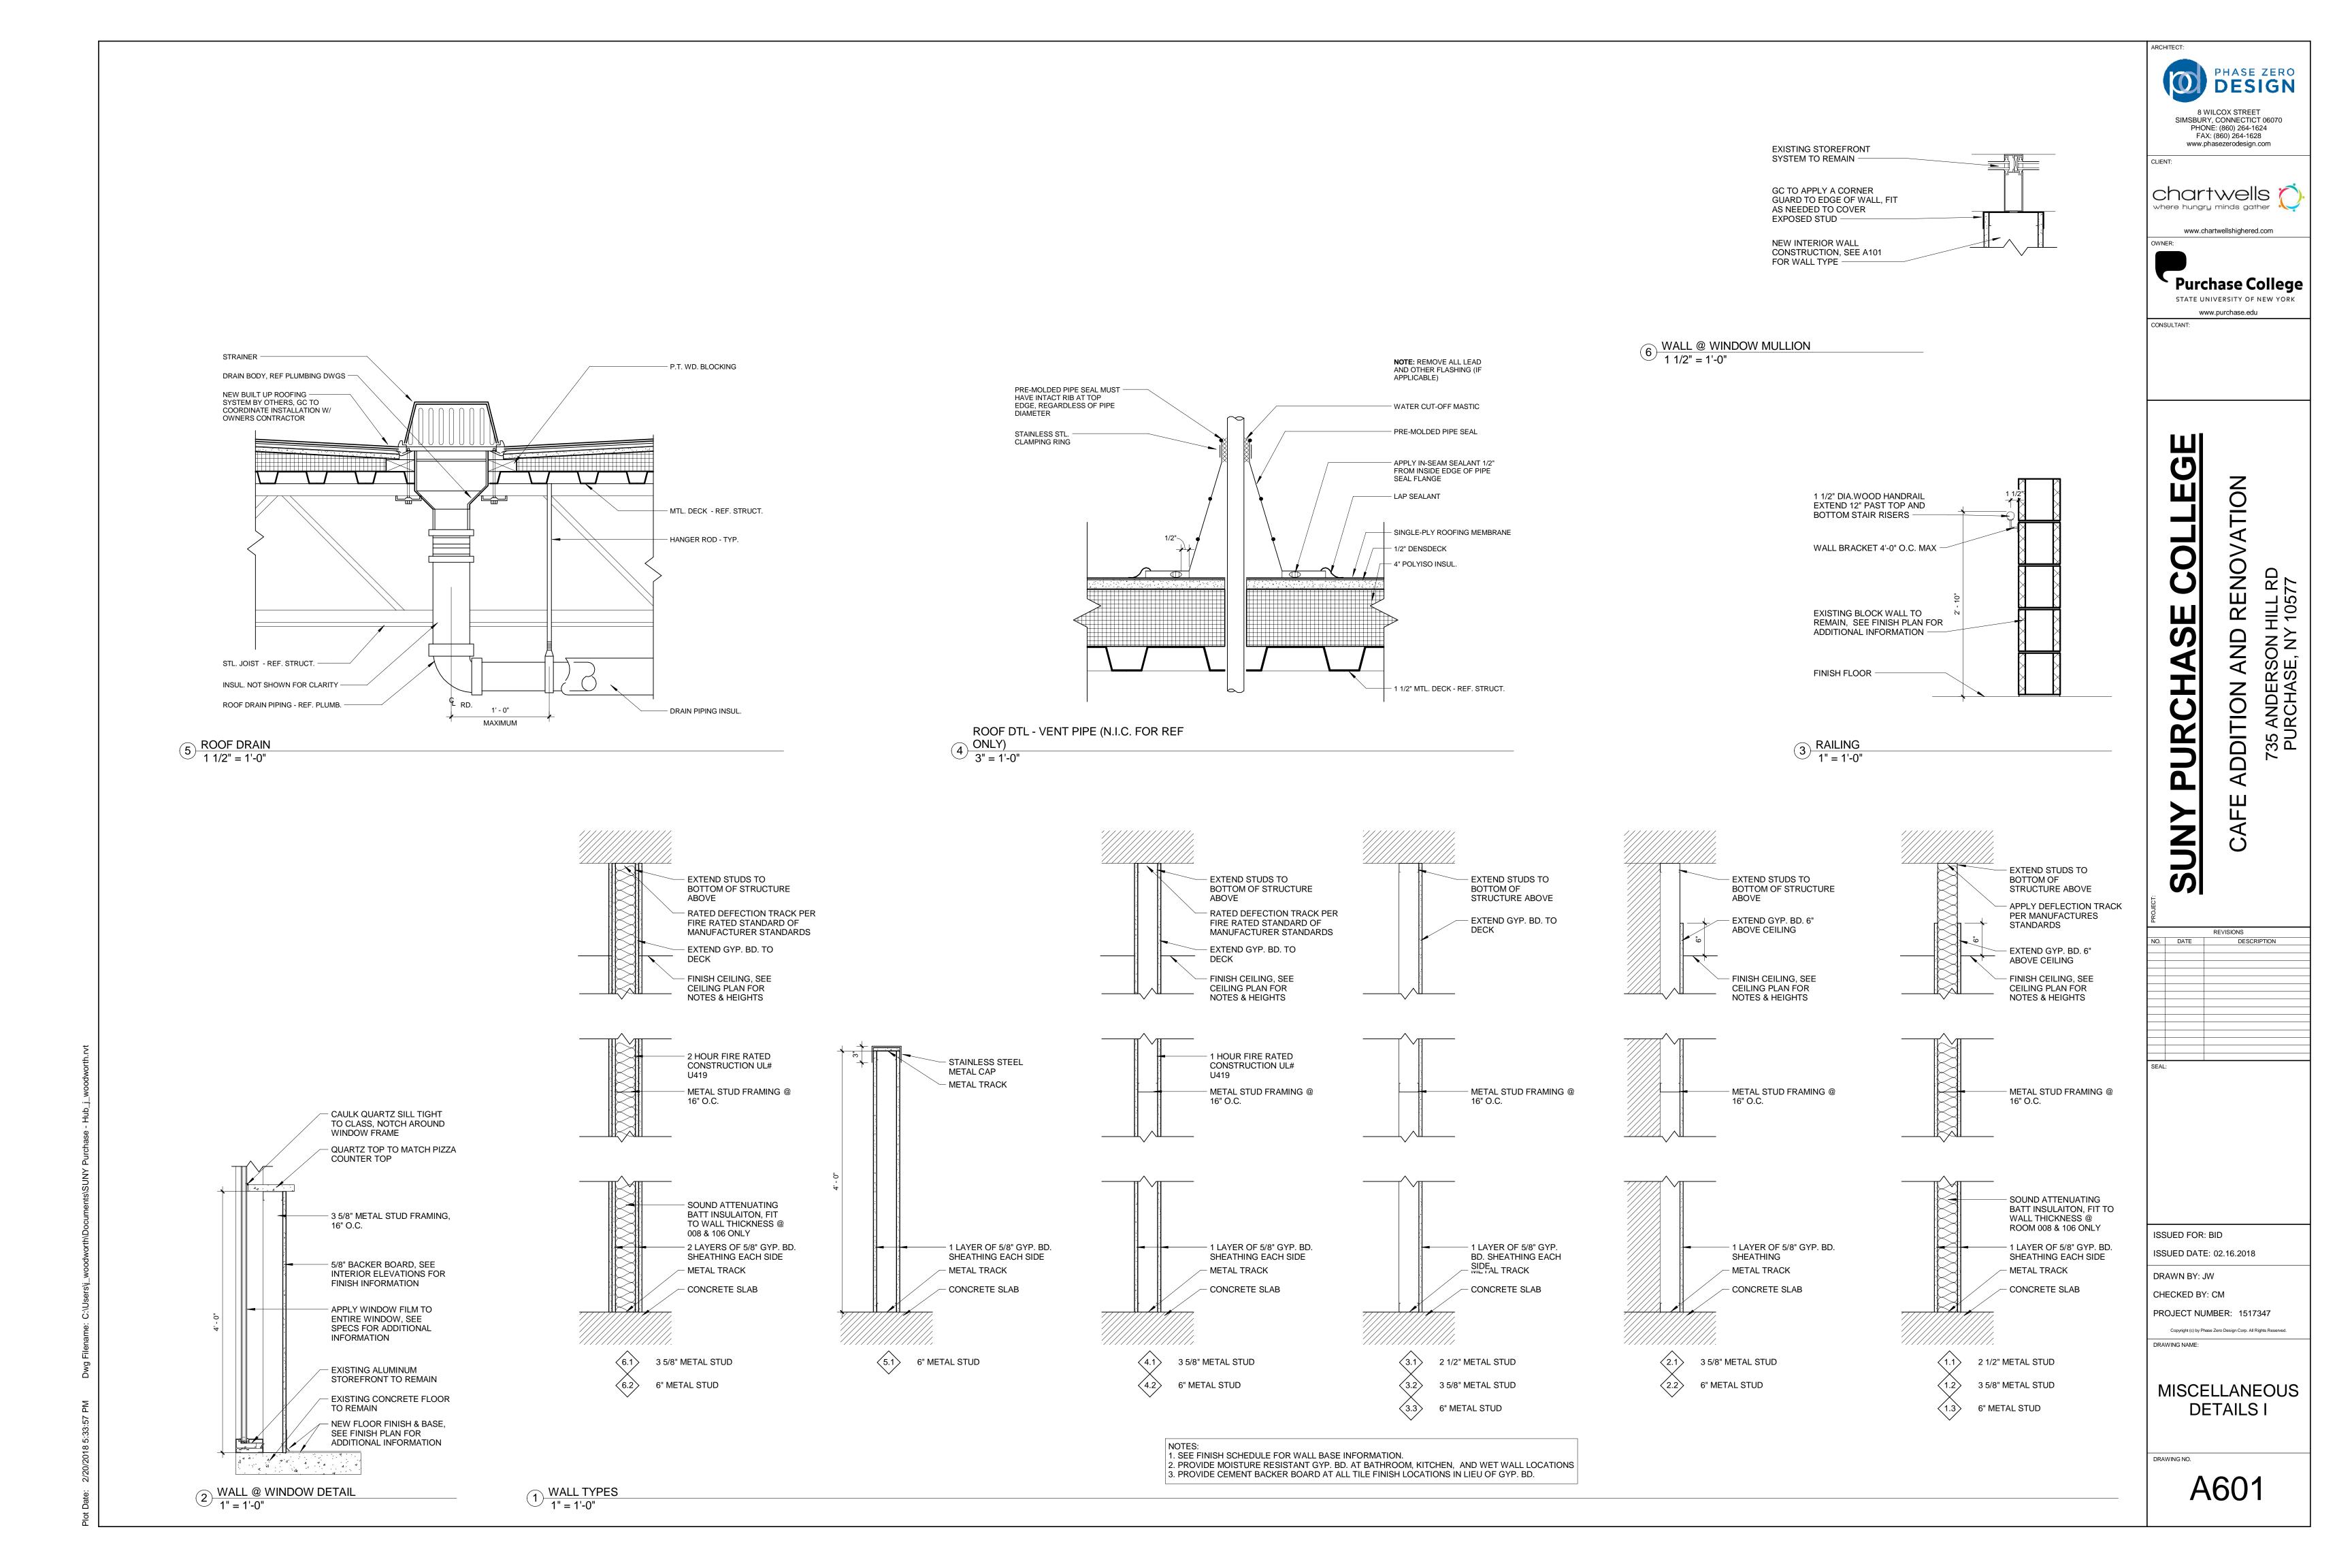

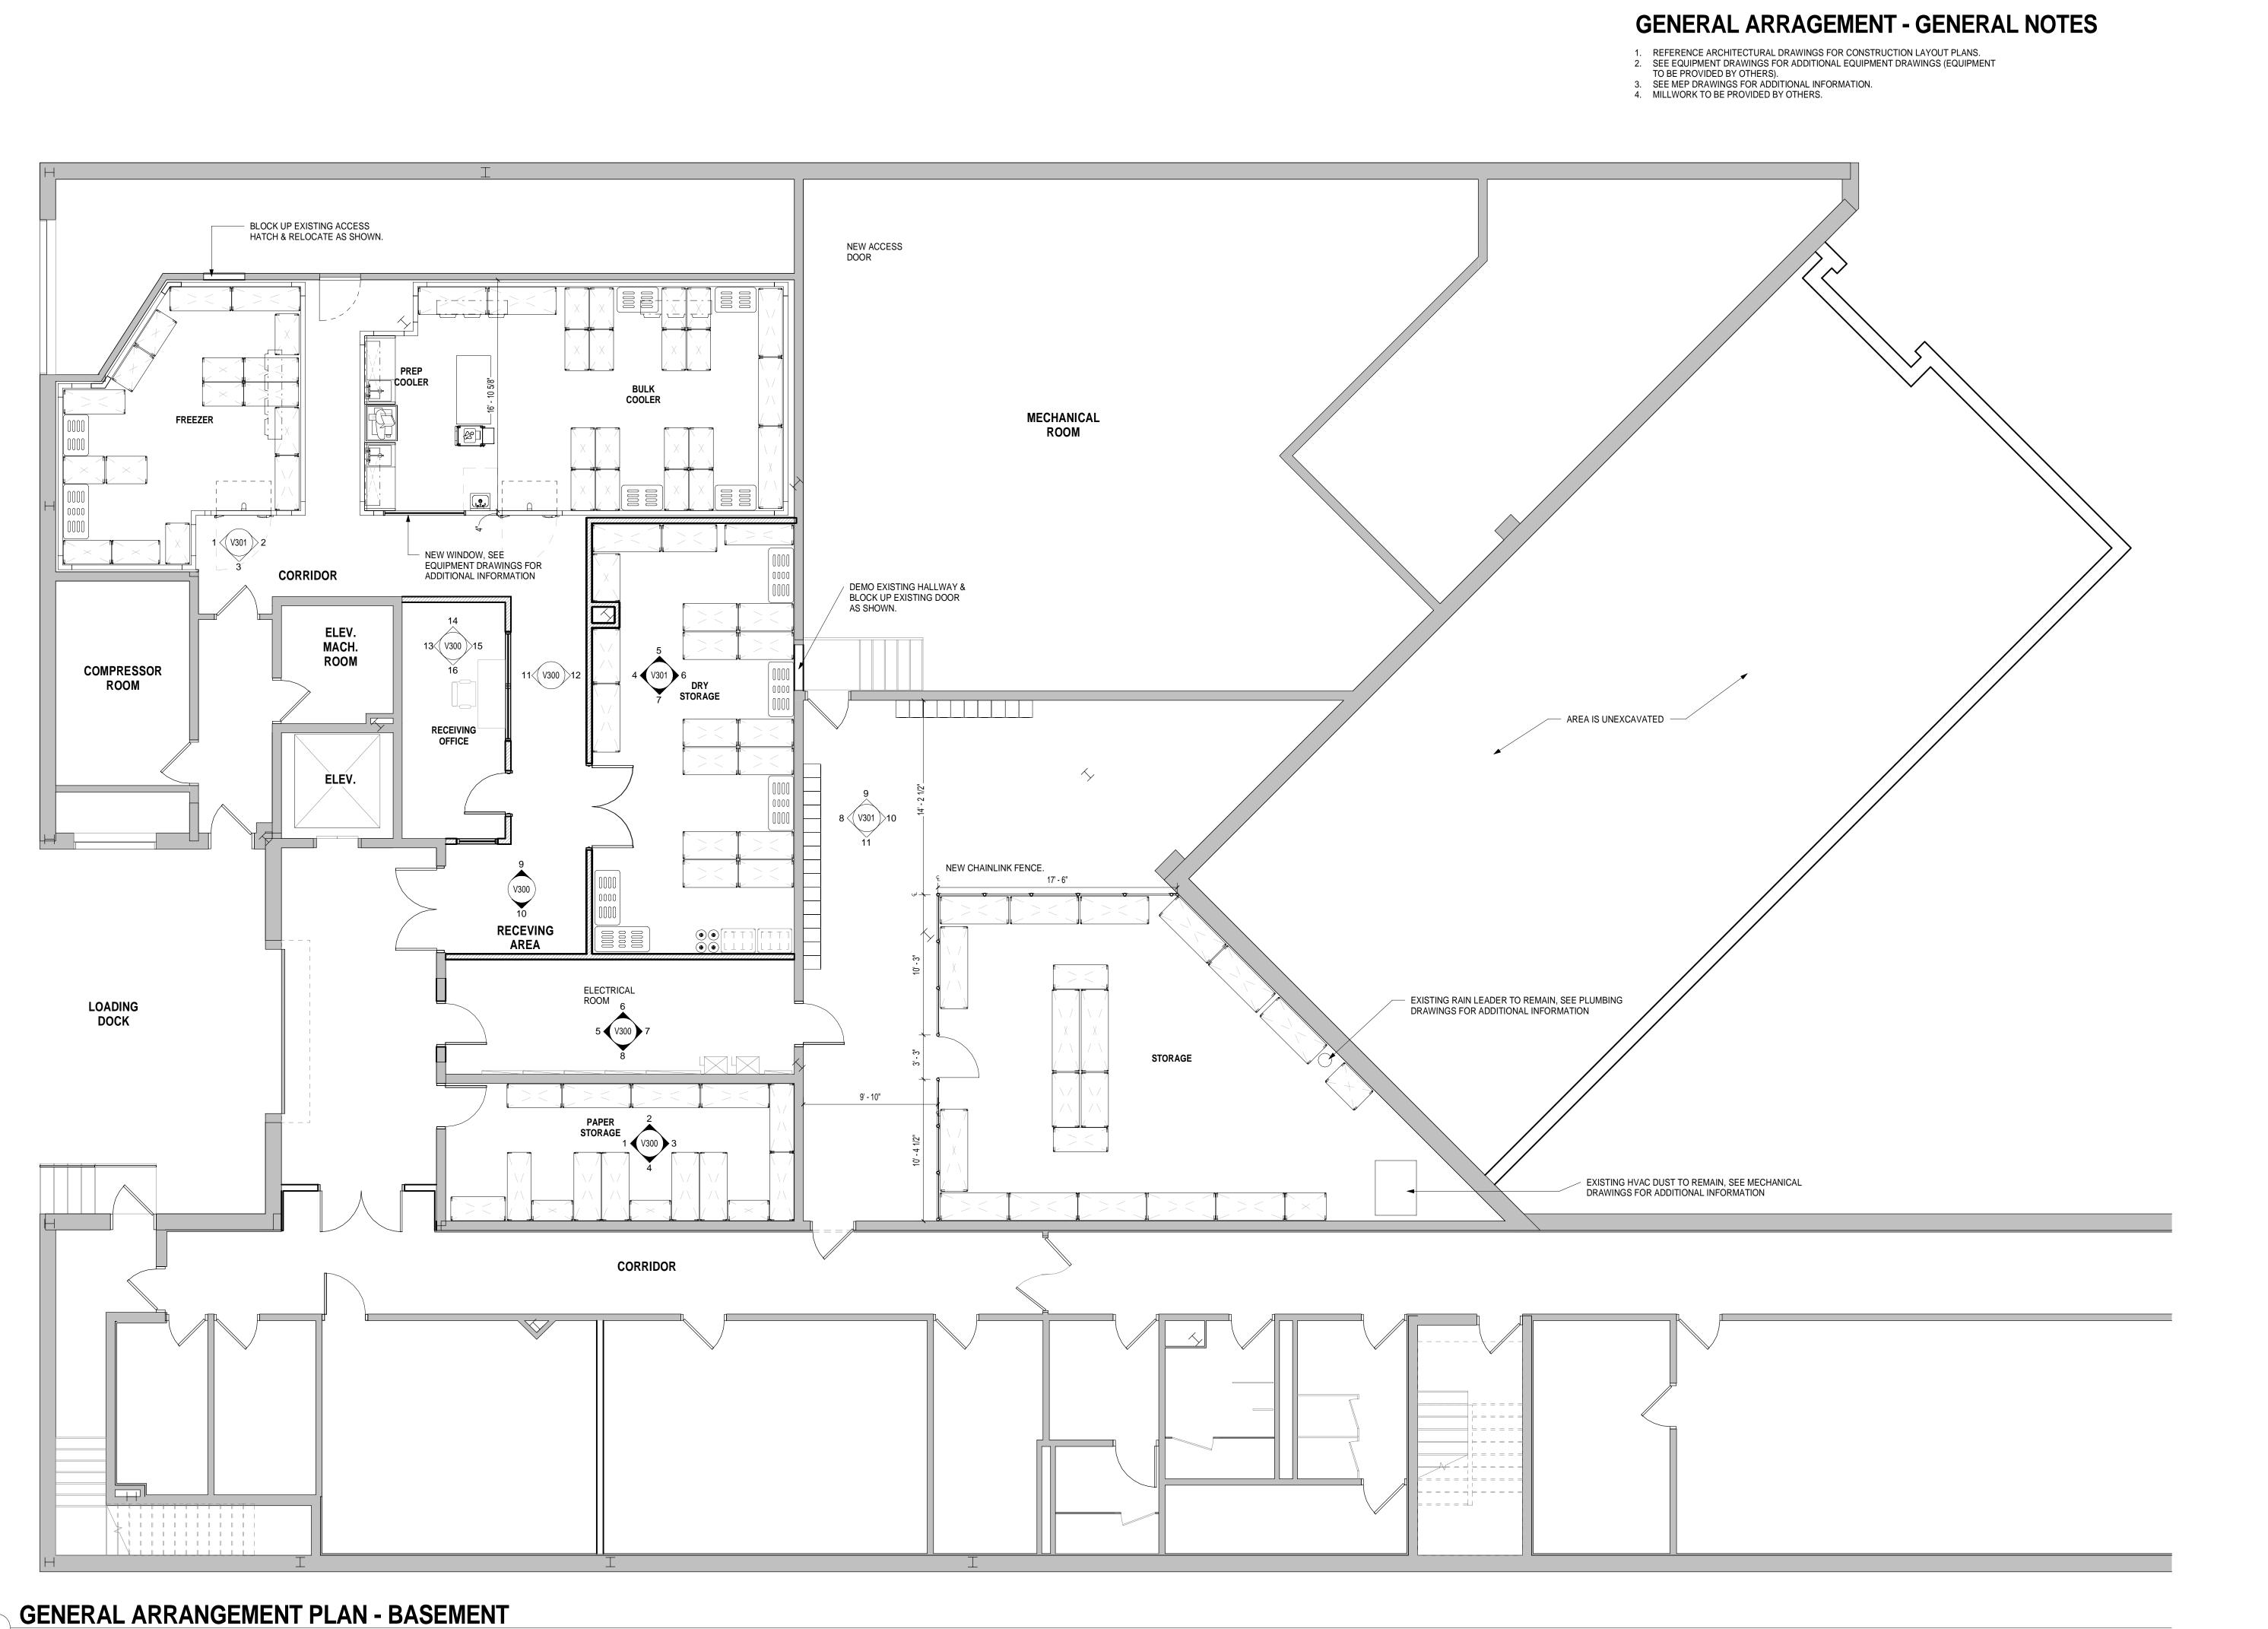

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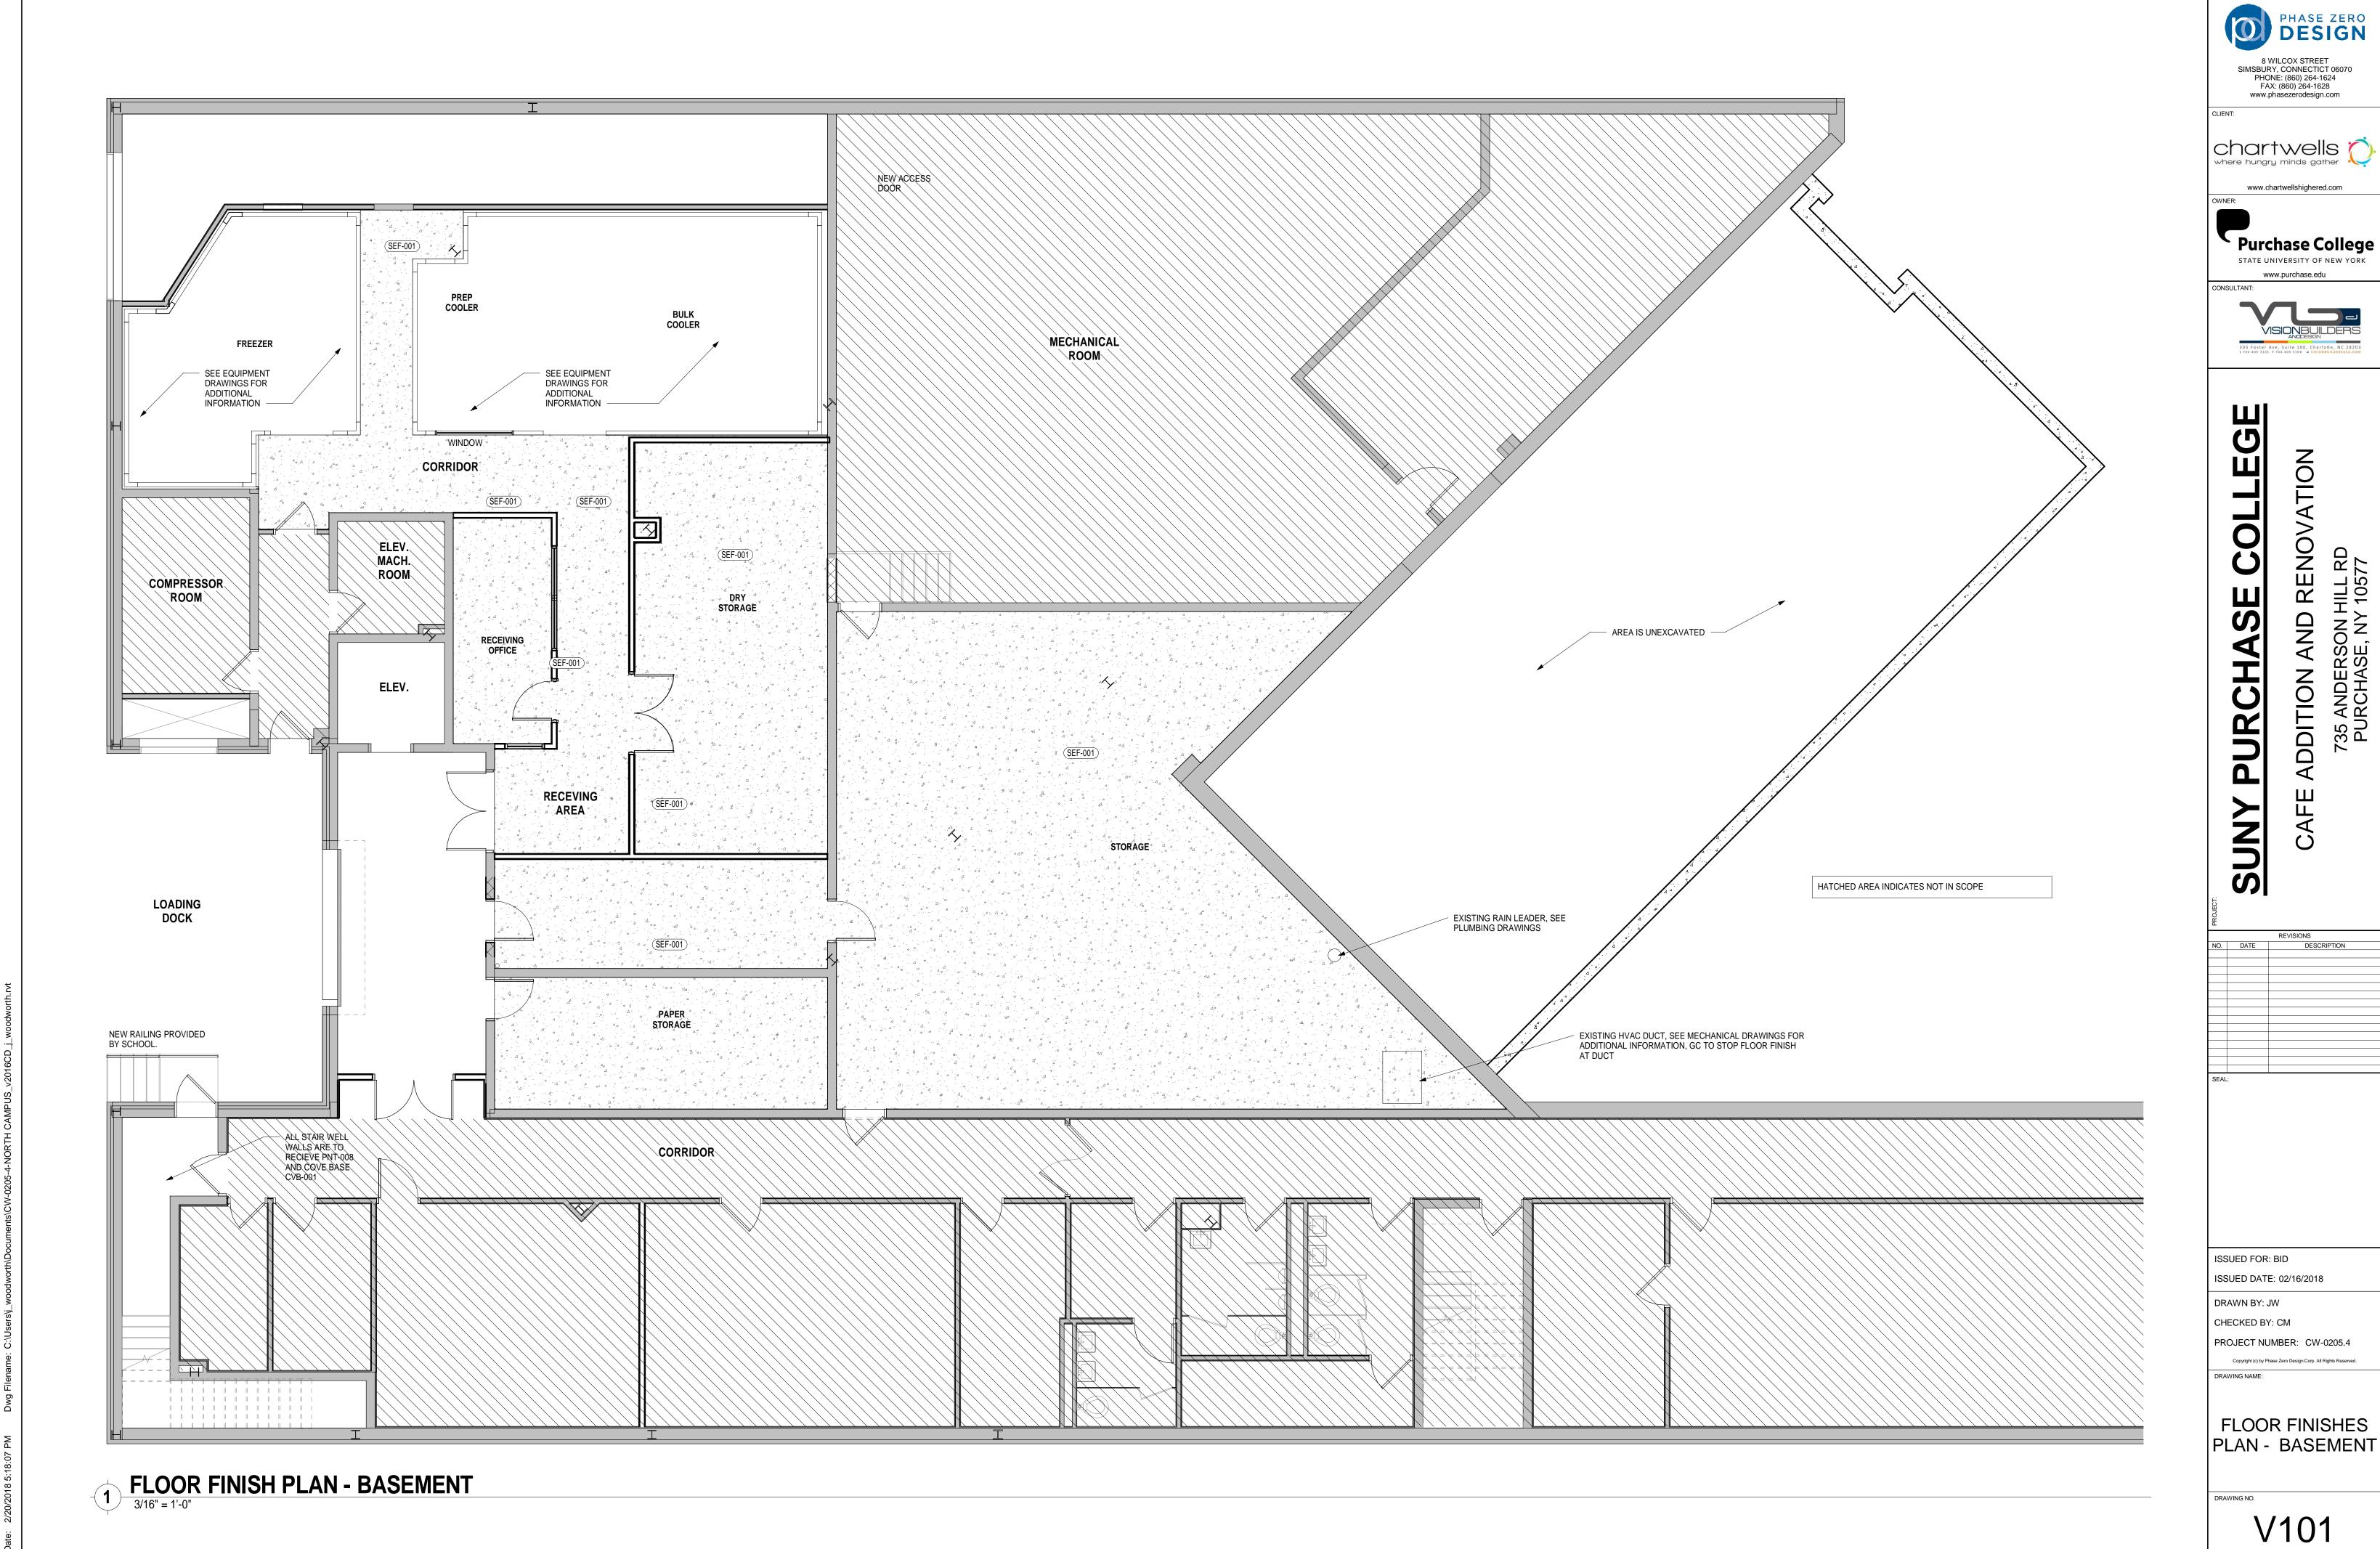
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ISSUED FOR: BID ISSUED DATE: 02/16/2018


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GENERAL ARRANGEMENT PLAN - BASEMENT



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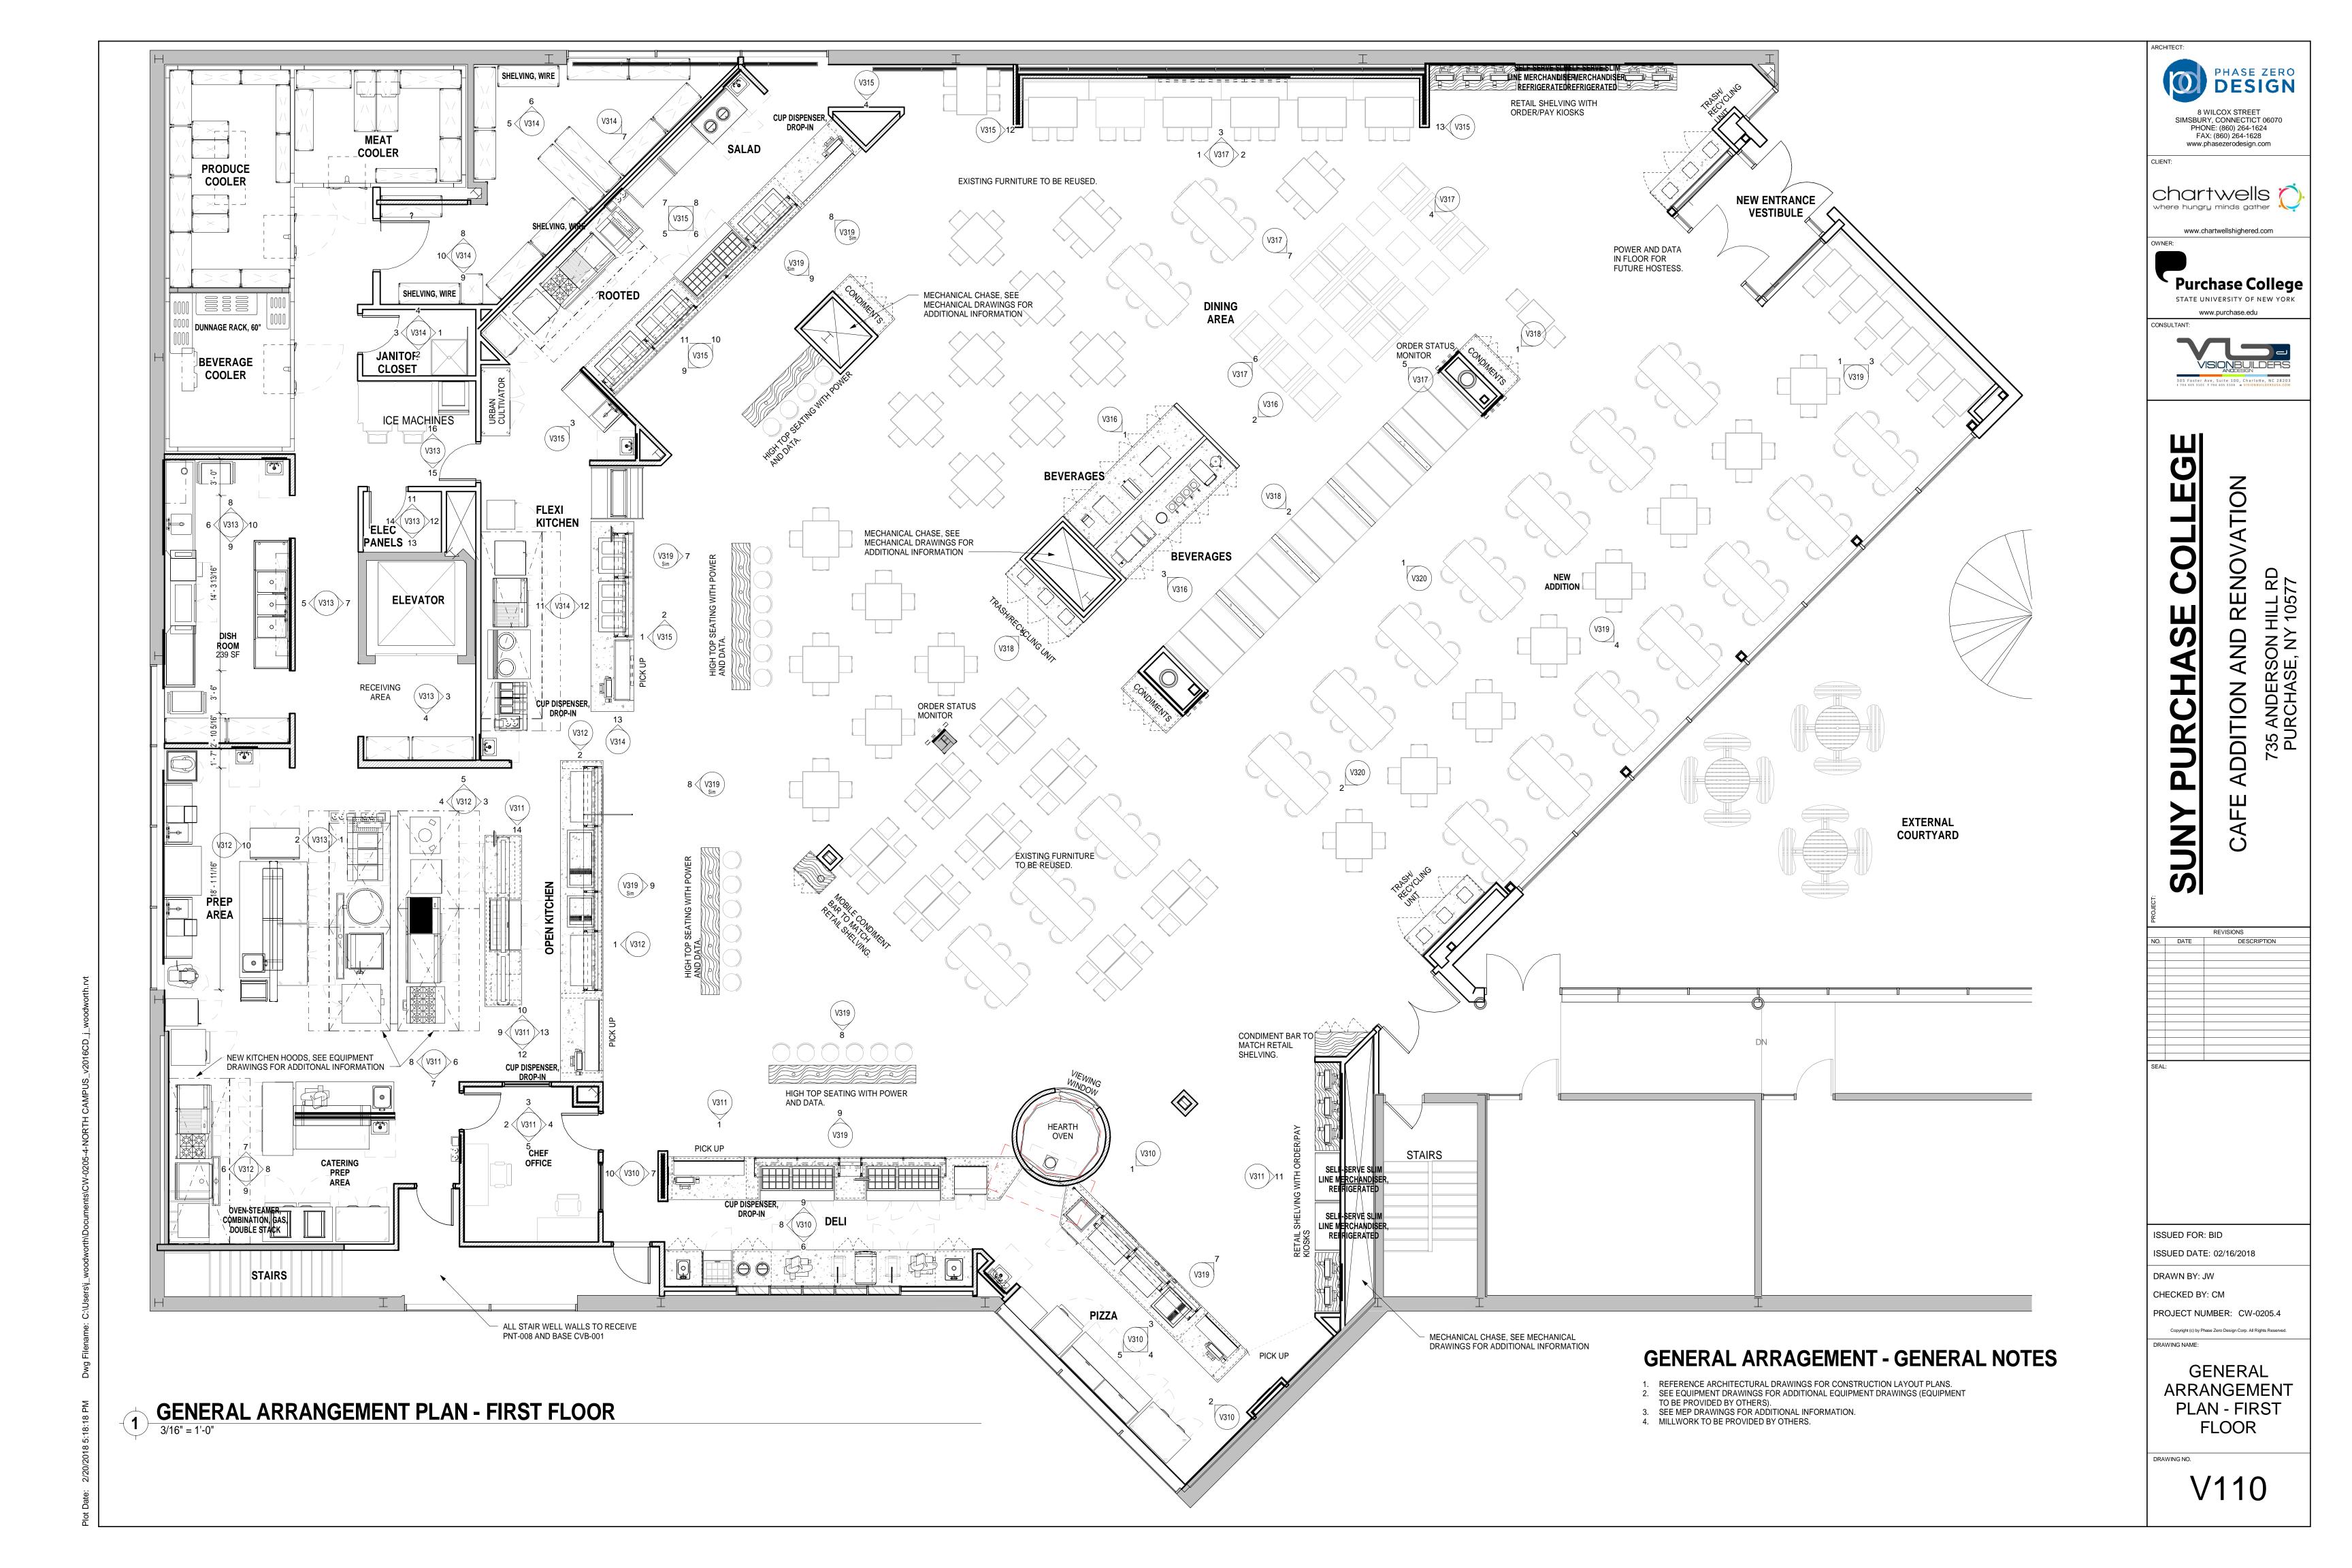
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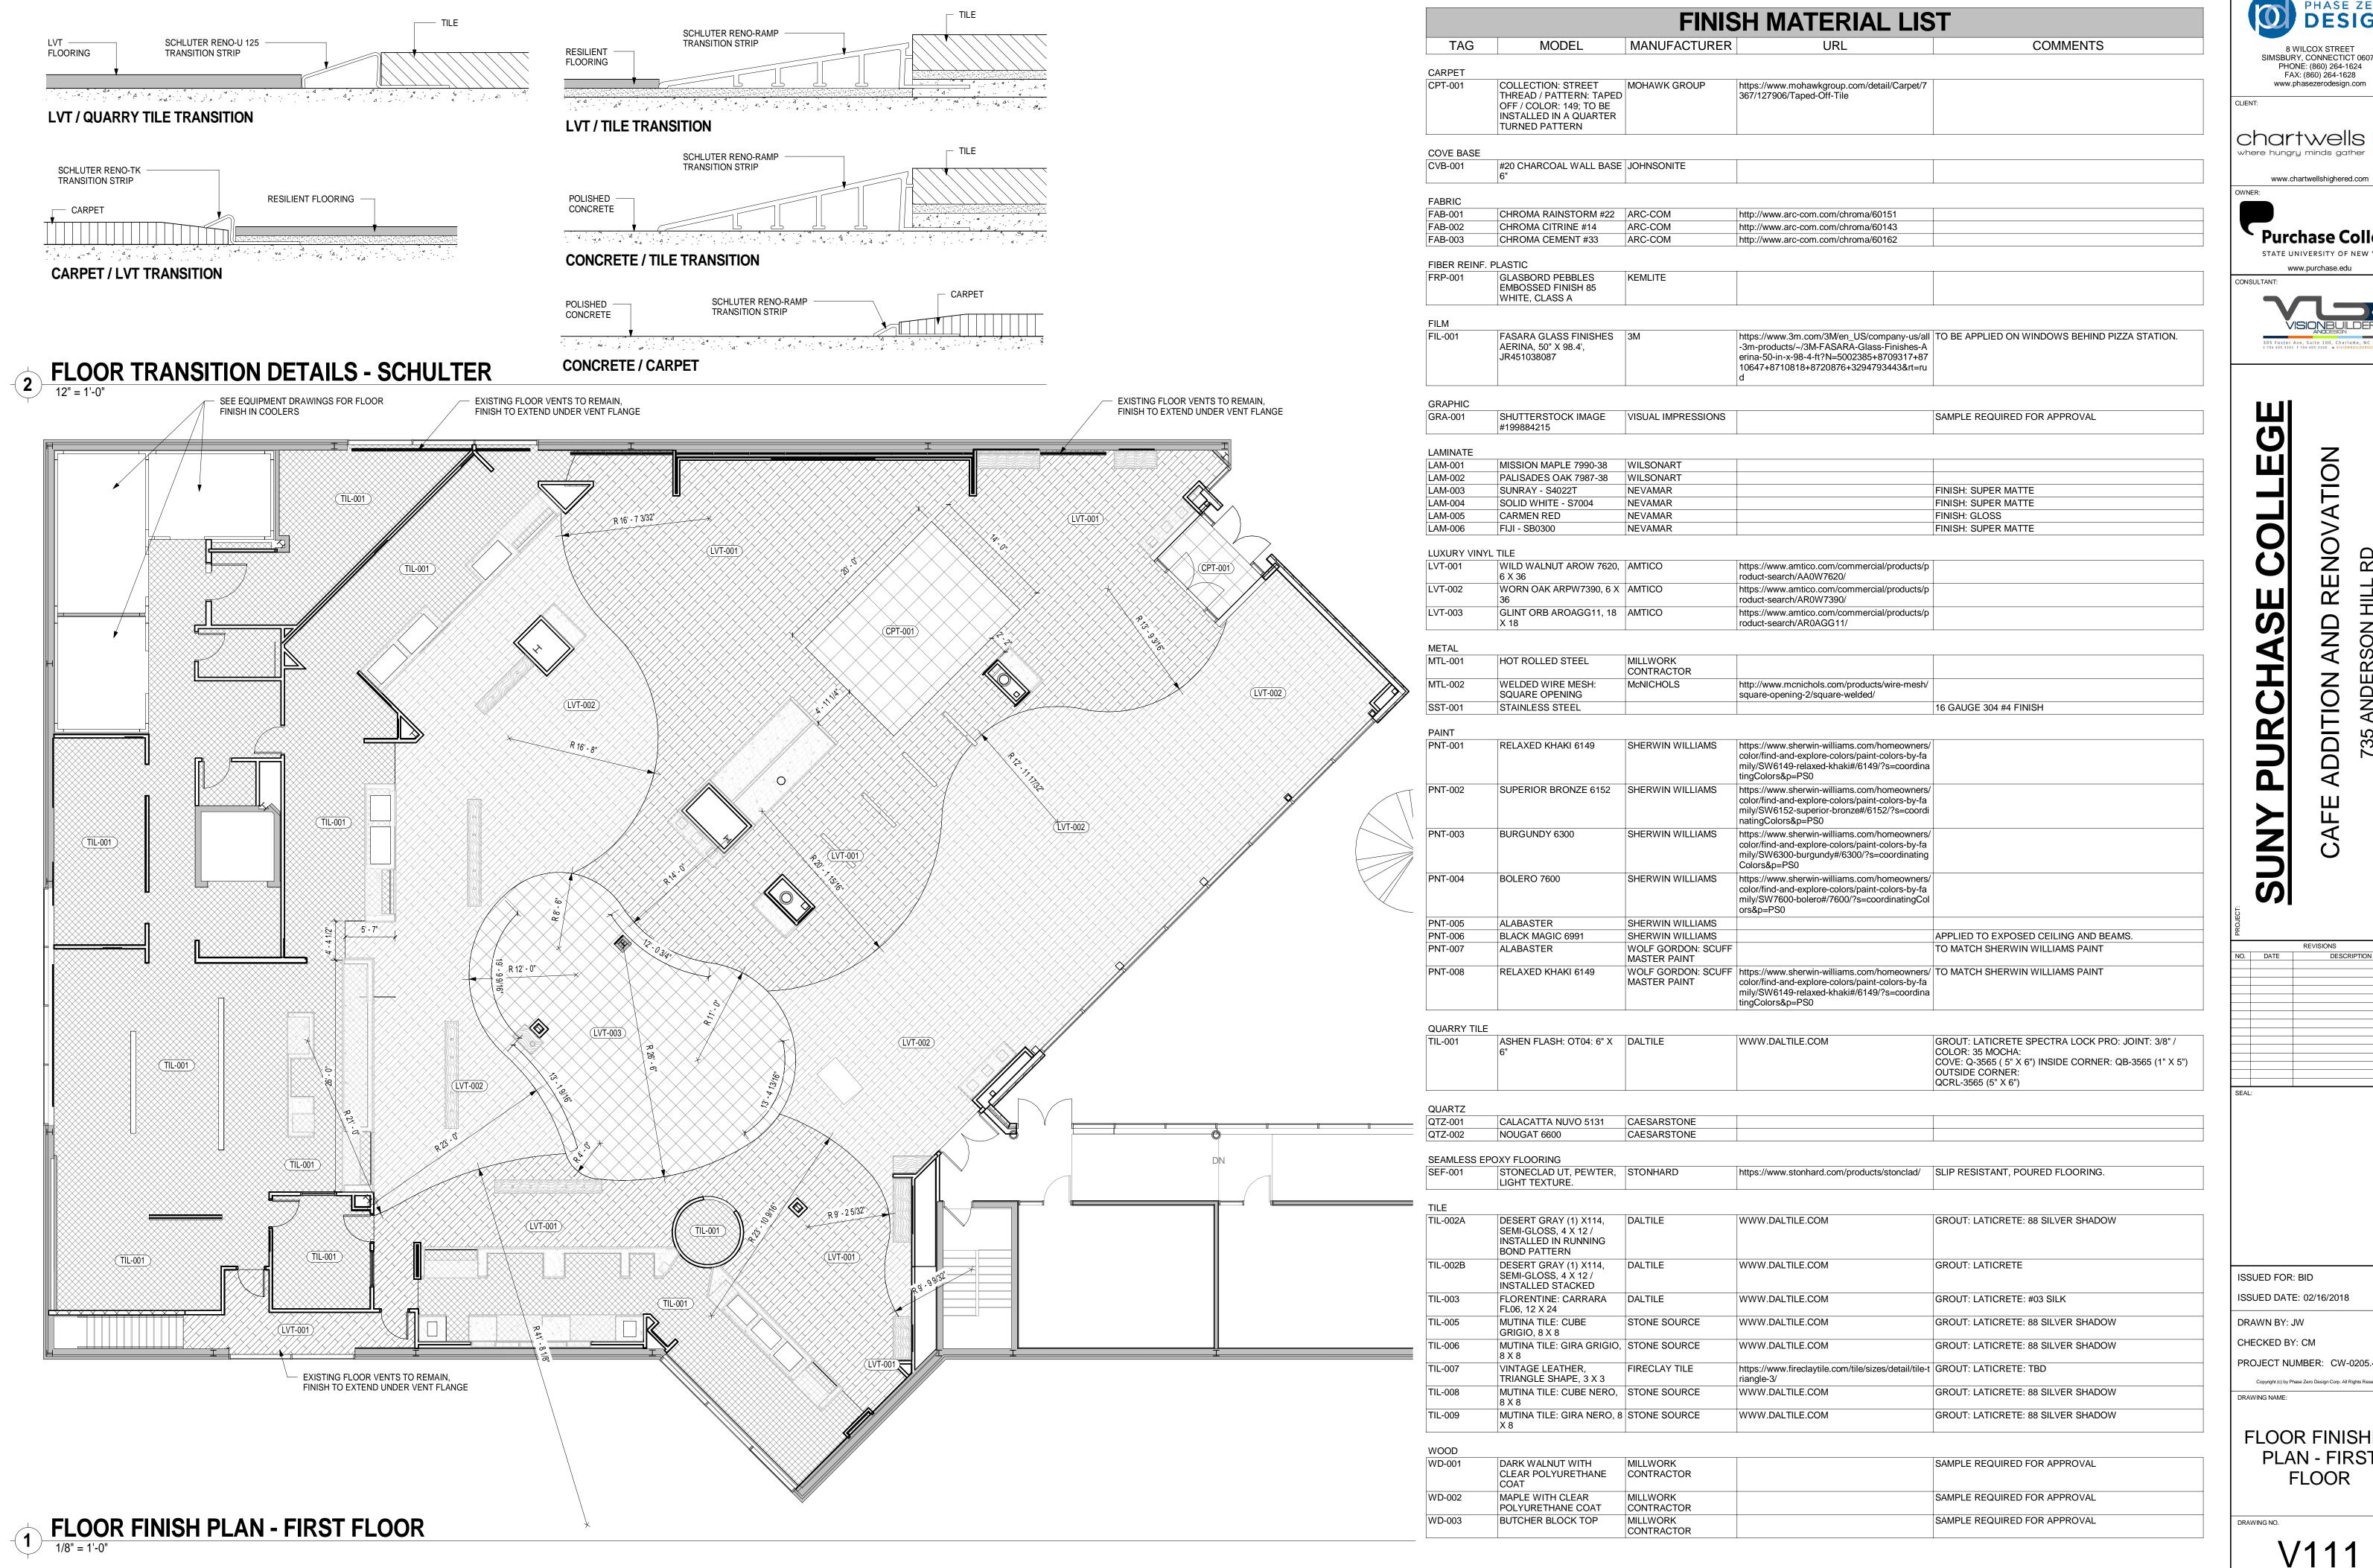
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REFLECTED **CEILING PLAN -BASEMENT** 



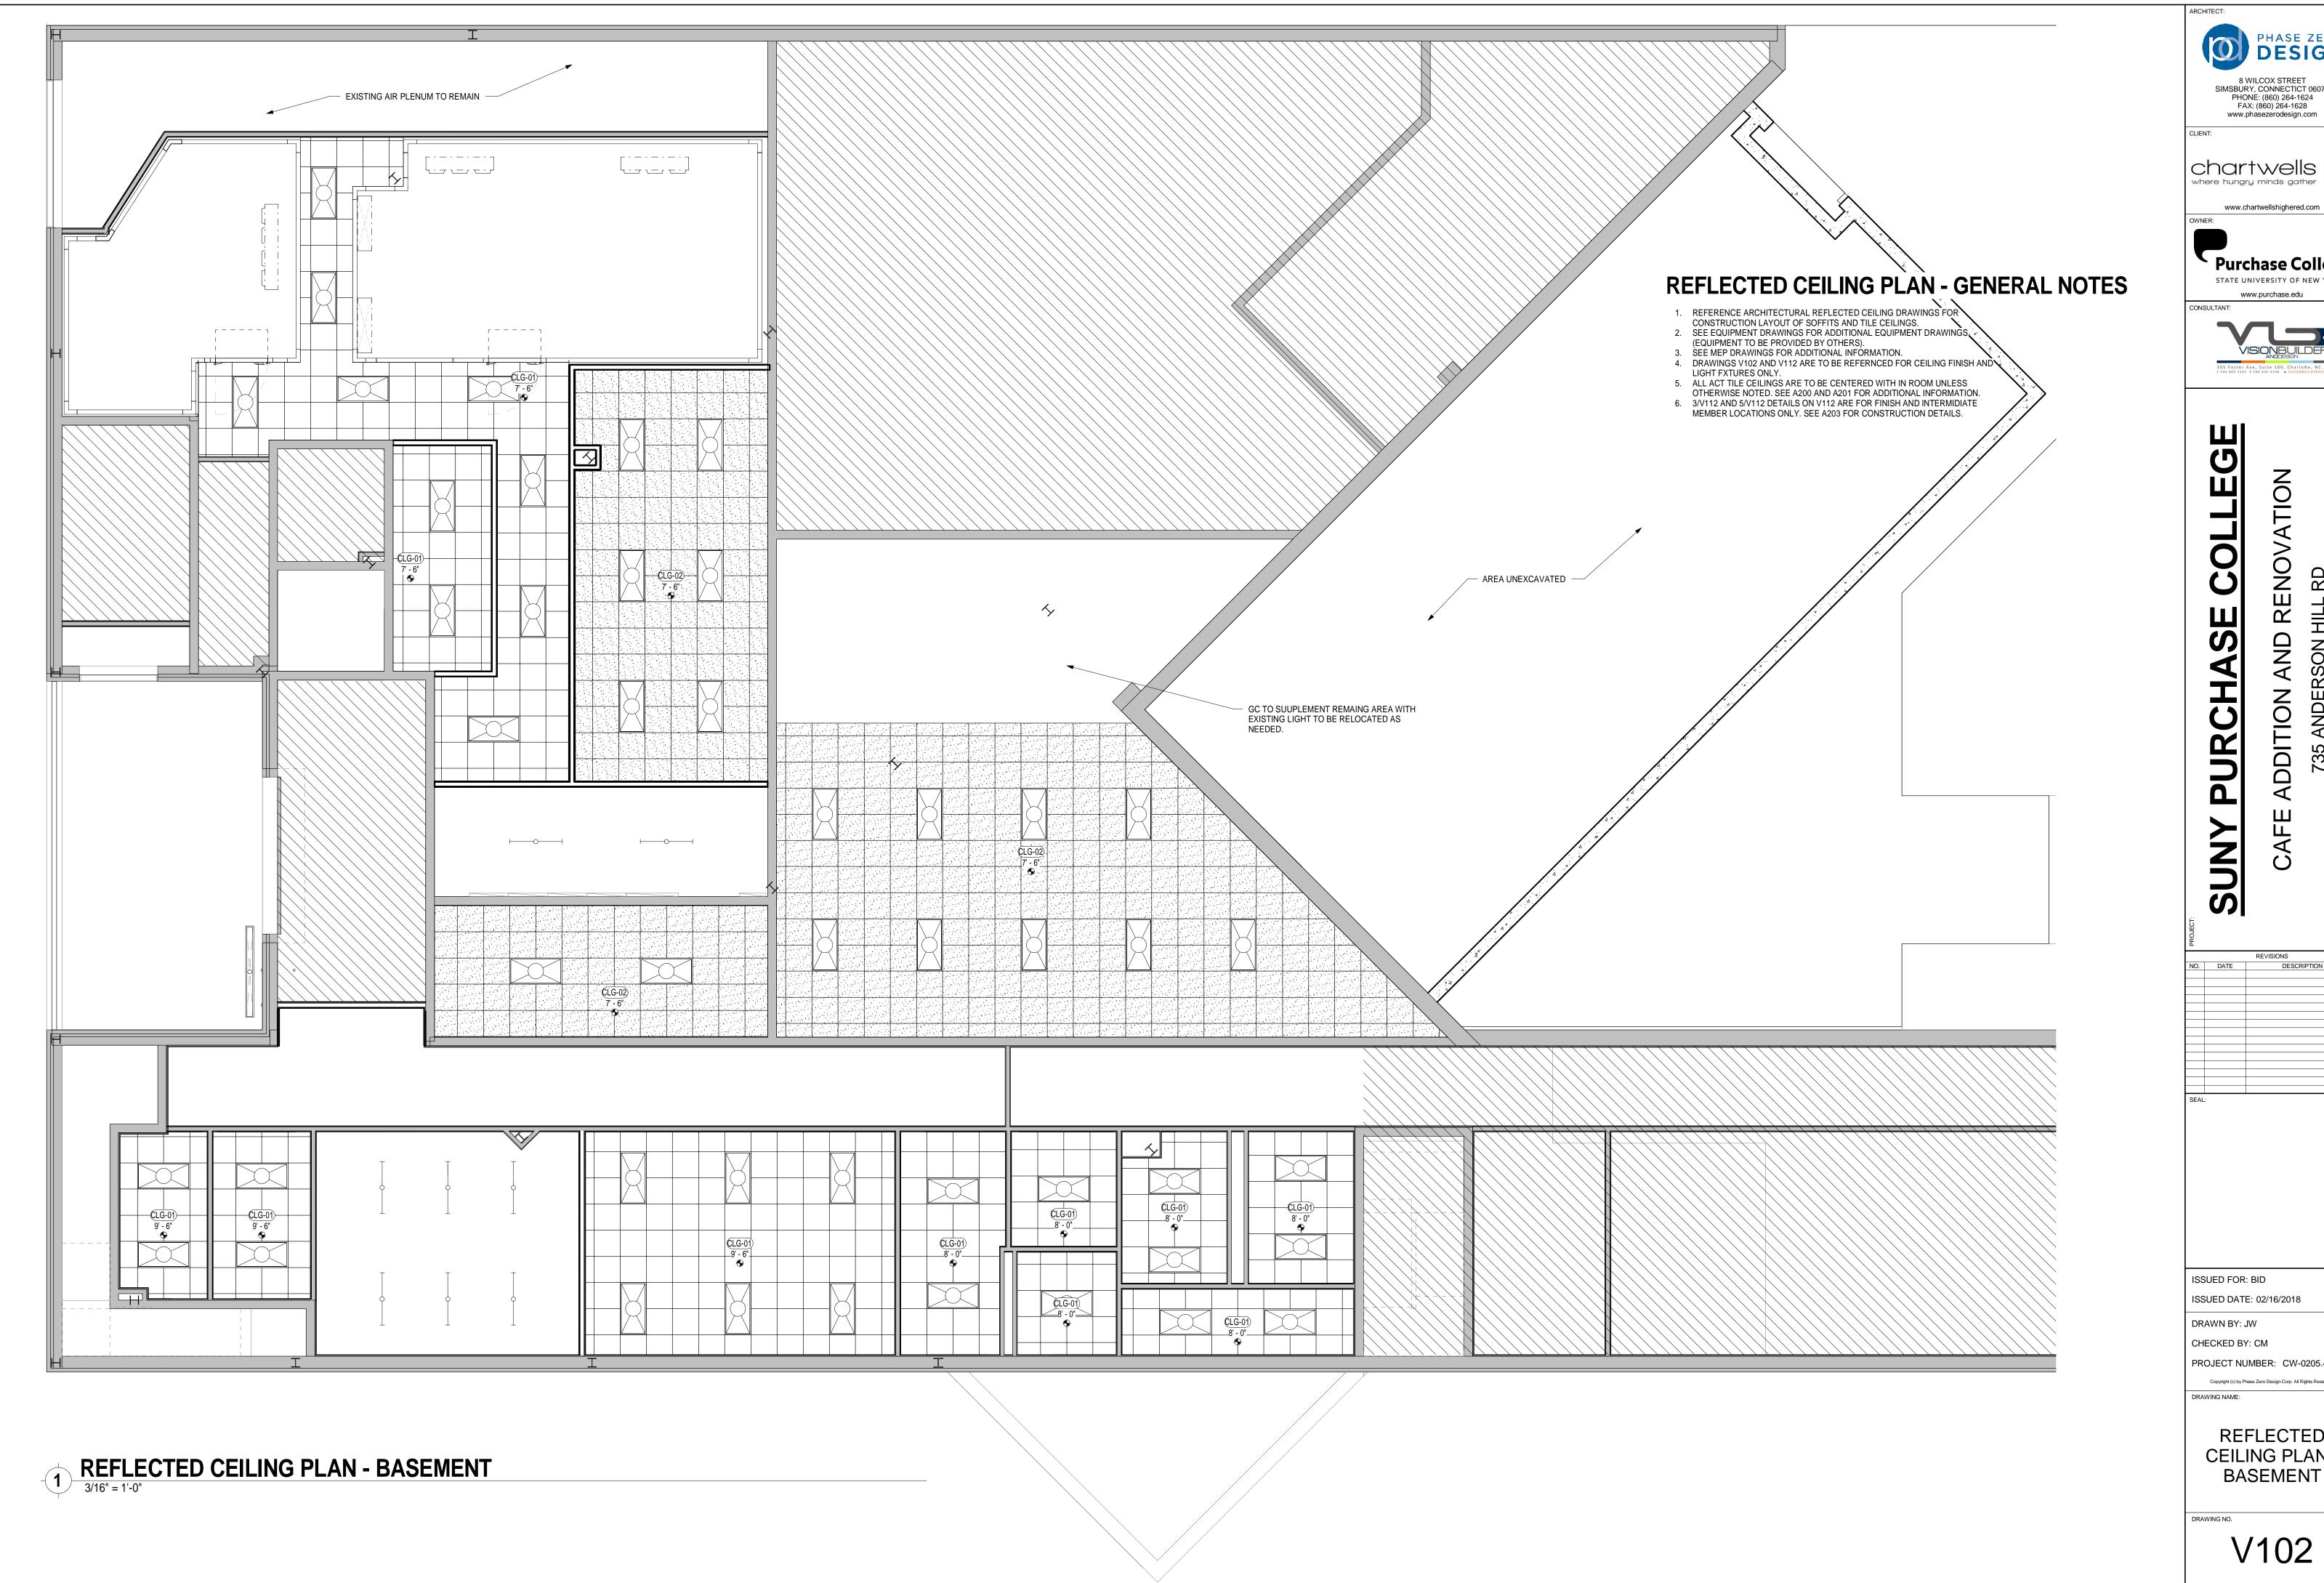

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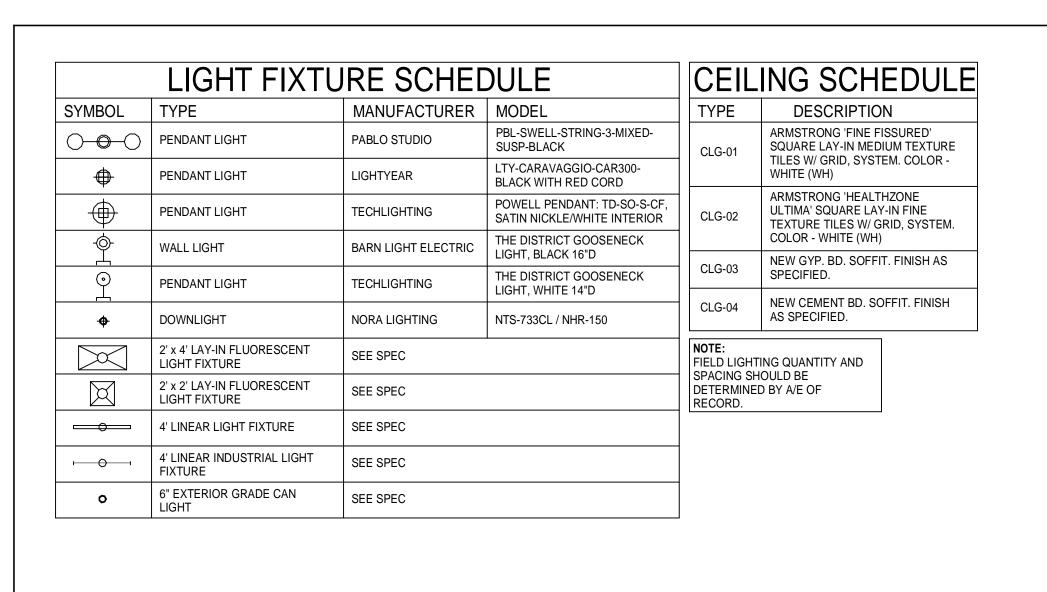
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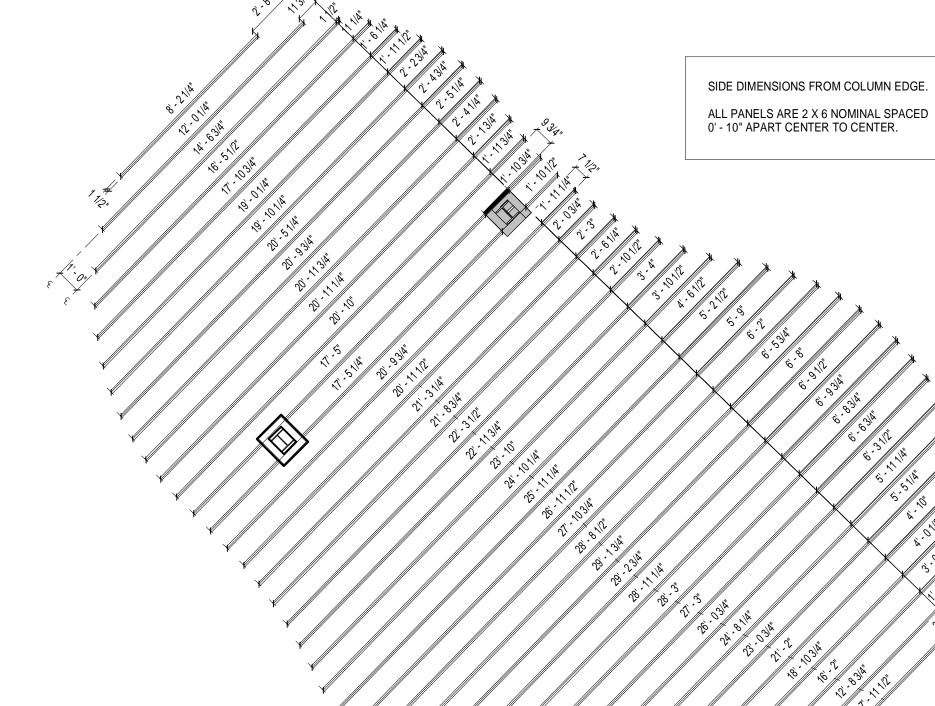
FLOOR FINISHES PLAN - FIRST




# **REFLECTED CEILING PLAN - GENERAL NOTES**

- REFERENCE ARCHITECTURAL REFLECTED CEILING DRAWINGS FOR CONSTRUCTION LAYOUT OF SOFFITS AND TILE CEILINGS.
   SEE EQUIPMENT DRAWINGS FOR ADDITIONAL EQUIPMENT DRAWINGS
- (EQUIPMENT TO BE PROVIDED BY OTHERS).

  3. SEE MEP DRAWINGS FOR ADDITIONAL INFORMATION.
- 4. DRAWINGS V102 AND V112 ARE TO BE REFERNCED FOR CEILING FINISH AND
- LIGHT FXTURES ONLY. 5. ALL ACT TILE CEILINGS ARE TO BE CENTERED WITH IN ROOM UNLESS
- OTHERWISE NOTED. SEE A200 AND A201 FOR ADDITIONAL INFORMATION.
- 6. 3/V112 AND 5/V112 DETAILS ON V112 ARE FOR FINISH AND INTERMIDIATE MEMBER LOCATIONS ONLY. SEE A203 FOR CONSTRUCTION DETAILS.



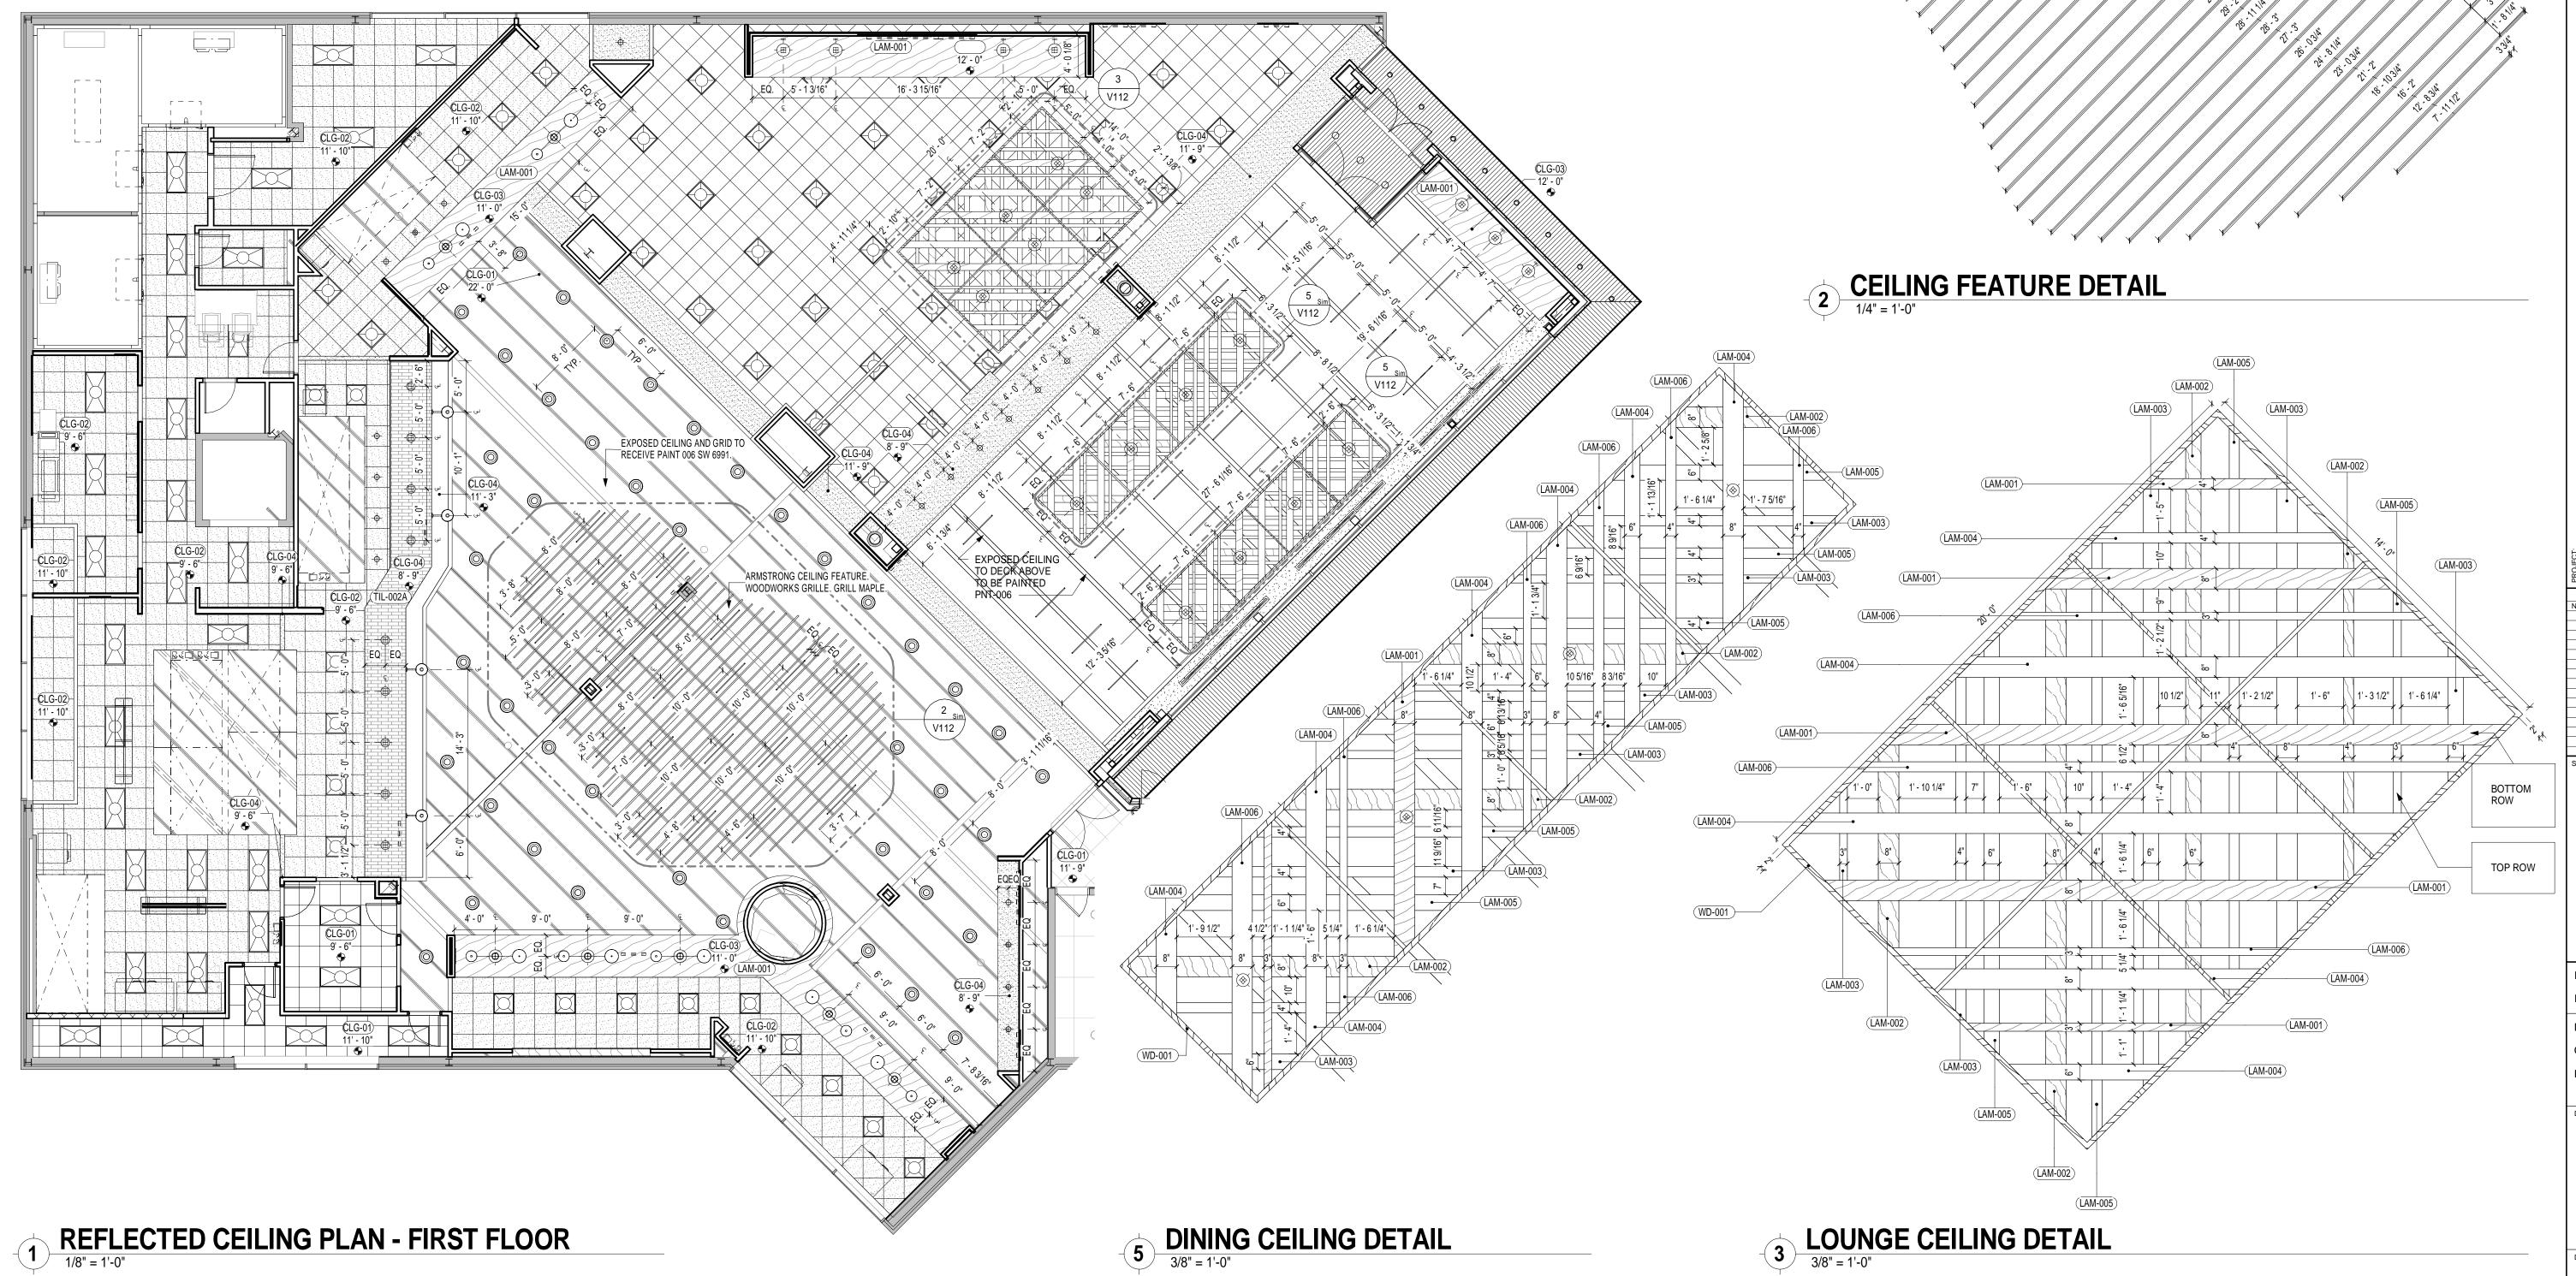

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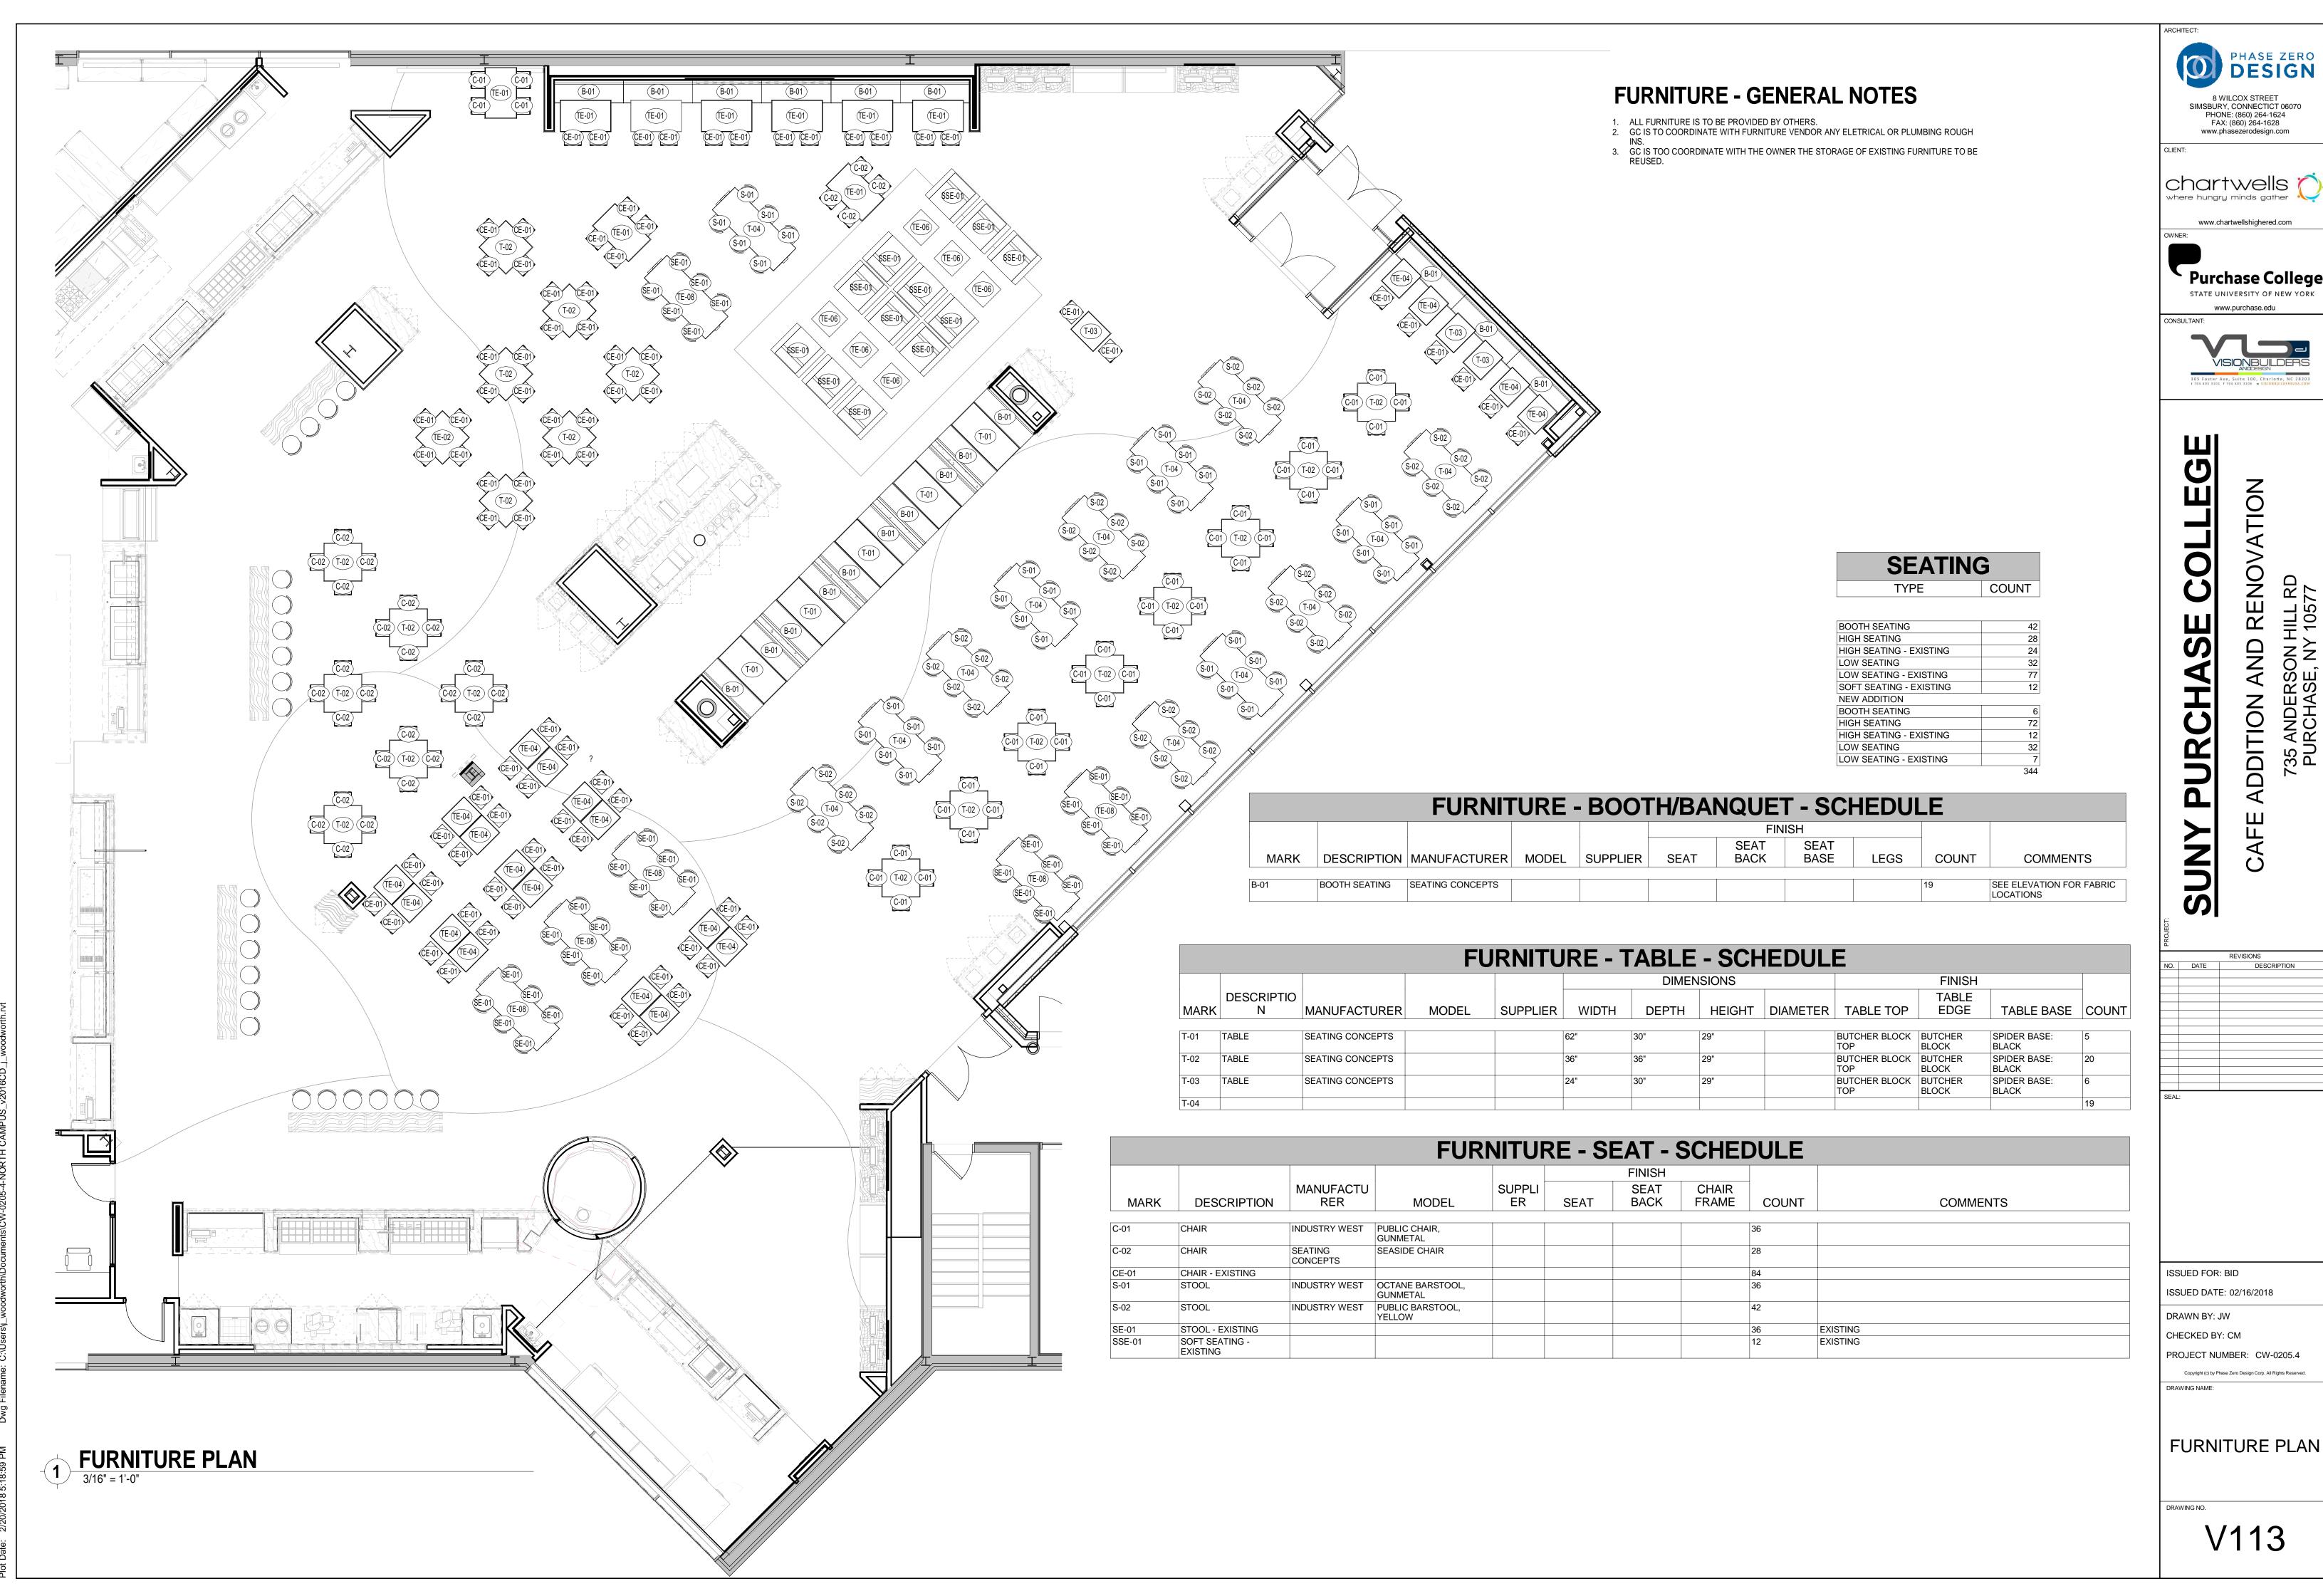
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ISSUED DATE: 02/16/2018 DRAWN BY: JW


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REFLECTED CEILING PLAN -FIRST FLOOR



DESIGN

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RENOVATION

**ADDITION** 

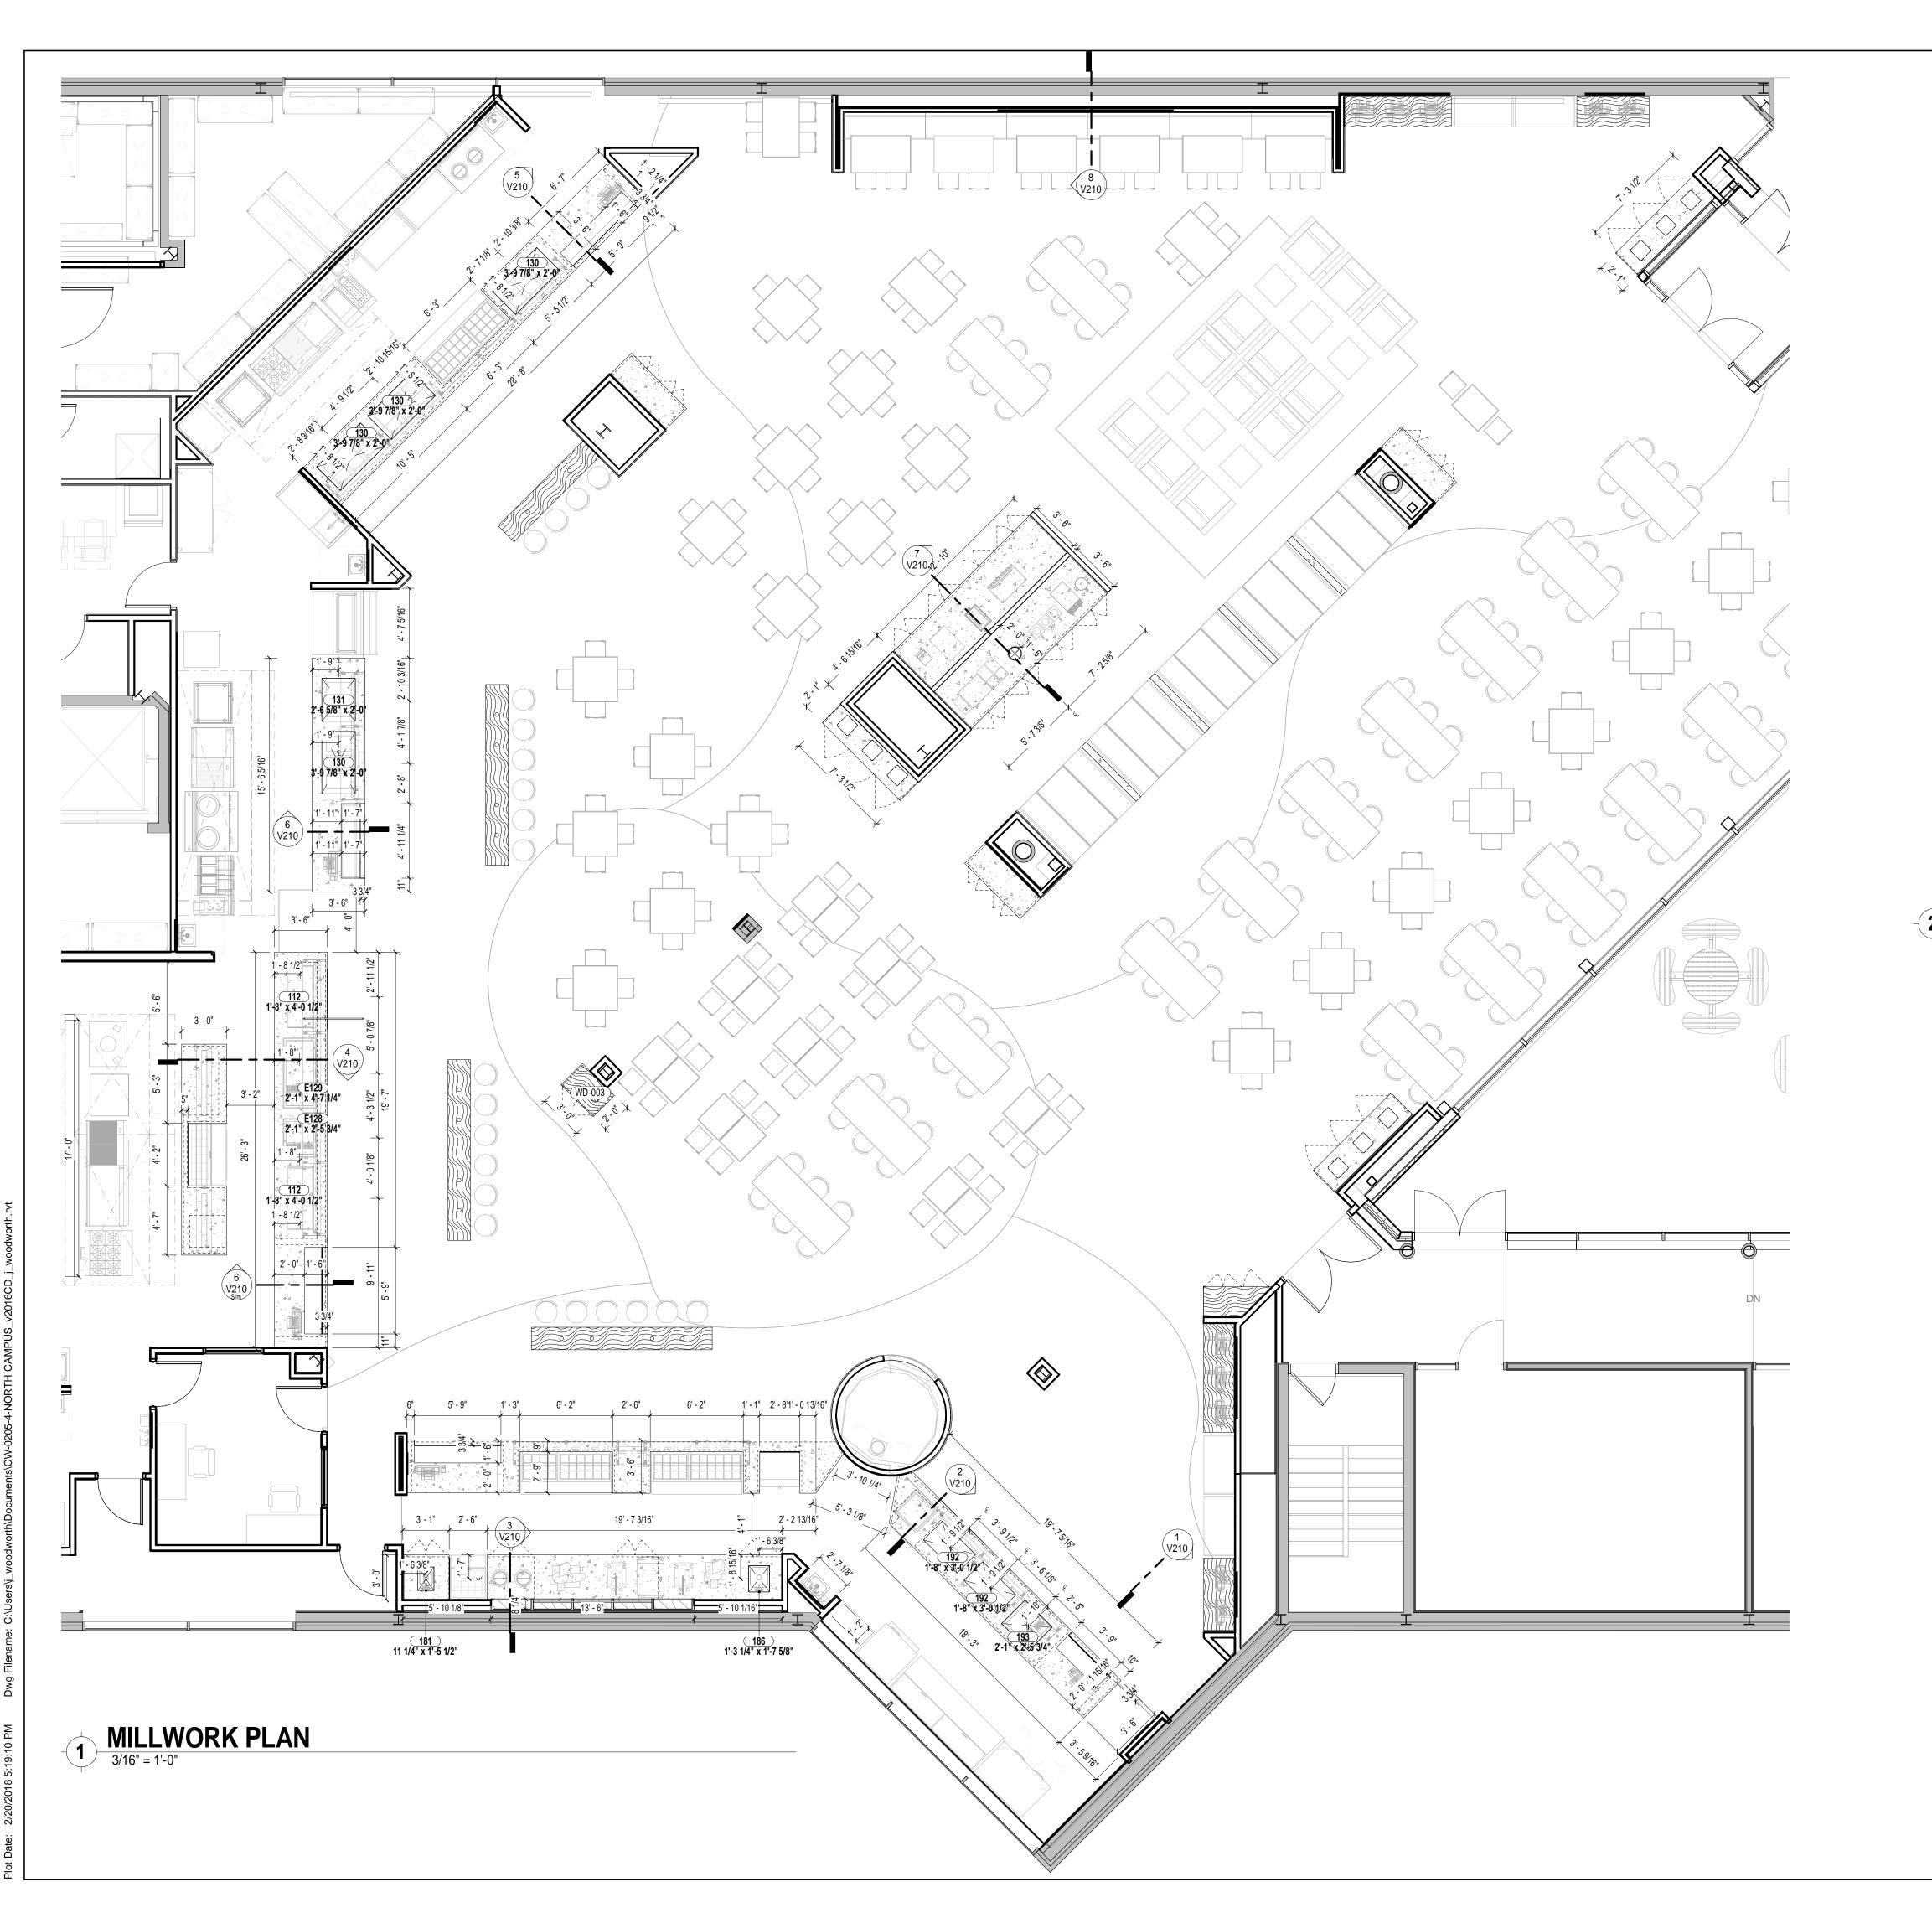DESCRIPTION

DESIGN

8 WILCOX STREET SIMSBURY, CONNECTICT 06070

# (1) LAYER NOMEX INSULATION TAPE QUARTZ COUNTER TOP COUNTER SUBSTRATE DROP-IN UNIT

# MILLWORK BEAUTY / HEAT RING DETAIL 3" = 1'-0"

2" FLAT STEEL TRIM RING

1 1/4" STEEL TUBE

## MILLWORK LEGEND

**CUTOUT AS SPECIFIED** 

## **GENERAL NOTES:**

- REFER TO FINISHES SCHEDULE FOR ALL FINISHES.
- MILLWORK CONTRACTOR TO SITE VERIFY ALL DIMENSIONS PRIOR TO CONSTRUCTION.
   DRAWINGS TO BE READ IN CONJUNCTION WITH EQUIPMENT SCHEDULE & ASSOCIATED DOCUMENTATION SUBMITTED BY

  MICHOLINIA DESCRIPTION.
- VISIONBUILDERS & DESIGN.

   MILLWORK CONTRACTOR TO SUBMIT SHOP DRAWINGS PRIOR TO
- CONSTRUCTION / FABRICATION FOR DESIGNER'S APPROVAL.

  UNLESS OTHERWISE NOTED, ALL INTERIOR KNEEWALL
- SURFACES AND CABINET INTERIORS TO RECEIVE WHITE PLASTIC
- LAMINATE FINISH. UNLESS OTHERWISE NOTED, THE UNDERSIDE OF THE
- COUNTERTOP SUBSTRATE IS TO RECEIVE A WHITE LAMINATE
- ALL SURFACES TO BE FINISHED. NO EXPOSED SURFACES WILL BE ACCEPTED.
- MILLWORK CONTRACTOR TO ENSURE COUNTER FITS SNUG WITH SURROUNDING SITE AND MILLWORK CONDITIONS. IF NECESSARY SCRIBE COUNTER ON SITE.

  • WHERE COUNTERTOP SUBSTRATE INTERFERES WITH

MANUFACTURER'S SPECIFICATIONS PRIOR TO FABRICATION.

- UNDERCOUNTER EQUIPMENT CLEARANCES, STEEL FLAT BARS SHALL BE USED TO SUPPORT THE COUNTERTOP AS NEEDED.
- MILLWORK CONTRACTOR TO ENSURE ALL SPECIFIED/PROVIDED EQUIPMENT FITS INTO COUNTER AS NOTED. CHECK ALL
- MILLWORK CONTRACTOR TO LIASE WITH KEC TO COORDINATE ADEQUATE MILLWORK REINFORCEMENT TO SUPPORT
- SPECIFIED/PROVIDED EQUIPMENT AT FULL CAPACITY.

   MILLWORK CONTRACTOR TO CLEAN AND SEAL AROUND ALL COUNTERTOP CUTOUTS FOR EQUIPMENT, TRASH DROPS, ETC.
- ANY SUPPORT LEGS INDICATED ON THE DRAWINGS ARE SUGGESTED PLACEMENT. QUANTITY OF SUPPORT LEGS SHALL BE DETERMINED BY MILLWORK CONTRACTOR AND KEC.
- MILLWORK CONTRACTOR TO PROVIDE ADEQUATE VENTILATION IN COUNTERS FOR REQUIRED EQUIPMENT. CHECK ALL
- MANUFACTURER'S SPECIFICATIONS PRIOR TO FABRICATION. ALL CONSTRUCTION TO BE 3/4" C-3 GRADE PLYWOOD OR
- APPROVED EQUAL, FINISH AS SPECIFIED. UNLESS OTHERWISE DETAILED, LOUVERED MILLWORK DOORS SHALL HAVE 1/2" VENTILATION SLOTS ROUTED INTO THE ENTIRE
- DOOR @ 1 1/2" OC. VENTILATION SLOTS SHALL STOP MIN. 3" ON ALL SIDES. INSIDE OF SLOT TO BE PAINTED BLACK WITH WATERPROOF SEALANT. CUSTOMER SIDE OF ALL SERVING COUNTERS SHALL NOT

EXCEED 34" ABOVE FINISHED FLOOR

MILLWORK SECTIONS ARE SHOWN AS A GENERAL REPRESENTATION OF PROFILE AND MATERIAL PLACEMENT. MILLWORK SECTIONS ARE NOT TO BE CONSTRUED AS A

MILLWORK CUTOUTS INDICATED ARE BASED ON EQUIPMENT
SPECIFICED IN THE DESIGN DEVELOPMENT DOCUMENTS.
ANY SUBSTITUTIONS OR ALTERATIONS TO SPECIFIED
EQUIPMENT RENDERS CUTOUT INFORMATION NULL AND

MEANS AND METHODS FOR CONSTRUCTION/FABRICATION.

SHOP DRAWINGS SHALL BE SUBMITTED FOR APPROVAL.

XX → ITEM NUMBER 

ISSUED FOR: BID ISSUED DATE: 02/16/2018


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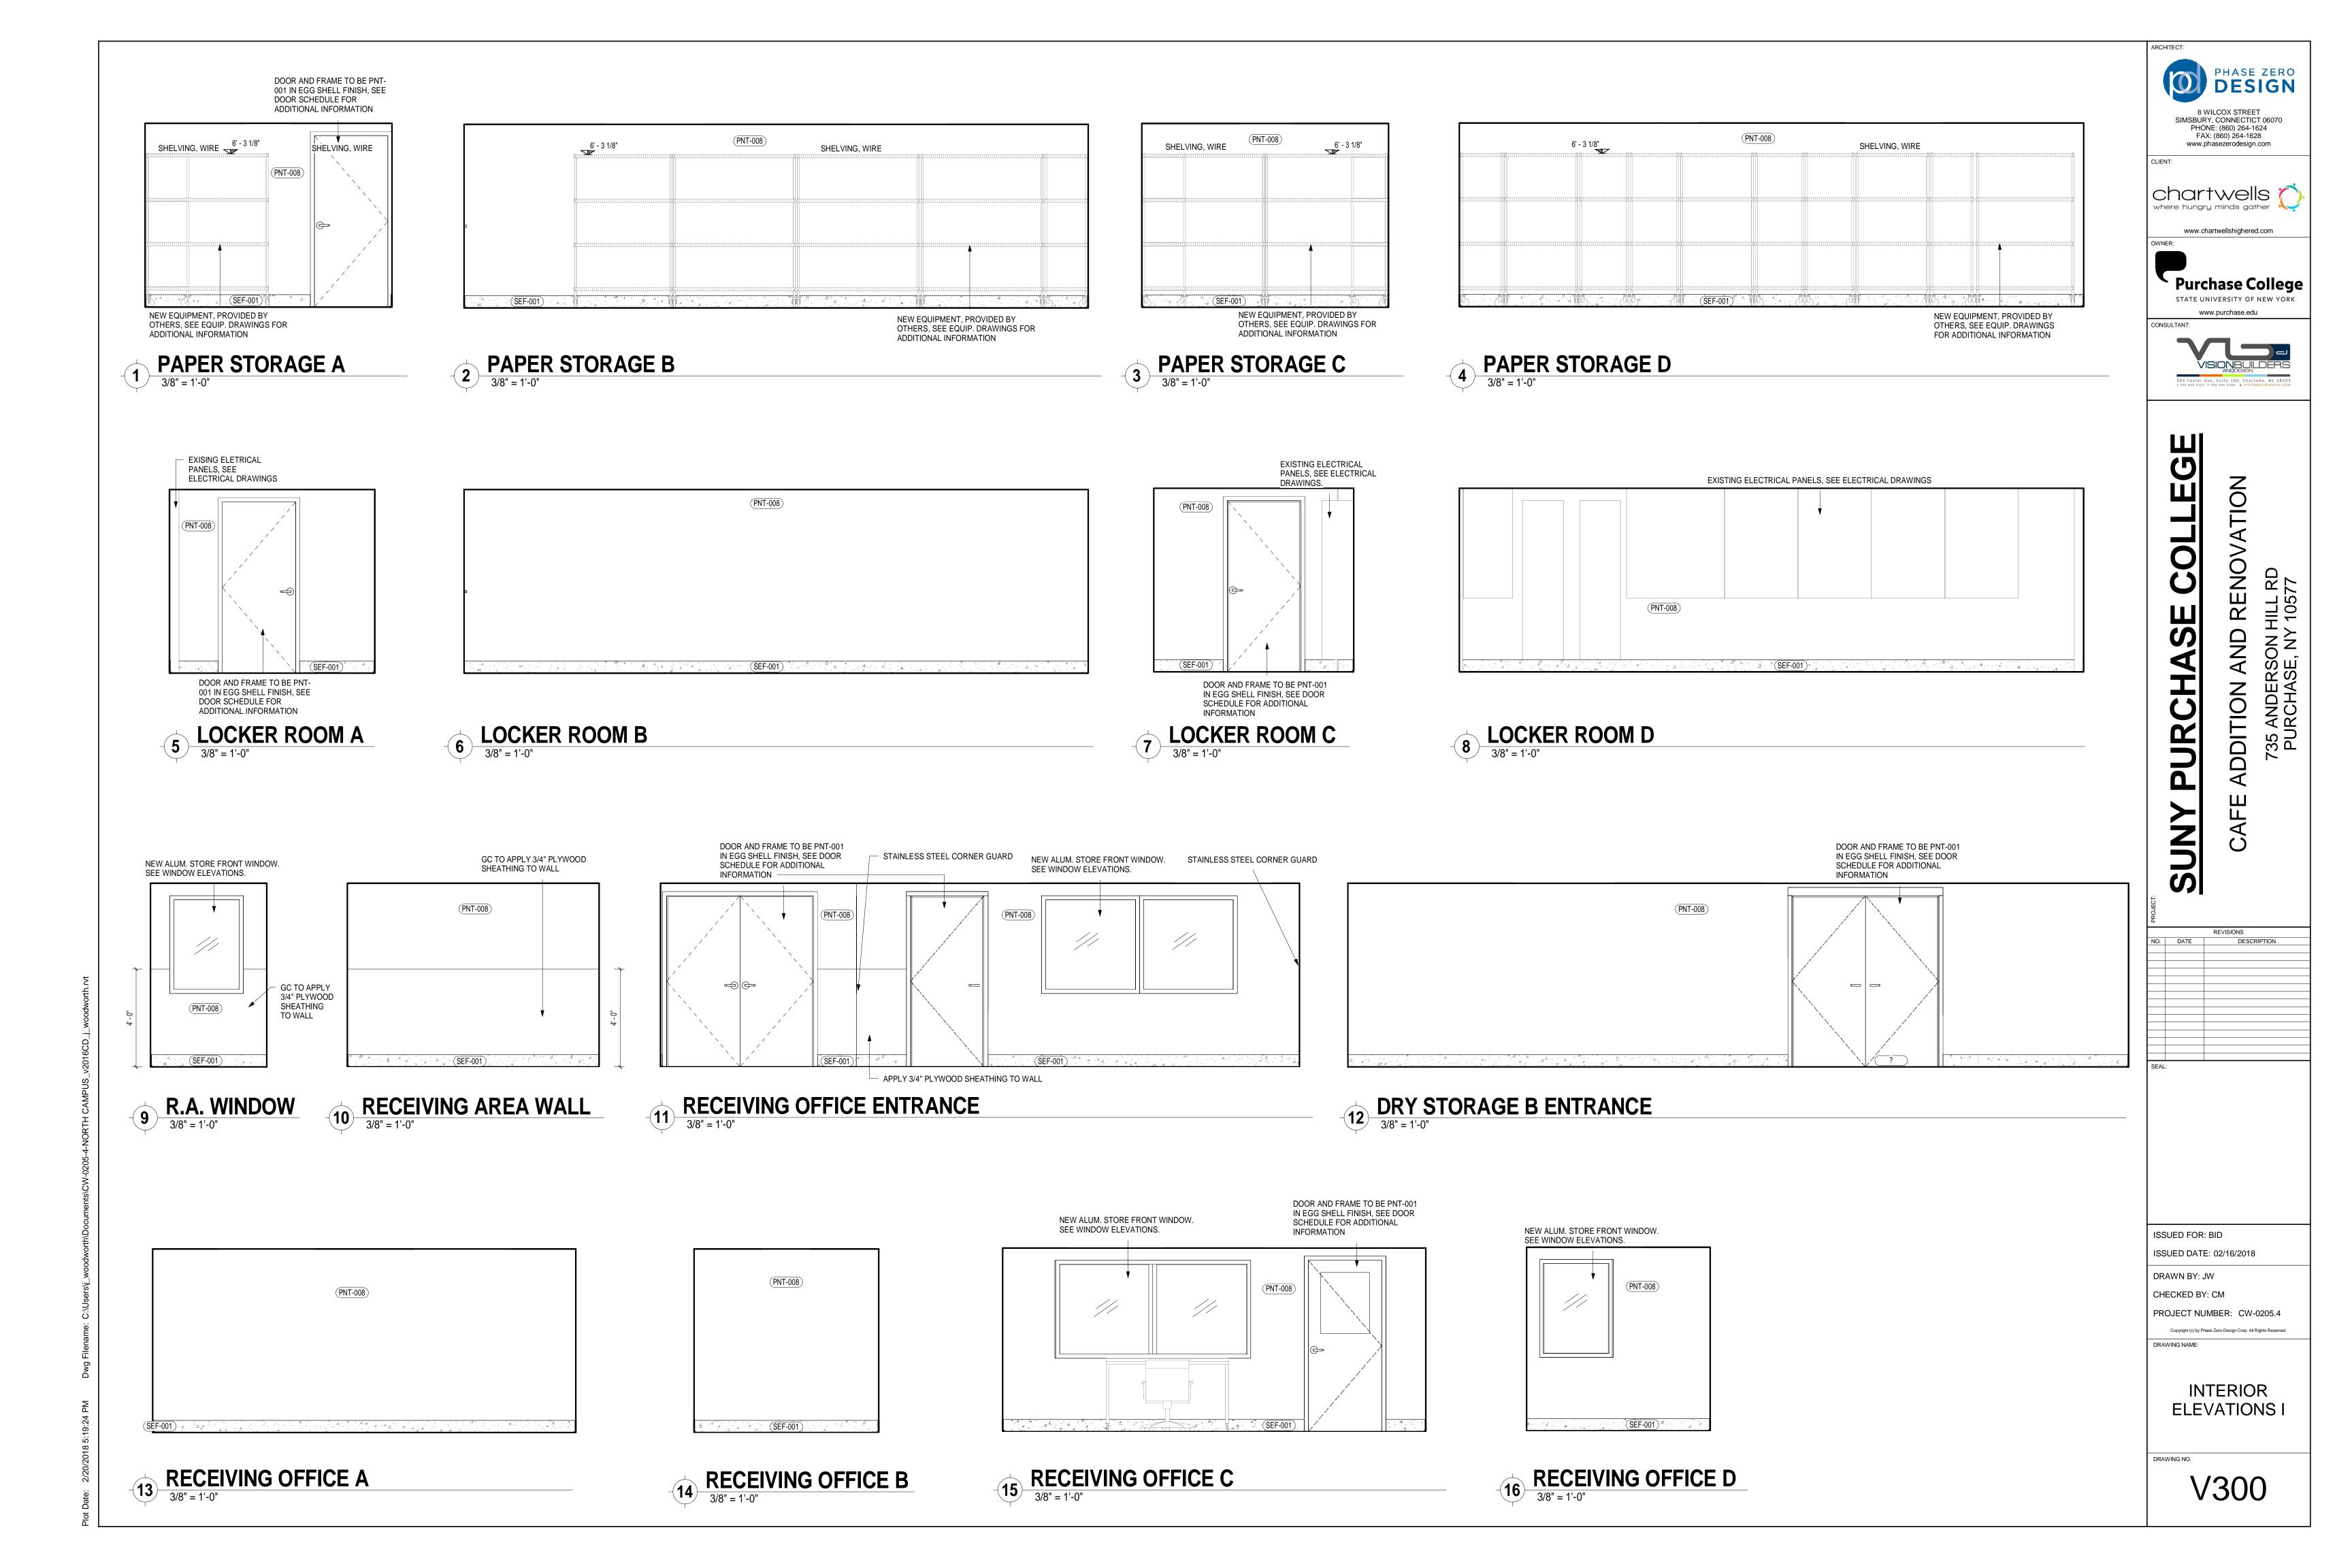
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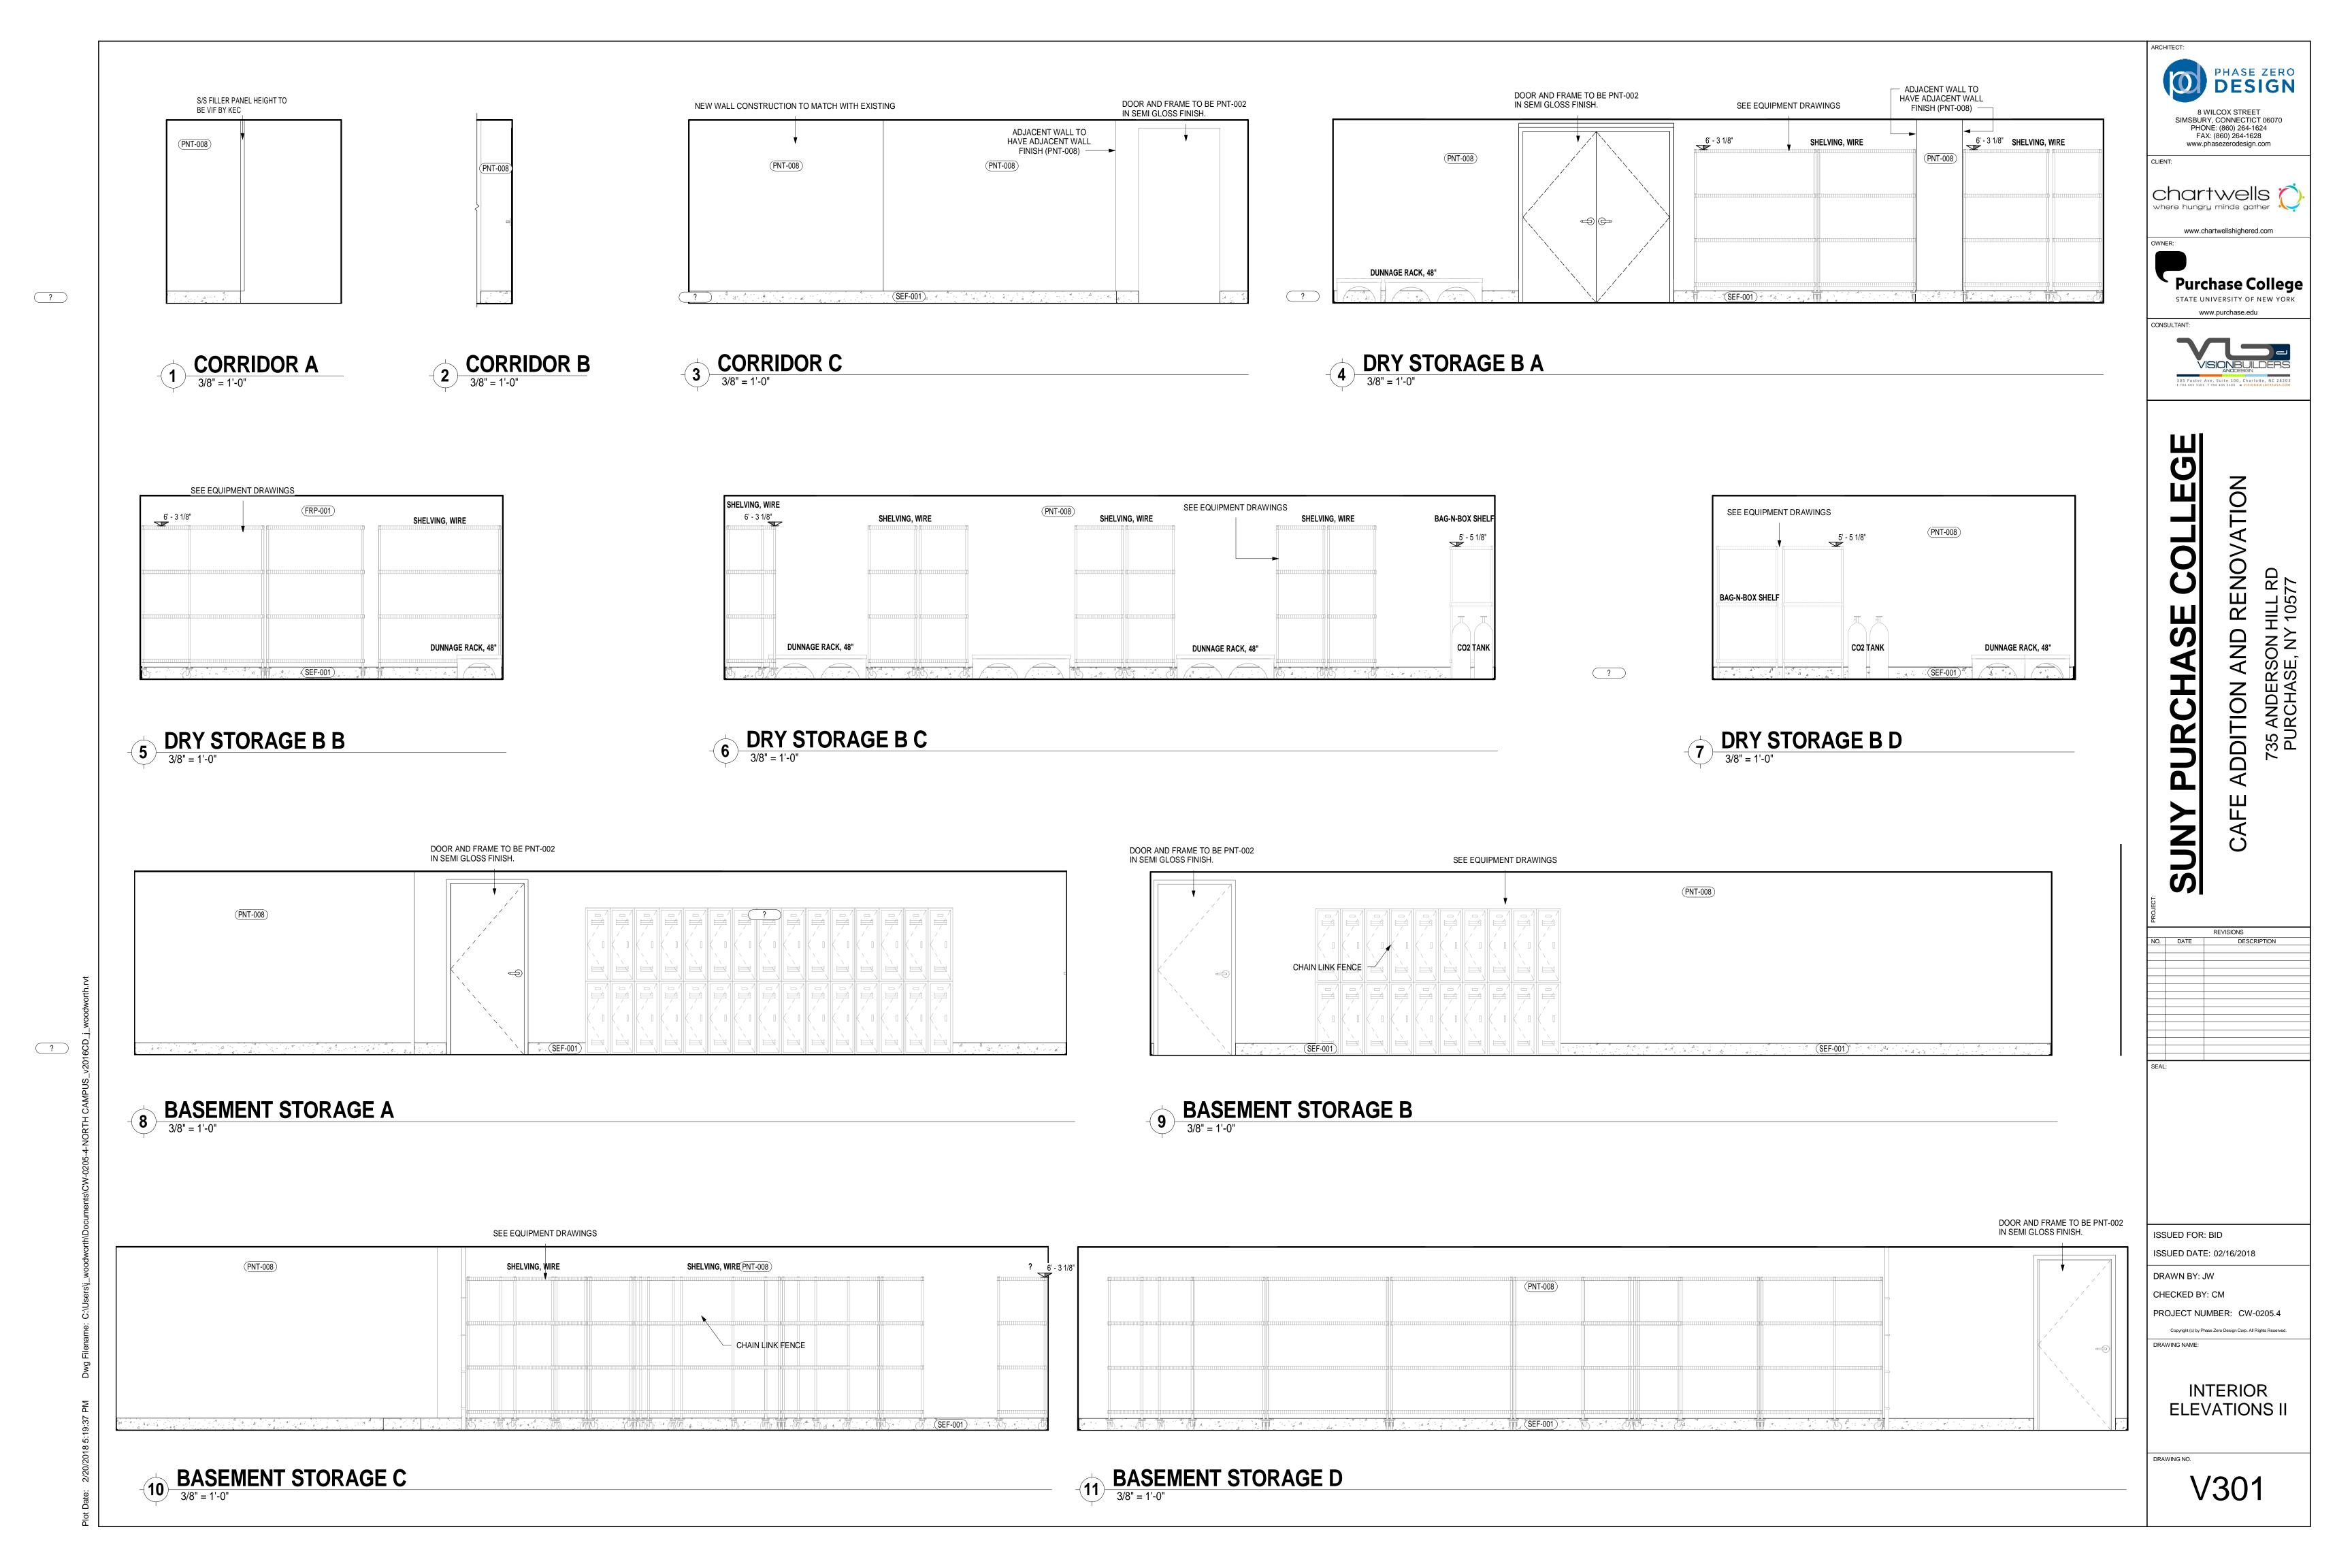
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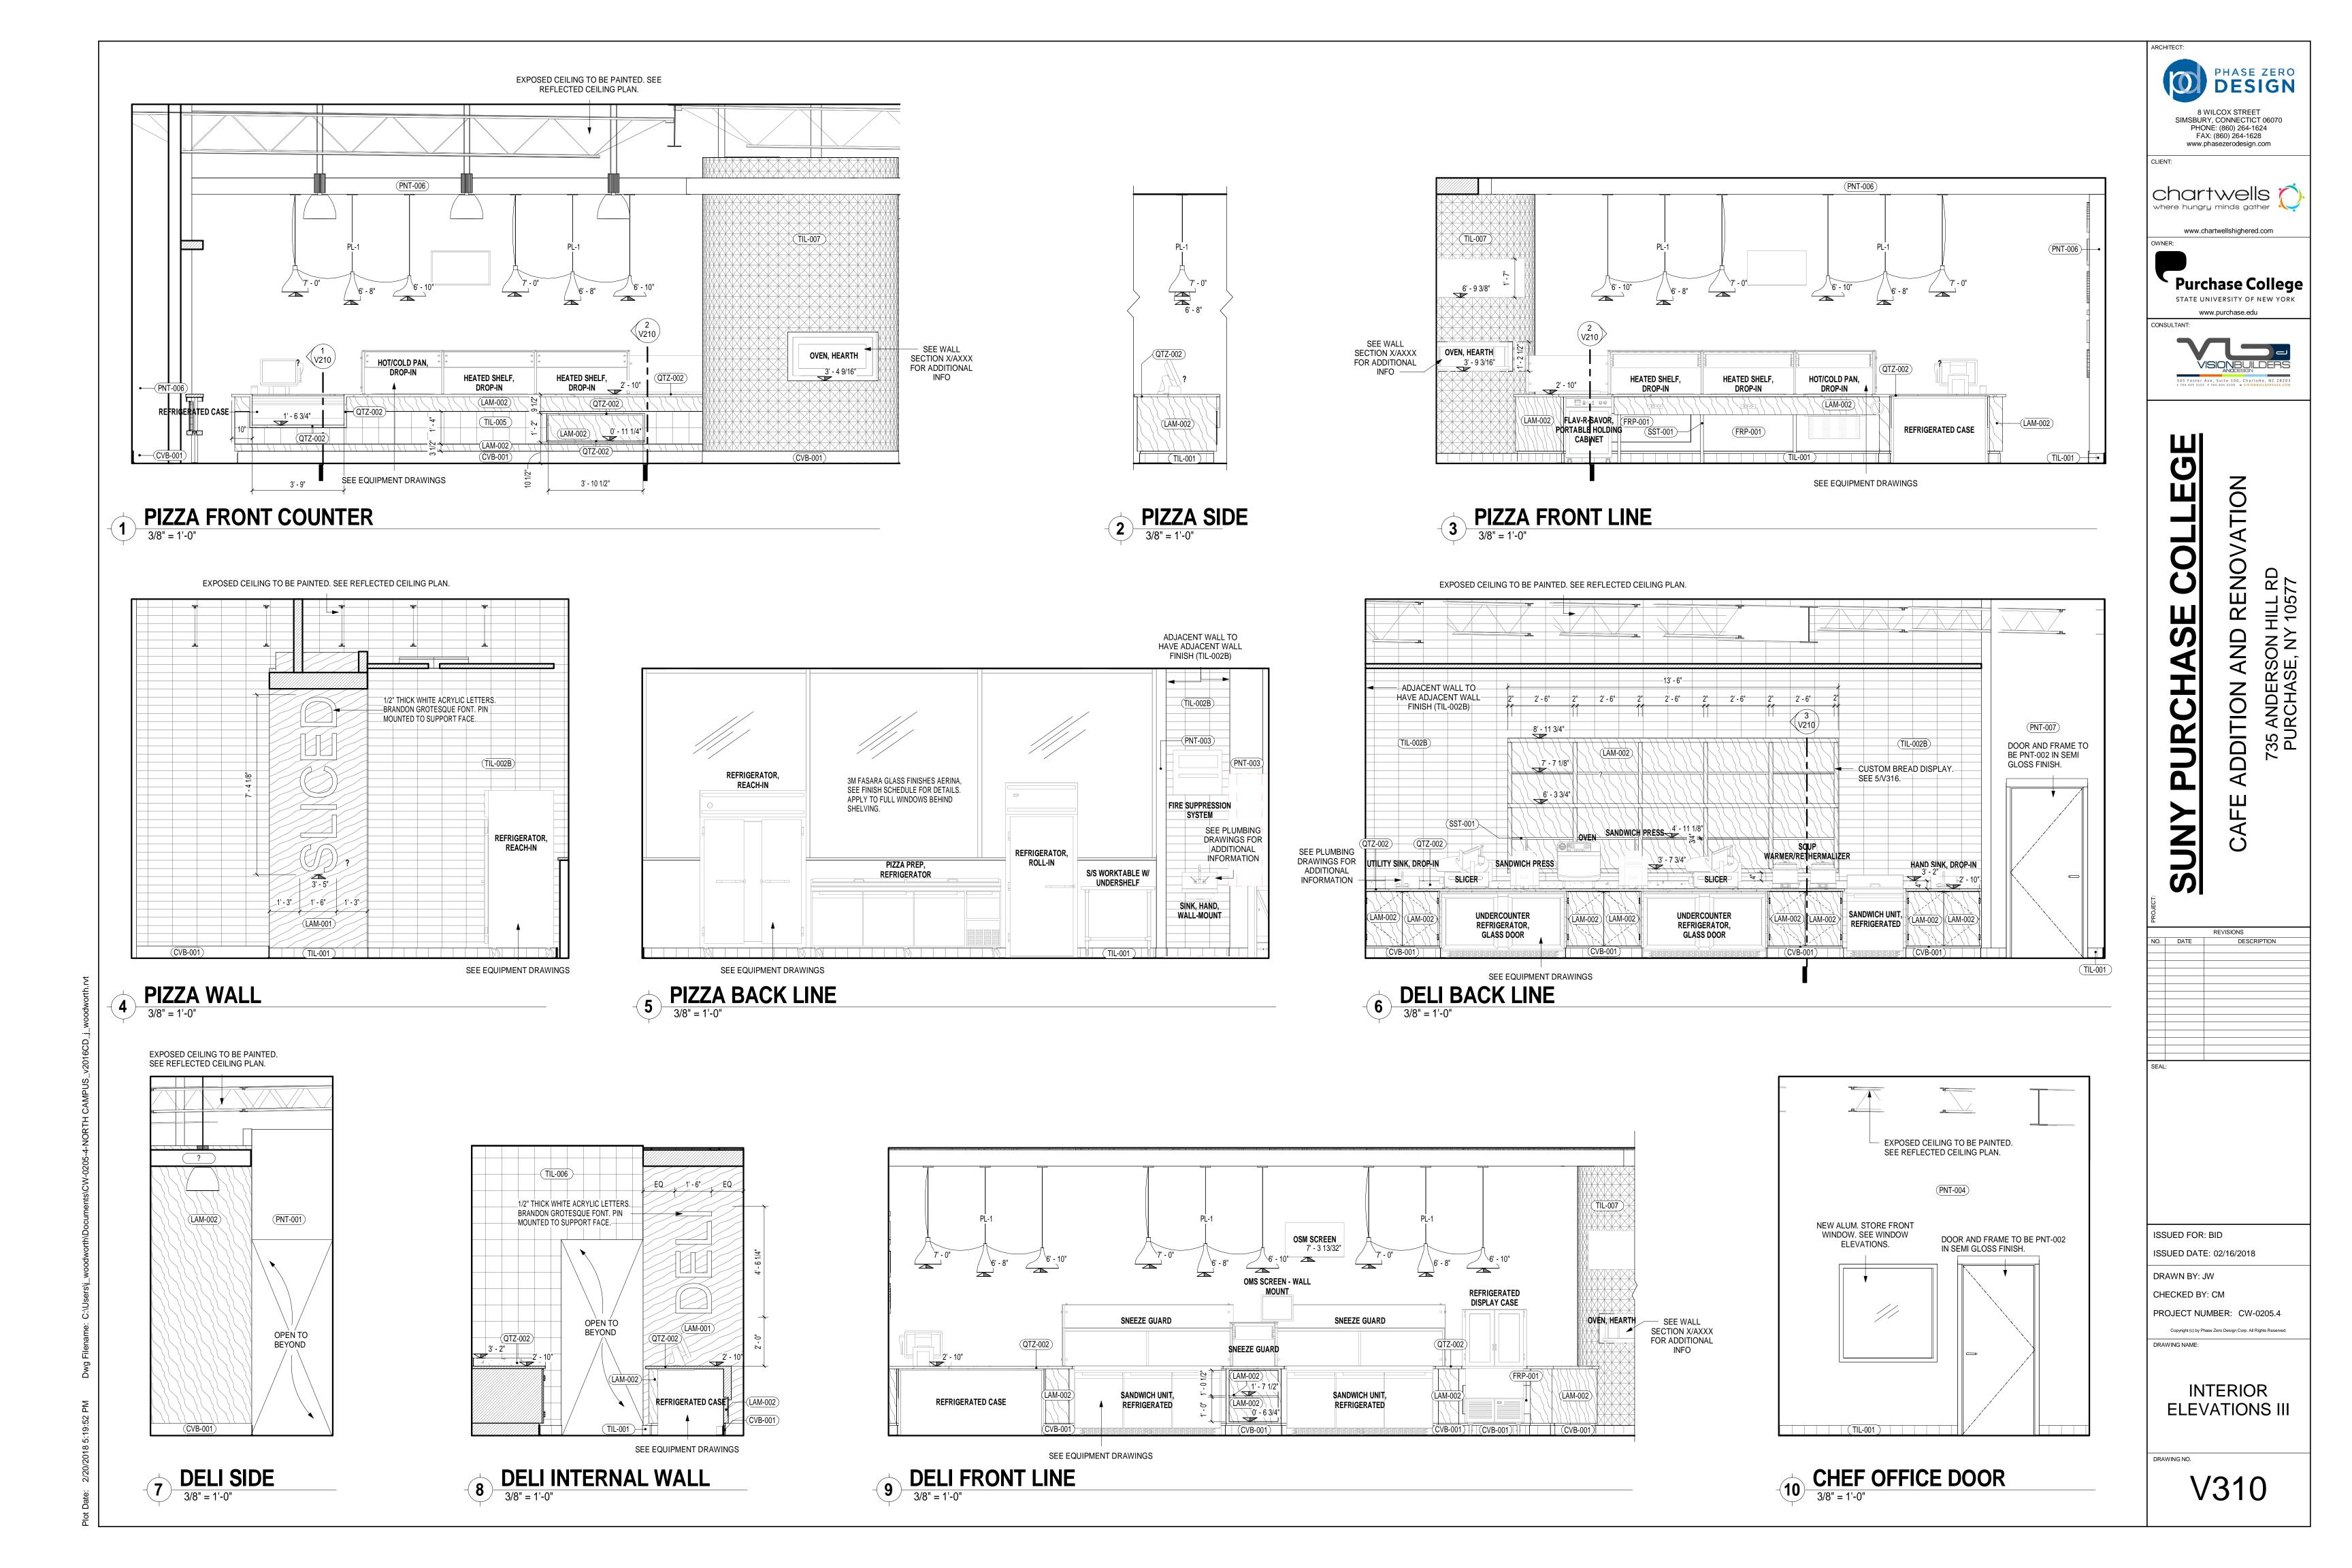
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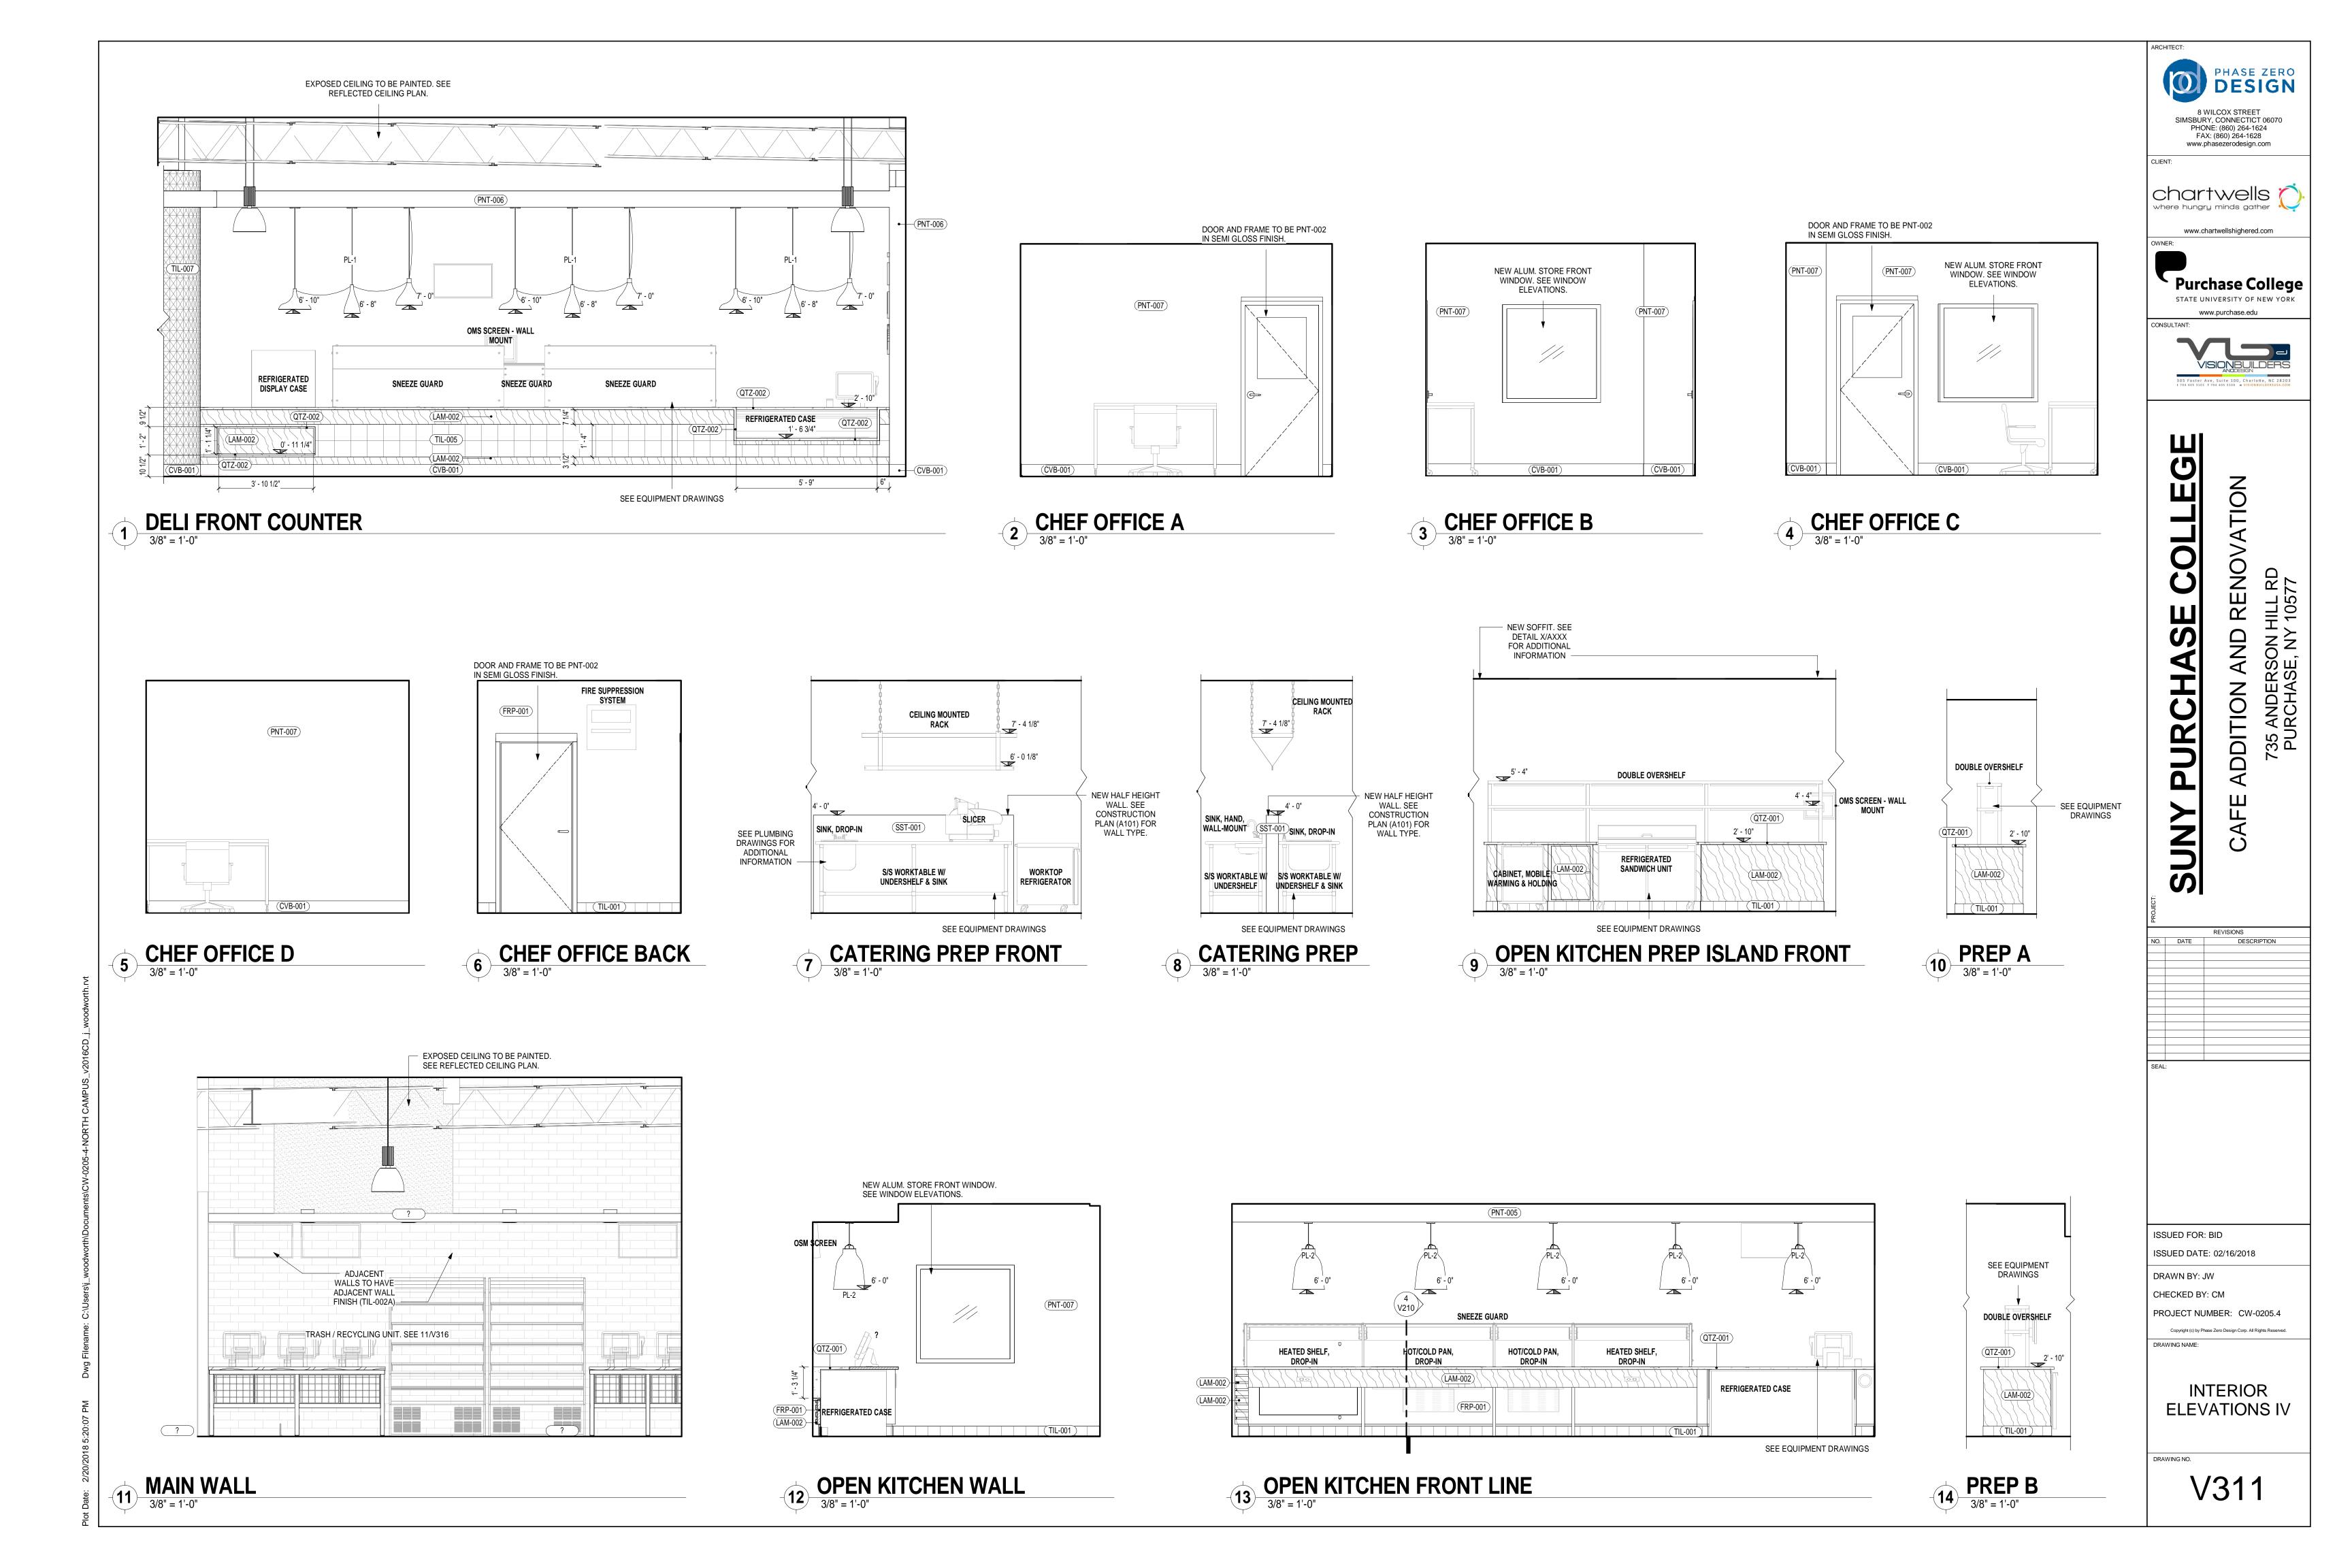
MILLWORK PLAN












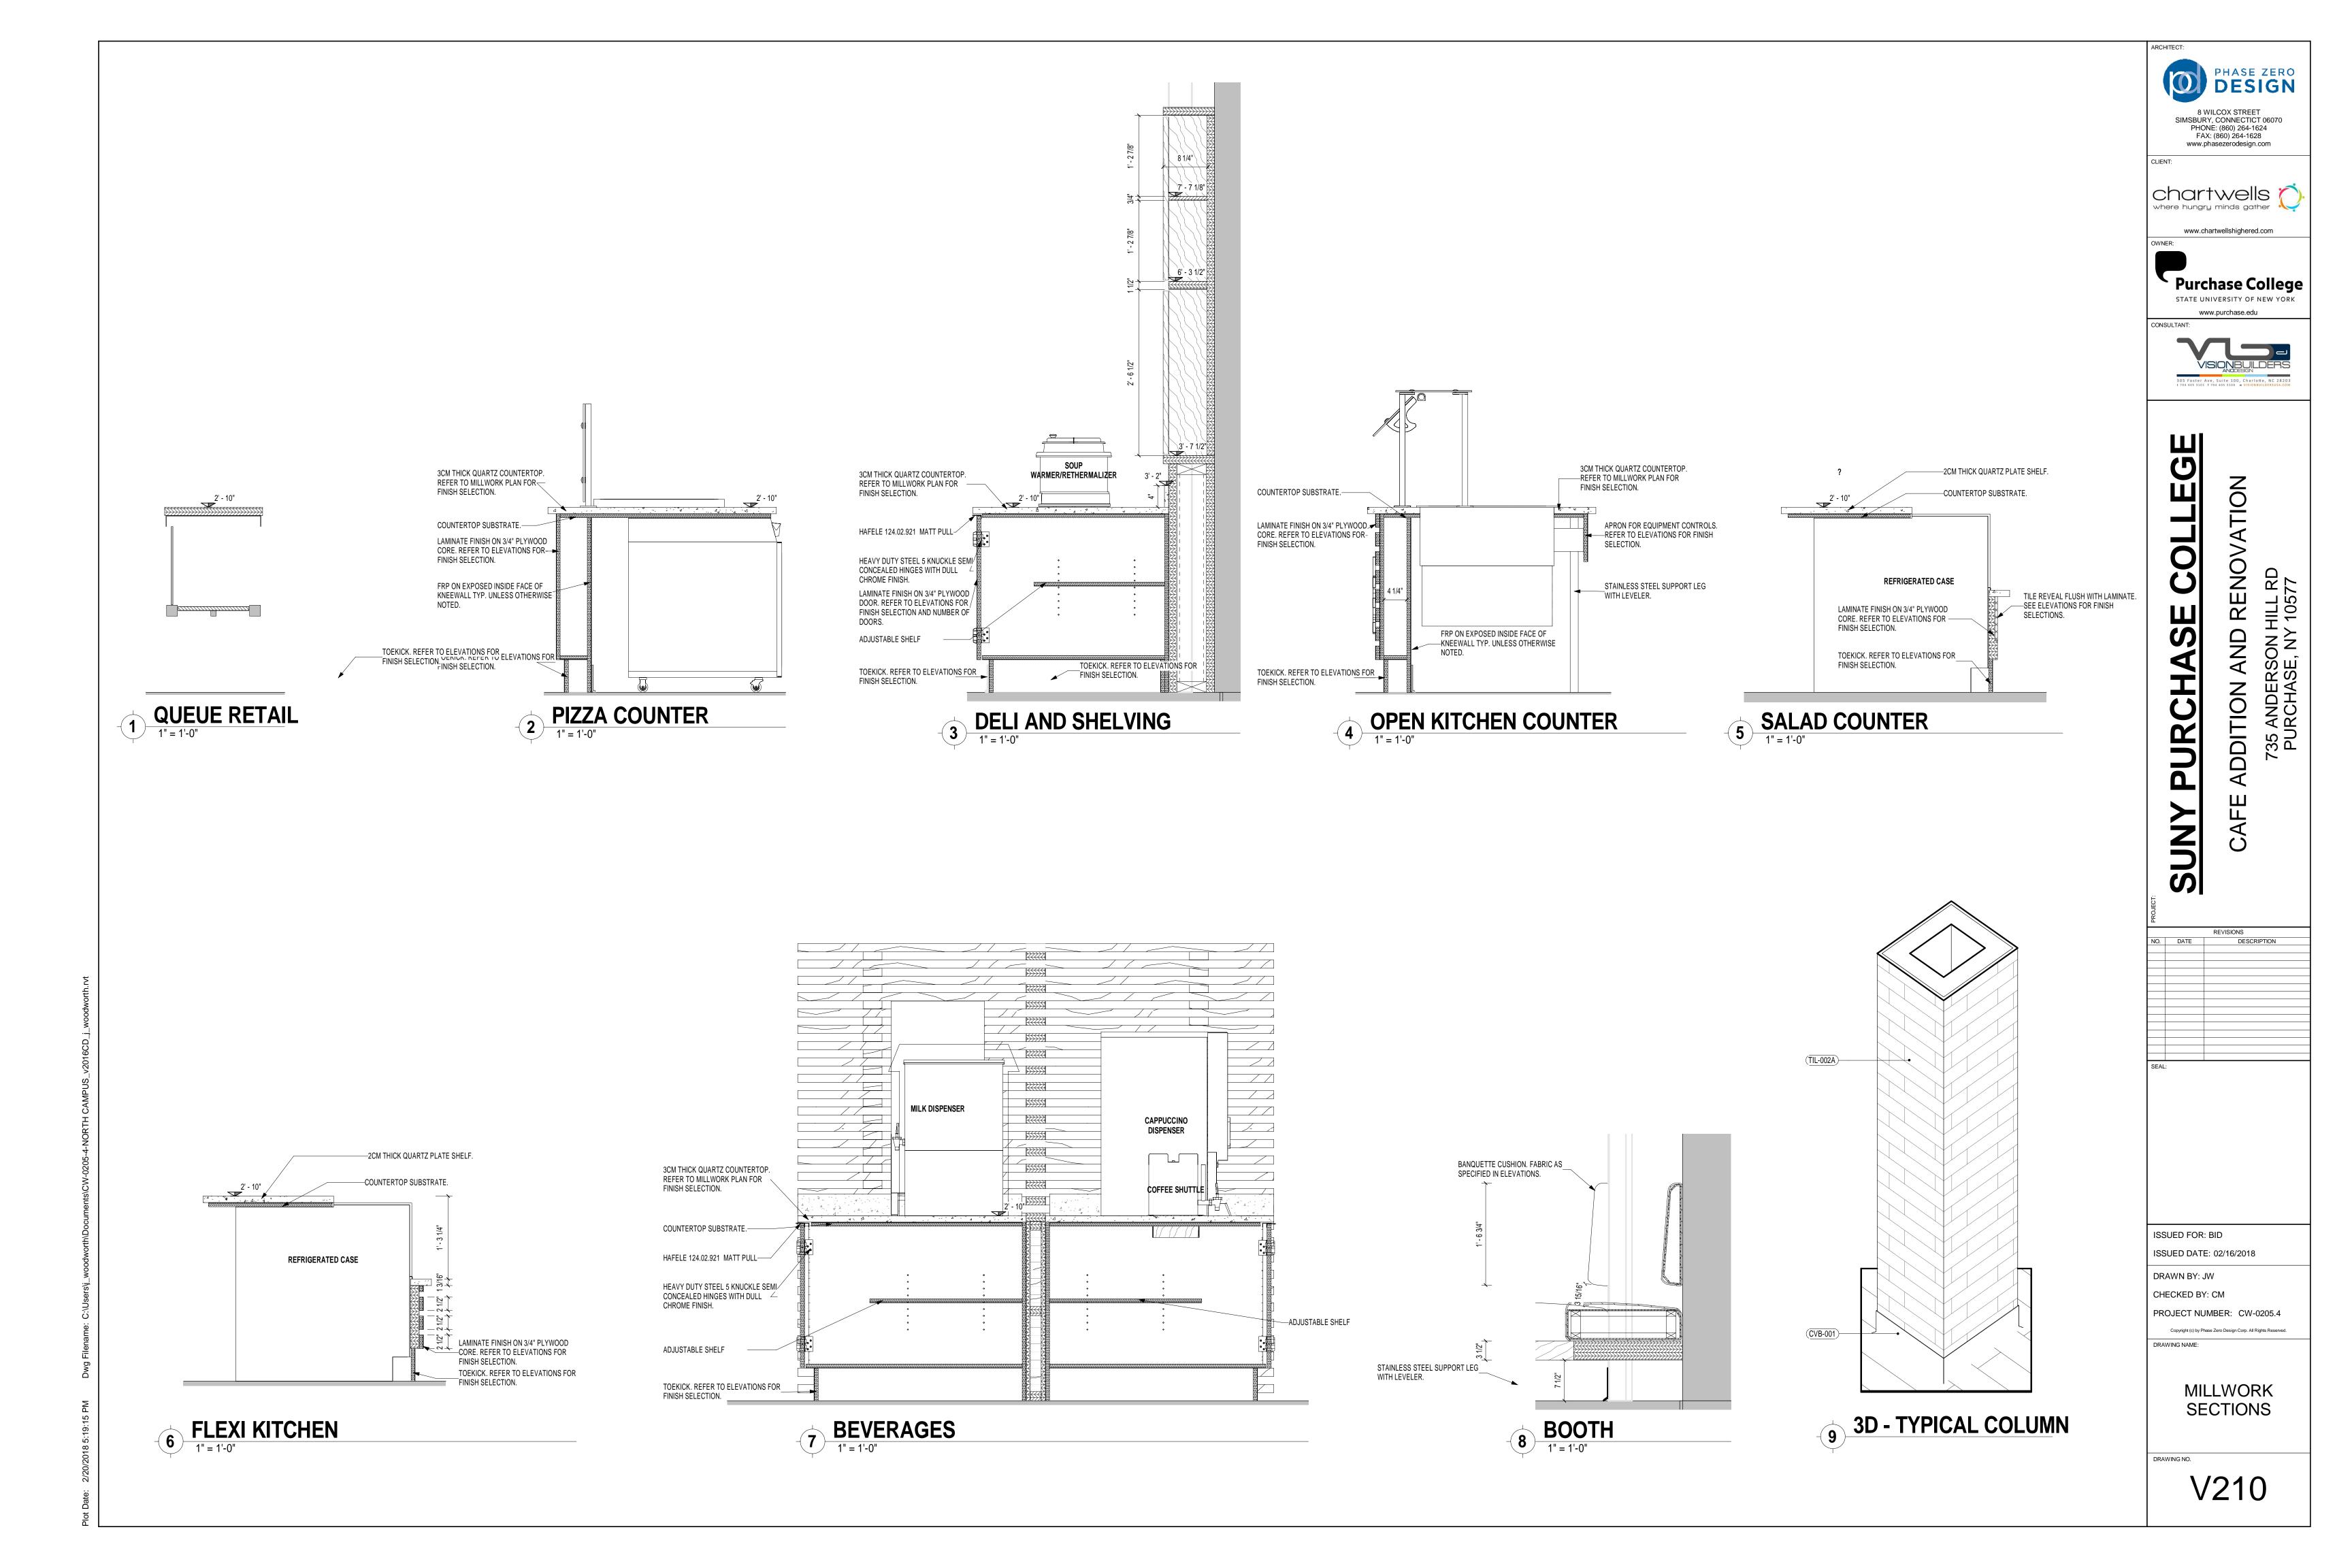


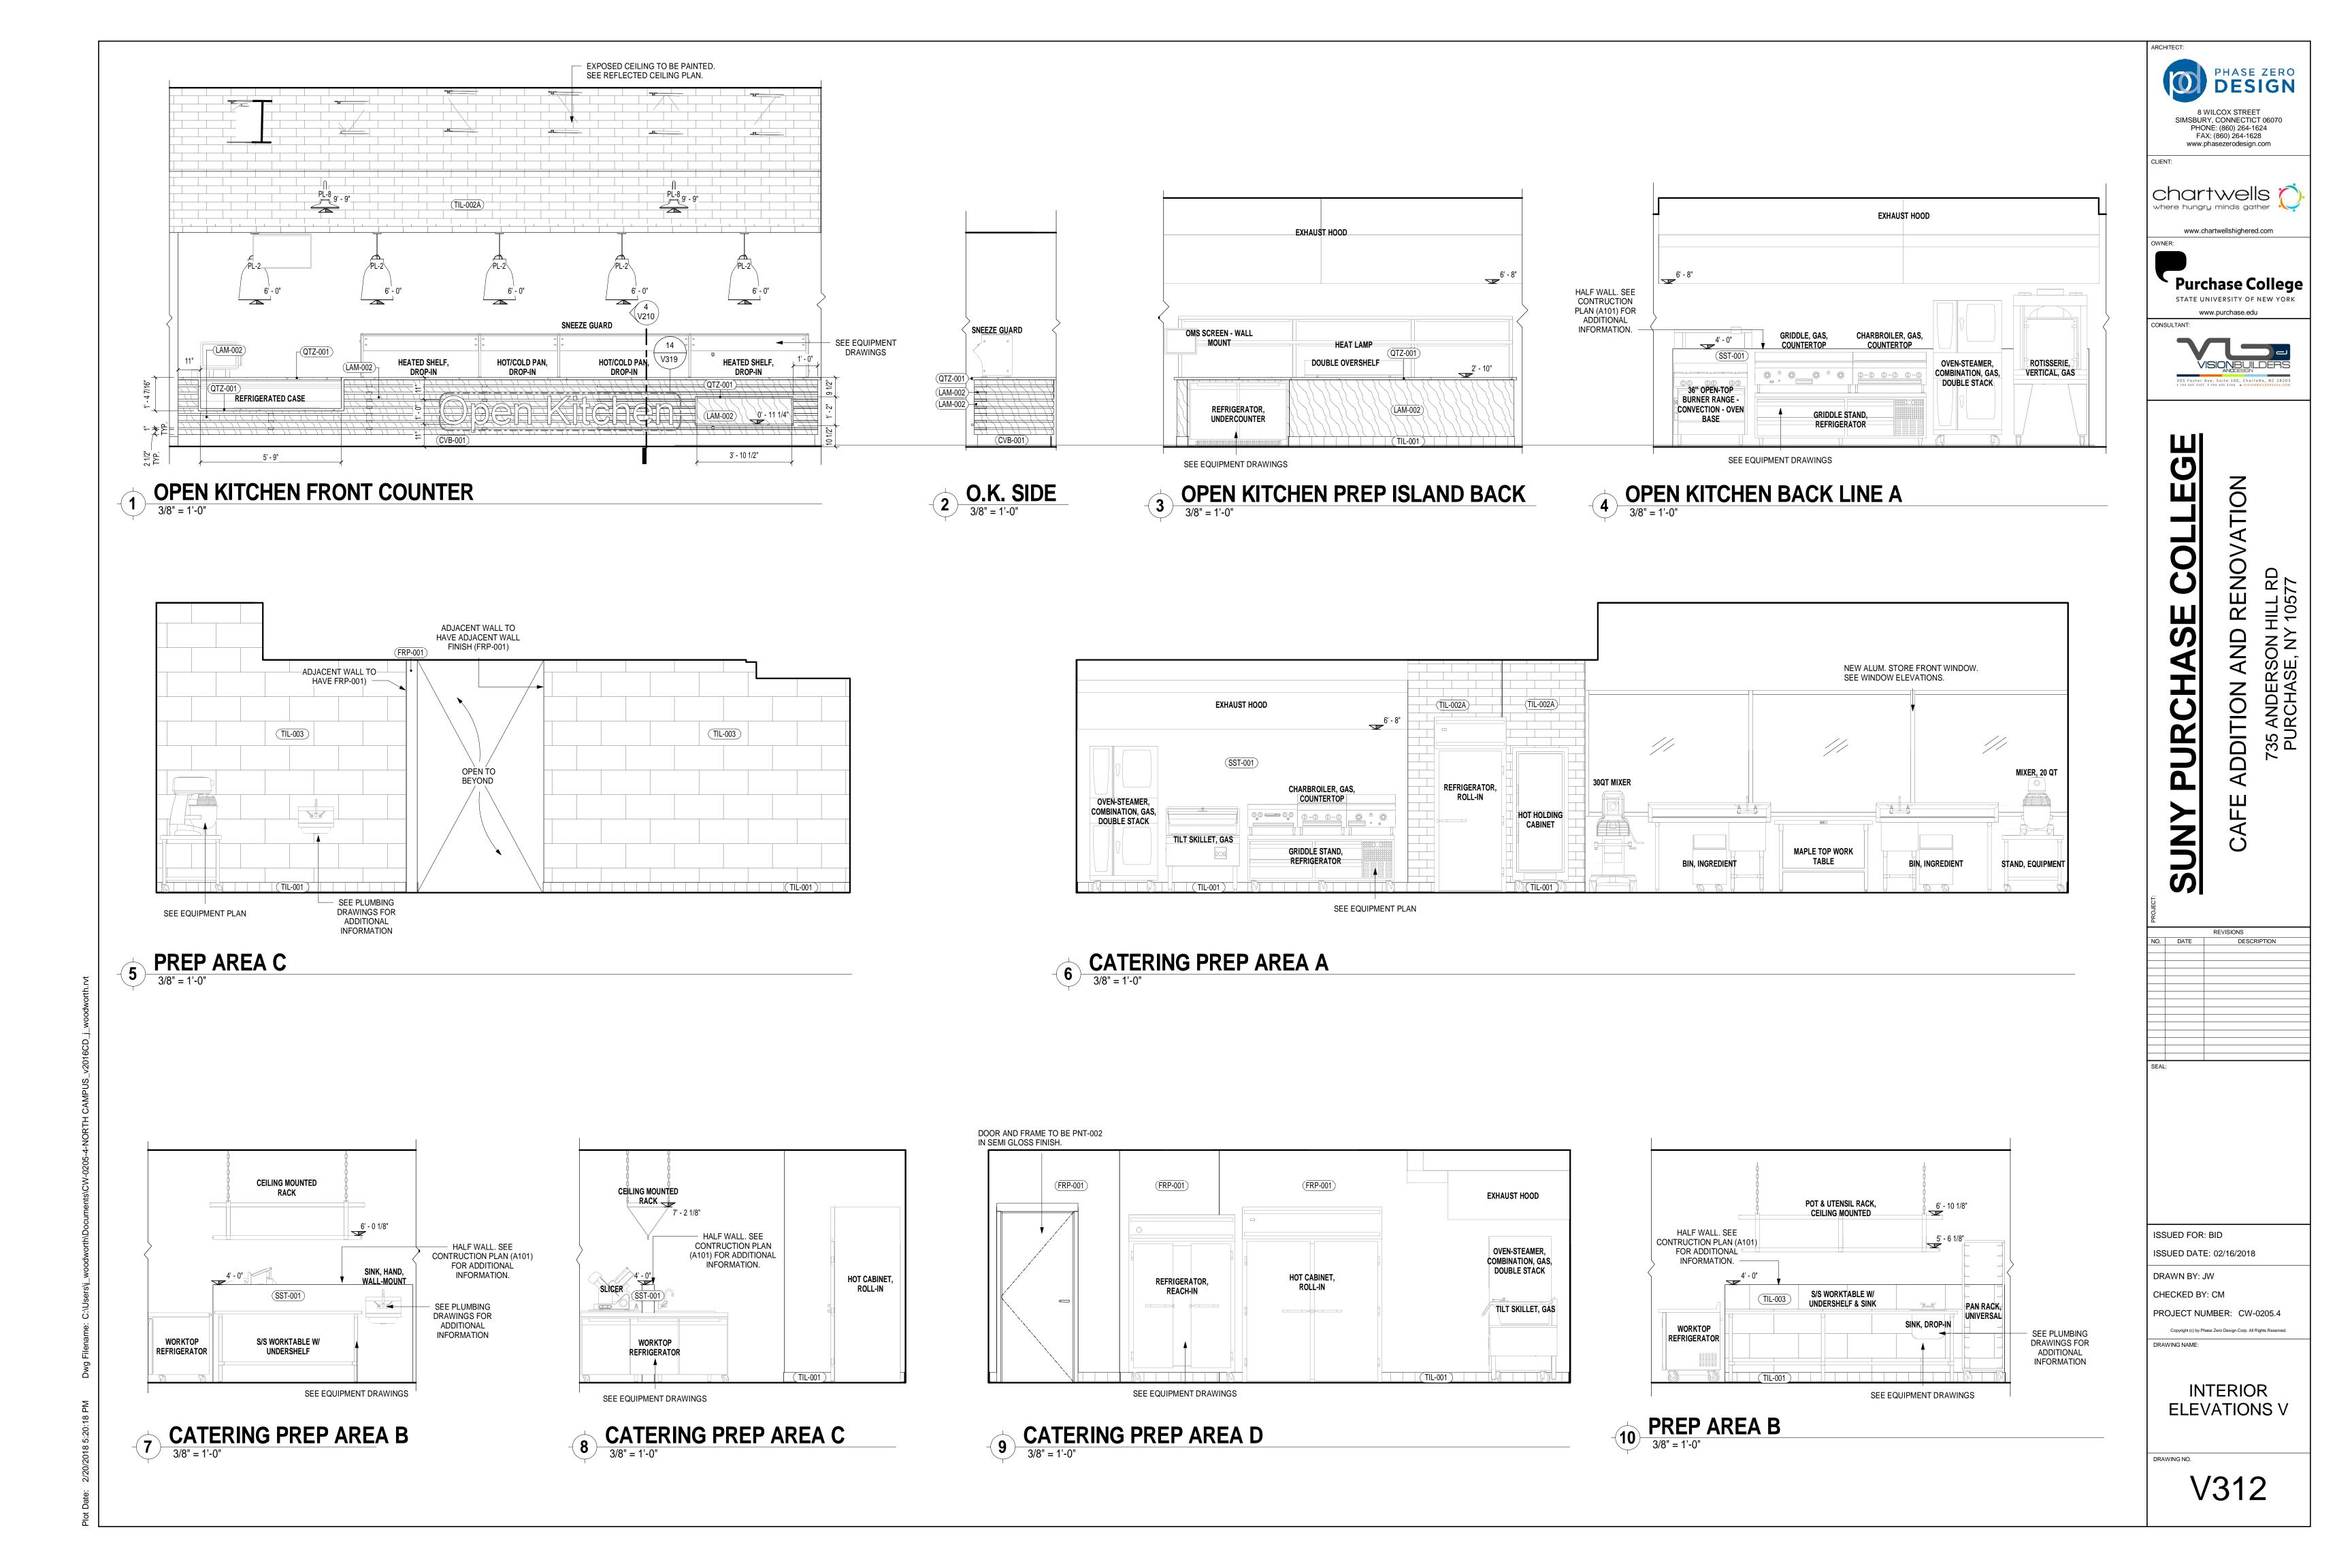




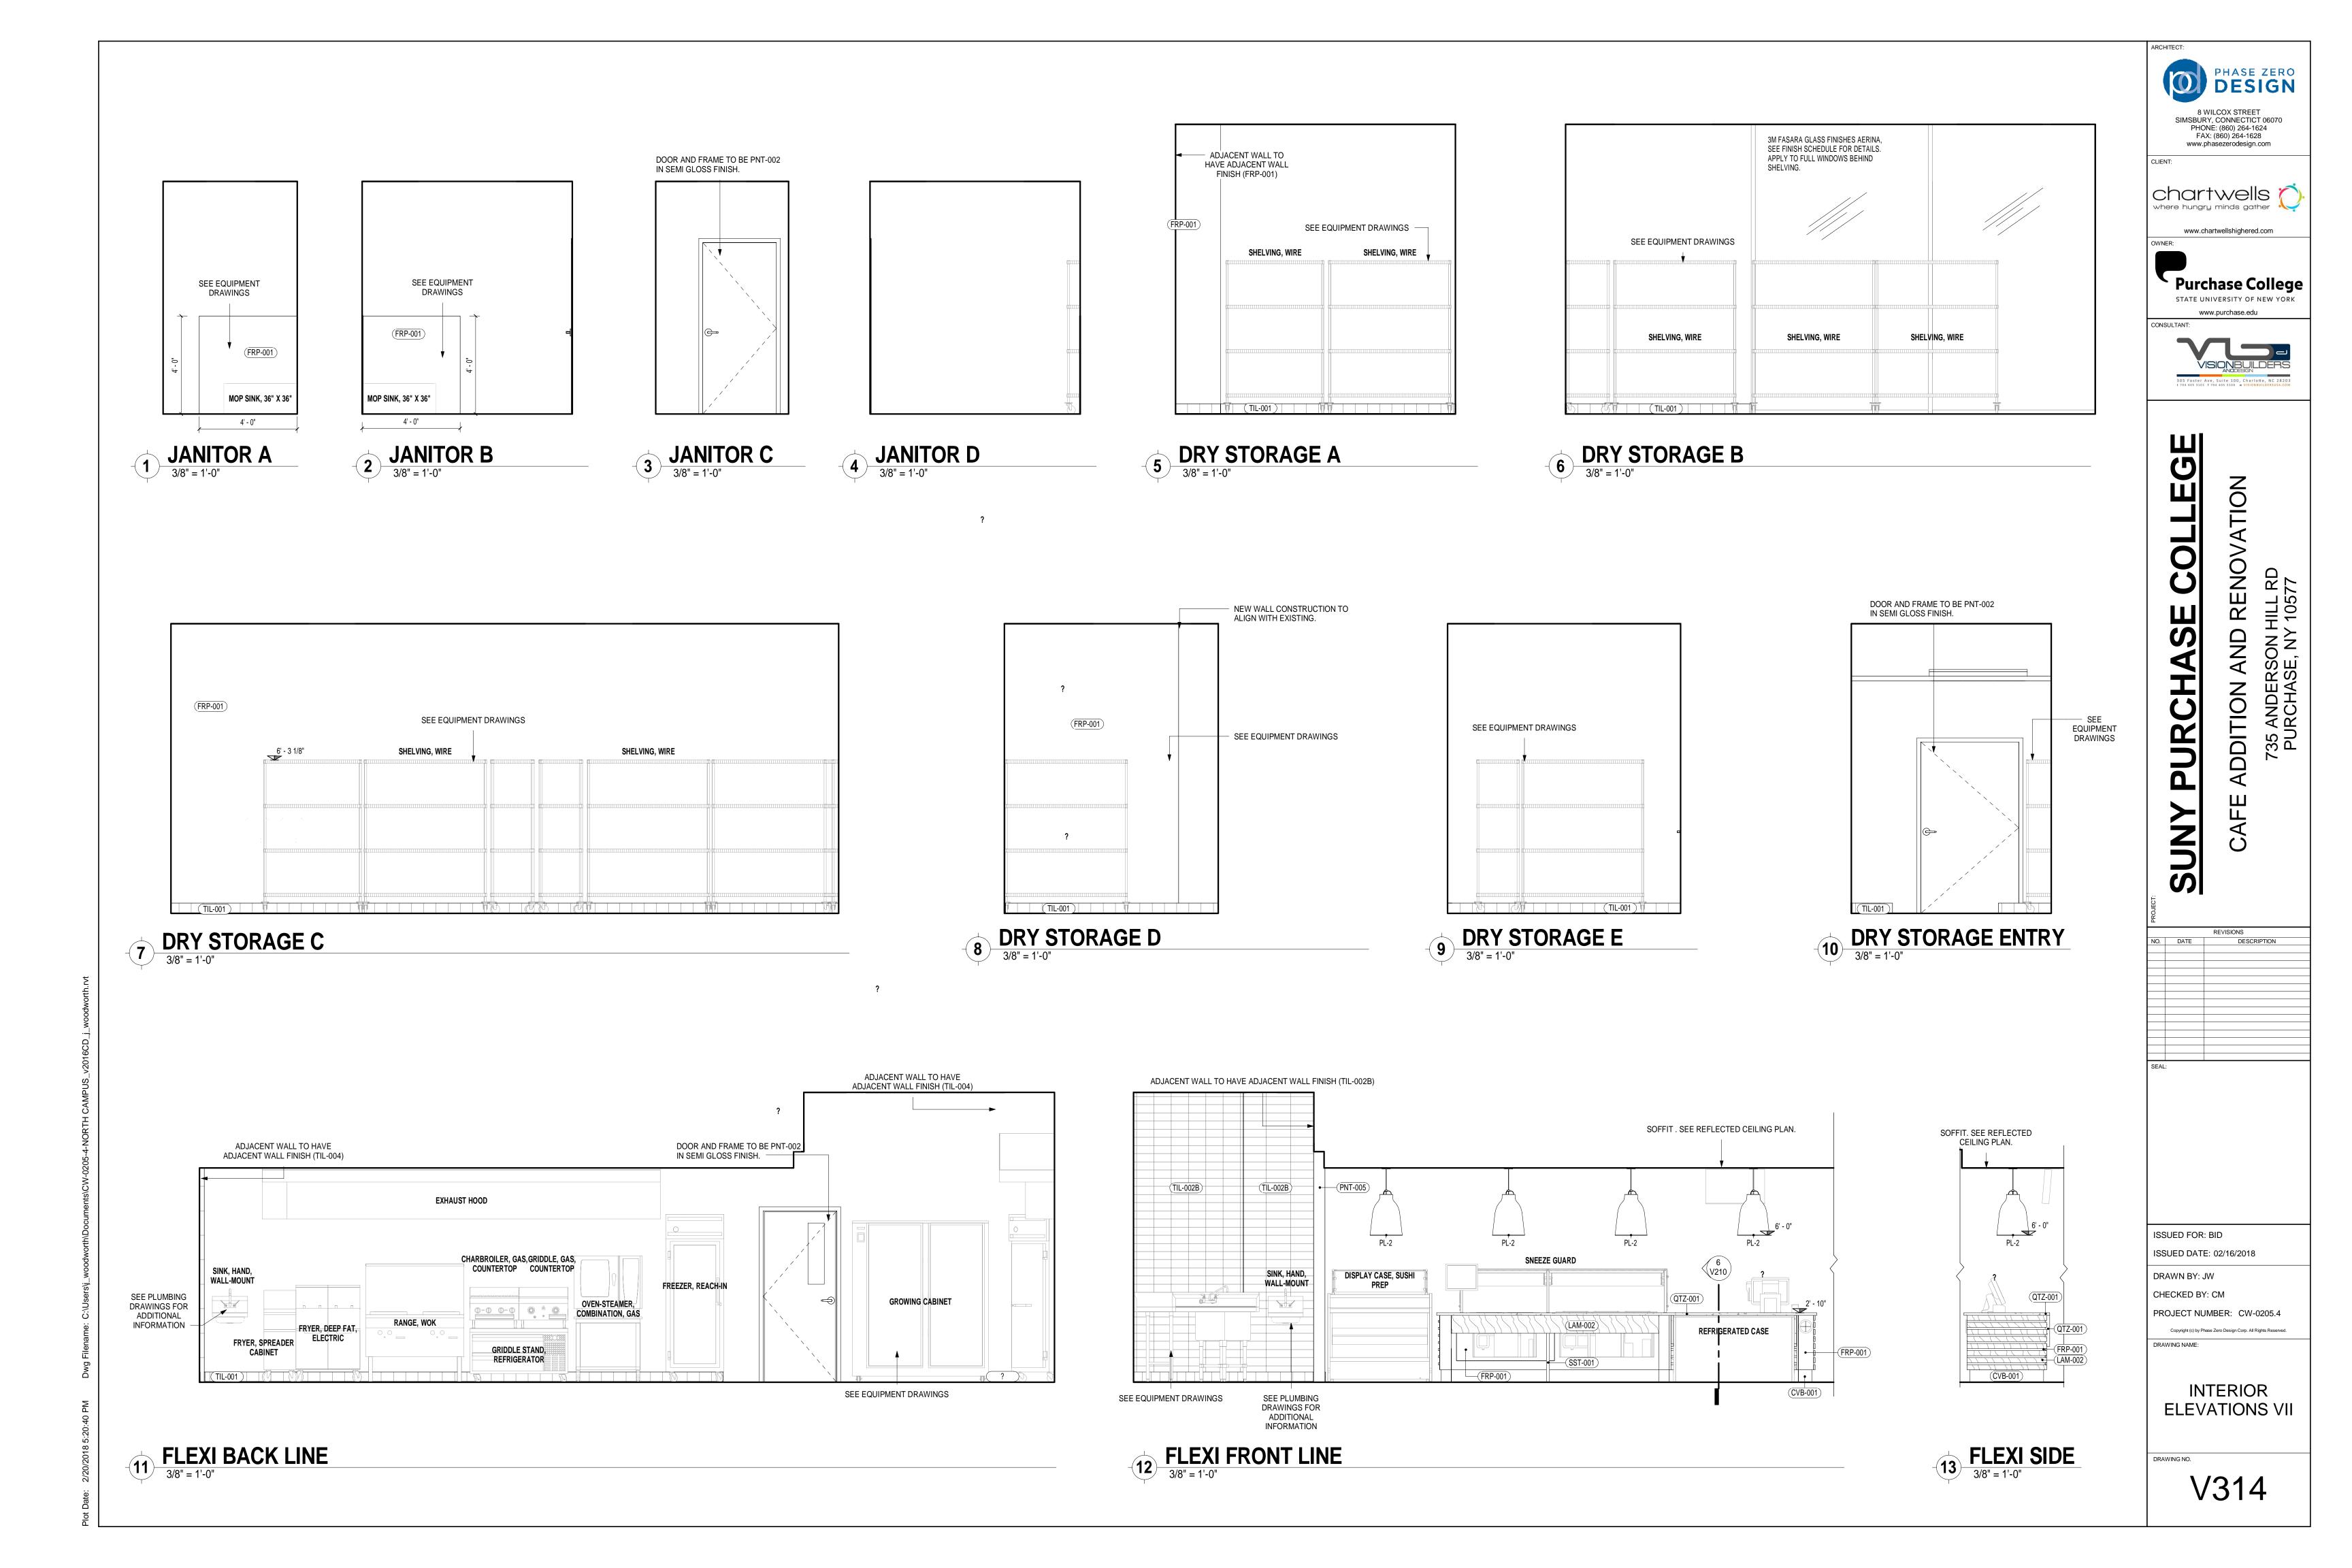

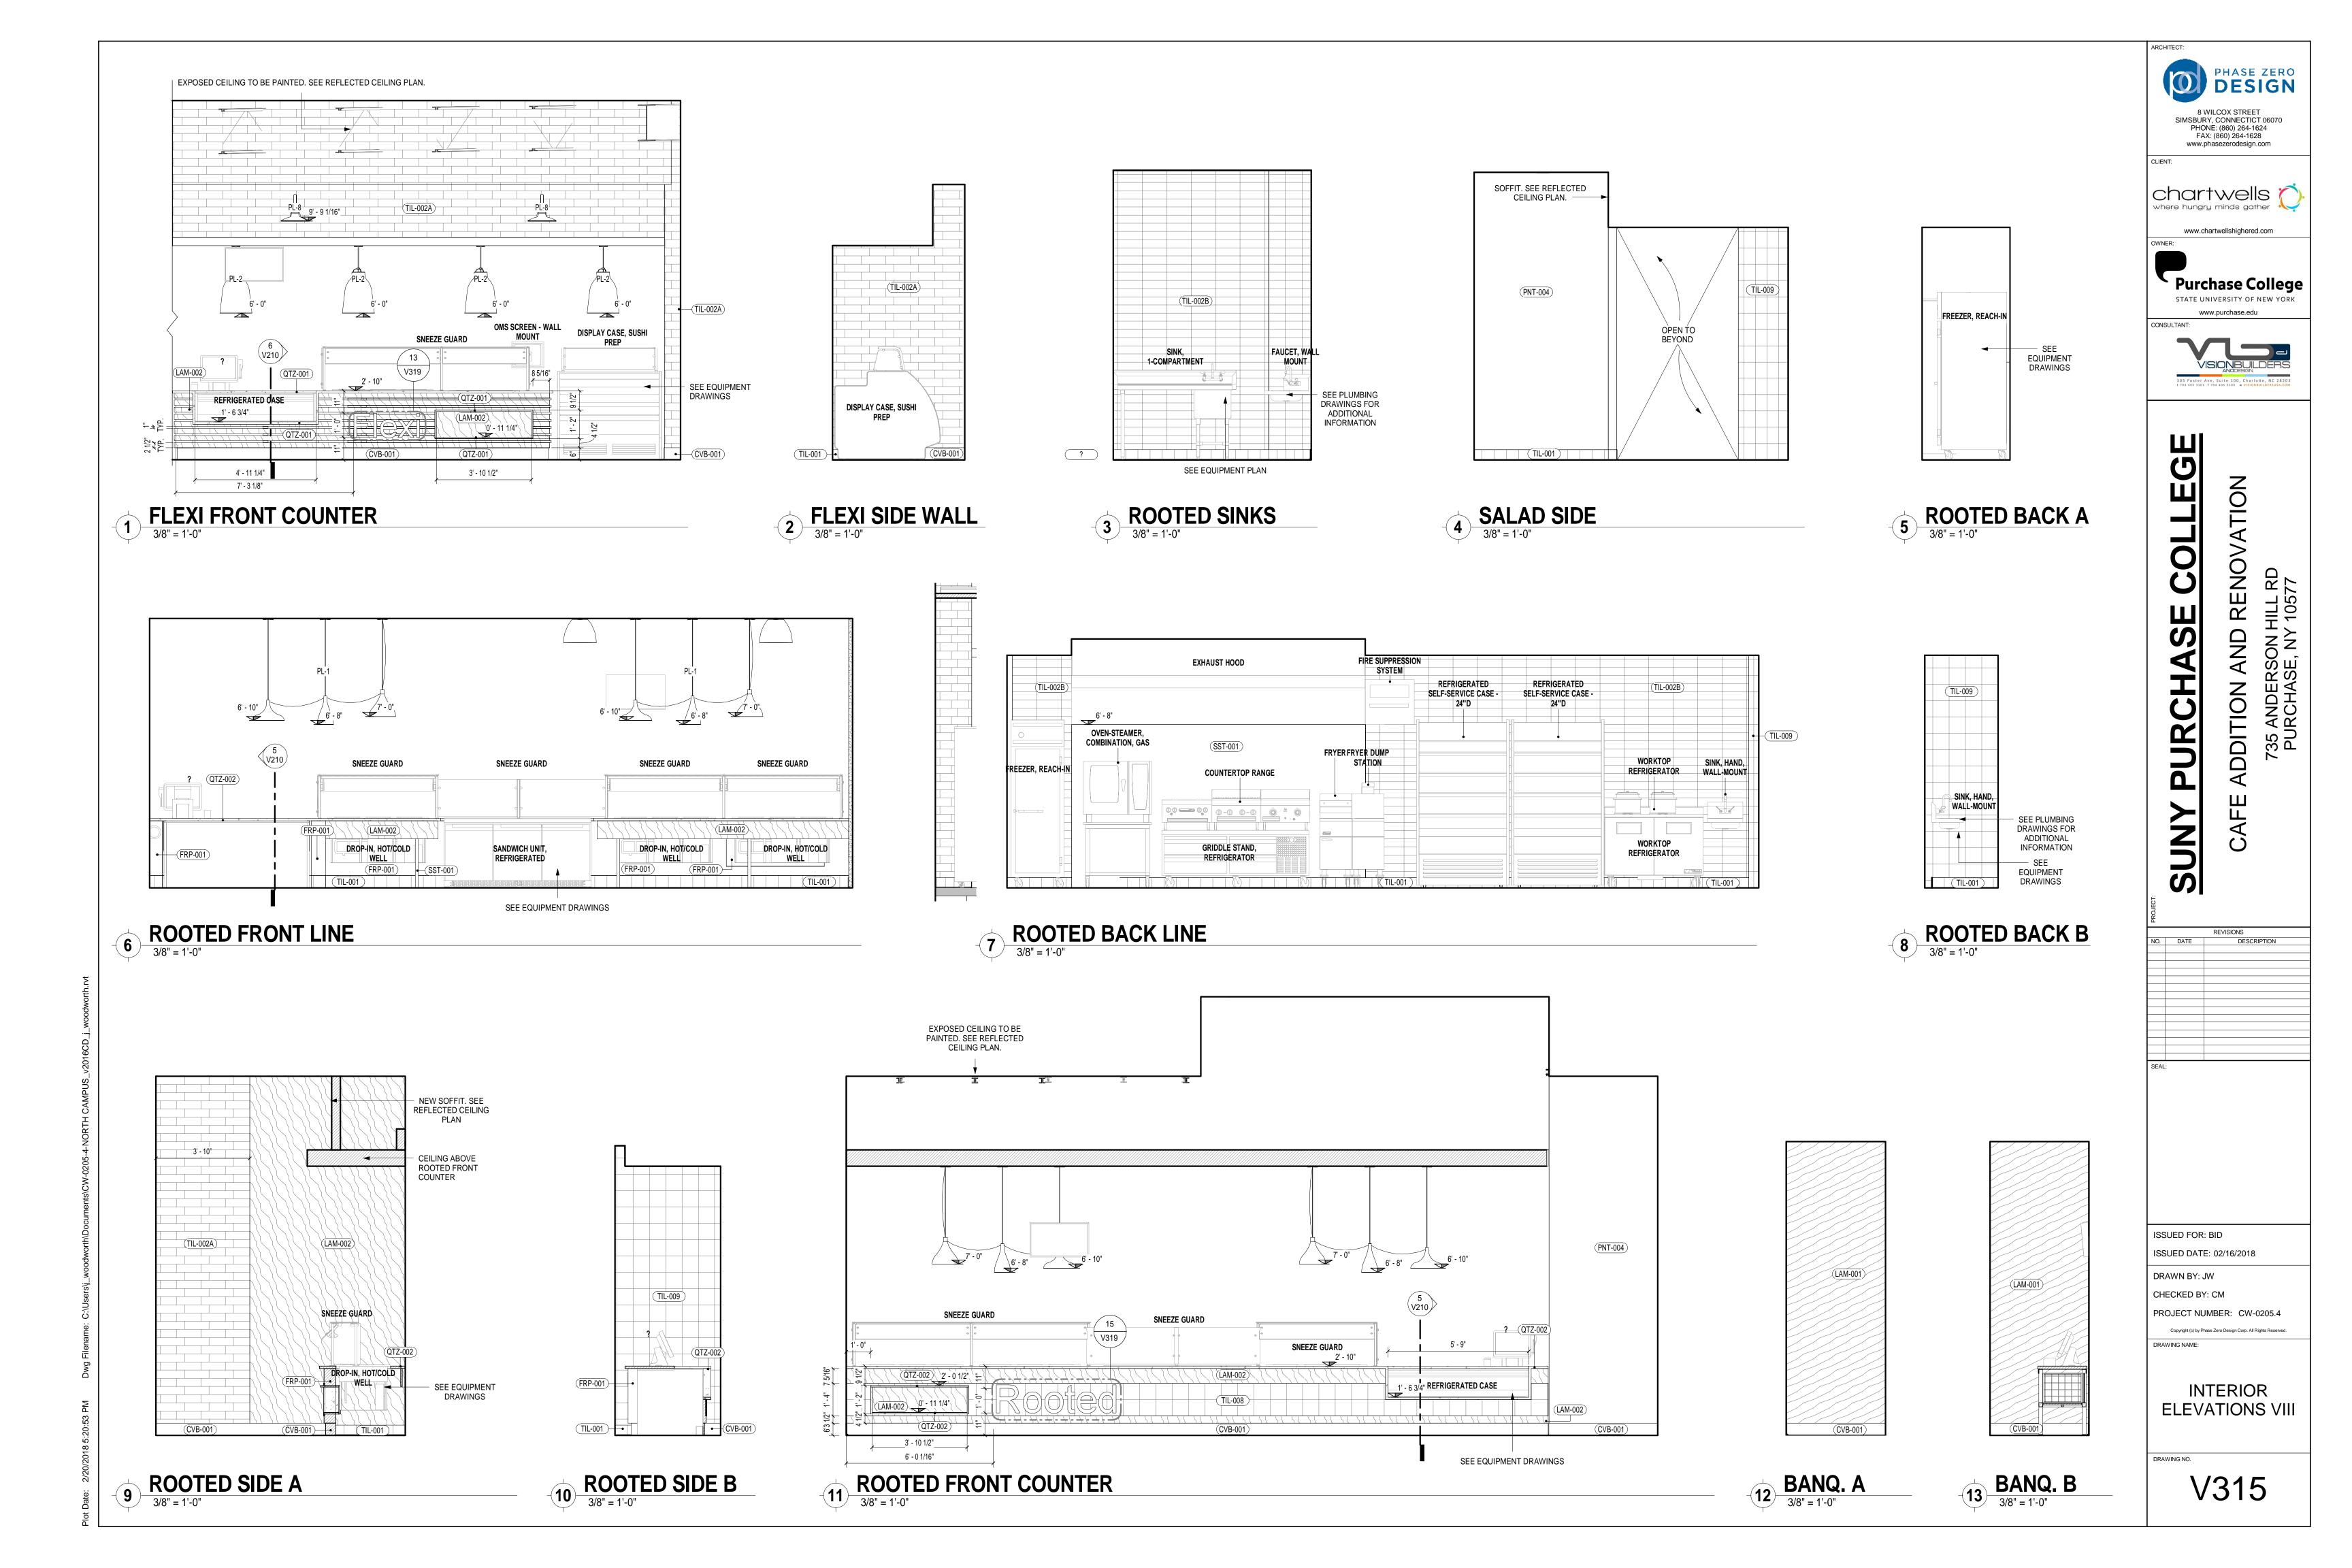

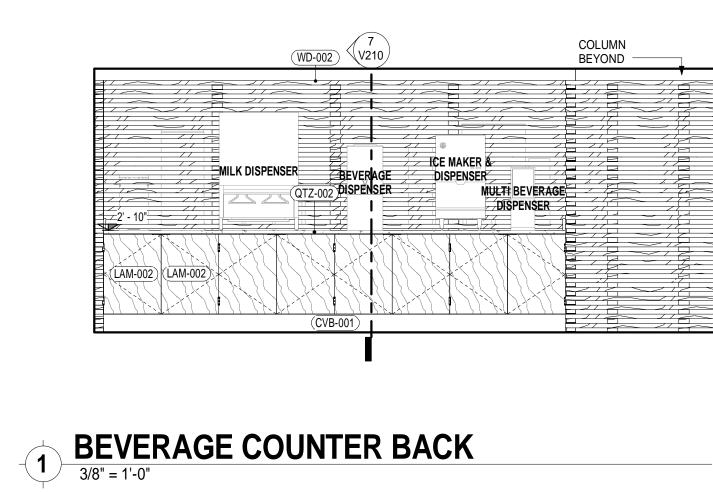



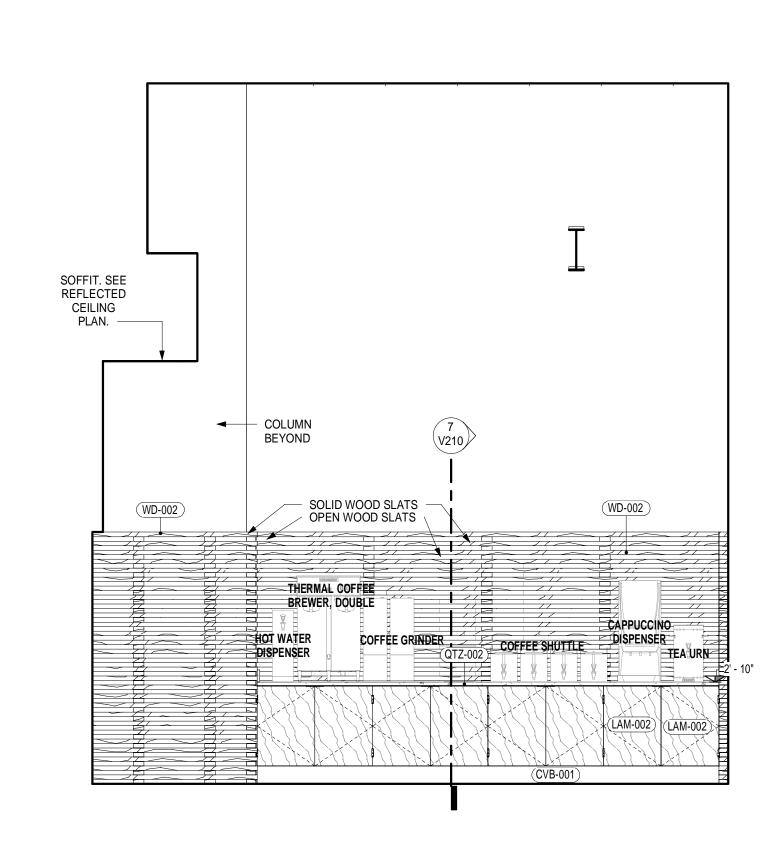





ADDITION AND RENOVATION

**PURCHA** 


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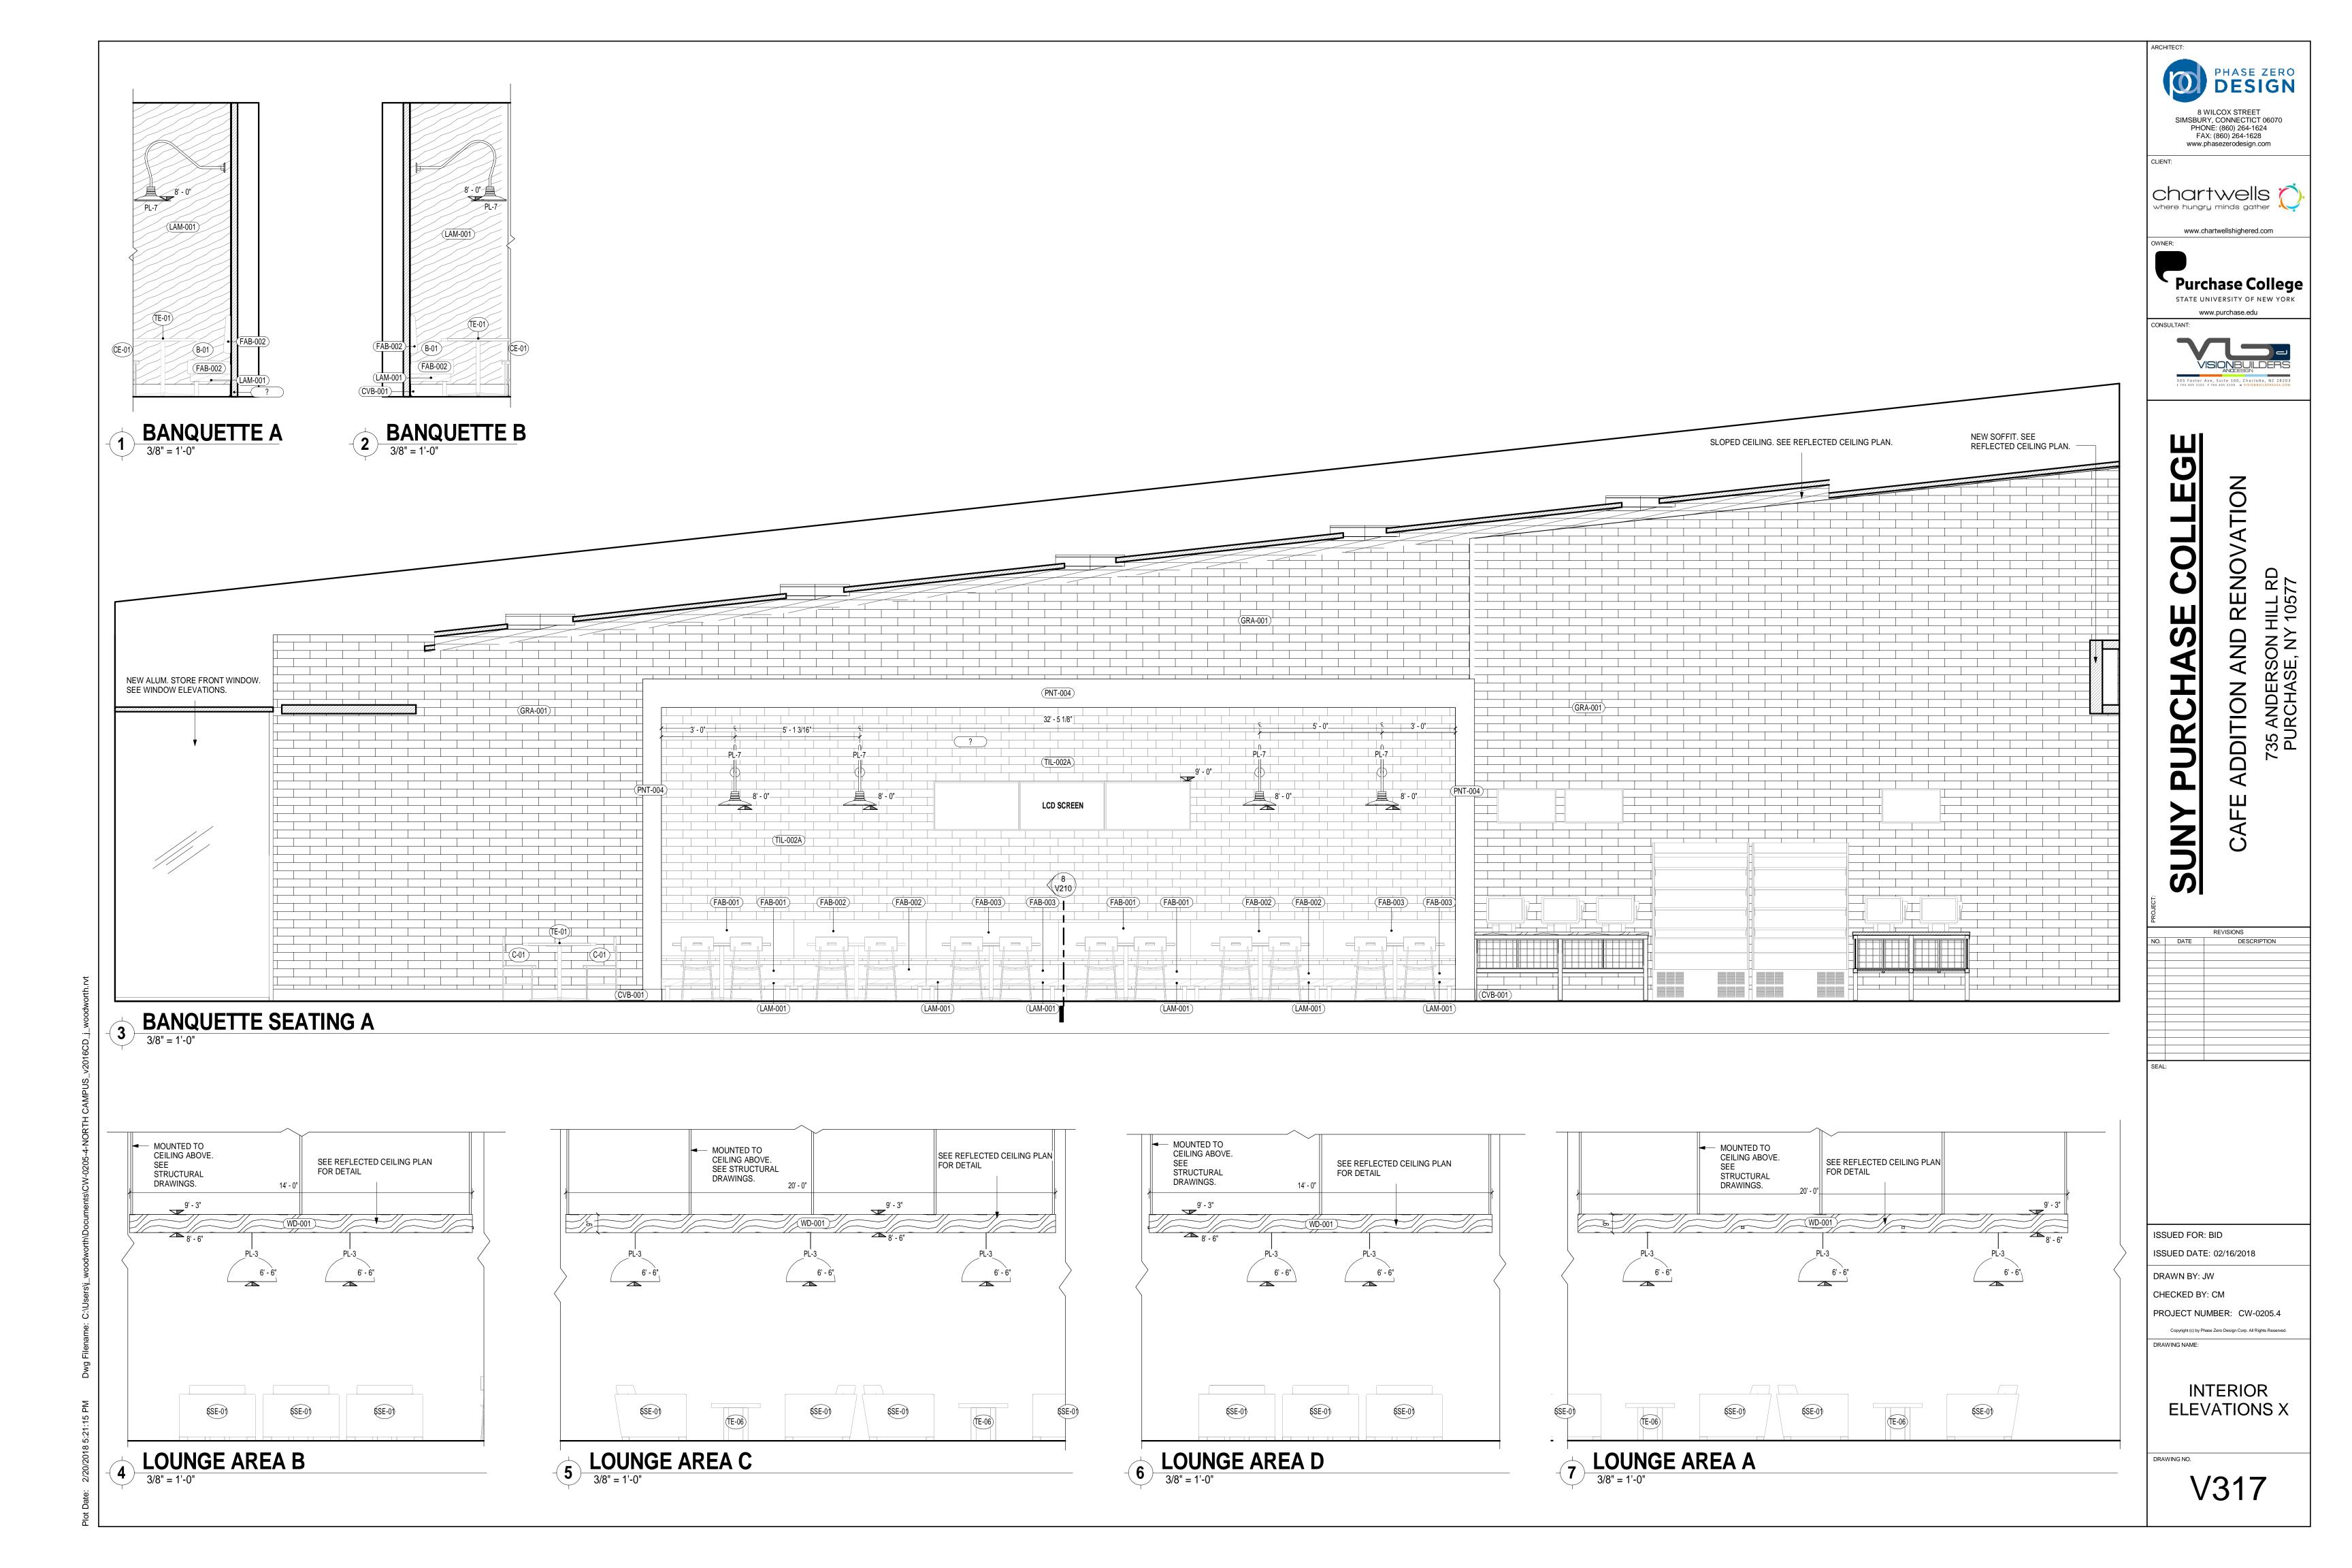
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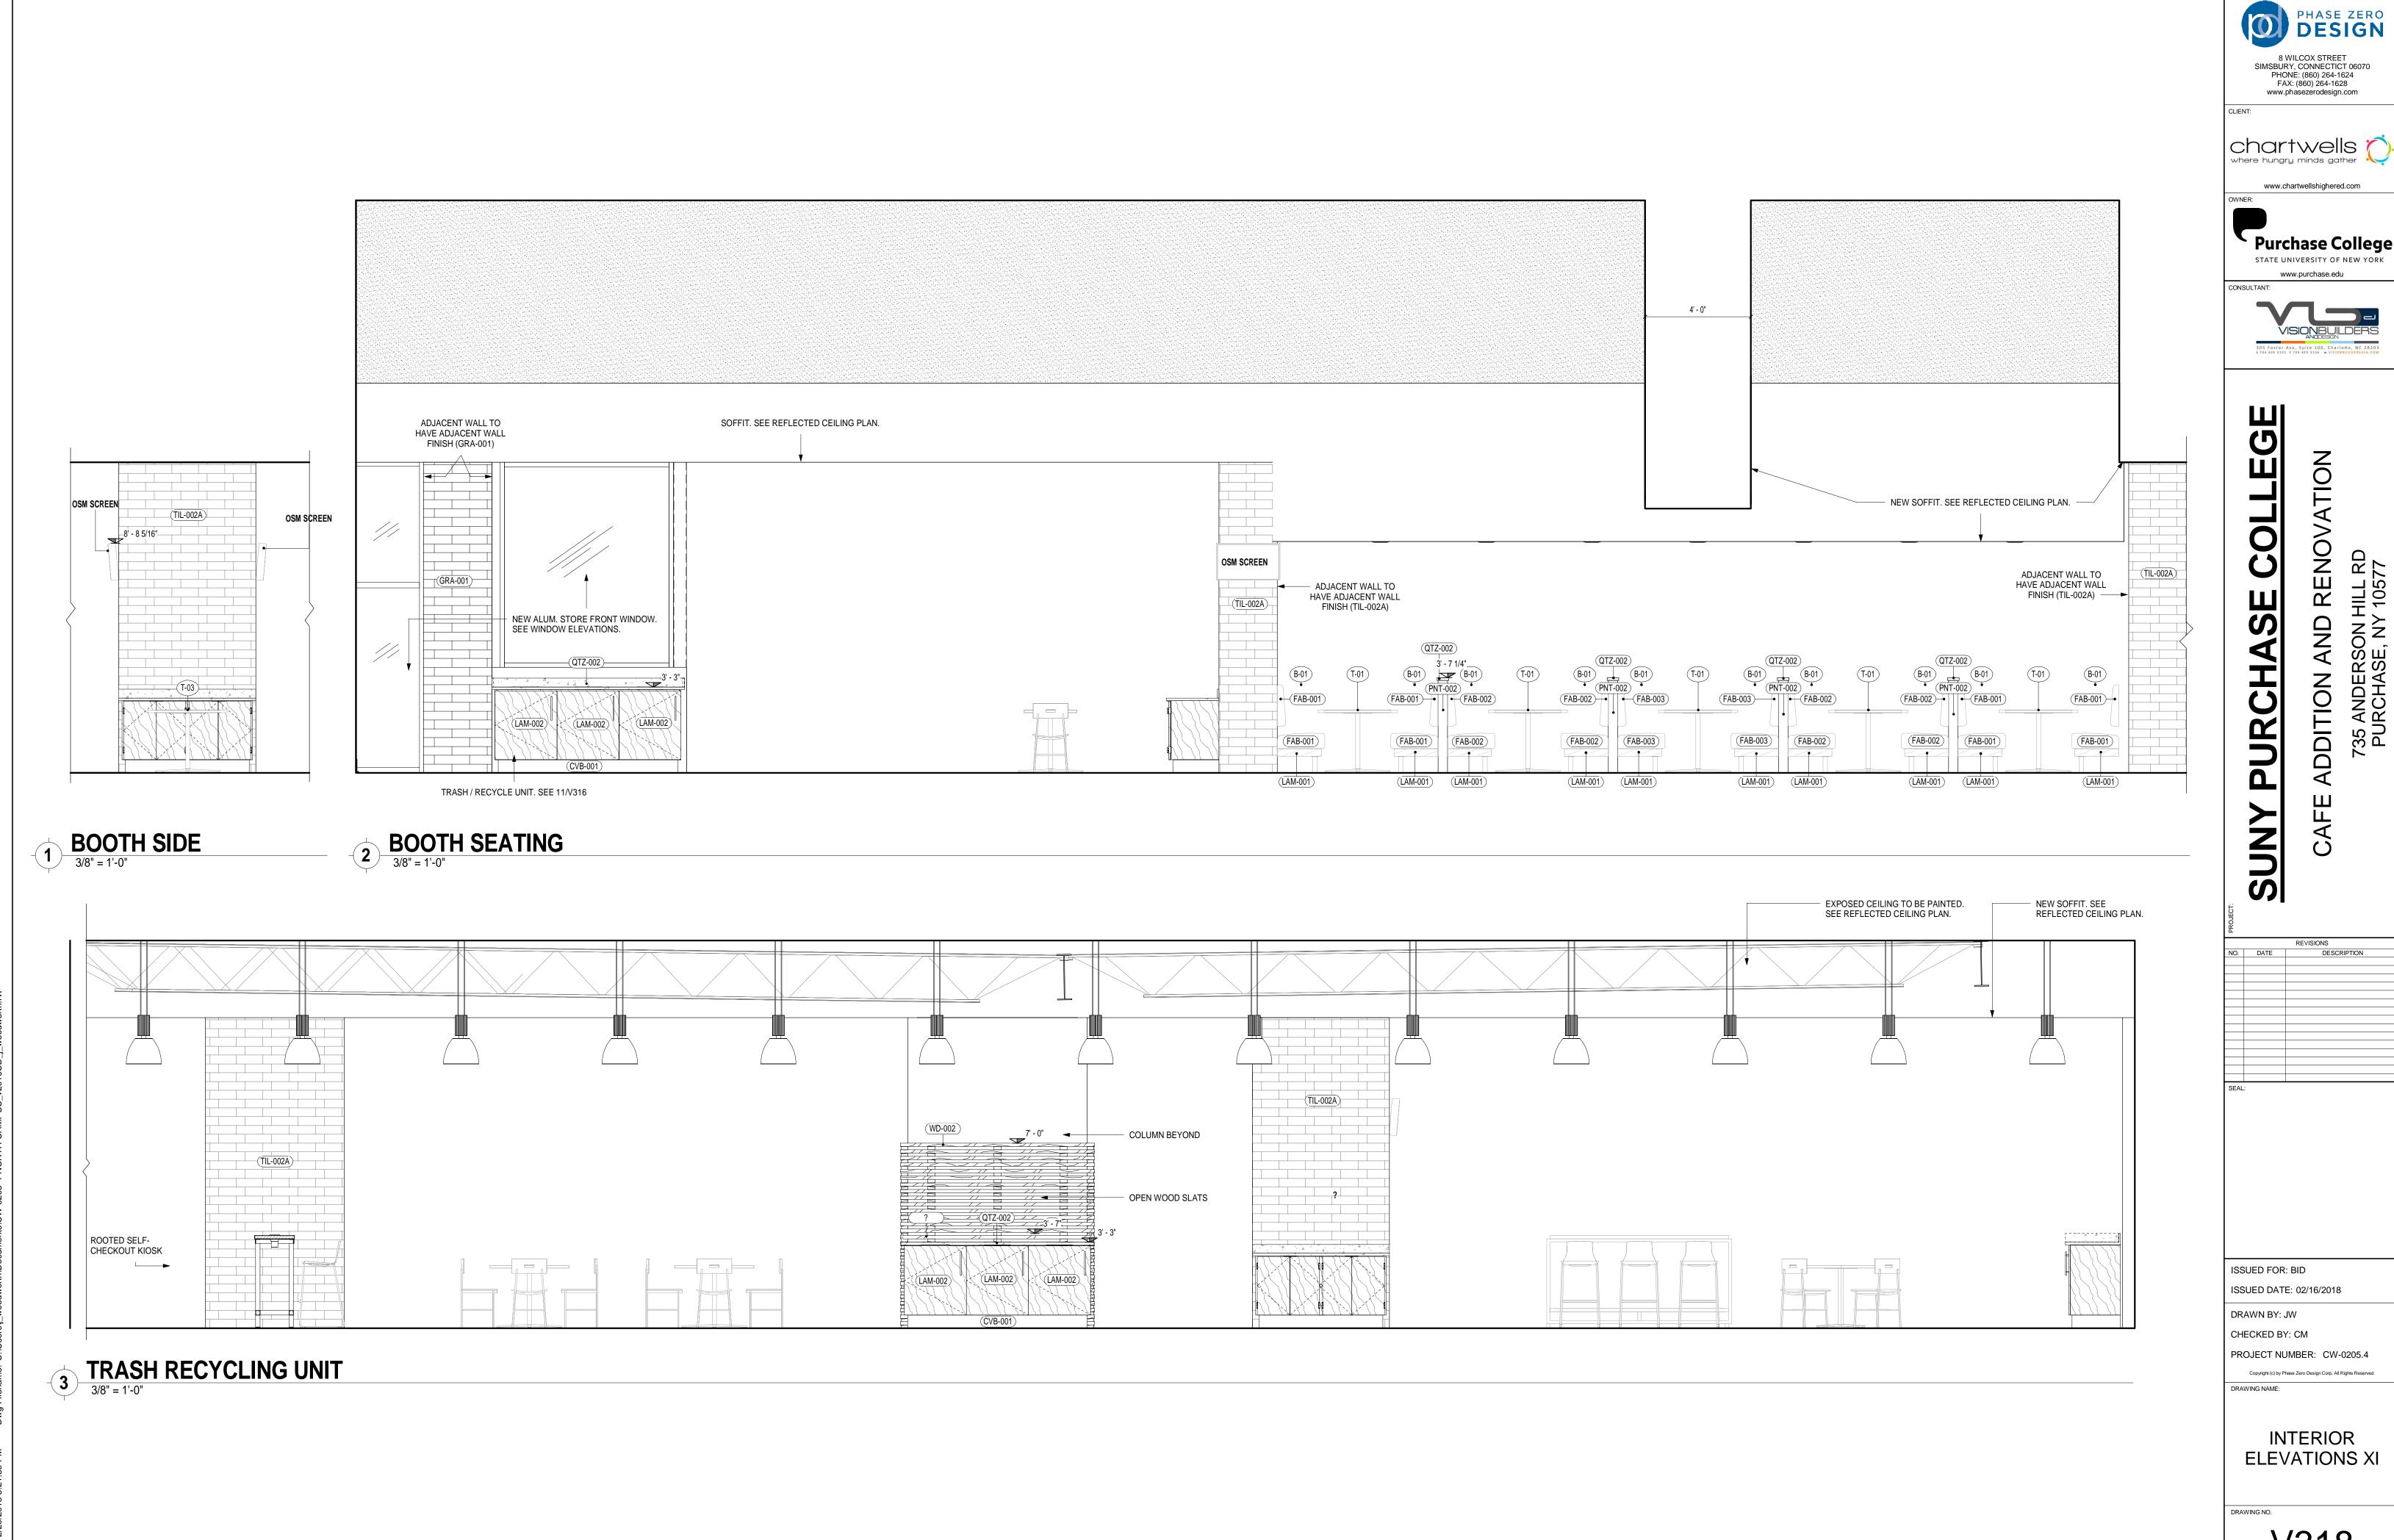
ISSUED DATE: 02/16/2018 DRAWN BY: JW

CHECKED BY: CM PROJECT NUMBER: CW-0205.4


INTERIOR **ELEVATIONS IX** 







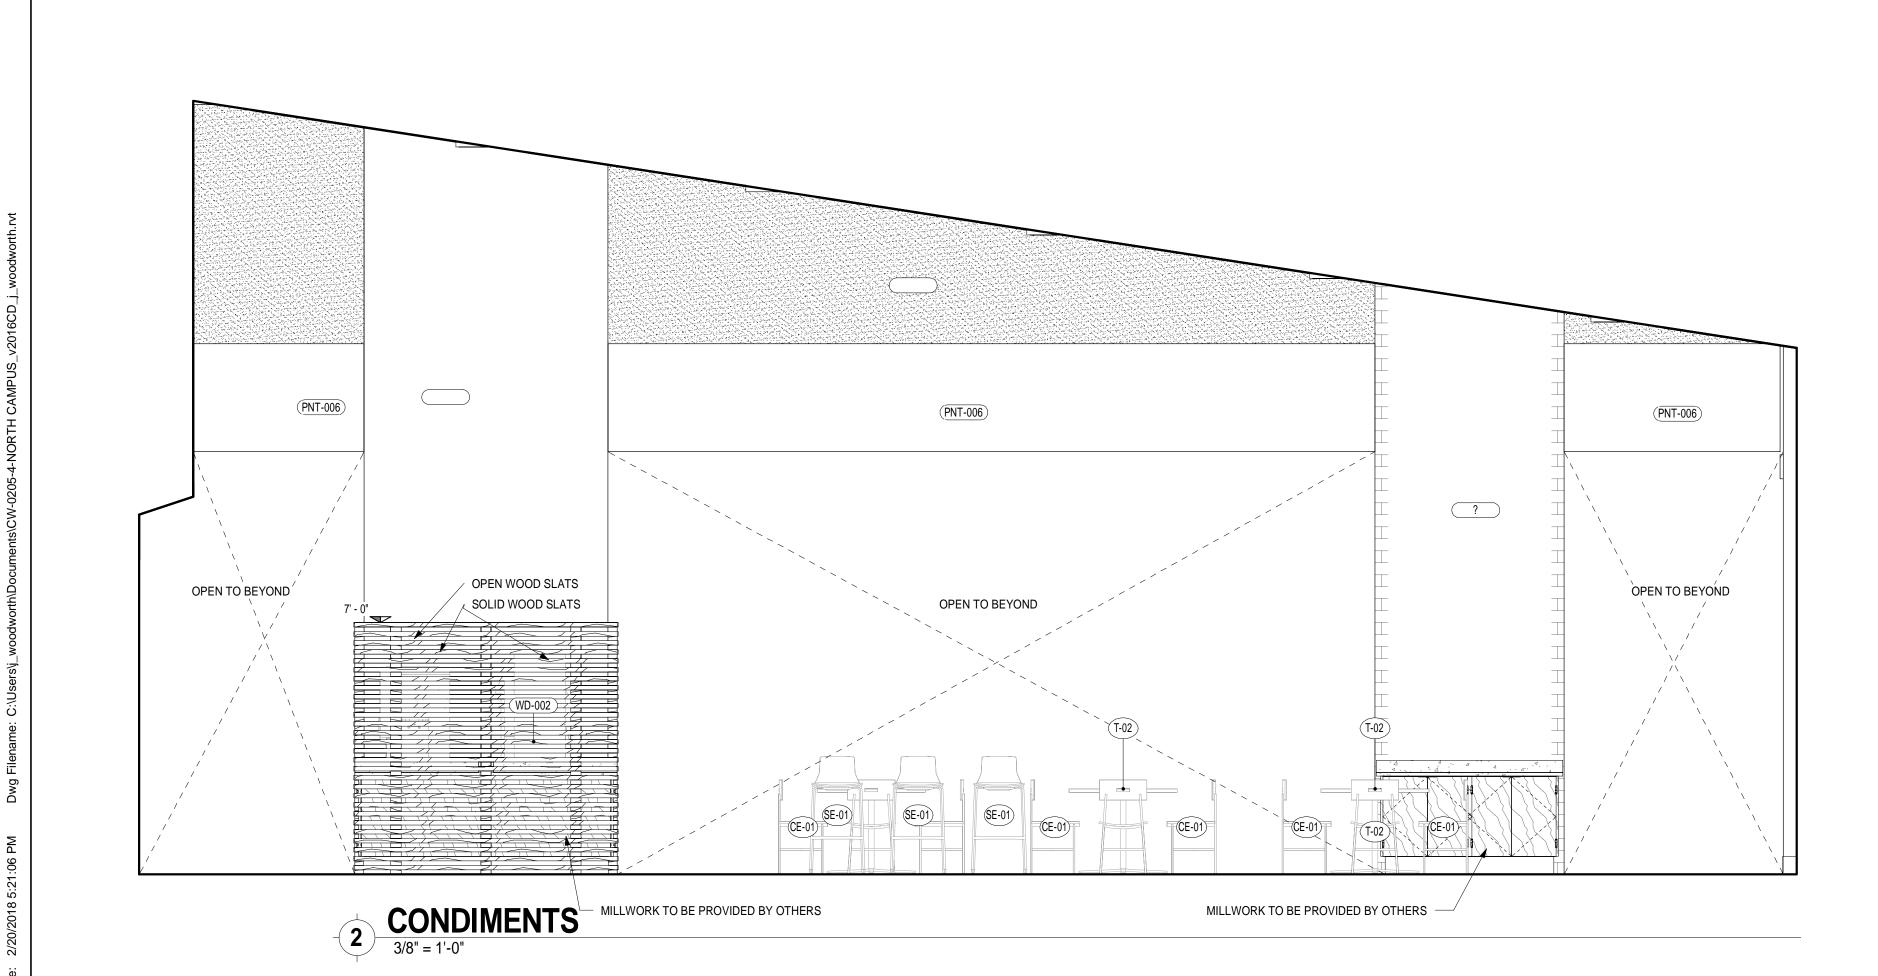

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REVISIONS
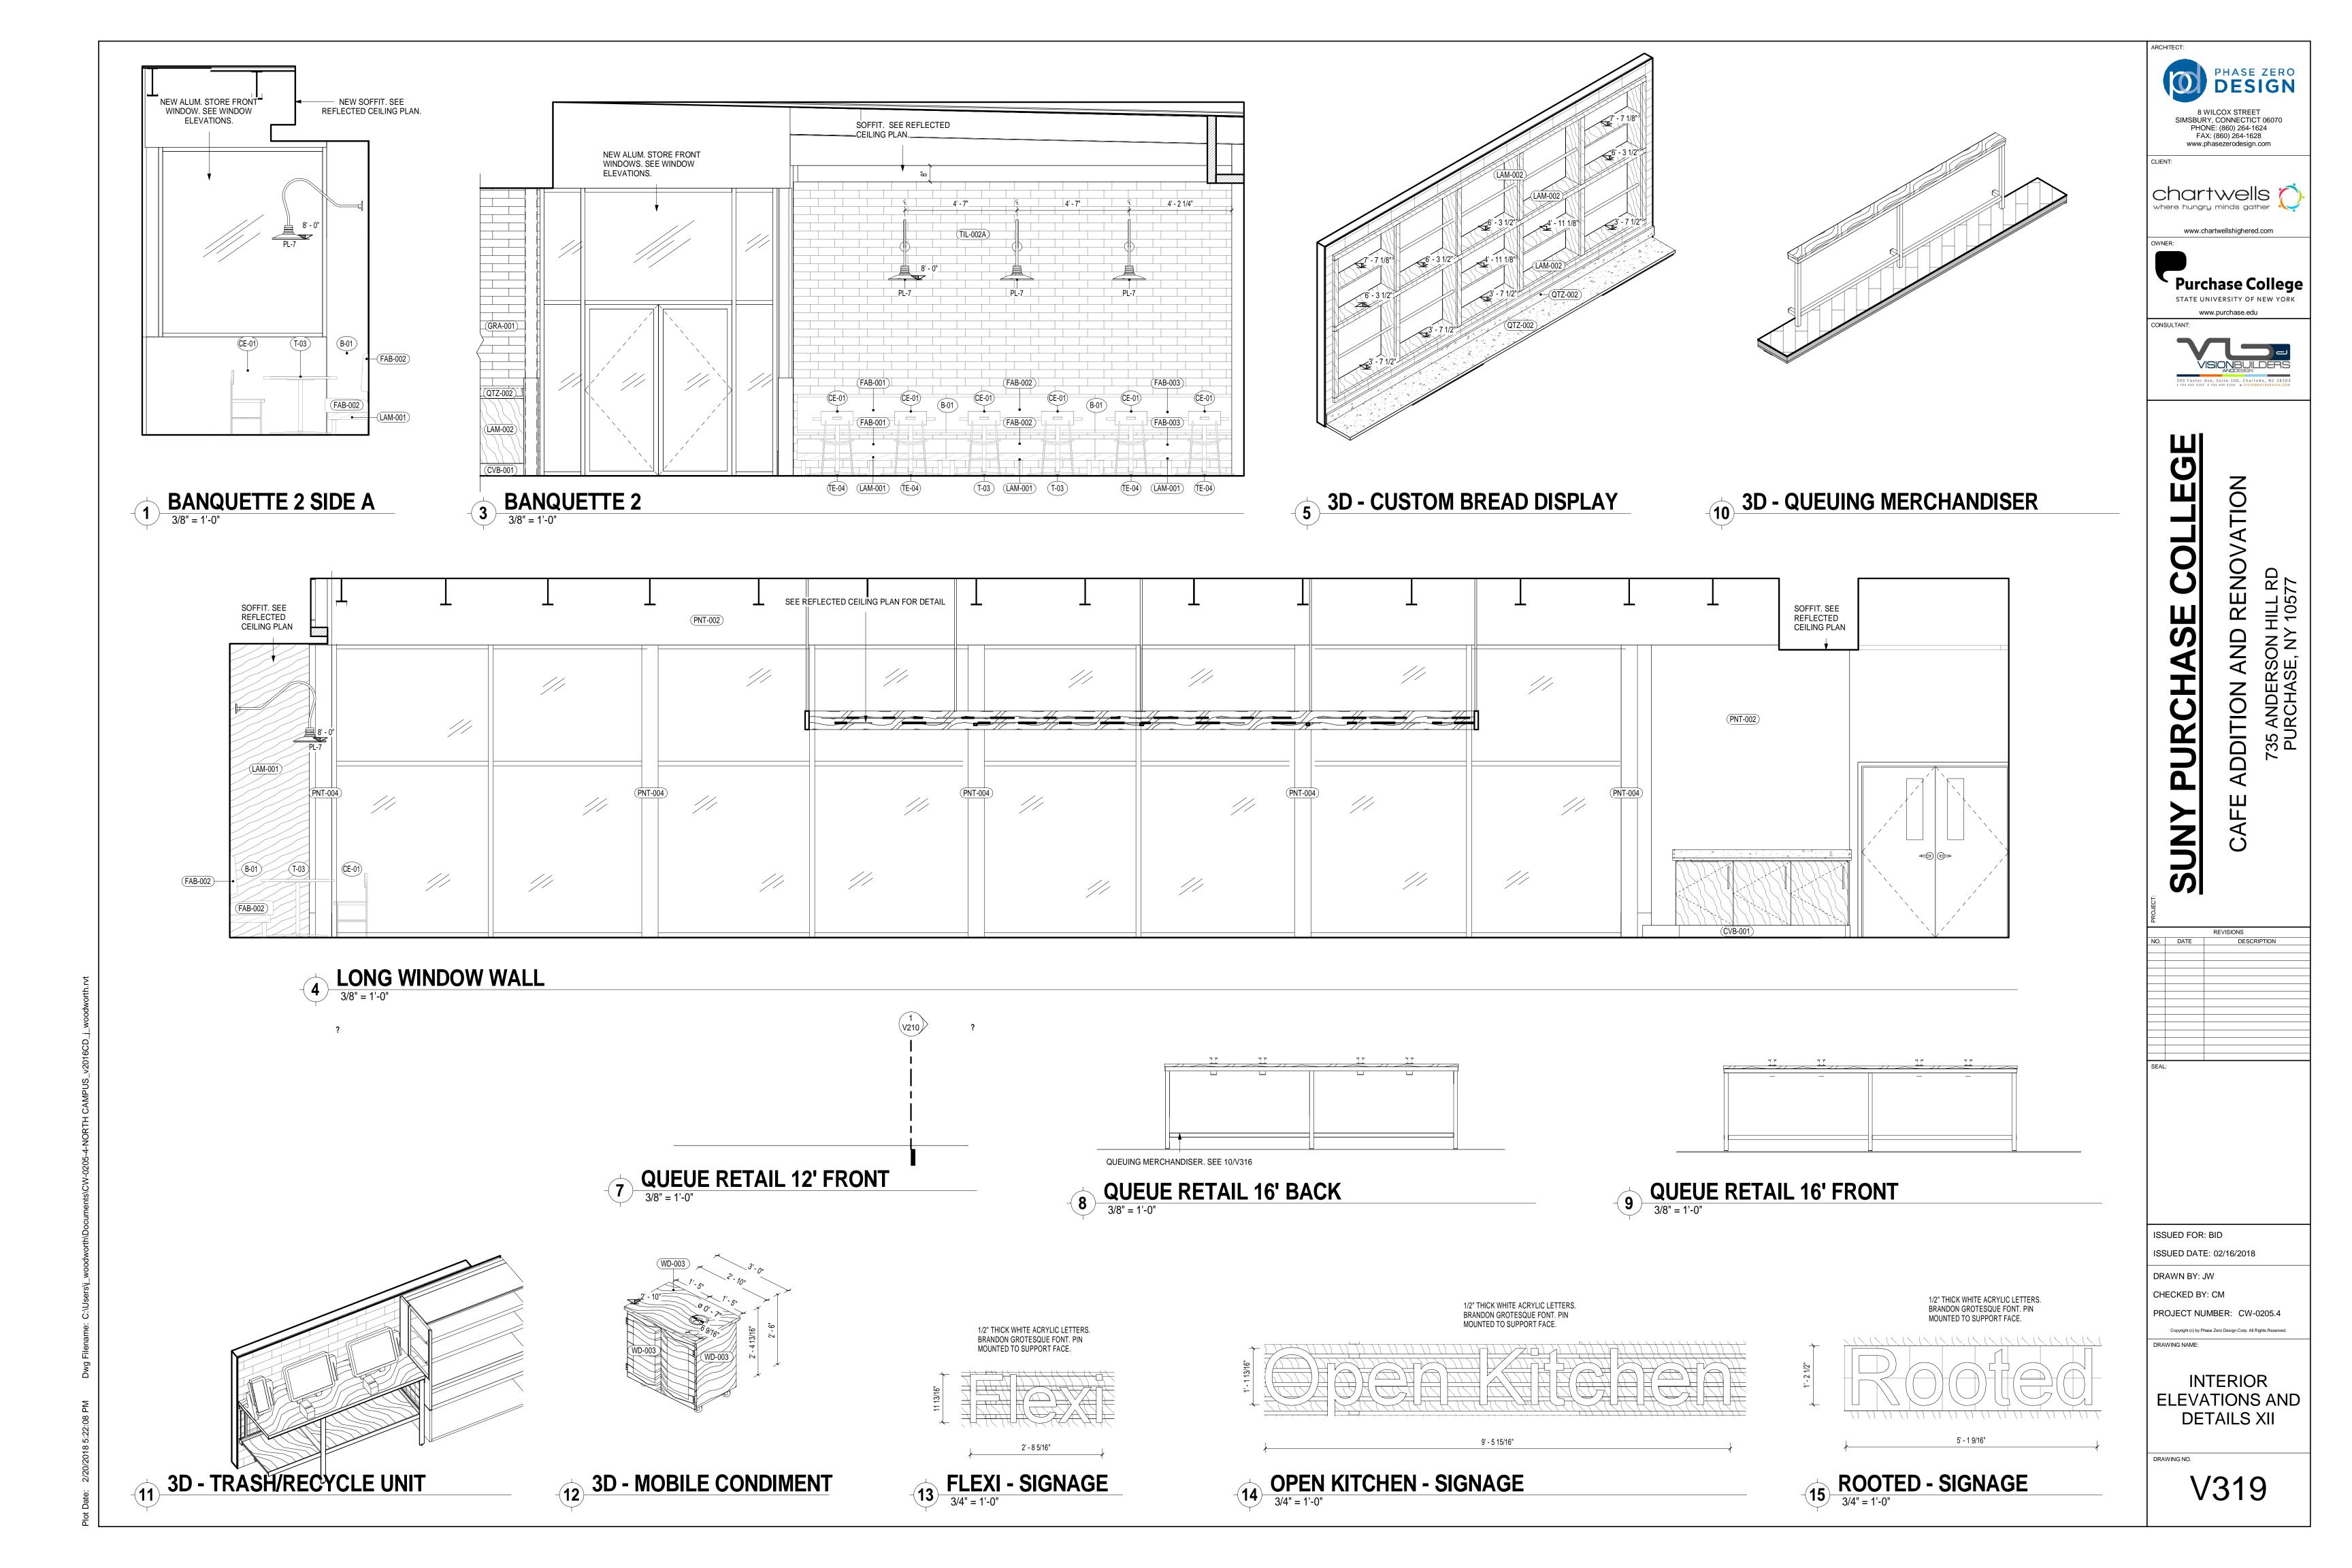
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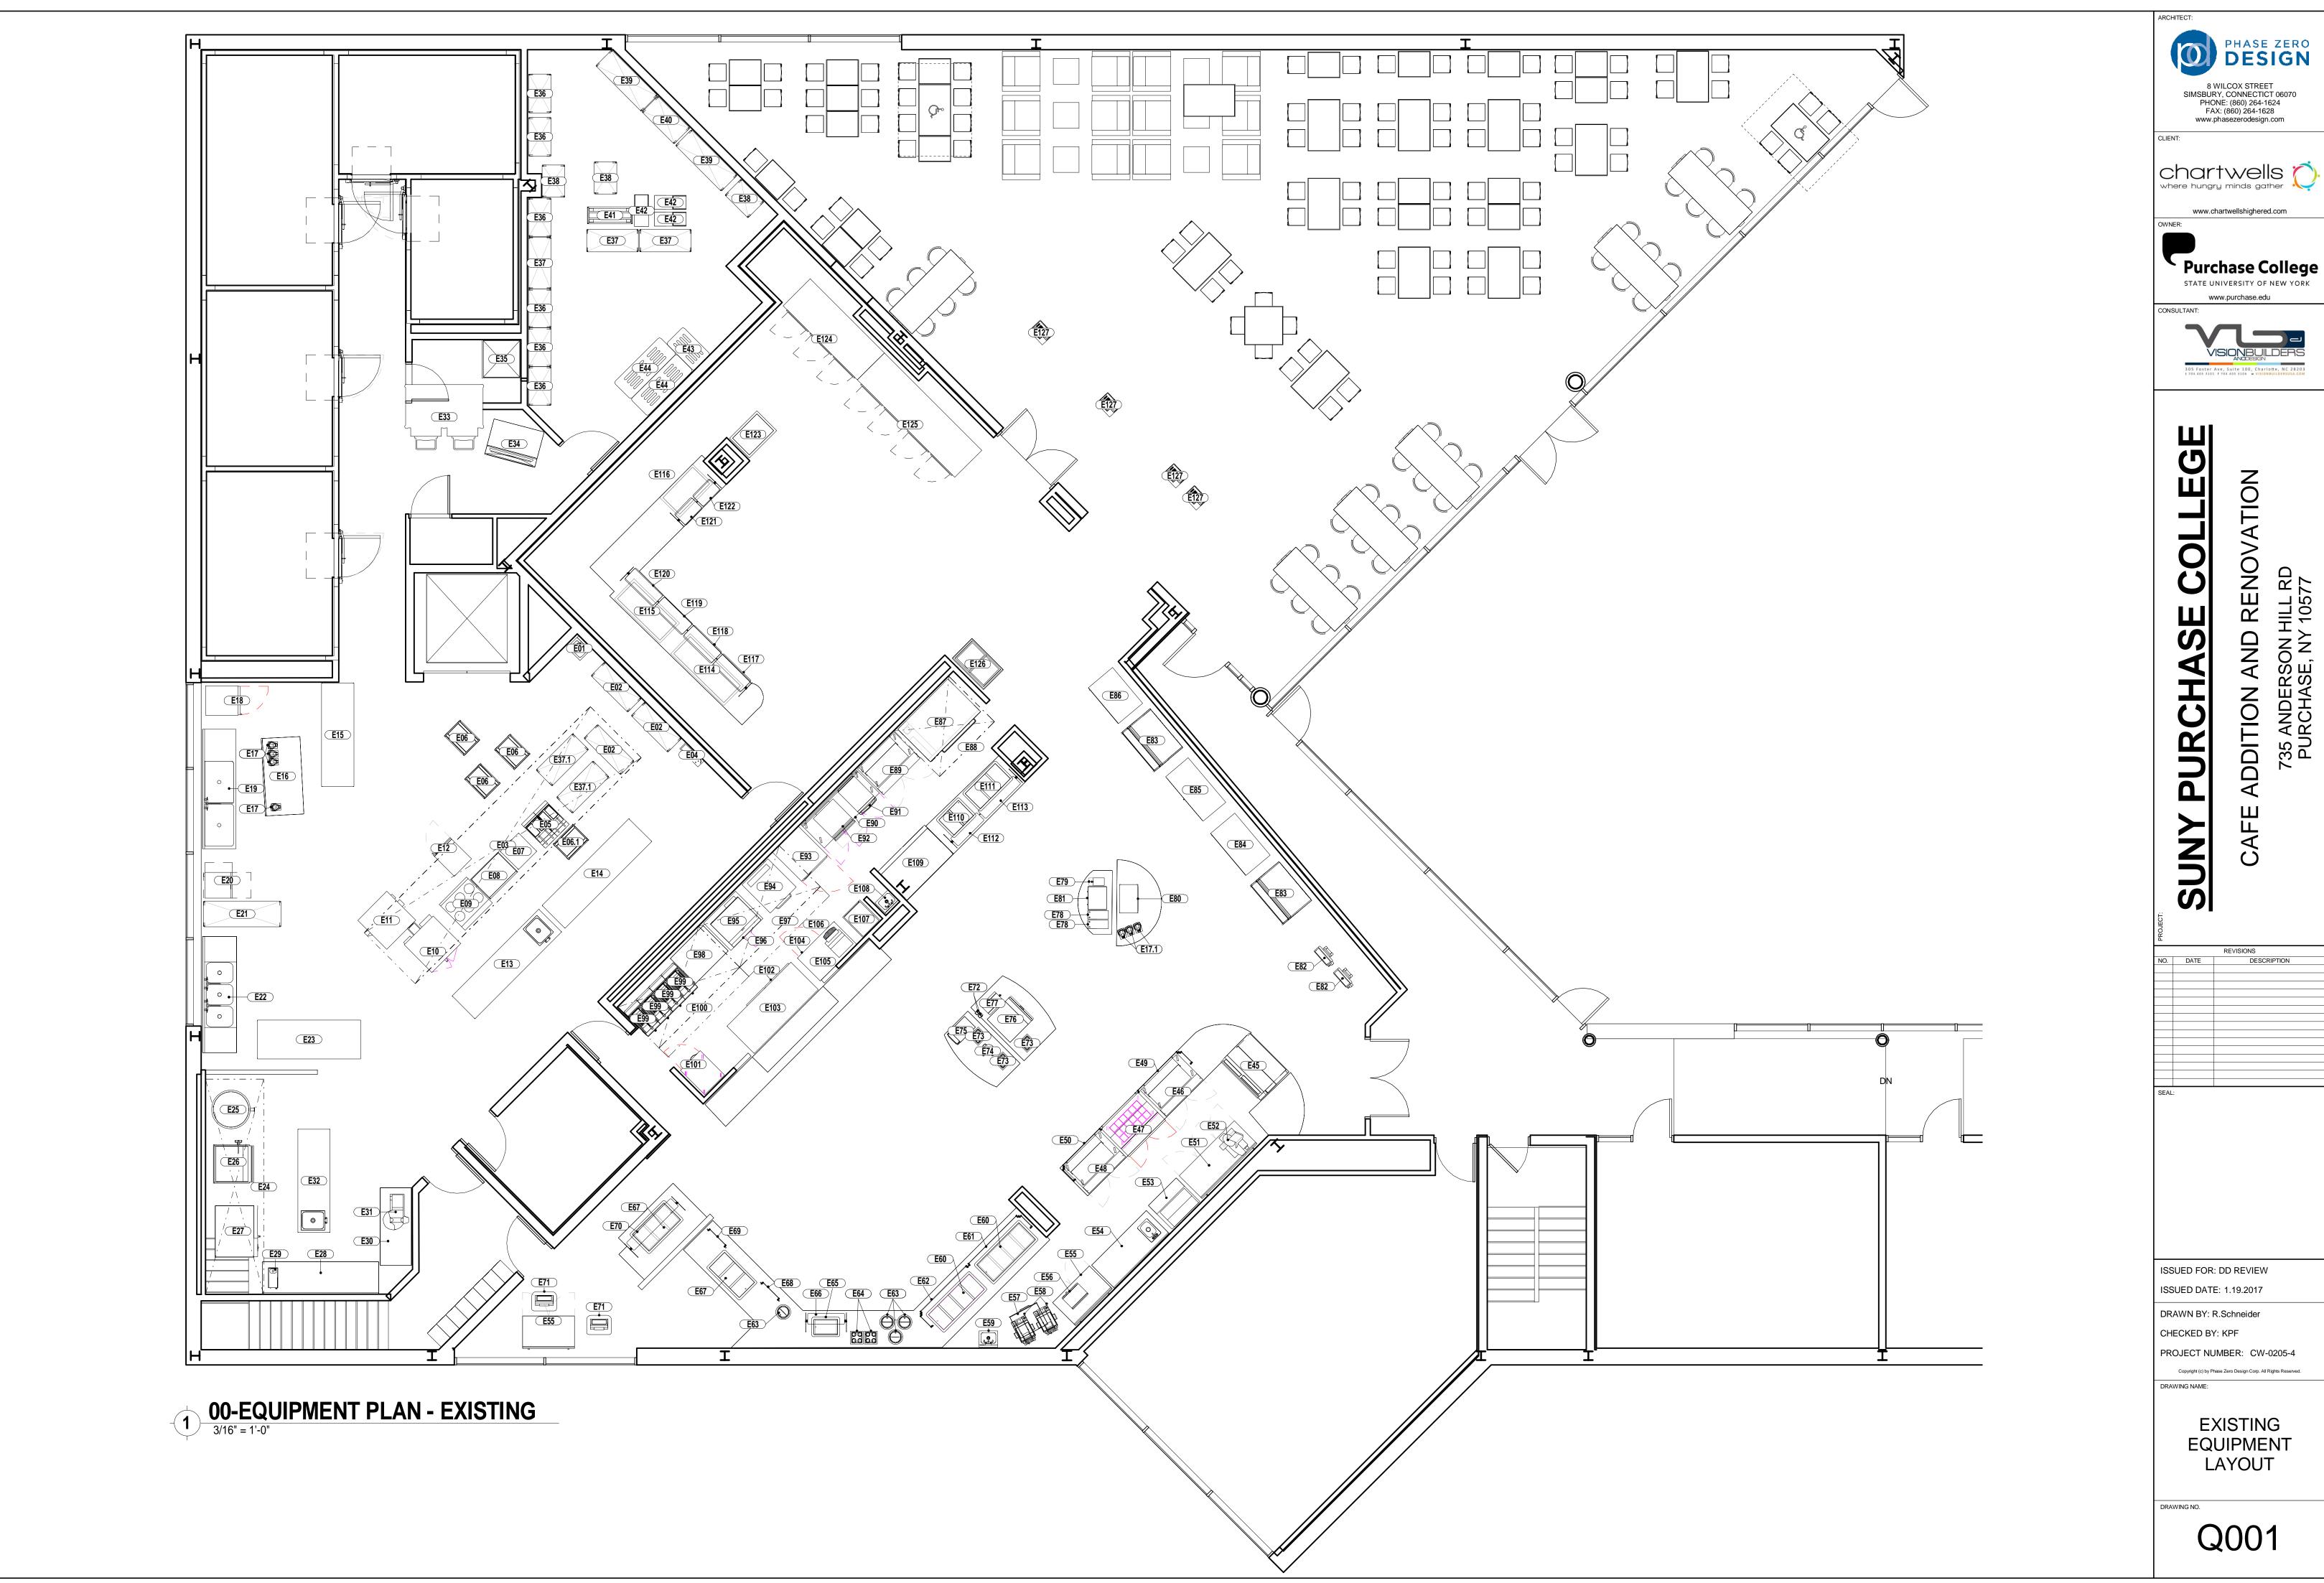
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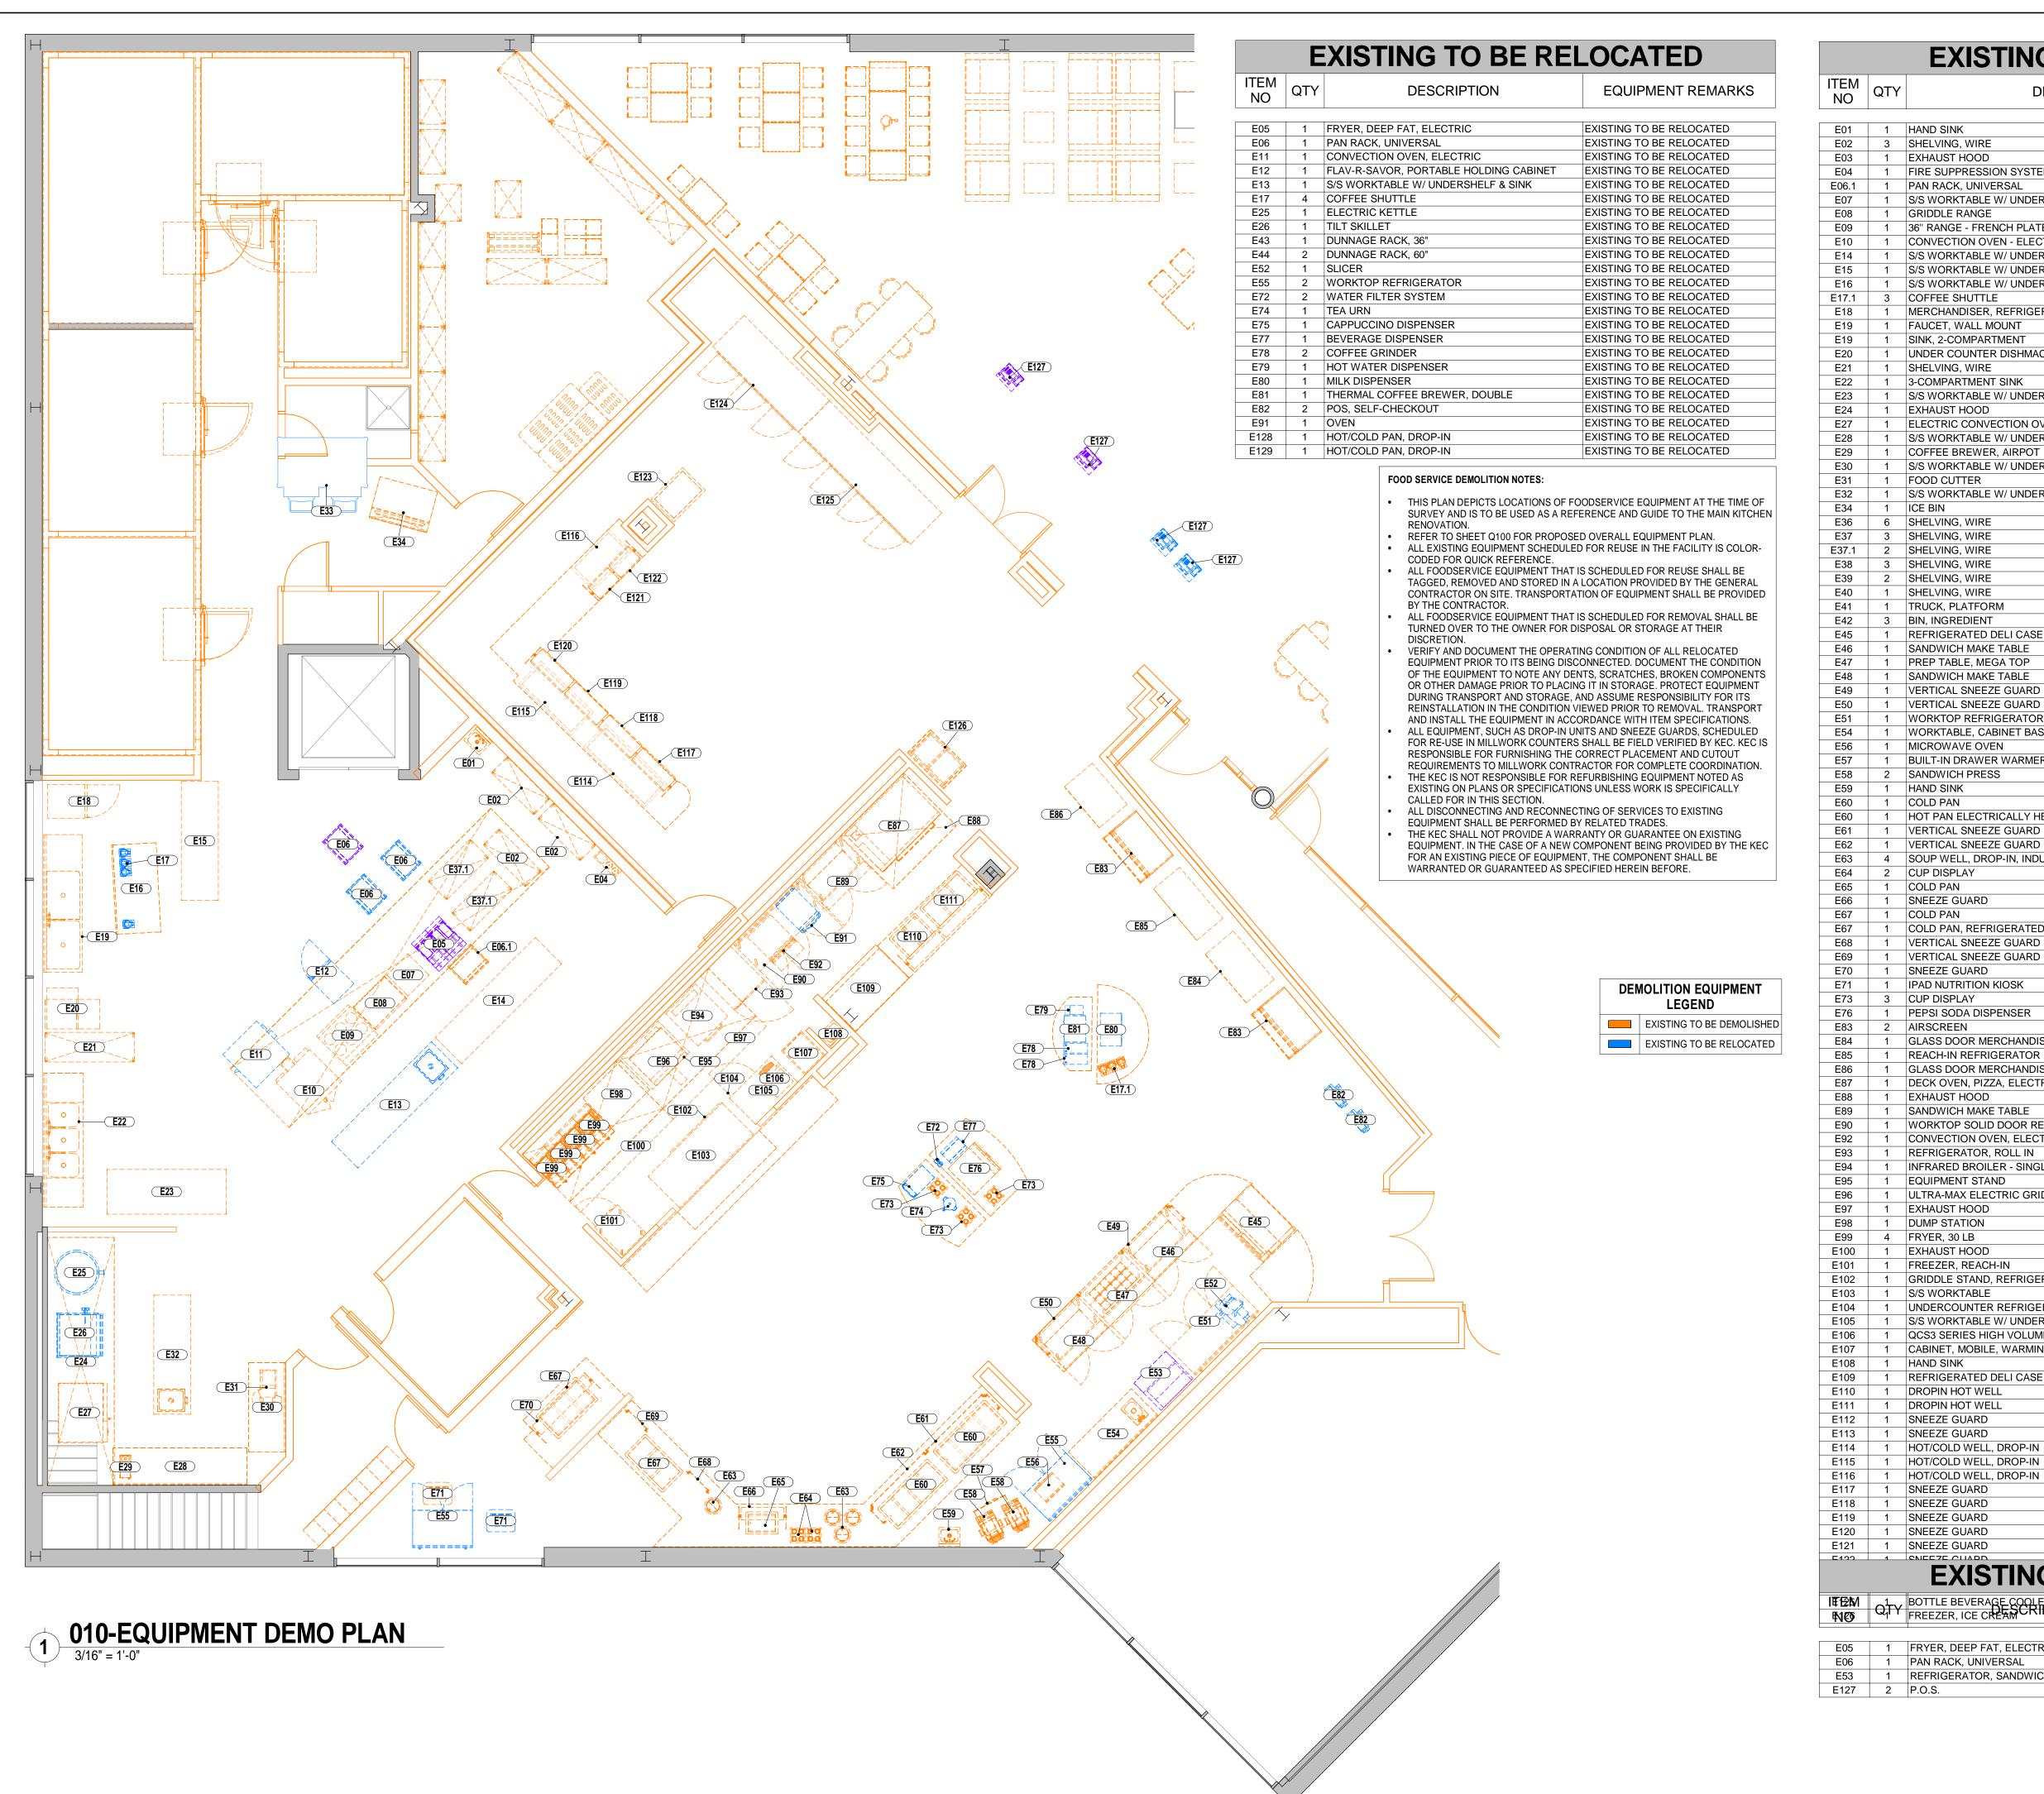
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CHECKED BY: Checker
PROJECT NUMBER: CW-0205.4

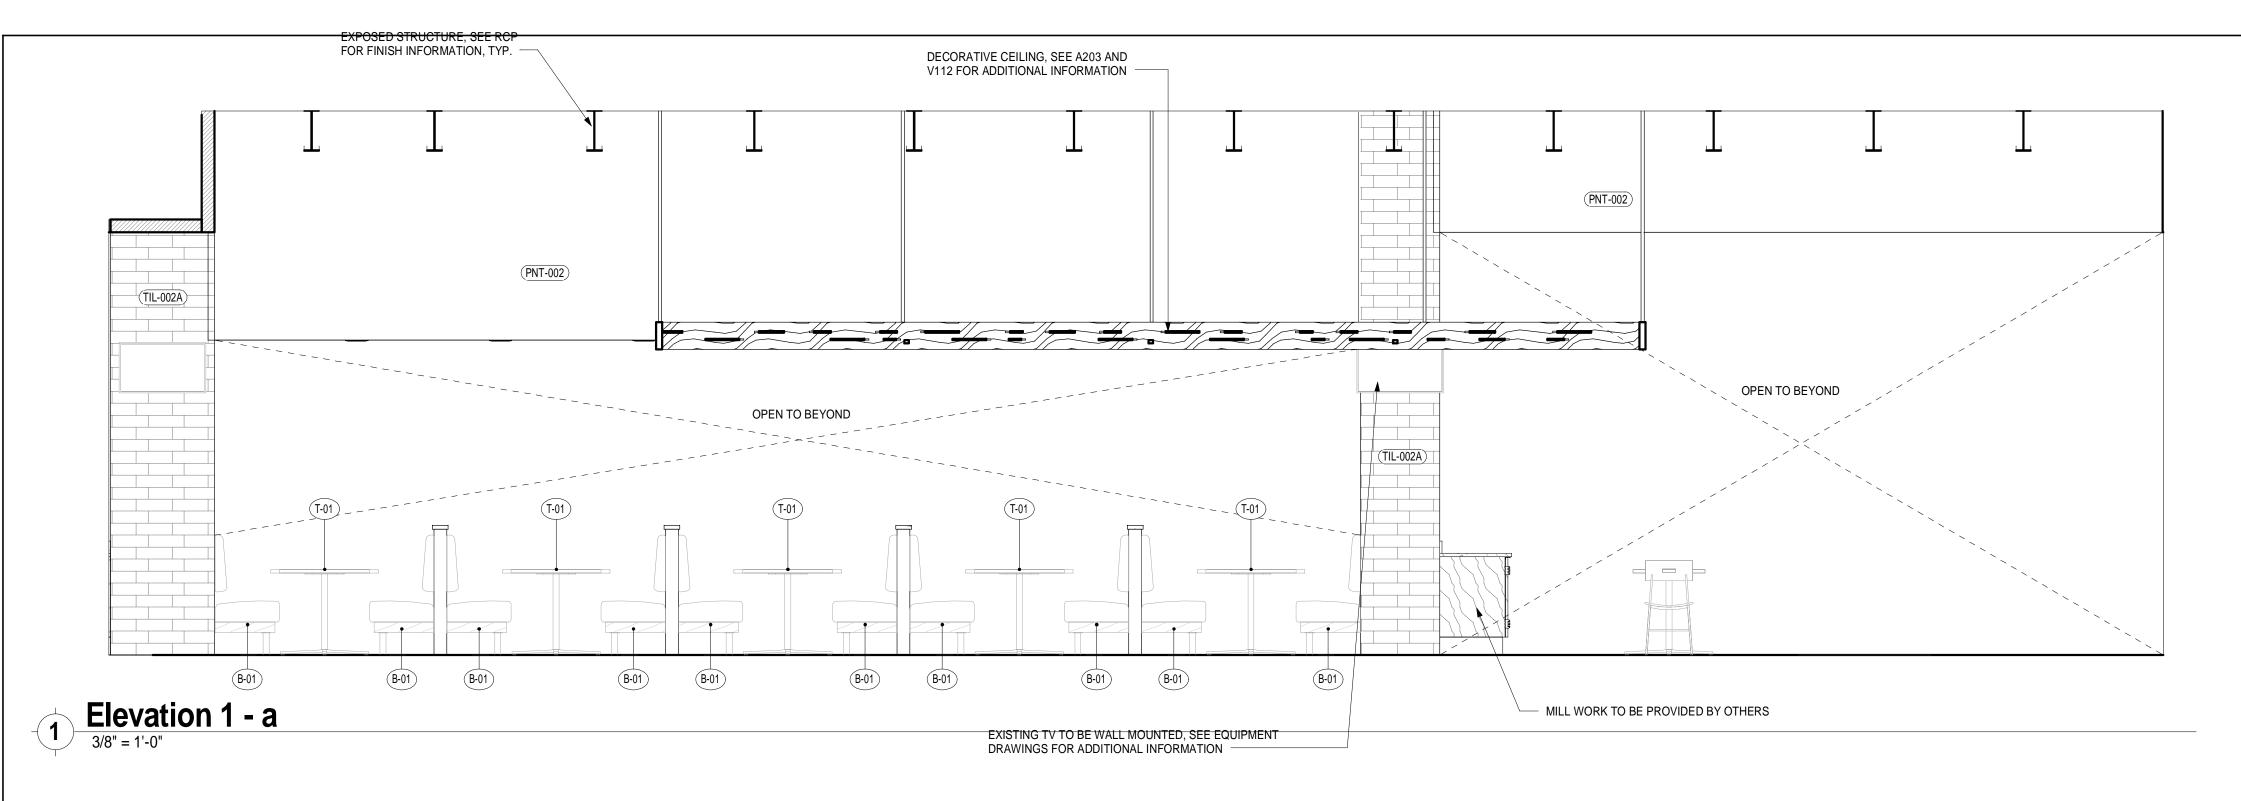INTERIOR ELEVATIONS XIII
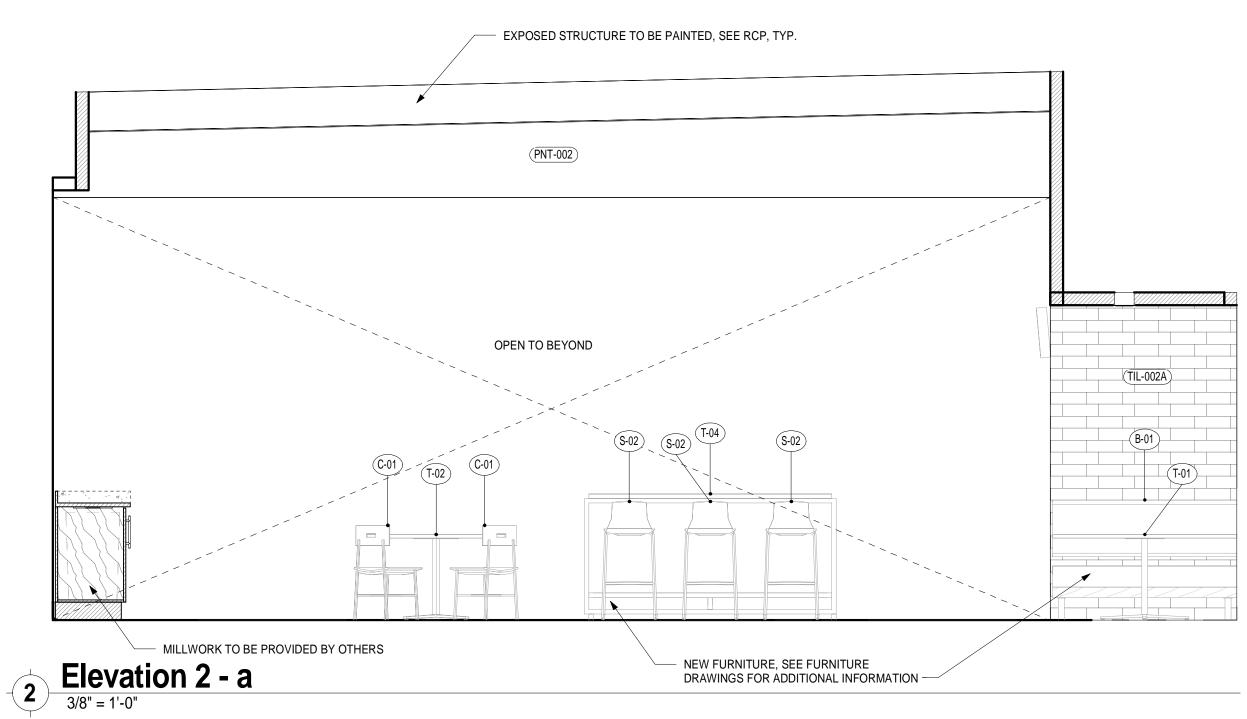
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DRAWING NO





ITEM NO	QTY	DESCRIPTION	EQUIPMENT REMAR
E01	1	HAND SINK	EXISTING TO BE DEMOLISHED
E02	3	SHELVING, WIRE	EXISTING TO BE DEMOLISHED
E03 E04	1	EXHAUST HOOD FIRE SUPPRESSION SYSTEM	EXISTING TO BE DEMOLISHED EXISTING TO BE DEMOLISHED
E06.1	1	PAN RACK, UNIVERSAL	EXISTING TO BE DEMOLISHED
E07 E08	1	S/S WORKTABLE W/ UNDERSHELF GRIDDLE RANGE	EXISTING TO BE DEMOLISHED EXISTING TO BE DEMOLISHED
E09	1	36" RANGE - FRENCH PLATE - STANDARD OVEN	EXISTING TO BE DEMOLISHED
E10 E14	1	CONVECTION OVEN - ELECTRIC - SINGLE DECK S/S WORKTABLE W/ UNDERSHELF	EXISTING TO BE DEMOLISHED  EXISTING TO BE DEMOLISHED
E15	1	S/S WORKTABLE W/ UNDERSHELF & SINK	EXISTING TO BE DEMOLISHED
E16 E17.1	1	S/S WORKTABLE W/ UNDERSHELF & BACKSPLASH COFFEE SHUTTLE	EXISTING TO BE DEMOLISHED EXISTING TO BE DEMOLISHED
E18	1	MERCHANDISER, REFRIGERATOR	EXISTING TO BE DEMOLISHED
E19 E19	1	FAUCET, WALL MOUNT SINK, 2-COMPARTMENT	EXISTING TO BE DEMOLISHED EXISTING TO BE DEMOLISHED
E20	1	UNDER COUNTER DISHMACHINE	EXISTING TO BE DEMOLISHED
E21	1	SHELVING, WIRE	EXISTING TO BE DEMOLISHED
E22 E23	1	3-COMPARTMENT SINK S/S WORKTABLE W/ UNDERSHELF	EXISTING TO BE DEMOLISHED EXISTING TO BE DEMOLISHED
E24	1	EXHAUST HOOD	EXISTING TO BE DEMOLISHED
E27 E28	1	ELECTRIC CONVECTION OVEN S/S WORKTABLE W/ UNDERSHELF & BACKSPLASH	EXISTING TO BE DEMOLISHED EXISTING TO BE DEMOLISHED
E29	1	COFFEE BREWER, AIRPOT	EXISTING TO BE DEMOLISHED
E30 E31	1	S/S WORKTABLE W/ UNDERSHELF & BACKSPLASH FOOD CUTTER	EXISTING TO BE DEMOLISHED EXISTING TO BE DEMOLISHED
E32	1	S/S WORKTABLE W/ UNDERSHELF & SINK	EXISTING TO BE DEMOLISHED
E34 E36	1	ICE BIN SHELVING, WIRE	EXISTING TO BE DEMOLISHED EXISTING TO BE DEMOLISHED
E37	3	SHELVING, WIRE	EXISTING TO BE DEMOLISHED
E37.1 E38	3	SHELVING, WIRE SHELVING, WIRE	EXISTING TO BE DEMOLISHED EXISTING TO BE DEMOLISHED
E39	2	SHELVING, WIRE	EXISTING TO BE DEMOLISHED
E40	1	SHELVING, WIRE	EXISTING TO BE DEMOLISHED EXISTING TO BE DEMOLISHED
E41 E42	3	TRUCK, PLATFORM BIN, INGREDIENT	EXISTING TO BE DEMOLISHED
E45	1	REFRIGERATED DELI CASE	EXISTING TO BE DEMOLISHED
E46 E47	1	SANDWICH MAKE TABLE PREP TABLE, MEGA TOP	EXISTING TO BE DEMOLISHED EXISTING TO BE DEMOLISHED
E48	1	SANDWICH MAKE TABLE	EXISTING TO BE DEMOLISHED
E49 E50	1	VERTICAL SNEEZE GUARD  VERTICAL SNEEZE GUARD	EXISTING TO BE DEMOLISHED EXISTING TO BE DEMOLISHED
E51	1	WORKTOP REFRIGERATOR	EXISTING TO BE DEMOLISHED
E54 E56	1	WORKTABLE, CABINET BASE, HINGED DOORS MICROWAVE OVEN	EXISTING TO BE DEMOLISHED EXISTING TO BE DEMOLISHED
E57	1	BUILT-IN DRAWER WARMER	EXISTING TO BE DEMOLISHED
E58 E59	2	SANDWICH PRESS HAND SINK	EXISTING TO BE DEMOLISHED EXISTING TO BE DEMOLISHED
E60	1	COLD PAN	EXISTING TO BE DEMOLISHED
E60 E61	1	HOT PAN ELECTRICALLY HEATED-SINGLE CONTROL VERTICAL SNEEZE GUARD	EXISTING TO BE DEMOLISHED EXISTING TO BE DEMOLISHED
E62	1	VERTICAL SNEEZE GUARD	EXISTING TO BE DEMOLISHED
E63 E64	4 2	SOUP WELL, DROP-IN, INDUCTION CUP DISPLAY	EXISTING TO BE DEMOLISHED EXISTING TO BE DEMOLISHED
E65	1	COLD PAN	EXISTING TO BE DEMOLISHED
E66 E67	1	SNEEZE GUARD COLD PAN	EXISTING TO BE DEMOLISHED EXISTING TO BE DEMOLISHED
E67	1	COLD PAN REFRIGERATED 9-3/4" FULL DEPTH SELF-CONTAINED	EXISTING TO BE DEMOLISHED
E68	1	VERTICAL SNEEZE GUARD	EXISTING TO BE DEMOLISHED
E69 E70	1	VERTICAL SNEEZE GUARD SNEEZE GUARD	EXISTING TO BE DEMOLISHED EXISTING TO BE DEMOLISHED
E71	1	IPAD NUTRITION KIOSK	EXISTING TO BE DEMOLISHED
E73 E76	3	CUP DISPLAY PEPSI SODA DISPENSER	EXISTING TO BE DEMOLISHED EXISTING TO BE DEMOLISHED
E83	2	AIRSCREEN	EXISTING TO BE DEMOLISHED
E84 E85	1	GLASS DOOR MERCHANDISER SLIDE DOOR REFRIGERATOR REACH-IN REFRIGERATOR	EXISTING TO BE DEMOLISHED EXISTING TO BE DEMOLISHED
E86	1	GLASS DOOR MERCHANDISER SLIDE DOOR REFRIGERATOR	EXISTING TO BE DEMOLISHED
E87 E88	1	DECK OVEN, PIZZA, ELECTRIC  EXHAUST HOOD	EXISTING TO BE DEMOLISHED EXISTING TO BE DEMOLISHED
E89	1	SANDWICH MAKE TABLE	EXISTING TO BE DEMOLISHED
E90 E92	1	WORKTOP SOLID DOOR REFRIGERATOR CONVECTION OVEN, ELECTRIC, COUNTERTOP	EXISTING TO BE DEMOLISHED EXISTING TO BE DEMOLISHED
E93	1	REFRIGERATOR, ROLL IN	EXISTING TO BE DEMOLISHED
E94 E95	1	INFRARED BROILER - SINGLE DECK WITH WARMER EQUIPMENT STAND	EXISTING TO BE DEMOLISHED EXISTING TO BE DEMOLISHED
E96	1	ULTRA-MAX ELECTRIC GRIDDLES	EXISTING TO BE DEMOLISHED
E97	1	EXHAUST HOOD	EXISTING TO BE DEMOLISHED
E98 E99	4	DUMP STATION FRYER, 30 LB	EXISTING TO BE DEMOLISHED EXISTING TO BE DEMOLISHED
E100	1	EXHAUST HOOD	EXISTING TO BE DEMOLISHED
E101 E102	1	FREEZER, REACH-IN GRIDDLE STAND, REFRIGERATOR	EXISTING TO BE DEMOLISHED EXISTING TO BE DEMOLISHED
E103	1	S/S WORKTABLE	EXISTING TO BE DEMOLISHED
E104 E105	1	UNDERCOUNTER REFRIGERATOR S/S WORKTABLE W/ UNDERSHELF	EXISTING TO BE DEMOLISHED EXISTING TO BE DEMOLISHED
E106	1	QCS3 SERIES HIGH VOLUME CONVEYOR TOASTERS	EXISTING TO BE DEMOLISHED
E107 E108	1	CABINET, MOBILE, WARMING & HOLDING HAND SINK	EXISTING TO BE DEMOLISHED EXISTING TO BE DEMOLISHED
E108	1	REFRIGERATED DELI CASE	EXISTING TO BE DEMOLISHED
E110	1	DROPIN HOT WELL	EXISTING TO BE DEMOLISHED
E111 E112	1	DROPIN HOT WELL SNEEZE GUARD	EXISTING TO BE DEMOLISHED  EXISTING TO BE DEMOLISHED
E113	1	SNEEZE GUARD	EXISTING TO BE DEMOLISHED
E114 E115	1	HOT/COLD WELL, DROP-IN HOT/COLD WELL, DROP-IN	EXISTING TO BE DEMOLISHED EXISTING TO BE DEMOLISHED
E115	1	HOT/COLD WELL, DROP-IN	EXISTING TO BE DEMOLISHED

ENEEZE CHARD	EVICTING TO BE DEMOLICE
EXISTING TO BE U	JSED LATER
ROTTLE REVERAGE COOLER	EXISTING TO BE DEMOLISH

EXISTING TO BE DEMOLISHED

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<b>E</b> EM	0 <sup>1</sup> -v	BOTTLE BEVERAGE COOLER TON	FOU FXISTING TO BE DEMOUSHED
村の	Q <sub>1</sub> I Y	FREEZER, ICE CREAM CRIPTION	EQUENTIFICATION TO BE MENTING
E05	1	FRYER, DEEP FAT, ELECTRIC	FUTURE
E06	1	PAN RACK, UNIVERSAL	FUTURE
F53	1	REFRIGERATOR SANDWICH/SALAD PREP	FUTURE



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RENO **DDITION** 

DESCRIPTION

ISSUED FOR: DD REVIEW


ISSUED DATE: 1.19.2017 DRAWN BY: R.Schneider

CHECKED BY: KPF PROJECT NUMBER: CW-0205-4

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EQUIPMENT DEMO LAYOUT

Q010

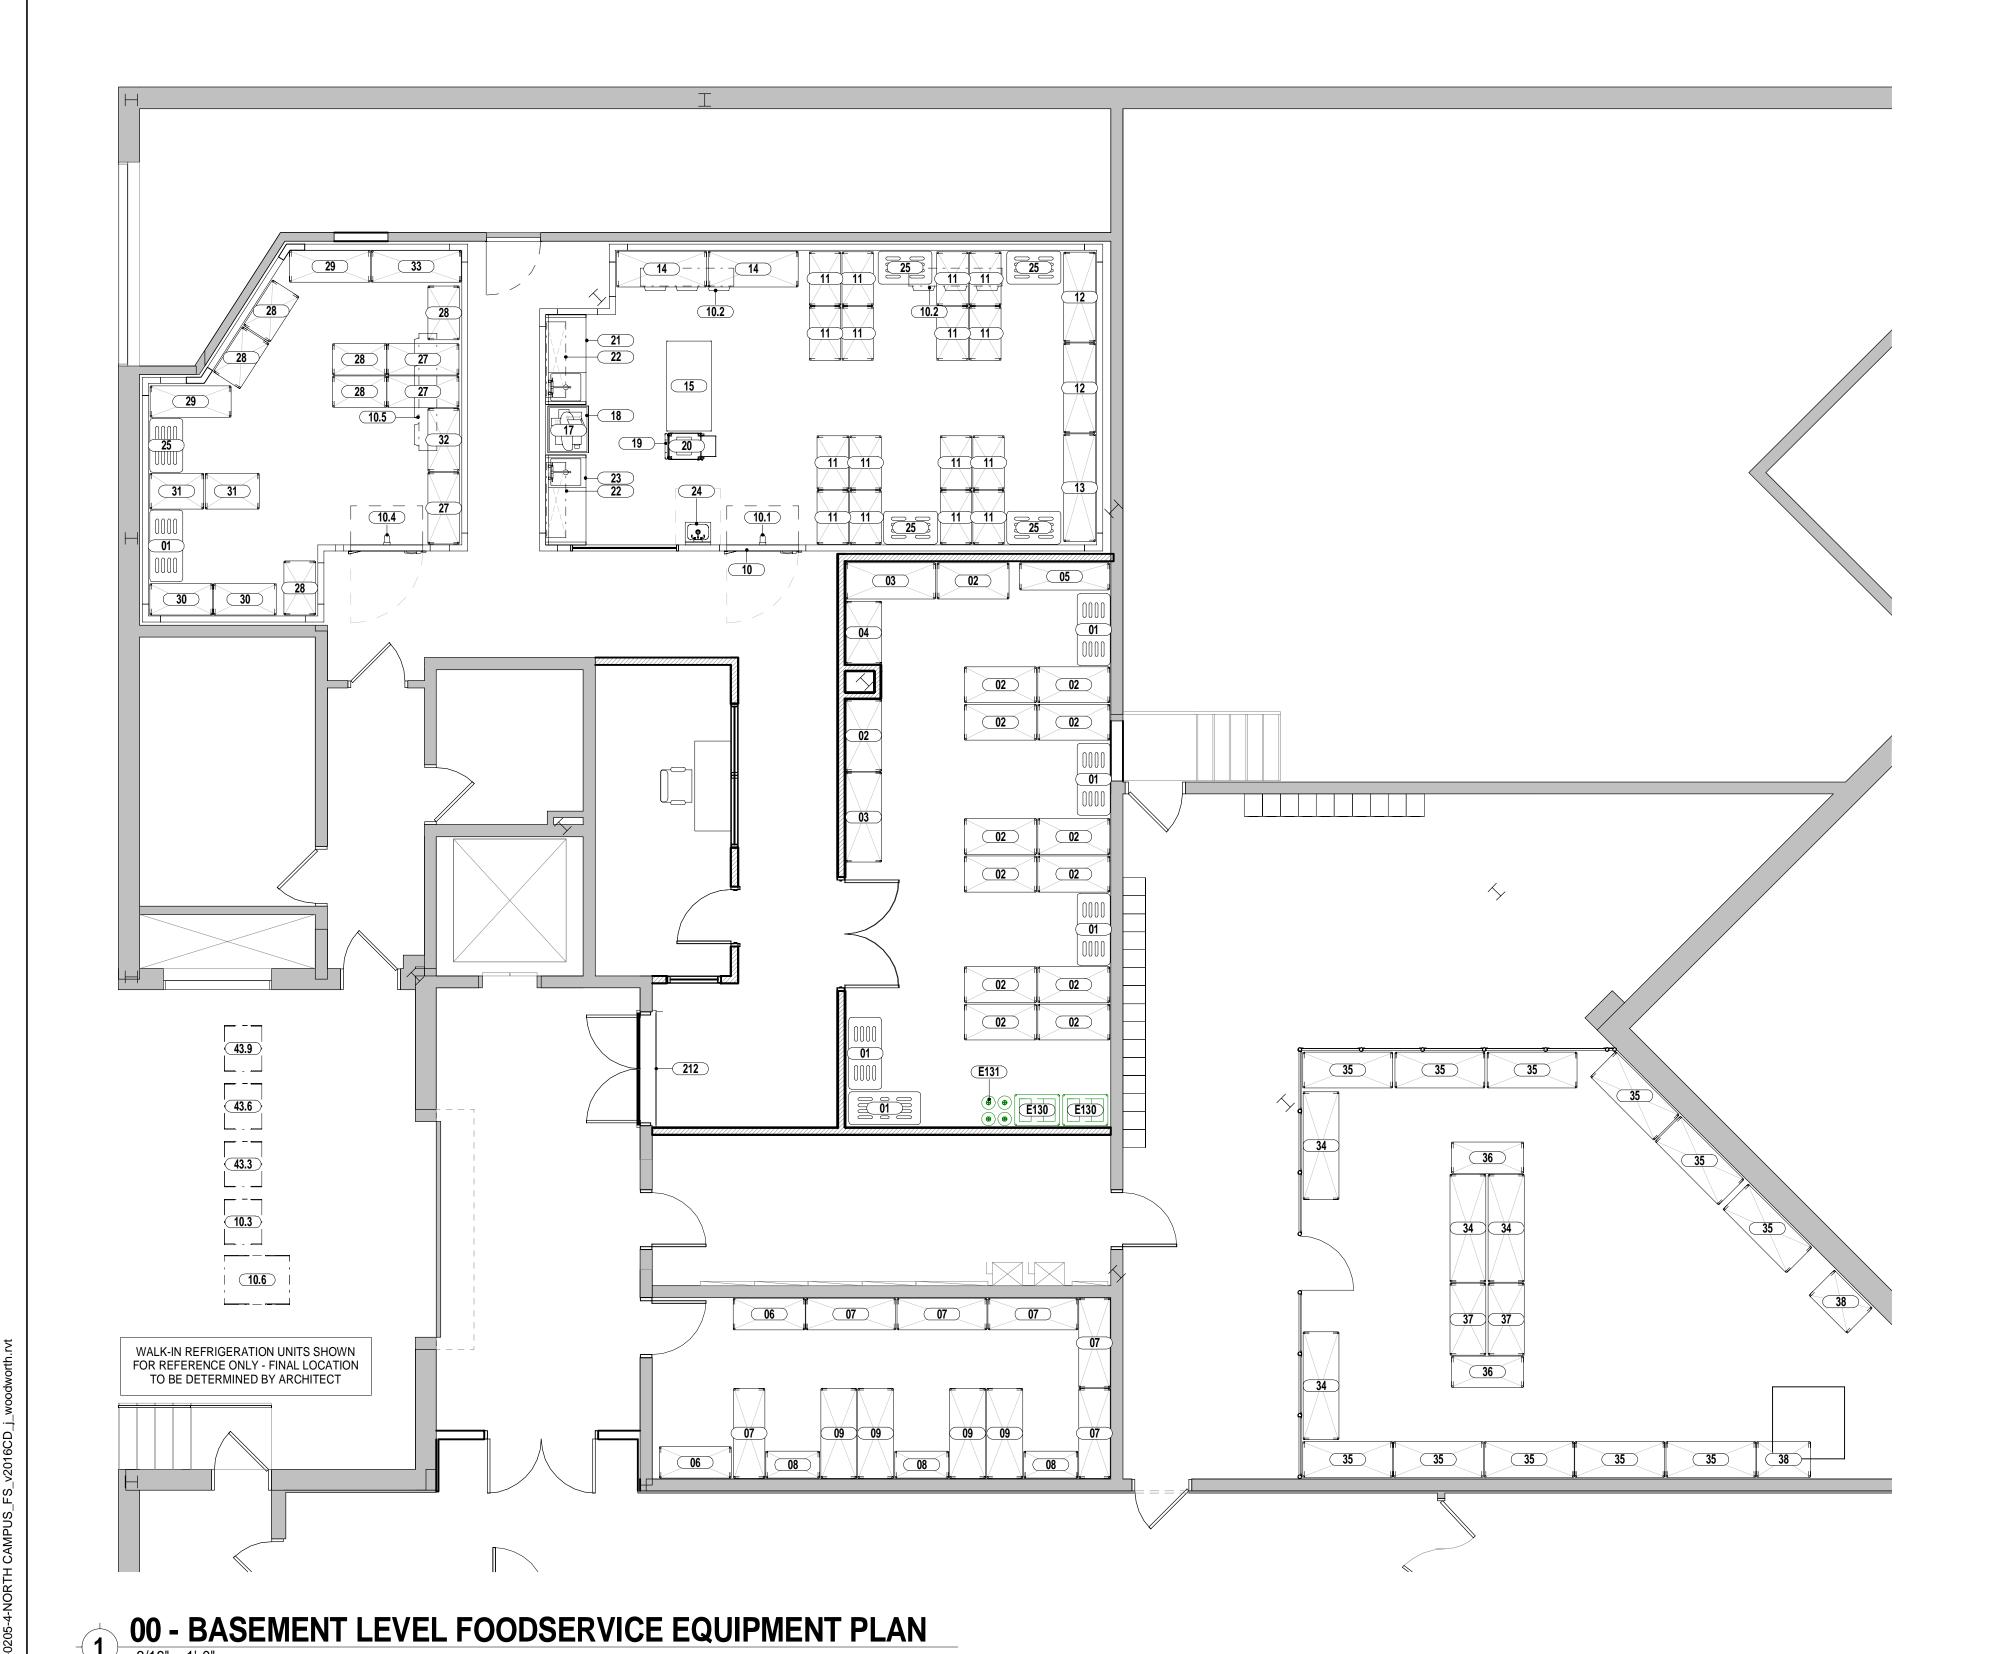

- NATIONAL, STATE AND/OR LOCAL CODES AND STANDARDS.
- WORK AND MATERIALS SHALL BE IN COMPLIANCE WITH REQUIREMENTS OF APPLICABLE CODES, ORDINANCES, AND REGULATIONS, INCLUDING BUT NOT LIMITED TO THOSE OF THE NATIONAL FIRE PROTECTION ASSOCIATION, STATE FIRE MARSHALL, STATE BOARD OF HEALTH, LOCAL HEALTH CODES, ETC.
- ELECTRICALLY OPERATED AND/OR HEATED EQUIPMENT, FABRICATED OR OTHERWISE, SHALL CONFORM TO THE LATEST STANDARDS OF NATIONAL ELECTRIC MANUFACTURERS ASSOCIATION AND OF UNDERWRITERS LABORATORIES, INC., AND SHALL BEAR THE
- MANUFACTURED IN ACCORDANCE WITH A.S.M.E. CODE REQUIREMENTS AND CARRY THE A.S.M.E. STAMP.
- RULINGS AND INTERPRETATIONS OF ENFORCING AGENCIES SHALL BE CONSIDERED PART OF REGULATIONS.

THE FOODSERVICE EQUIPMENT PLANS AND SPECIFICATIONS ARE INTENDED TO ILLUSTRATE TYPES AND ARRANGEMENTS, INCLUDING SPACE AND UTILITY REQUIREMENTS, OF EQUIPMENT REQUIRED FOR THIS PROJECT REGARDING THE DESIRED FUNCTION AND PRODUCT FLOW, AND TO SERVE AS A REFERENCE TO THE LICENSED PROFESSIONAL ARCHITECT AND/OR ENGINEERS IN THE PREPARATION OF THEIR RESPECTIVE BID AND CONSTRUCTION DOCUMENTS. NO ARCHITECTURAL OR ENGINEERING DESIGN SERVICES ARE INTENDED OR ASSUMED.

- DESIGN DOCUMENTS INCLUDE DRAWINGS AND SPECIFICATIONS, WHICH SHOULD BE REASONABLY CORRECT. HOWEVER THEIR CONFLICT TO BE CLARIFIED IN AN OFFICIAL REQUEST FOR
- IT SHALL BE THE RESPONSIBILITY OF THE FOODSERVICE EQUIPMENT BIDDERS TO INFORM THE FOODSERVICE CONSULTANT OF ANY DISCREPANCIES FOUND WITHIN THESE DOCUMENTS TO INCLUDE: WRITTEN SPECIFICATIONS, DRAWINGS OR SCHEDULES, TO ALLOW AN OPPORTUNITY FOR THE CONSULTANT TO PREPARE AN ADDENDUM TO CORRECT SUCH DISCREPANCIES. BIDDING ON A KNOWN DISCREPANCY WITH THE INTENTION OF EQUIPMENT SUBSTITUTION OR PRICE GOUGING THROUGH CHANGE ORDERS WILL NOT BE TOLERATED.

## **EXISTING EQUIPMENT:**

- THOSE ITEMS INDICATED AS RELOCATED. ALL FOODSERVICE EQUIPMENT THAT IS SCHEDULED FOR REMOVAL
- STORAGE AT THEIR DISCRETION. THE DATA ON EXISTING EQUIPMENT IS THE BEST AVAILABLE AT THE TIME THESE DRAWINGS WHERE PREPARED, AND IS OFFERED FOR
- EXISTING VENTILATORS MUST BE VERIFIED THEY WILL PERFORM
- PROPERLY FOR NEW EQUIPMENT INDICATED. EXISTING FIRE SUPPRESSION SYSTEM MUST BE RECONFIGURED AS REQUIRED TO SUIT NEW COOKING EQUIPMENT INDICATED.

## 11400: WORK INCLUDED IN THIS SECTION

- A. Furnish all labor, material, services, and specified equipment, necessary for the complete installation of foodservice equipment in strict accordance with specifications, applicable drawings and local codes, including that which is reasonably inferred, with all related items necessary to complete work shown on contract drawings and/or required by these specifications. B. Deliver all equipment on schedule. The Foodservice Equipment Contractor shall be responsible for coordinating all aspects of their work as it relates to
- C. The Foodservice Equipment Contractor shall be fully responsible for verifying all field dimensions as they pertain to the work in this section. D. Cutting of holes in equipment for pipes, drains, electric outlets, etc., as
- workmanship and shall include welded sleeves, collars, ferrules or
- wall sleeves Foodservice Equipment Contractor to provide vermin proofing for all floor sleeves he uses. F. All work involved in making stands and supports for all specified equipment
- requiring them.
- removal of all debris left by the Foodservice Equipment Contractor. fixtures shall be cleaned thoroughly and ready for operation at the time the building is turned over to the owner.
- Become familiar with and accepts responsibility for compliance with all applicable codes and regulations. If authorities having jurisdiction require any portion of the equipment to be inspected, tested, or approved, the Foodservice Equipment Contractor and/or their equipment supplier shall bear all costs of such inspections, tests or approvals.

**FOODSERVICE GENERAL NOTES:** 

- ALL ITEMS OF FOODSERVICE EQUIPMENT SHALL BE FABRICATED AND INSTALLED IN STRICT ACCORDANCE WITH THE LATEST STANDARDS PUBLISHED BY THE NATIONAL SANITATION FOUNDATION (NSF), OR THE EQUIVALENT; AND IN STRICT COMPLIANCE WITH ALL APPLICABLE

- ALL STANDARD STEAM-HEATED EQUIPMENT SHALL BE
- NO EXTRA CHARGE WILL BE PAID FOR FURNISHING ITEMS REQUIRED BY THE REGULATIONS, BUT NOT SPECIFIED OR SHOWN ON THE
- GENERAL CONTRACTOR TO SITE VERIFY ALL DIMENSIONS PRIOR TO CONSTRUCTION.

## DISCLAIMER:

**EXISTING EQUIPMENT** 

**LEGEND** 

EXISTING TO BE RELOCATED

REMOTE REFRIGERATION CONDENSING UNITS

SHOWN FOR INFORMATIONAL PURPOSES ONLY.

ACTUAL LOCATION TO BE DETERMINED BY FIELD CONDITIONS AND BUILDING STRUCTURE IN KEEPING

WITH ALL REQUIREMENTS OF SPECIFICATIONS.

EXISTING TO REMAIN

### **ERRORS AND OMISSIONS:**

ACCURACY IS NOT GUARANTEED. SHOULD DISCREPANCIES OCCUR THEY SHALL BE BROUGHT TO THE ATTENTION OF THE FOODSERVICE CONSULTANT AND/OR PROJECT ARCHITECT IN ORDER FOR THE INFORMATION.

- APPRORIATE TRADES TO DISCONNECT FOODSERVICE EQUIPMENT ALLOCATED FOR RELOCATION OR REMOVAL.
- ALL EXISTING H.V.A.C., SPRINKLERS AND OTHER SERVICES TO BE RELOCATED AS REQUIRED BY MECHANICAL AND ELECTRICAL ENGINEERS SHALL MEET ALL STANDARDS, CODES AND BYLAWS SET FORTH BY LOCAL GOVERNING AUTHORITIES. FOOD SERVICE EQUIPMENT CONTRACTOR TO MOVE & SET IN PLACE
- SHALL BE TURNED OVER TO THE OWNER FOR DISPOSAL OR
- PLANNING PURPOSES ONLY. THE CONTRACTOR SHALL FIELD VERIFY ALL DATA PRIOR TO ROUGHING-IN UTILITIES FOR EXISTING



- the General Contractor, Subcontractors, the Owner, or any other Trades as may be dictated by the Owner, Architect, or Consultant.
- required for this installation. Work shall conform to the highest standards of escutcheons. Foodservice Equipment Contractor to completely coordinate all aspects of installation with all trades for a complete and thorough installation. All wall sleeves, chrome plated cover plates, vermin proofing, and sealing of
- G. Repair all damage to the premises as a result of this installation and daily H. The Foodservice Equipment Contractor shall be responsible for keeping their area orderly during the entire time of installation. Foodservice equipment and

8 WILCOX STREET SIMSBURY, CONNECTICT 06070

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FAX: (860) 264-1628

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RENO AND **DDITION** 

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NO.	DATE	DESCRIPTION		
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ISSUED FOR: DD REVIEW

ISSUED DATE: 1.19.2017 DRAWN BY: R.Schneider


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> **BASEMENT EQUIPMENT**


> > LAYOUT



**EXISTING EQUIPMENT** LEGEND

EXISTING TO REMAIN EXISTING TO BE RELOCATED

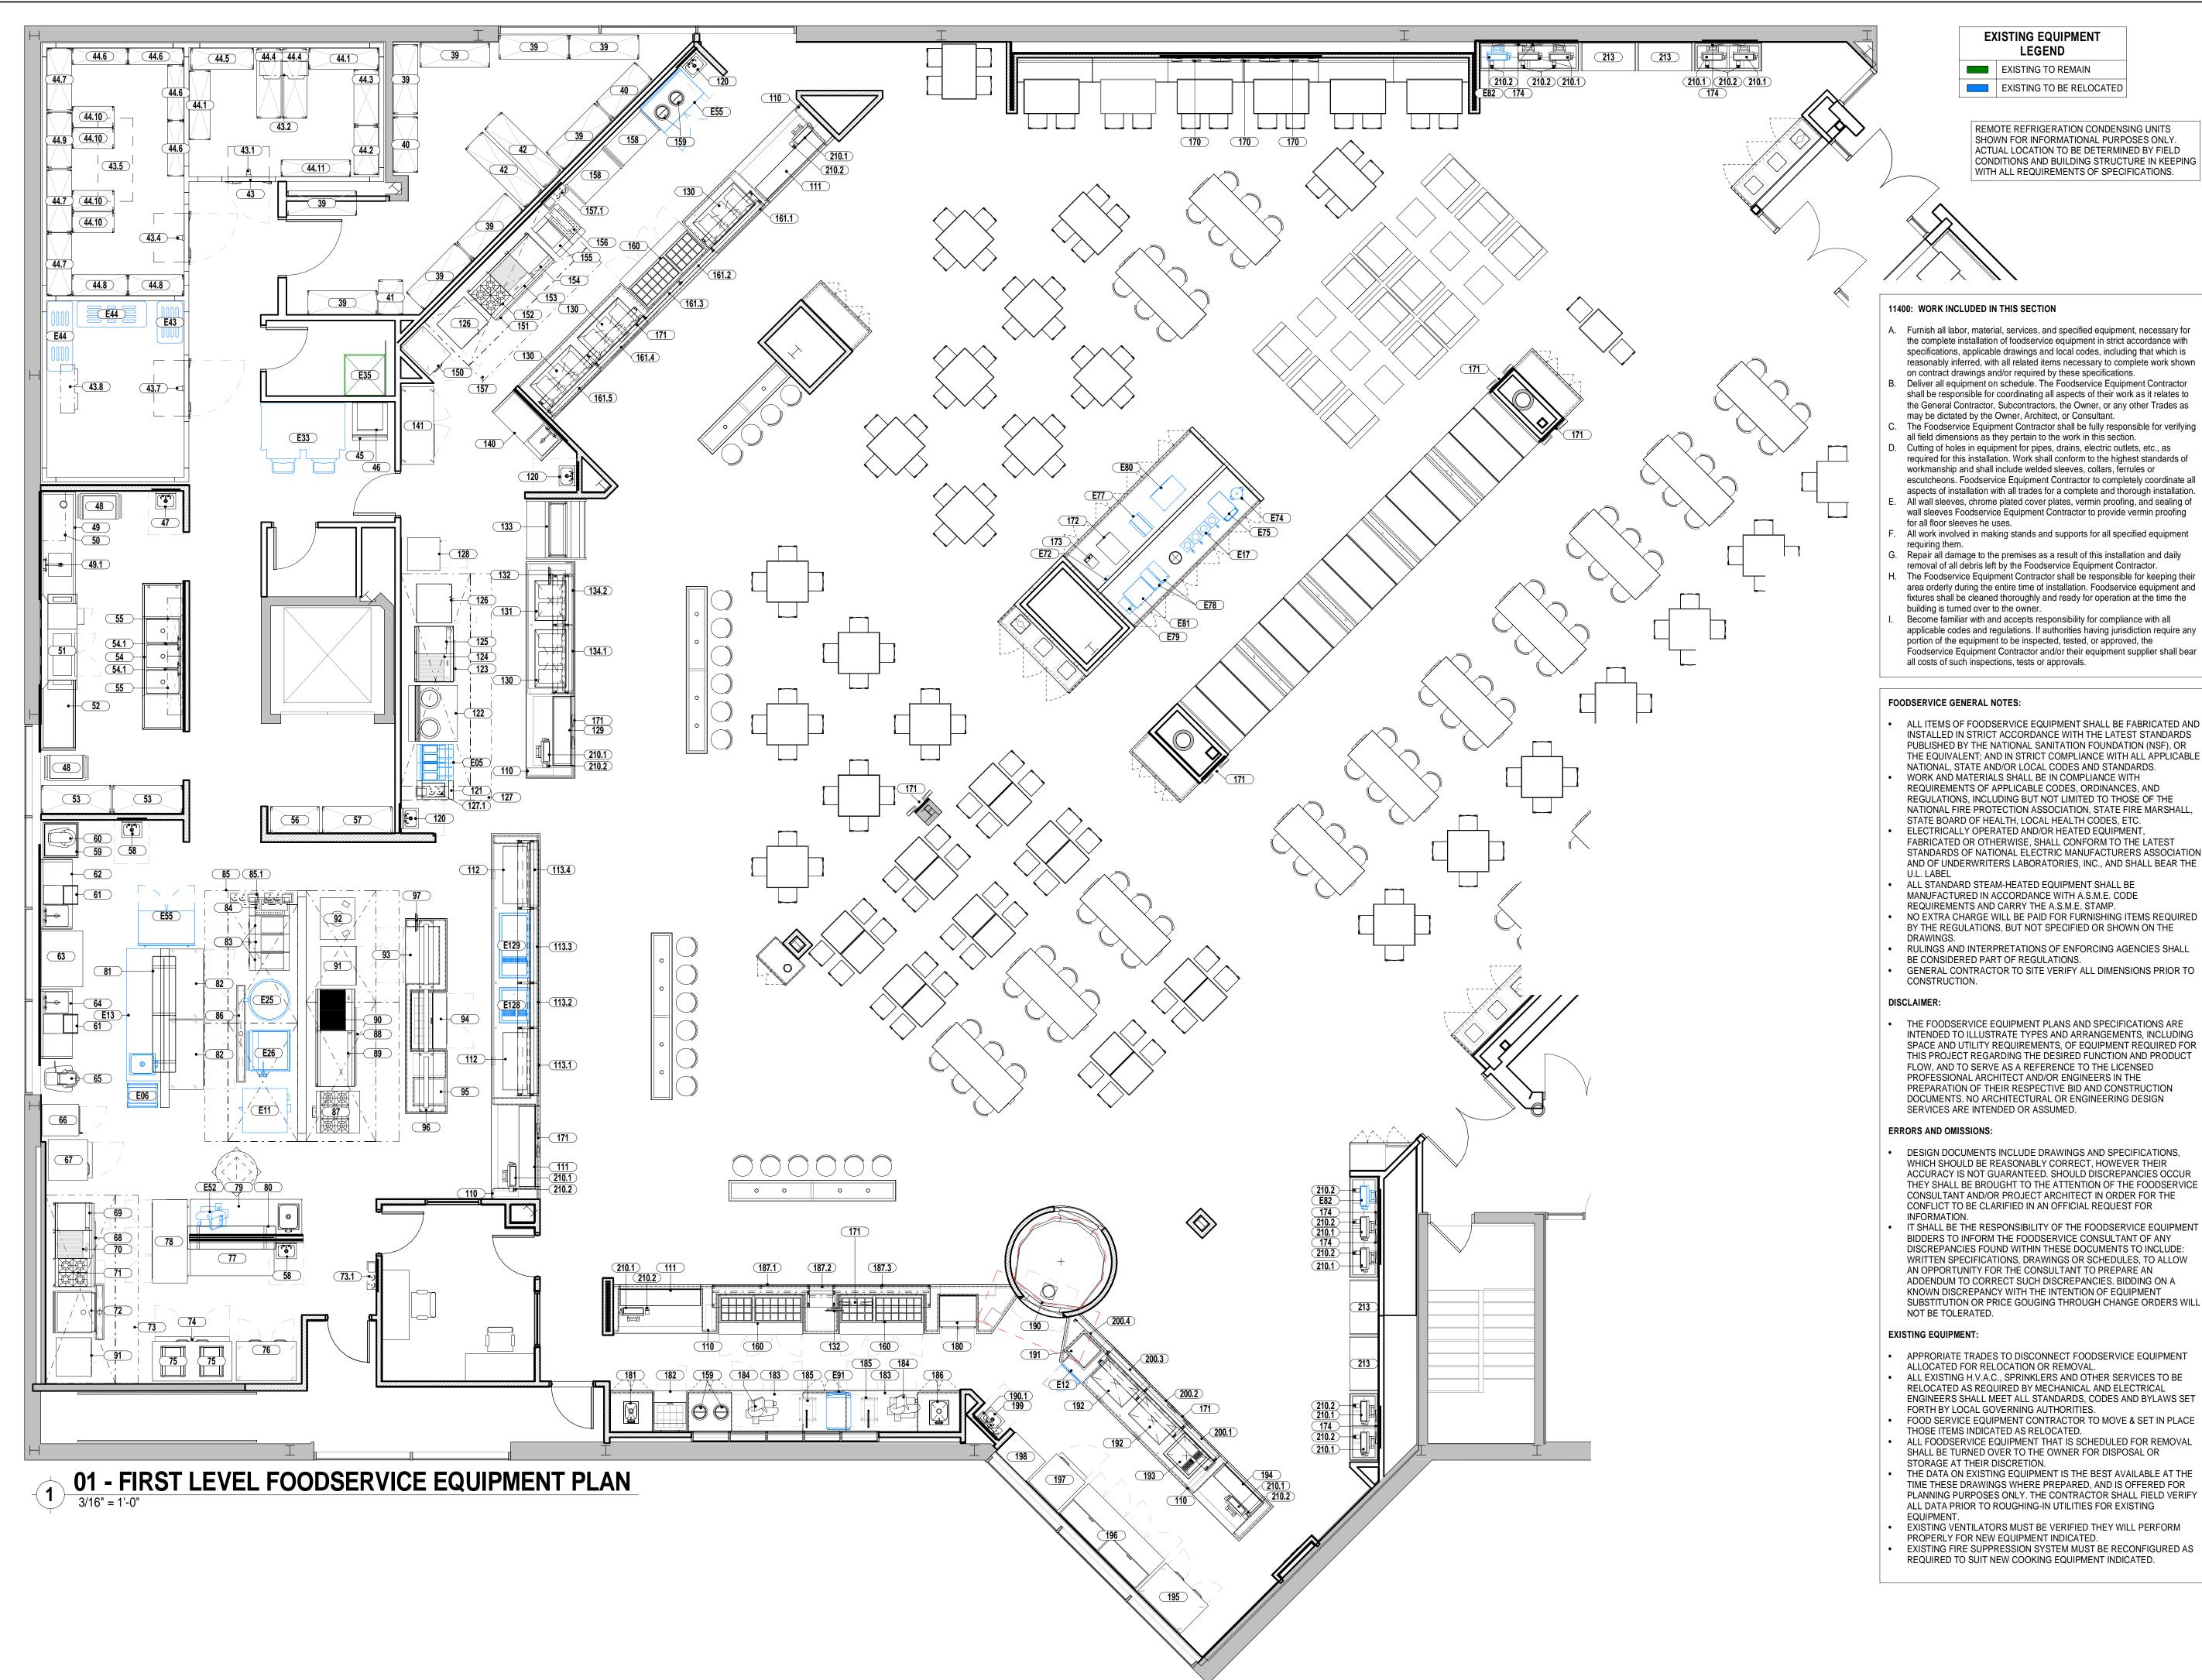REMOTE REFRIGERATION CONDENSING UNITS SHOWN FOR INFORMATIONAL PURPOSES ONLY. ACTUAL LOCATION TO BE DETERMINED BY FIELD CONDITIONS AND BUILDING STRUCTURE IN KEEPING WITH ALL REQUIREMENTS OF SPECIFICATIONS.

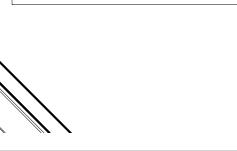

### 11400: WORK INCLUDED IN THIS SECTION

- A. Furnish all labor, material, services, and specified equipment, necessary for the complete installation of foodservice equipment in strict accordance with specifications, applicable drawings and local codes, including that which is reasonably inferred, with all related items necessary to complete work shown
- B. Deliver all equipment on schedule. The Foodservice Equipment Contractor shall be responsible for coordinating all aspects of their work as it relates to the General Contractor, Subcontractors, the Owner, or any other Trades as may be dictated by the Owner, Architect, or Consultant. C. The Foodservice Equipment Contractor shall be fully responsible for verifying
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- G. Repair all damage to the premises as a result of this installation and daily removal of all debris left by the Foodservice Equipment Contractor. H. The Foodservice Equipment Contractor shall be responsible for keeping their area orderly during the entire time of installation. Foodservice equipment and fixtures shall be cleaned thoroughly and ready for operation at the time the building is turned over to the owner.
- Become familiar with and accepts responsibility for compliance with all applicable codes and regulations. If authorities having jurisdiction require any portion of the equipment to be inspected, tested, or approved, the Foodservice Equipment Contractor and/or their equipment supplier shall bear all costs of such inspections, tests or approvals.

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- PLANNING PURPOSES ONLY. THE CONTRACTOR SHALL FIELD VERIFY ALL DATA PRIOR TO ROUGHING-IN UTILITIES FOR EXISTING
- EXISTING VENTILATORS MUST BE VERIFIED THEY WILL PERFORM PROPERLY FOR NEW EQUIPMENT INDICATED. EXISTING FIRE SUPPRESSION SYSTEM MUST BE RECONFIGURED AS

**EQUIPMENT** LAYOUT - OVERALL LAYOUT

ISSUED FOR: DD REVIEW

ISSUED DATE: 1.19.2017

DRAWN BY: R.Schneider

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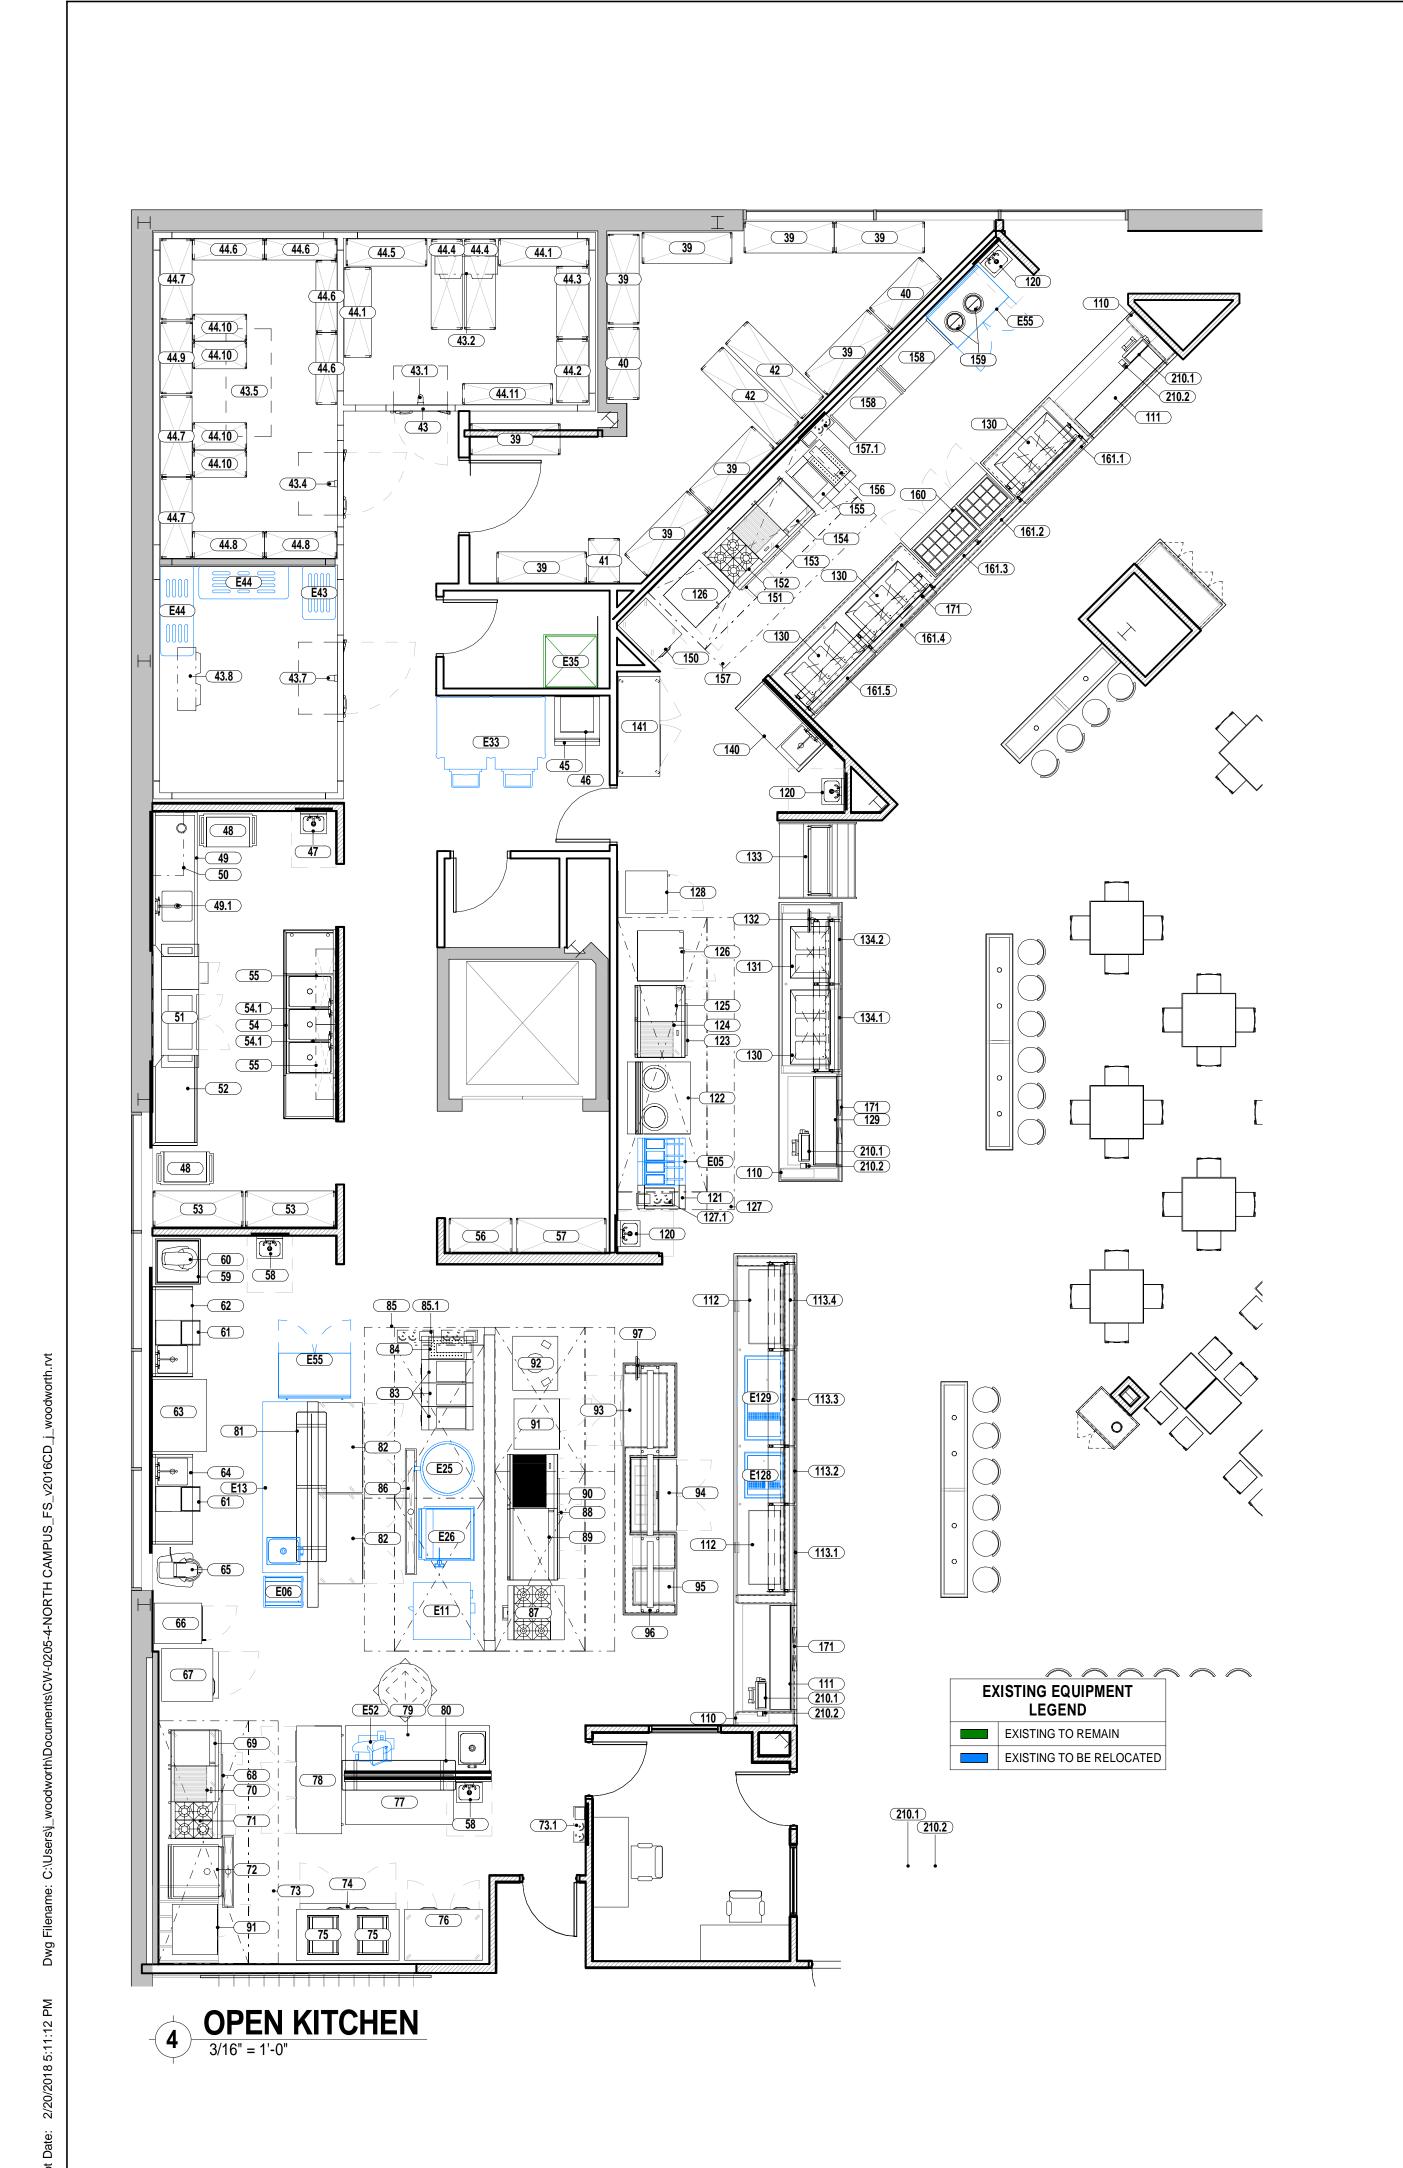
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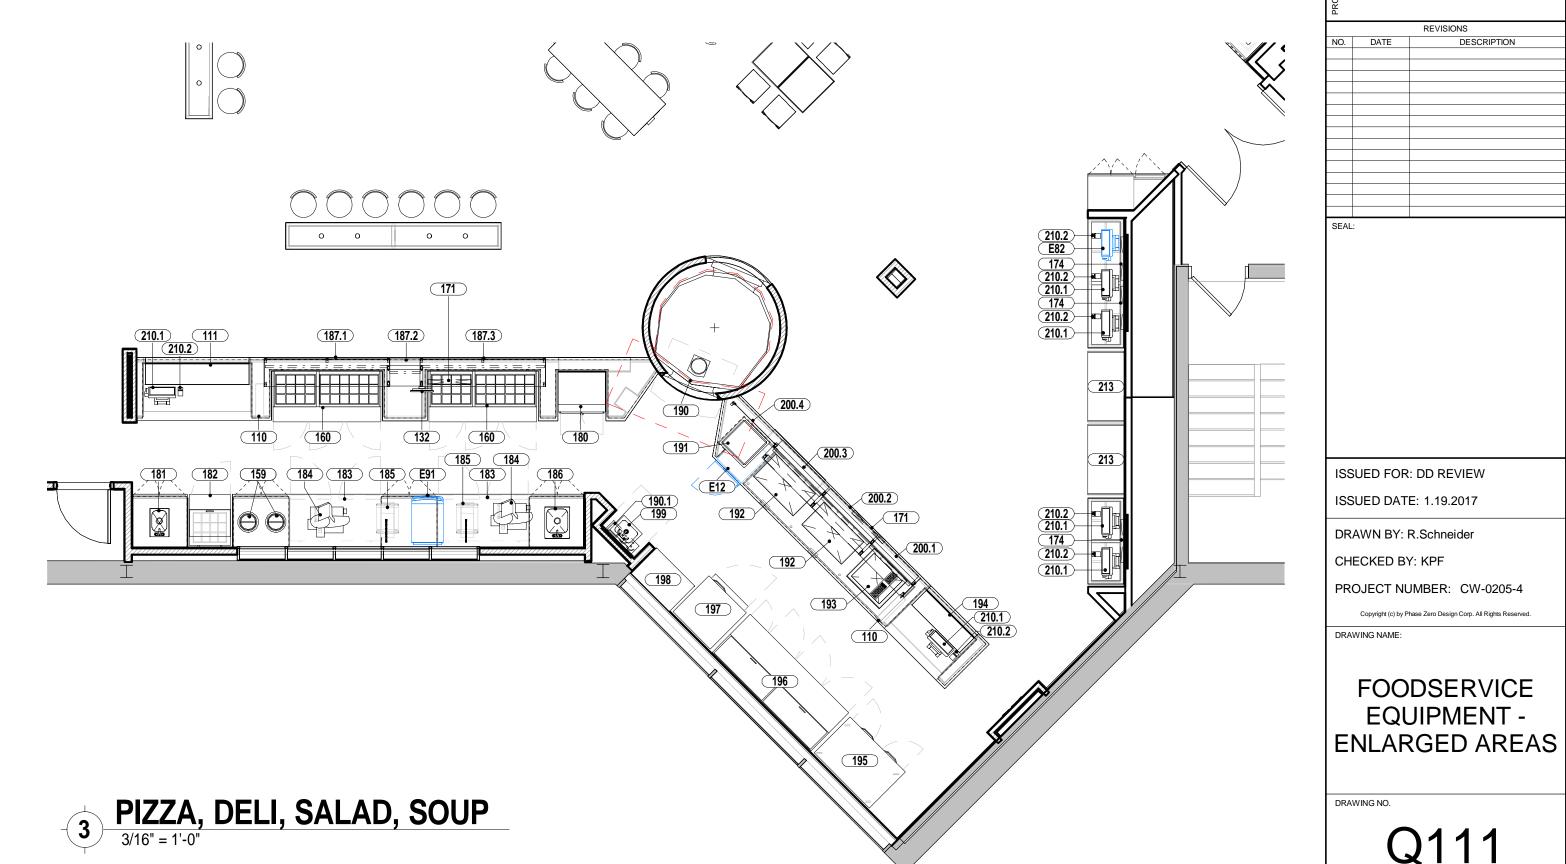
RENOVATION


35 ANDERSON HILL PURCHASE, NY 105 AND **ADDITION** 

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D. DATE DESCRIPTION

ISSUED FOR: DD REVIEW

ISSUED DATE: 1.19.2017 DRAWN BY: R.Schneider

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FOODSERVICE **EQUIPMENT** -
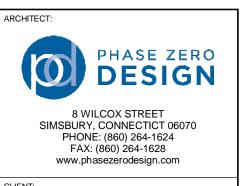
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